PROJECT NUMBER

23-124

91 S. High Street

DUBLIN, OH 43017

RETAIL TO RESTAURANT CONVERSION PROJECT

OWNER

Dustin Snow


<u>Dustin.snow@gmail.com</u>₃tin.snow@gmail.com" 312.505.7579 7739 Sudbrook Sq. New Albany, OH 43054

ABBREVIATIONS LEGEND

ABBR.	DESCRIPTION
A/C AFF ARCH	AIR CONDITIONING ABOVE FINISH FLOOR ARCHITECT OR ARCHITECTURAL
	ALUMINUM APPROXIMATE AT AND
BD	BOARD
BLDG	BUILDING
B.O.	BY OTHERS
B/	BOTTOM OF
CAB	CABINET
CFM	CUBIC FEET PER MINUTE
CL	CLOSET
CLG	CEILING
CLR	CLEAR
COL	COLUMN
CONC	CONCRETE
C.T.	CERAMIC TILE
DIA	DIAMETER
DN	DOWN
DTL	DETAIL
DW	DISHWASHER
DWG	DRAWING
EA	EACH
ELEC	ELECTRICAL
EL	ELEVATION
ENCL	ENCLOSURE
EQ	EQUAL
EQUIP	EQUIPMENT
EXIST	EXISTING
FF FIN FIXT FLR F.R. FT	FINISH FLOOR FINISH FIXTURE FLOOR FIRE-RETARDANT OR FIRE-RATED FOOT OR FEET
GA	GAUGE OR GAGE
GAVL	GALVANIZED
GC	GENERAL CONTRACTOR
GFI	GROUND FAULT INTERUPTER
GWB	GYPSUM WALL BOARD
H.C. H.M. HOR HR HT HVAC	HOLLOW CORE HOLLOW METAL HORIZONTAL HOUR HEIGHT HEATING, VENTILATION, AND AIR CONDITIONING
I.D.	INSIDE DIAMETER
IN	INCH OR INCHES
INCL	INCLUDING
LAM LAV	LAMINATED LAVATORY LENGTH OVERALL
MATL	MATERIAL
MAX	MAXIMUM
MECH	MECHANICAL
MFR	MANUFACTURER
MIN	MINIMUM
MISC	MISCELLANEOUS
M.O.	MASONRY OPENING
MTL	METAL

ABBR. DESCRIPTION NOT IN CONTRACT NIC NO NUMBER NOMINAL NOM NTS NOT TO SCALE 0.C. 0.D. ON CENTER OUTSIDE DIAMETER OPNG OPENING OPP OPPOSITE PL PLATE PLAS PLASTER PLAM PLASTIC LAMINATE PLYWD PLYWOOD POL POLISHED PR P.T. PAIR PRESSURE TREATED PTD PAINTED R **RISER OR RADIUS** R.A. **RETURN AIR** RADIATOR RAD RE: REFER TO REF REFRIGERATOR REQD REQUIRED REV REVISED OR REVISION RM ROOM R.O. ROUGH OPENING S.C. SOLID CORE SCHED SCHEDULE SECT SECTION SF SQUARE FEET SHT SHEET SIM SIMILAR SPEC SPECIFICATIONS S.S. STAINLESS STEEL STD STANDARD STL STEEL STRUCT STRUCTURAL Т TREAD TELEPHONE TEL T&G TONGUE AND GROOVE T.O. TOP OF T.O.B. TOP OF BEAM T.O.C.TOP OF CONCRETET.O.S.TOP OF SLAB TER T.O.W. TOP OF WALL TYP TYPICAL TOP OF Τ/ UON UNLESS OTHERWISE NOTED VINYL COMPOSITION TILE VCT V.I.F. VERIFY IN FIELD W/ WITH WITHOUT W/O WC WATER CLOSET WD WOOD

WATER RESISTANT WR WWF WELDED WIRE FABRIC

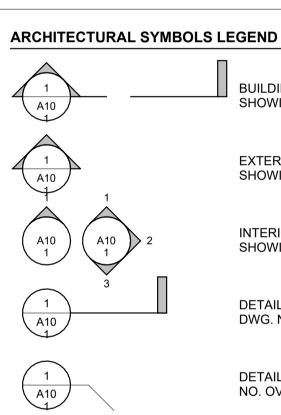

1			
	<u>3. HT.</u> " AFF		 _
	<u>G. HT.</u> " AFF		
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Α			
\triangle			
(1.1)			
ى			 _
-		4' - 0"	
لو		4' - 0"	
-		4' - 0"	

BUILDING SECTION REFERENCE
SHOWING DWG. NO. OVER SHEET NO.
EXTERIOR ELEVATION REFERENCE SHOWING DWG. NO. OVER SHEET NO.
INTERIOR ELEVATION(S) REFERENCE SHOWING DWG. NO(S). AND SHEET NO.
DETAIL SECTION REFERENCE SHOWING DWG. NO. OVER SHEET NO.
DETAIL REFERENCE SHOWING DWG. NO. OVER SHEET NO.
 PLAN DATUM SHOWING REFERENCE SURFACE AND ELEVATION HEIGHT
 SECTION OR ELEVATION DATUM REFERENCE SHOWING REFERENCE HT & EL
DOOR INDICATOR SHOWING DOOR TYPE WINDOW INDICATOR SHOWING WINDOW TYPE
WALL INDICATOR SHOWING WALL TYPE

REVISION INDICATOR SHOWING

REVISION NO.

NOTE INDICATOR SHOWING NOTE NO.

— CENTERLINE


---- HIDDEN LINE ABOVE

— - — HIDDEN LINE BELOW DIMENSION TO OR FROM INDICATED SURFACE

DIMENSION TO OR FROM CENTER LINE CLEAR DIMENSION TO OR FROM FINISH SURFACE

ARCHITECTURAL MATERIALS LEGEND

BRICK MASONRY

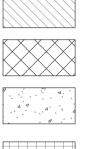

RIGID INSULATION

CONCRETE

THERMAL OR SOUND ATTENUATION BATT INSULATION

CONCRETE MASONRY UNITS, (CMU)

UNDISTURBED EARTH

DISTURBED EARTH OR FILL

SOLID WOOD

PLYWOOD OR WOOD PANEL PRODUCT

SPRAY APPLIED INSULATION



PROJECT LOCATION: 91 S. HIGH STREET

GUNZELMAN architecture + interiors, LLC 333 STEWART AVE, COLUMBUS, OHIO 43206 Laurie A Gunzelman, AIA P 614-674-6696 lgunzelman@gunzelmanai.com **PROJECT ARCHITECTS**


PRATER ENGINEERING ASSOCIATES, INC. 6130 WILCOX ROAD, DUBLIN, OH 43016 P: 614-766-4896 **MEP ENGINEER**

ELHERS ENGINEERING STRUCTURAL ENGINEER

WASSERSTROM FOOD SERVICE EQUIPMENT CONSULTANT

GENERAL G-0.0 TITLE SHEET • • CIVIL • • • 1/3 SITE PLAN • • 2/3 EXISTING CONDITIONS PLAN • • 3/3 LANDSCAPE PLANS • • ARCHITECTURAL • • • ARCHITECTURAL • • • A-0.1 SITE PLAN • • A-0.2 CODE DATA AND LIFE SAFETY PLAN • • A-0.3 WALL TYPES AND PROJECT NOTES • • A-1.0 EXISTING CONDITIONS AND DEMOLITION PLANS • • A-1.1 NEW CONSTRUCTION PLANS • • A-1.2 ROOF PLAN • •		DRAWING SCHEDULE		z
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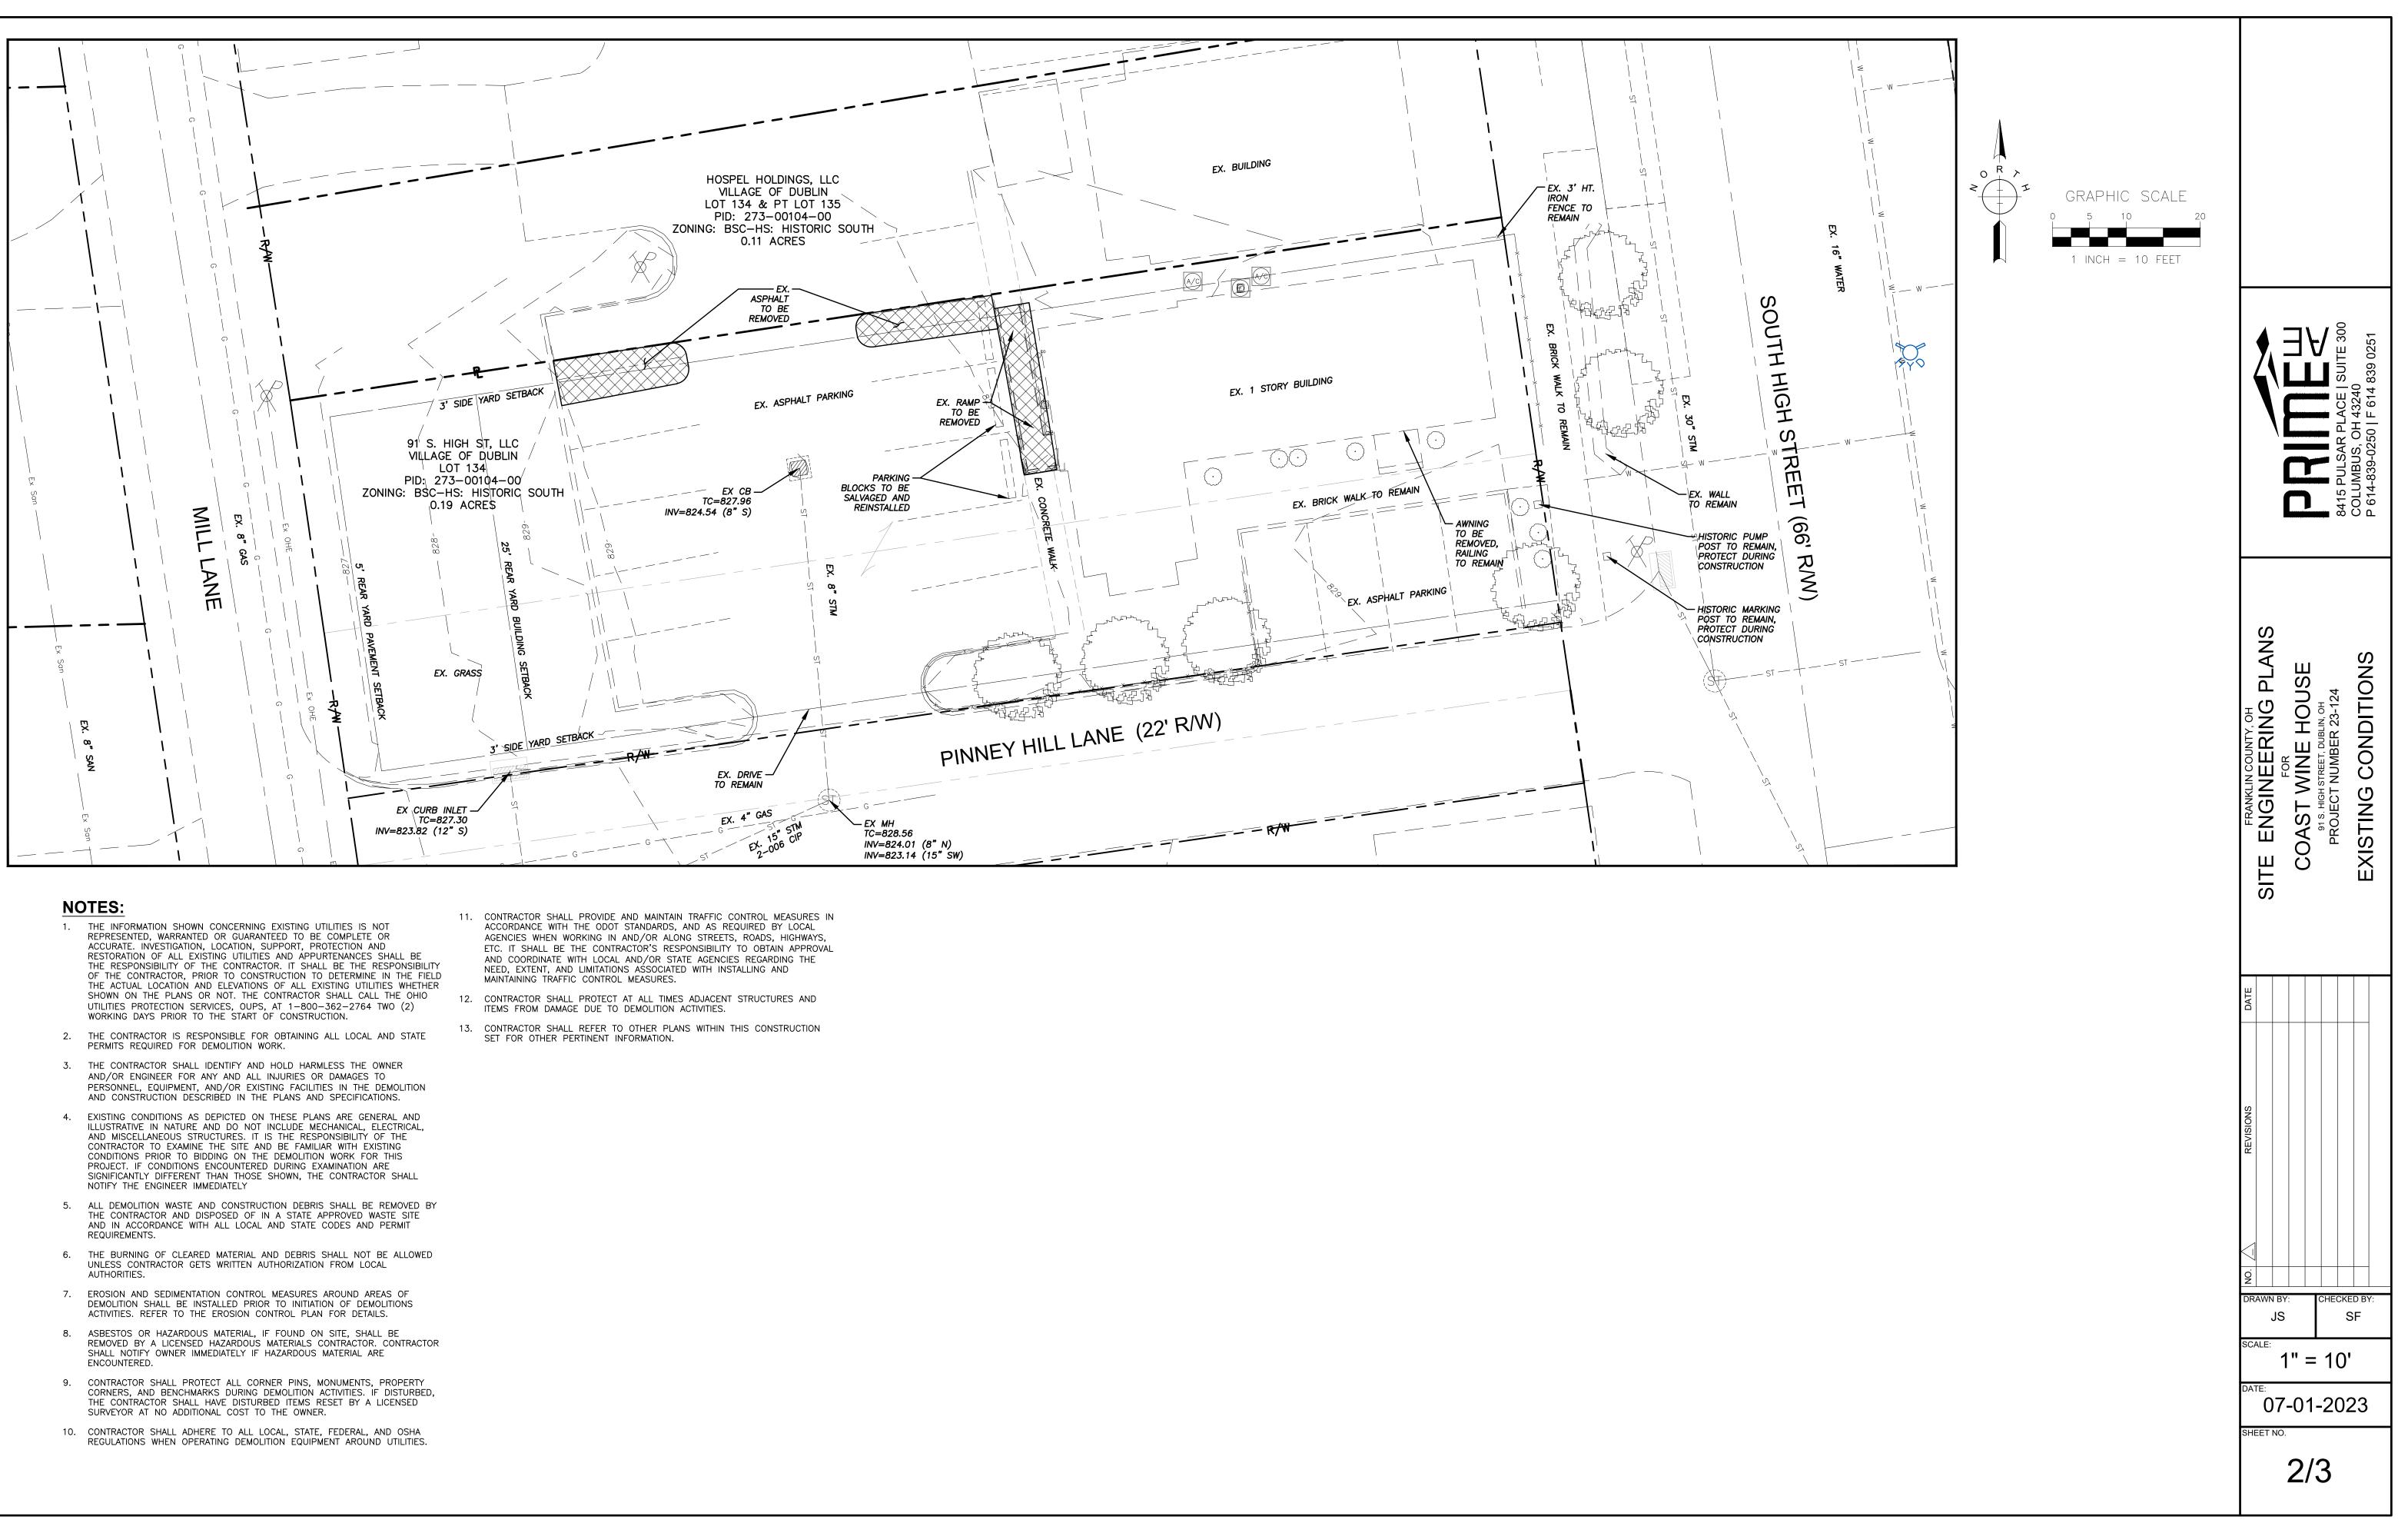
LEGAL DESCRIPTION: 91 S HIGH ST VILLAGE OF DUBLIN 55.70'MID PT LOT 134
SITE ADDRESS: 91 S HIGH ST, DUBLIN OH 43017
TOTAL LOT AREA: 0.2 ACRES, 8,693 SF


ZONING CLASSIFICATION: BSC-HC: HISTORIC SOUTH

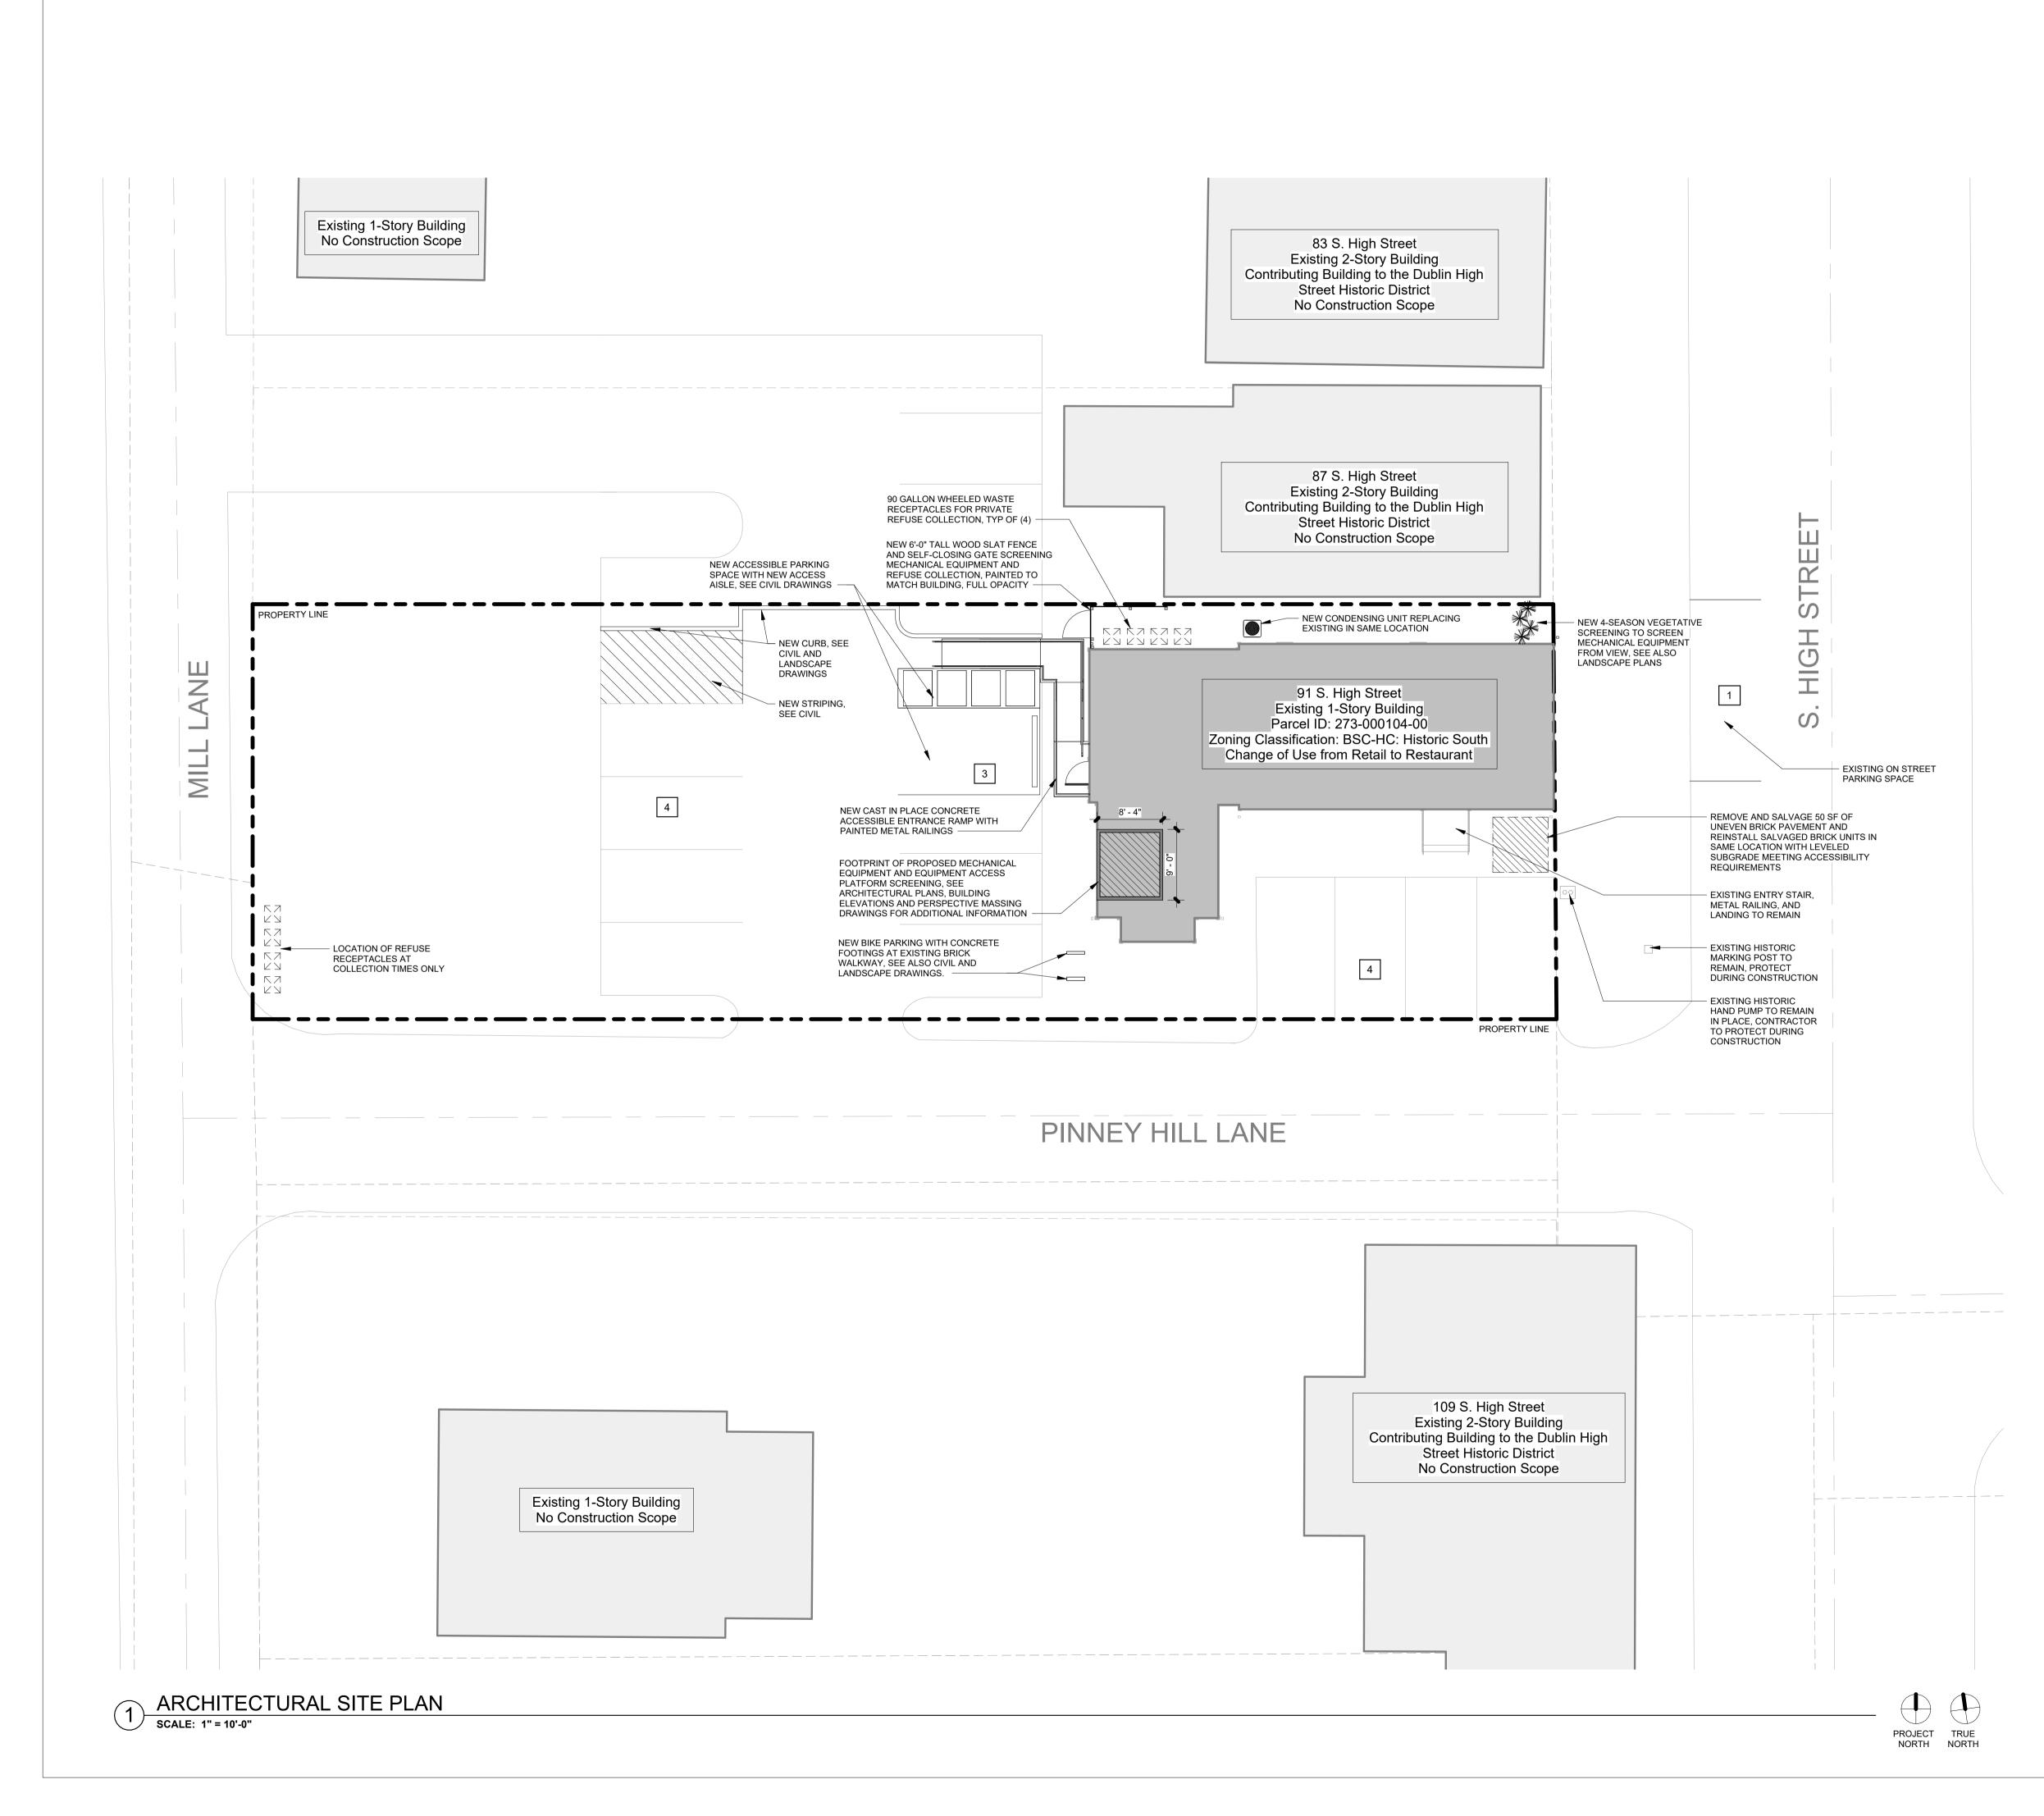PARCEL #: 273-000104-00

ZONING REQU	JIREMENT AND DATA SUMMARY
PROJECT DESCRIPTION:	Change of use at an existing one-story building from retail to restaurant uses. No change in building footprint proposed. New work includes addition of accessible parking space, painting of building exterior with colors from ARB preapproved list, and addition of rooftop HVAC equipment to serve new restaurant kitchen.
EXISTING USE: R PROPOSED USE:	etail, General Eating and Drinking (PERMITTED PER TABLE 153.172A)
PROPOSED INDO BUILDING HEIGH	G FOOTPRINT AREA: 1457 SF (EXISTING AREA, NO CHANGE PROPOSED) OR GROSS AREA*: 1190 SF T: 16'-0" (EXISTING HEIGHT, NO CHANGE PROPOSED) HANGES PROPOSED
OFF-STREET PAR	RKING CALCULATION
11 Off Street Vehic	le parking spaces proposed
TABLE 153.173C:	REQUIRED VEHICLE PARKING
<u>Use</u> Eating and Drinking	Minimum RequiredMaximum Permittedg10 per 1,000 sq ft.125% of minimum
Indoor Gross Area [*] 635 SF Dining F 475 SF Kitchen 80 SF Toilet Ro	Room & Bar
Vehicle Parking Ca	lculation = 1190 SF @ 10 per 1000 sf = 11.9 vehicle parking spaces
12 minimum vehicle	e parking spaces required
	spaces to be provided on site rking space at front of property
*Per 153.173 (7)(a) on indoor gross floo	3, all square footage requirements for required vehicle parking are based or area

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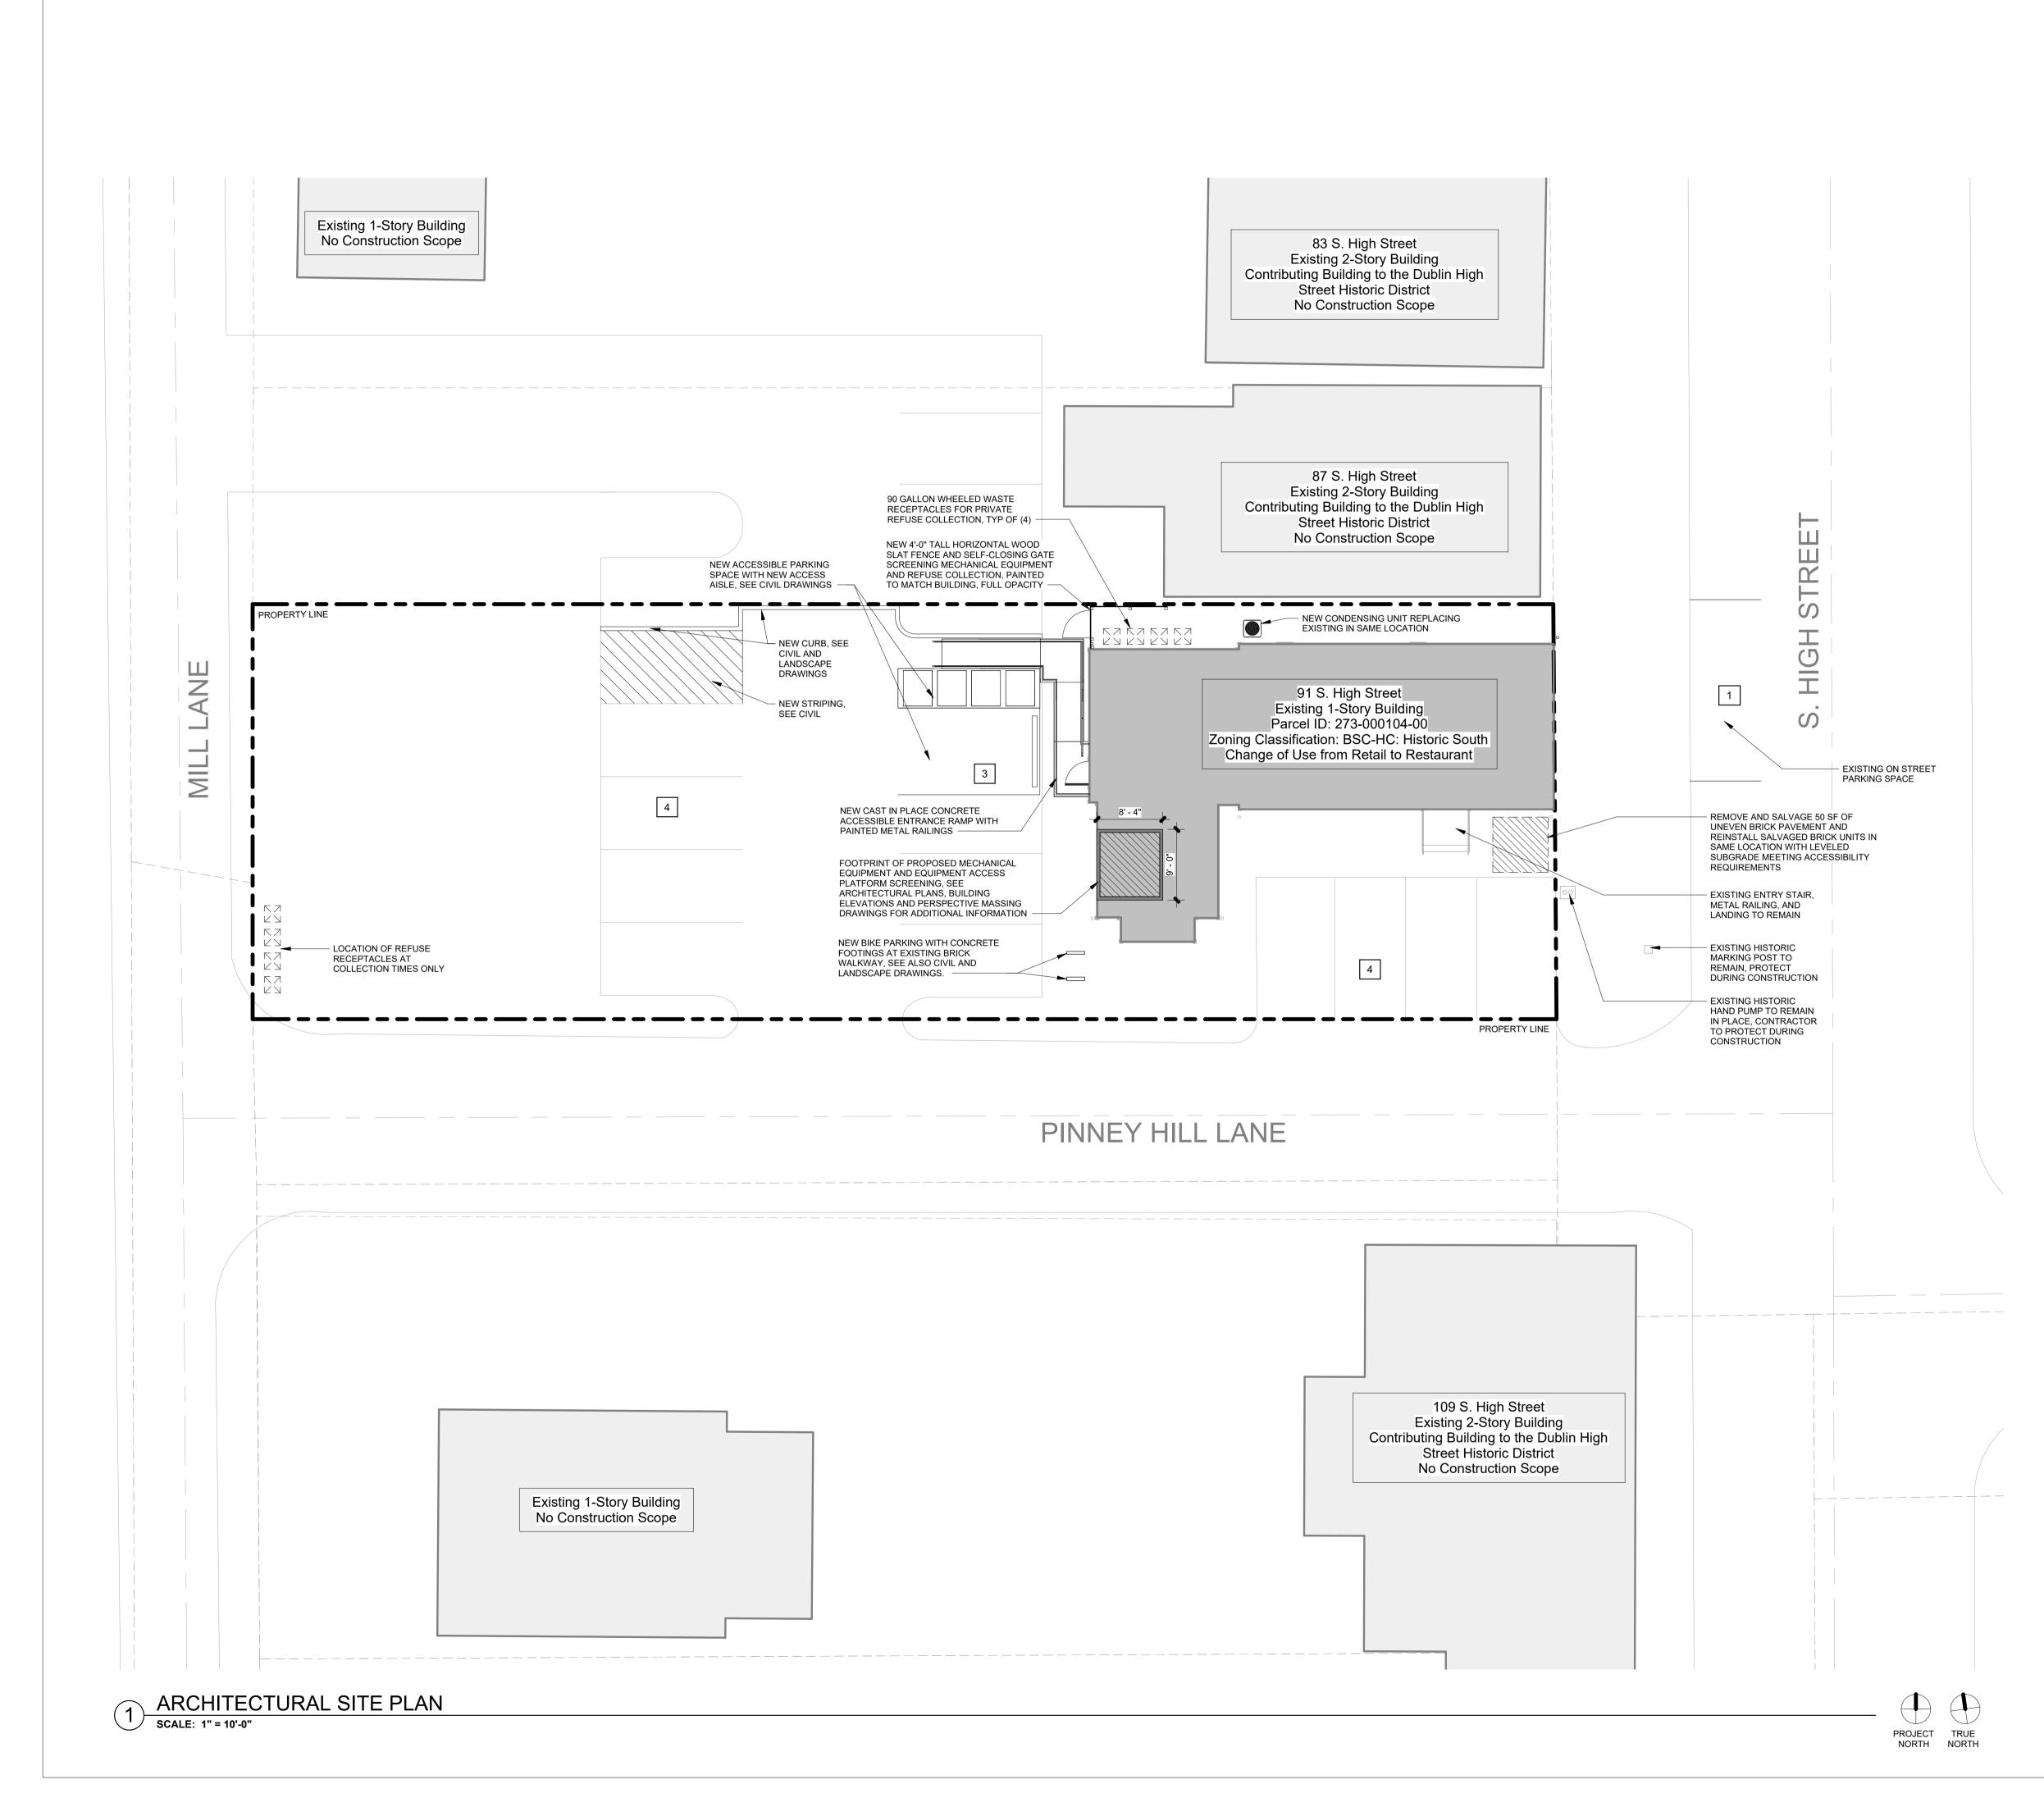


ALL SEEDING INSTALLATION SHALL CONFORM TO ODOT SPECIFICATIONS. SEED AT 6 LBS/1000 SF WITH THE	
FOLLOWING SEED MIXTURE:	
KENTUCKY BLUEGRASS	30%
CREEPING FESCUE	30%
ANNUAL RYEGRASS	20%
PERENNIAL RYEGRASS	103

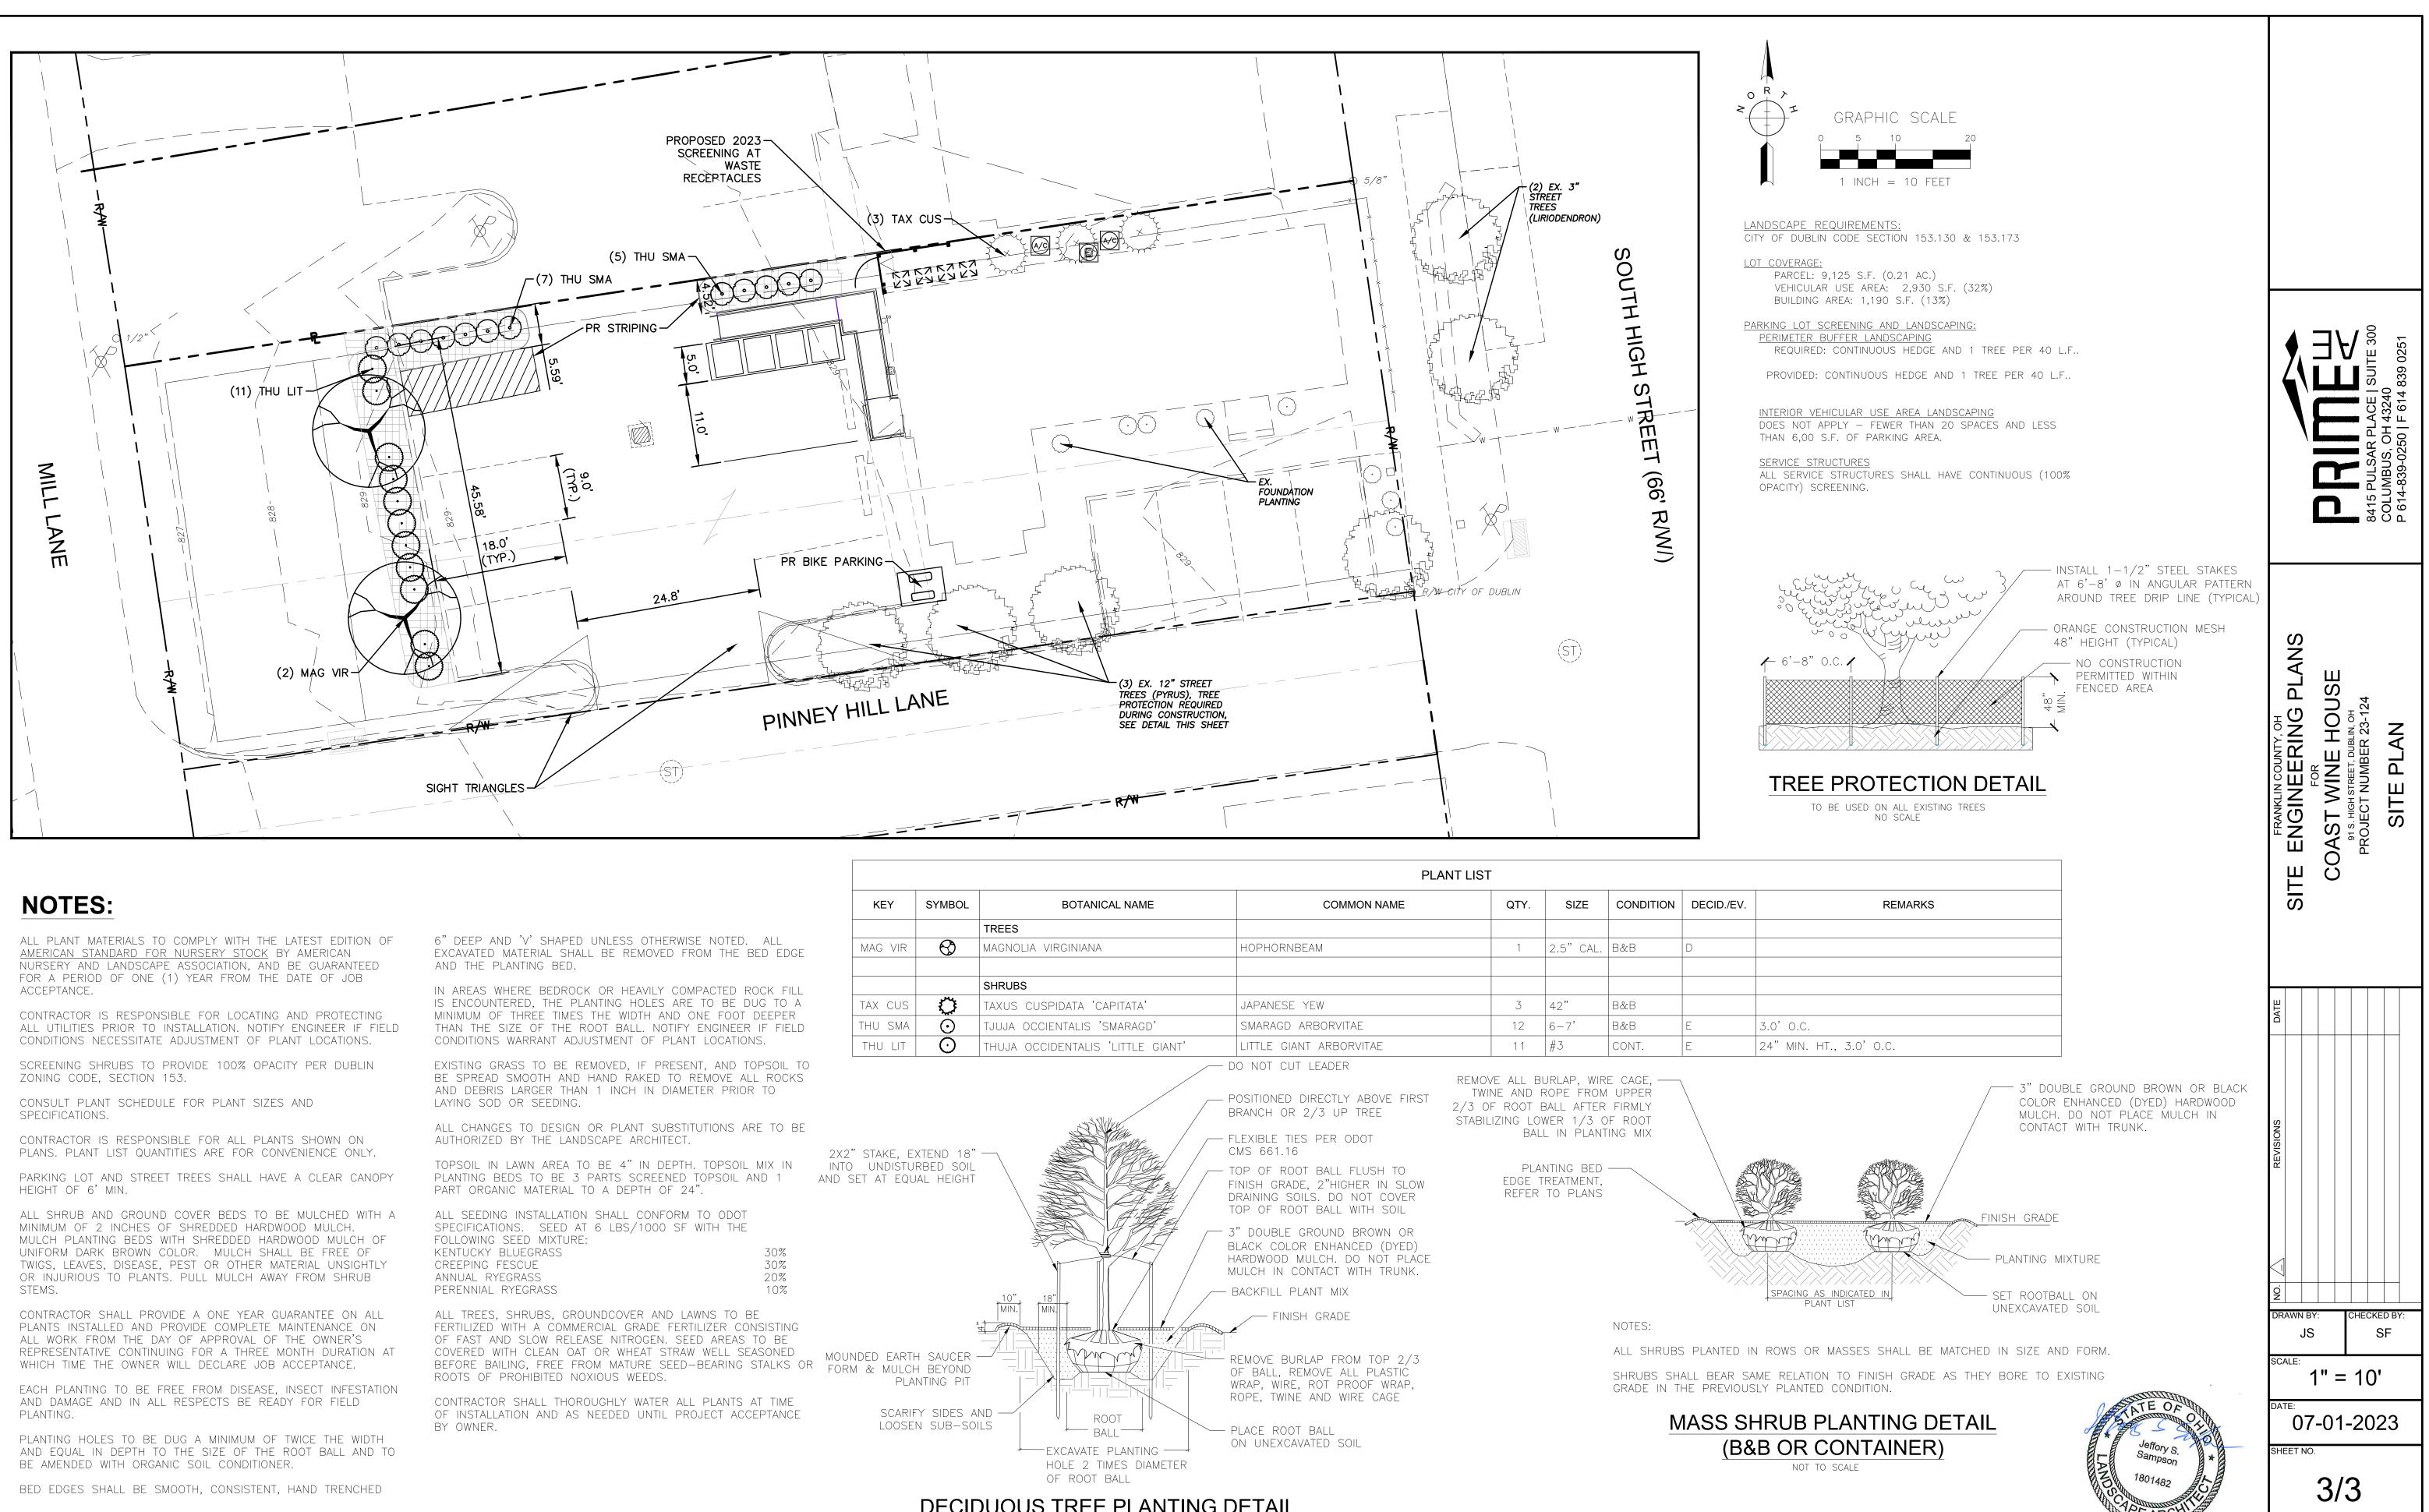		PLA	ANTLIST				
KEY SYMBOL	BOTANICAL NAME	COMMON NAME	QTY	. SIZE	CONDITION	DECID./EV.	
	TREES						
mag vir 😚	MAGNOLIA VIRGINIANA	HOPHORNBEAM	1	2.5" CAL	B&B	D	
	SHRUBS						
TAX CUS	TAXUS CUSPIDATA 'CAPITATA'	JAPANESE YEW	3	42"	B&B		
THU SMA O	TJUJA OCCIENTALIS 'SMARAGD'	SMARAGD ARBORVITAE	12	6-7'	B&B	E	3.0'C
THU LIT O	THUJA OCCIDENTALIS 'LITTLE GIANT'	LITTLE GIANT ARBORVITAE DO NOT CUT LEADER	11	#3	CONT.	E	24" M
" STAKE, EXTEND 18" D UNDISTURBED SOIL SET AT EQUAL HEIGHT NDED EARTH SAUCER M & MULCH BEYOND PLANTING PIT SCARIFY SIDES A LOOSEN SUB-SC		 POSITIONED DIRECTLY ABOVE FIRST BRANCH OR 2/3 UP TREE FLEXIBLE TIES PER ODOT CMS 661.16 TOP OF ROOT BALL FLUSH TO FINISH GRADE, 2"HIGHER IN SLOW DRAINING SOILS. DO NOT COVER TOP OF ROOT BALL WITH SOIL 3" DOUBLE GROUND BROWN OR BLACK COLOR ENHANCED (DYED) HARDWOOD MULCH. DO NOT PLACE MULCH IN CONTACT WITH TRUNK. BACKFILL PLANT MIX FINISH GRADE REMOVE BURLAP FROM TOP 2/3 OF BALL, REMOVE ALL PLASTIC WRAP, WIRE, ROT PROOF WRAP, ROPE, TWINE AND WIRE CAGE PLACE ROOT BALL ON UNEXCAVATED SOIL 	2/3 OF ROO STABILIZING E F EDG	D ROPE FROI T BALL AFTER LOWER 1/3 BALL IN PLAN LANTING BED TREATMENT ER TO PLANS	R FIRMLY OF ROOT TING MIX - NOTES: ALL SHRUBS SHRUBS SH GRADE IN T	S PLANTED II ALL BEAR SA HE PREVIOUS MASS SI (B8	AME RE Sly pla

DECIDUOUS TREE PLANTING DETAIL

NOT TO SCALE




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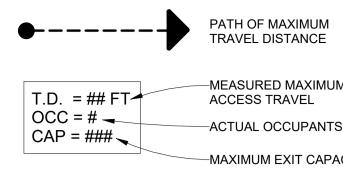
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CODE PLAN LEGEND



	CODE REQUIREMENTS AND ANALYSIS		
	PROJECT DESCRIPTION: Alteration of existing building to change use of building from retail and salon business to restaurant.		
	BUILDING ADDRESS:91 S. High StreetYEAR CONSTRUCTED:1840s		
UM EXIT	AHJ: CITY OF DUBLIN AREA OF BUILDING: 1457 SF		
TS SERVED PACITY	APPLICABLE CODES:2017 OHIO BUILDING CODE2017 OHIO MECHANICAL CODE2017 OHIO PLUMBING CODE2017 OHIO FIRE CODE2012 INTERNATIONAL ENERGY CODE2010 ASHRAE 90.12015 INTERNATIONAL FUEL GAS CODE2017 NATIONAL ELECTRIC CODE, NFPA 70	Z	8 (0
	CHAPTER 3: USE AND OCCUPANCY EXISTING BUILDING USE: MIXED USE, NON-SEPARATED - GROUP M MERCHANTILE (309.1: RETAIL STORE) - GROUP B BUSINESS (304.1: BEAUTY SHOP)	UNZELMAN	architecture + interiors 333 Stewart Ave Columbus, OH 43206 614-674-6696
	PROPOSED BUILDING USE: - GROUP A-2 ASSEMBLY (303.3: RESTAURANTS)	NN	intectul 33 Ste umbus 614-6
	CHAPTER 5: GENERAL BUILDING HEIGHTS AND AREAS TYPE V-B, NON-SPRINKLERED, A-2 OCCUPANCY	GUI	arch 3 Colt
	EXISTING BUILDING HEIGHT: 18 FEET, 1 STORY; NO HEIGHT CHANGE PROPOSED EXISTING BUILDING AREA: 1,457 SF; NO AREA CHANGES PROPOSED		
	ALLOWABLE HEIGHT AND TABULAR AREA Table 504.3 Table 504.4 Table 506.2 <u>USES HEIGHT STORIES TABULAR AREA</u> (NS) A-2 40'-0" 1 6,000 SF	PJT #	: 23-124
	(PROPOSED OCCUPANCY COMPLIES WITH HEIGHT AND AREA LIMITS FOR V-B CONSTRUCTION TYPE)		
	CHAPTER 6: TYPE OF CONSTRUCTIONCONSTRUCTION TYPE:EXISTING TYPE V-B (OBC TABLE 601)COMPONENTREQUIRED FIRE RATING IN HRS (F.R.R.)STRUCTURAL FRAME0 HRSBEARING WALLS (EXT)0 HRSBEARING WALLS (EXT)0 HRSNON BEARING WALLS (INT)0 HRSNON BEARING WALL (EXT)Varies, see Table 602NON BEARING WALL (INT)0 HRSFLOOR0 HRSROOF0 HRSNON CHANGES)ROOF0 HRSROOF0 HRS<		
	TABLE 602 FIRE-RESISTANCE RATING REQUIREMENTS FOR EXTERIOR WALLSGROUPS A-2: TYPE V-BFIRE SEP. DISTANCECOMMENTX < 5		
	10 ≤ X < 30		
	SUPPRESSION NOT REQUIRED PER OBC 903 FIRE ALARM: NONE EXISTING IN TENANT SPACE, NO CHANGES PROPOSED		
	FIRE ALARM SYSTEM NOT REQUIRED PER OBC 907 CHAPTER 10: MEANS OF EGRESS		
	OCCUPANT LOAD CALCULATIONS FLOOR AREAS WITHOUT FIXED SEATING (TABLE 1004.1.2) FUNCTION OF SPACE FACTOR AREA OCC. LOAD		
- 0" F.S.D.	FONCTION OF SPACEFACTORAREAOCC. LOADDining Room and Bar15 net44029Kitchen200 gross4753	et	
ع ^ت ⊐	FLOOR AREAS WITH FIXED SEATING (SECTION 1004.4) <u>SEATING AREA FACTOR LENGTH</u> OCC. LOAD Dining Room East Banquet 1 occ. / 24" 20'-0" 10 Dining Room West Banquet 1 occ. / 24" 13'-0" 7	Stree	
	TOTAL OCCUPANCY OF TENANT SPACE:49 OCCUPANTSCHAPTER 11: ACCESSIBILITY - SEE CH. 3411	gh	017
-0	CHAPTER 13: ENERGY EFFICIENCY <u>1301.1.1 Criteria</u> - Buildings shall be designed and constructed in accordance with the	Ï	OH 43017
2.	International Energy Conservation Code - (2012 IECC REFERNCED IN OBC CH 35)	<u>.</u>	DUBLIN, (
9 - 0 -	Register of Historic Places; designated as a historic property under local or state designation law or survey; certified as a contributing resource with a National Register listed or locally designated historic district; are exempt from this code. (BUILDING IS LISTED ON NATIONAL REGISTER OF HISTORIC PLACES AND IS A CONTRIBUTING RESOURCE TO HISTORIC DISTRIC; STRUCTURE IS EXEMPT FROM	9	
2'- 0"	REQUIREMENTS OF IECC PER C101.4.2) CHAPTER 29: PLUMBING		ATE
9 - 3	OBC TABLE 2902.1 Minimum Number of Required Plumbing Fixtures USE: A-2, Restaurant		1 10/28/2021
	WCs <u>Male Female LAVS TUB/SHOWERS DF * SERV SINK</u> 1 per 75 1 per 200 None Required 1 per 500 1		
2' - 0"	Occupants: 49 Total FIXTURES PROVIDED: 2 WATER CLOSETS, 2 LAVATORYS, 1 SERVICE SINK		
₽ ►	*(See Section 410 of the plumbing code for Drinking Fountain exceptions) <u>OPC Section 410.4 Substitution</u> Where restaurants provide drinking water in a container free of charge, drinking fountains shall not be required in those restaurants. In other occupancies, where water dispensers are provided, drinking fountains shall not be required. (WATER TO BE PROVIDED BY RESTAURANT FREE OF CHARGE)		
	 OPC Section 410.4 Substitution Where restaurants provide drinking water in a container free of charge, drinking fountains shall not be required in those restaurants. In other occupancies, where water dispensers are provided, drinking fountains shall not be required. (WATER TO BE PROVIDED BY RESTAURANT FREE OF CHARGE) CHAPTER 34: EXISTING BUILDINGS AND STRUCTURES Section 3401.1.1 Compliance: Compliance shall be demonstrated by meeting the requirements of one of the following: 1. Chapters 2 through 33 of this code; or 2. Sections 3403 through 3411; or 3. Section 3412 Compliance Alternatives. 	JLAN	Ę
	OPC Section 410.4 Substitution Where restaurants provide drinking water in a container free of charge, drinking fountains shall not be required in those restaurants. In other occupancies, where water dispensers are provided, drinking fountains shall not be required. (WATER TO BE PROVIDED BY RESTAURANT FREE OF CHARGE) CHAPTER 34: EXISTING BUILDINGS AND STRUCTURES Section 3401.1.1 Compliance: Compliance shall be demonstrated by meeting the requirements of one of the following: 1. Chapters 2 through 33 of this code; or 2. Sections 3403 through 3411; or 3. Section 3412 Compliance Alternatives. (COMPLIANCE SHALL BE DEMONSTRATED BY OPTION #2, 3403-3411) 3401.1.1 Energy Code Compliance: Alterations, repairs, additions and changes of occupancy to, or relocation of, existing buildings and structures shall also comply with the provisions for alterations, repairs, additions and changes of occupancy or relocation in the International Energy Conservation Code, and the ASHRAE 90.1 as referenced in Chapter 35	SAFETY PLA	lication
	OPC Section 410.4 Substitution Where restaurants provide drinking water in a container free of charge, drinking fountains shall not be required in those restaurants. In other occupancies, where water dispensers are provided, drinking fountains shall not be required. (WATER TO BE PROVIDED BY RESTAURANT FREE OF CHARGE) CHAPTER 34: EXISTING BUILDINGS AND STRUCTURES Section 3401.1.1 Compliance: Compliance shall be demonstrated by meeting the requirements of one of the following: 1. Chapters 2 through 33 of this code; or 2. Sections 3403 through 3411; or 3. Section 3412 Compliance Alternatives. (COMPLIANCE SHALL BE DEMONSTRATED BY OPTION #2, 3403-3411) 3401.1.1.1 Energy Code Compliance: Alterations, repairs, additions and changes of occupancy to, or relocation of, existing buildings and structures shall also comply with the provisions for alterations, repairs, additions and changes of occupancy Conservation Code, and the ASHRAE 90.1 as referenced in Chapter 35 (STRUCTURE IS EXEMPT FROM REQUIREMENTS OF IECC PER IECC C101.4.2)) 3411 Accessibility for Existing Buildings 3411.4.2 Complete Change of Occupancy: Where an entire building undergoes a change of occupancy, it shall comply with Section 3411.4.1 and shall have all of the following accessible	SAFETY PLA	3 Application
	OPC Section 410.4 Substitution Where restaurants provide drinking water in a container free of charge, drinking fountains shall not be required in those restaurants. In other occupancies, where water dispensers are provided, drinking fountains shall not be required. (WATER TO BE PROVIDED BY RESTAURANT FREE OF CHARGE) CHAPTER 34: EXISTING BUILDINGS AND STRUCTURES Section 3401.1.1 Compliance: Compliance shall be demonstrated by meeting the requirements of one of the following: 1. Chapters 2 through 33 of this code; or 2. Section 3412 Compliance Alternatives. (COMPLIANCE SHALL BE DEMONSTRATED BY OPTION #2, 3403-3411) 3401.1.11 Energy Code Compliance: Alterations, repairs, additions and changes of occupancy to, or relocation of, existing buildings and structures shall also comply with the provisions for alterations, repairs, additions and changes of occupancy conservation Code, and the ASHRAE 90.1 as referenced in Chapter 35 (STRUCTURE IS EXEMPT FROM REQUIREMENTS OF IECC PER IECC C101.4.2)) 3411 Accessibility for Existing Buildings 3411.4.2 Complete Change of Occupancy: Where an entire building undergoes a change of occupancy, it shall comply with Section 3411.4.1 and shall have all of the following accessible features: 1.At least one accessible building entrance. (COMPLIES) 2. At least one accessible route from an accessible building entrance to primary function areas.	DATA AND LIFE SAFETY PLA	
	 <u>ÓPC Section 410.4 Substitution</u> Where restaurants provide drinking water in a container free of charge, drinking fountains shall not be required in those restaurants. In other occupancies, where water dispensers are provided, drinking fountains shall not be required. (WATER TO BE PROVIDED BY RESTAURANT FREE OF CHARGE) CHAPTER 34: EXISTING BUILDINGS AND STRUCTURES Section 3401.1.1 Compliance: Compliance shall be demonstrated by meeting the requirements of one of the following: 1. Chapters 2 through 33 of this code; or 2. Sections 3403 through 3411; or 3. Section 3412 Compliance Alternatives. (COMPLIANCE SHALL BE DEMONSTRATED BY OPTION #2, 3403-3411) 3401.1.1.1 Energy Code Compliance: Alterations, repairs, additions and changes of occupancy to, or relocation of, existing buildings and structures shall also comply with the provisions for alterations, repairs, additions and chapter 35 (STRUCTURE IS EXEMPT FROM REQUIREMENTS OF IECC PER IECC C101.4.2)) 3411 Accessibility for Existing Buildings 3411.4.2 Complete Change of Occupancy: Where an entire building undergoes a change of occupancy, it shall comply with Section 3411.4.1 and shall have all of the following accessible features: A.At least one accessible building entrance. (COMPLIES) A tleast one accessible route from an accessible building entrance to primary function areas. (COMPLIES) 	CODE DATA AND LIFE SAFETY PLA	PHASE :
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SOFFIT AS APPLICABLE-

TO REMAIN-

SCHEDULED-

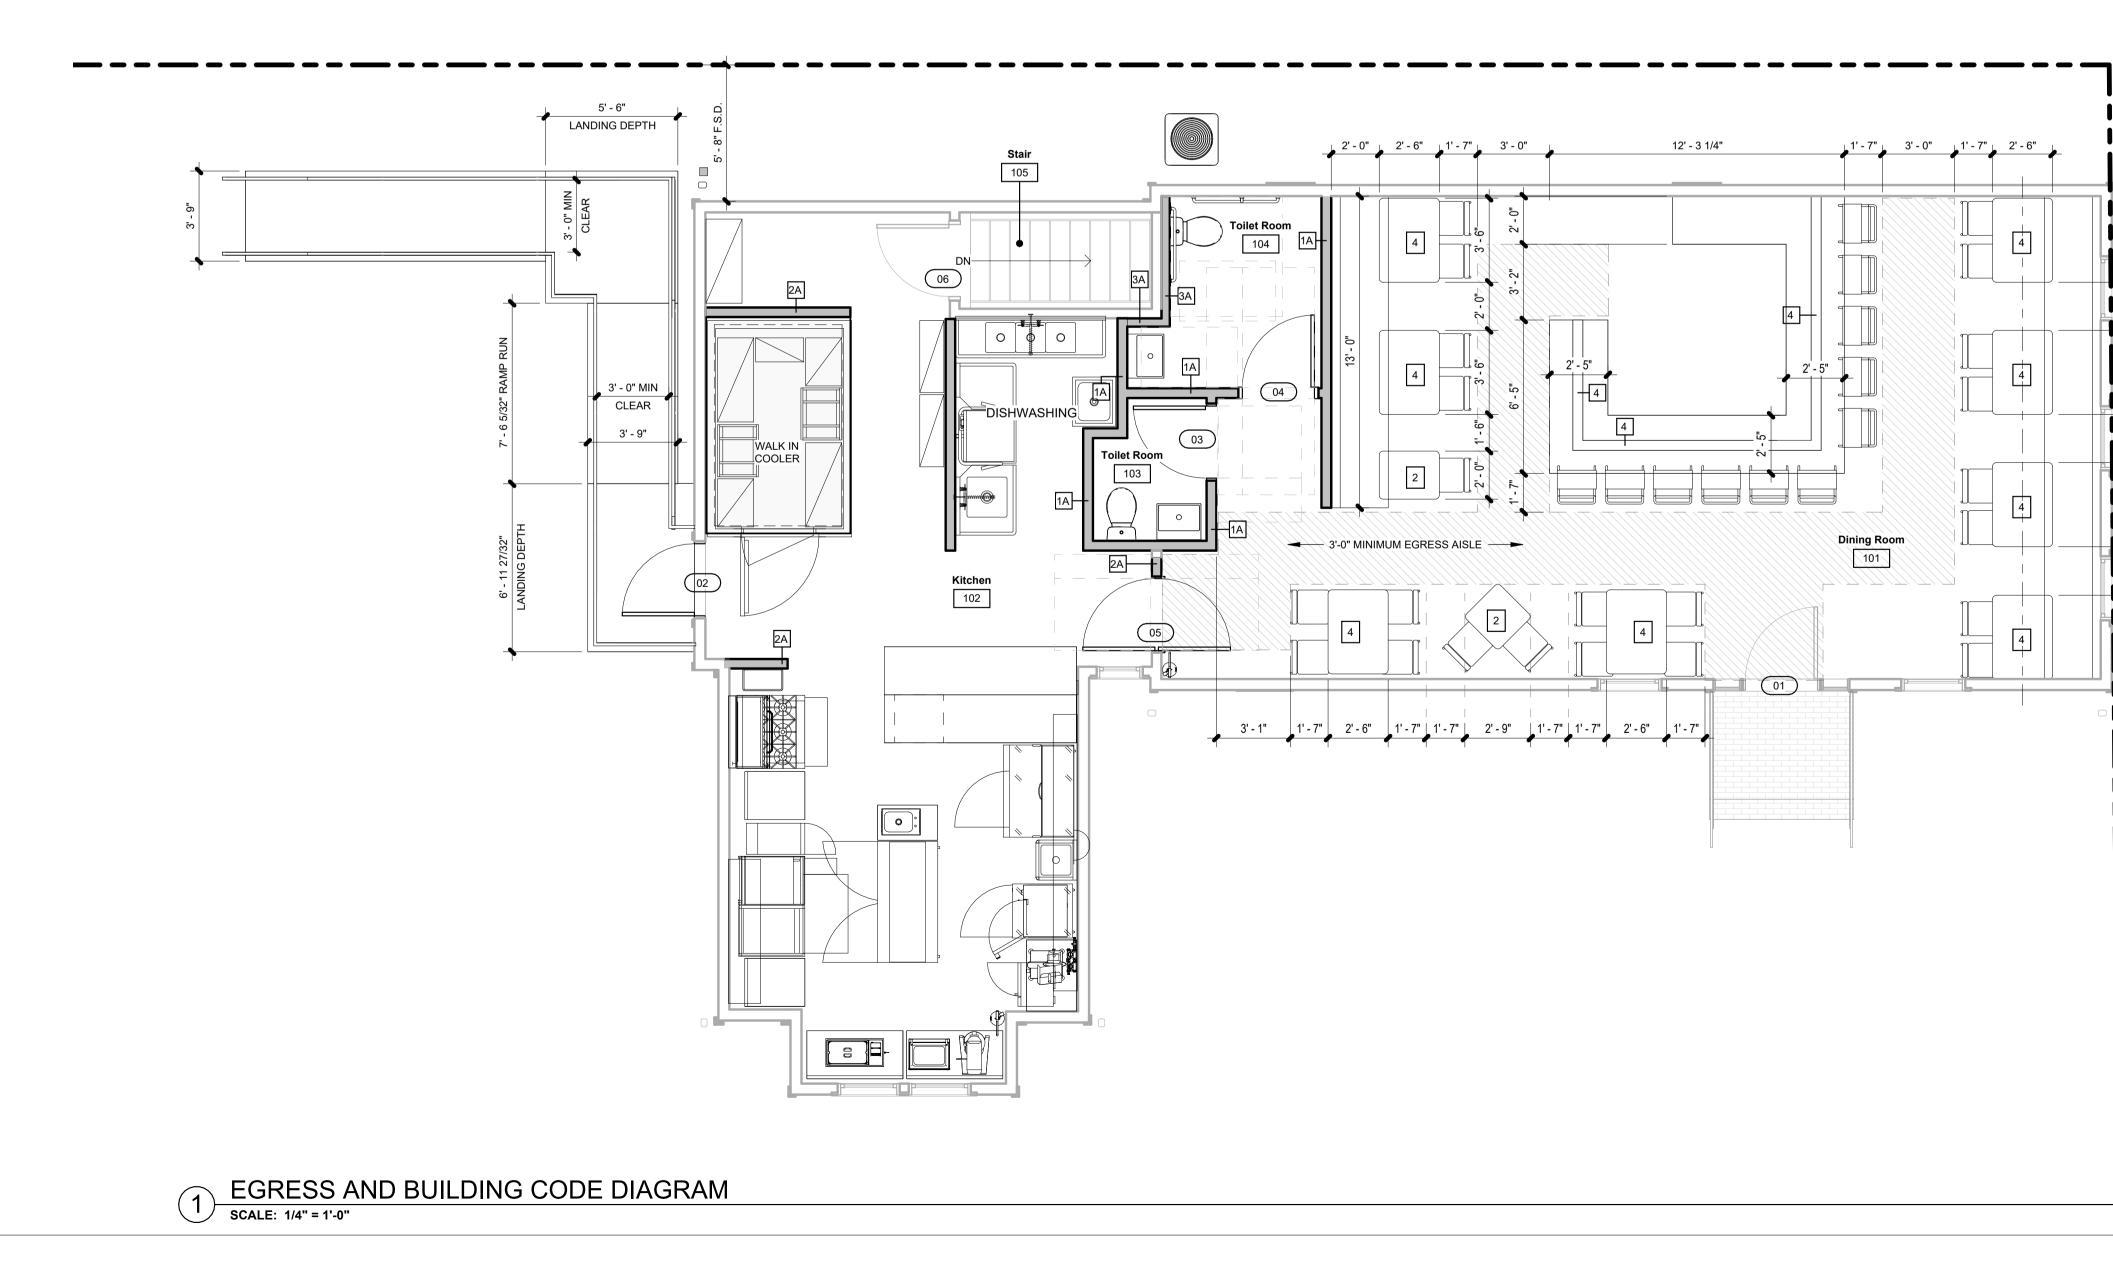FINISH PER ELEVATIONS-

STRUCTURAL DRAWINGS-

А



CONTINUOUS SEALANT-

TOP PLATE-

1/2" MINIMUM PLYWOOD SHEATHING-

FRP WALL PANELING-

WOOD WALL PANELING

2X6 WOOD STUD FRAMING AT 16" ON CENTER MAXIMUM

PLUMBING SERVING BAR EQUIPMENT, GENERAL BETWEEN TRADES-

WALL BASE AS SCHEDULED-


SILL PLATE-


TOP OF FLOOR DECK/SLAB-


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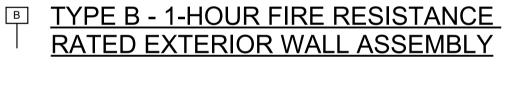



WALL TYPES - INTERIOR



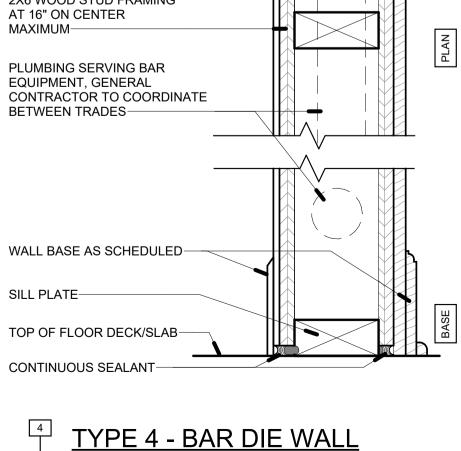

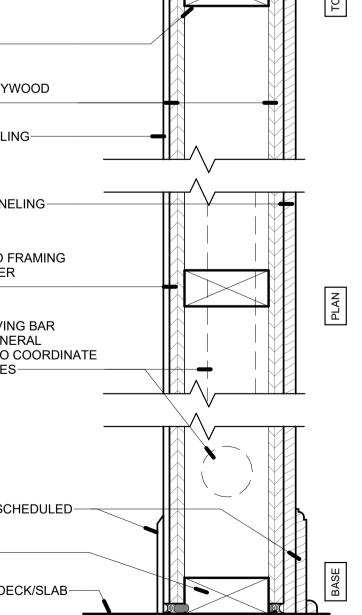

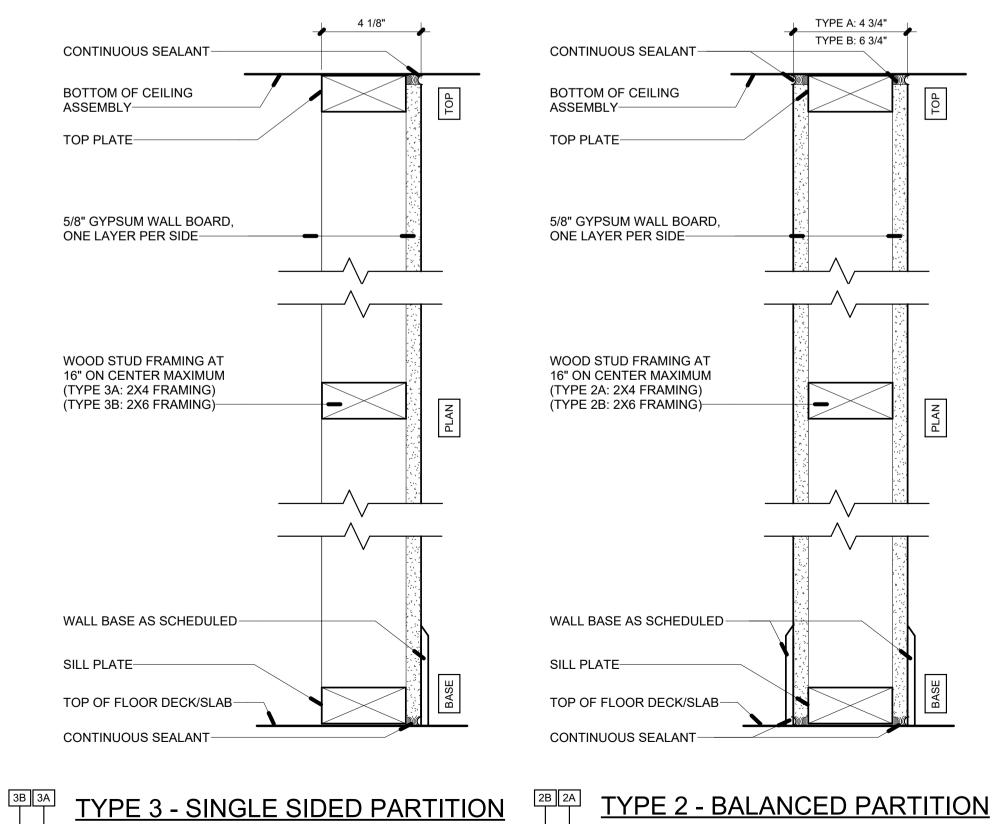


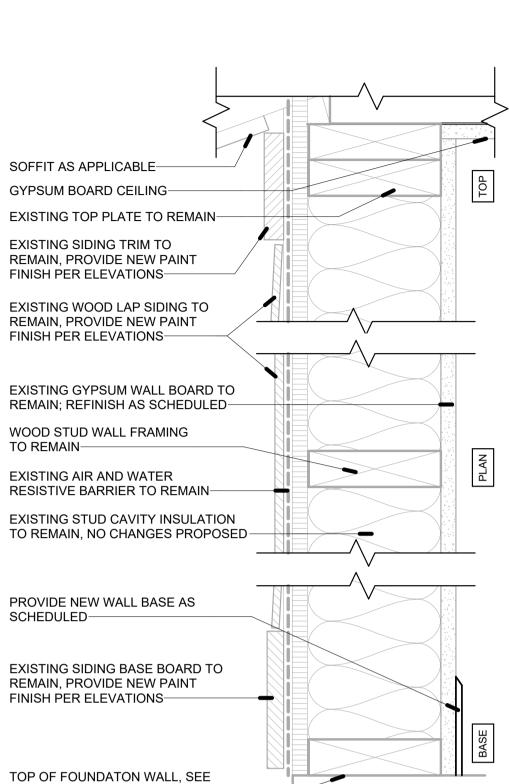

TYPE A - EXISTING EXTERIOR WALL ASSEMBLY

5 1/4"

2 WALL TYPES - EXTERIOR SCALE: 3" = 1'-0"

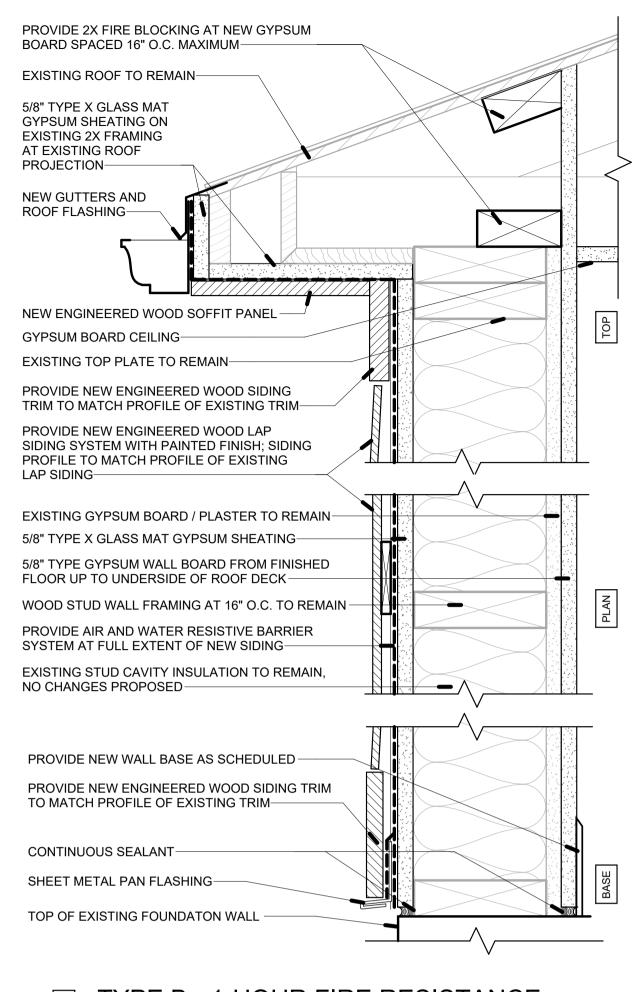



1. ALL SEAMS BETWEEN THE LAYERS OF GYPSUM BOARD IN MULTI-LAYER PARTITIONS SHOULD BE STAGGERED AND TAPED. THE ENTIRE PERIMETER OF THE OUTER LAYER OF GYPSUM BOARD SHOULD BE SEALED AIRTIGHT WITH RESILIENT SEALANT.

2. AT PARTITIONS INDICATED TO HAVE ACOUSTIC DESIGNS, CONTRACTOR TO SEPARATE ELECTRICAL ROUGH-IN BOXES BY 24" MINIMUM, SEAL ALL BOX OPENINGS WITH 1/8" THICK MINIMUM CLAY PACKING MATERIAL, AND CAULK ALL JOINTS BETWEEN THE ELECTRICAL ROUGH-IN BOXES AND THE GYPSUM BOARD. SEE ACOUSTIC DETAILS ON SHEET A-7.0

3. PROVIDE PAINTABLE RESILIENT SEALANT AT ALL PENETRATIONS IN PARTITIONS, SEE ACOUSTIC DETAILS ON SHEET A-7.0


4. GYPSUM WALL BOARD INSTALLED AS PART OF PARTITIONS WITH LINEAR PLAN GEOMETRY TO BE 5/8" THICK UNLESS NOTED OTHERWISE


5. WHERE WALL TILE IS INSTALLED FRAMED PARTITIONS, PROVIDE STUD SPACING AT NO GREATER THAN 16" ON CENTER AND PROVIDE FRAMING DESIGNED TO PROVIDE LATERAL DEFELECTION OF NO MORE THAN L/360 WHEN STUDS ARE INSTALLED BETWEEN FLOOR AND DECK ABOVE

6. FOR PARTITIONS SUPPORTING WALL MOUNTED CASEWORK, A/V DISPLAY SCREENS, OR SIMILAR ITEMS, PROVIDE IN-WALL BLOCKING AT MOUNTING HEIGHTS SHOWN ON DRAWINGS. IF MOUNTING HEIGHTS ARE NOT NOTED, SUBMIT R.F.I. TO OWNER AND ARCHITECT

7. GENERAL CONTRACTOR TO COORDINATE STUD DEPTHS BETWEEN TRADES TO ENSURE ALL CONDUITS, PIPES, DRAIN LINES, CABLES, AND SIMILAR ITEMS ARE CONCEALED WITHIN OR BEHIND STUD CAVITIES IN SPACES BELOW FINISHED CEILINGS UNLESS OTHER DRAWINGS SPECIFICALLY INDICATE THAT ABOVE REFERENCED ITEMS ARE INTENDED TO BE EXPOSED TO VIEW. IF CONDUITS, PIPES, DRAIN LINES, CABLES, OR SIMILAR ITEMS DO NOT FIT WITHIN MINIMUM STUD SIZES INDICATED ON PARTITION TYPE DETAILS, CONTRACTOR TO PROVIDE WIDER STUD CAVITY AS REQUIRED.



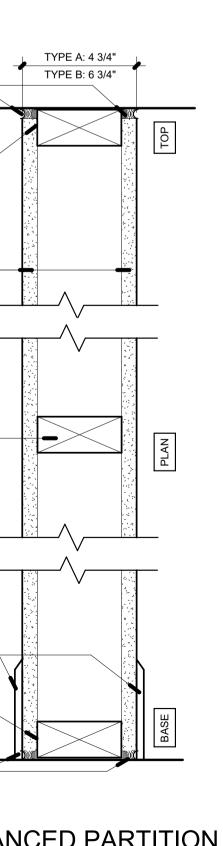

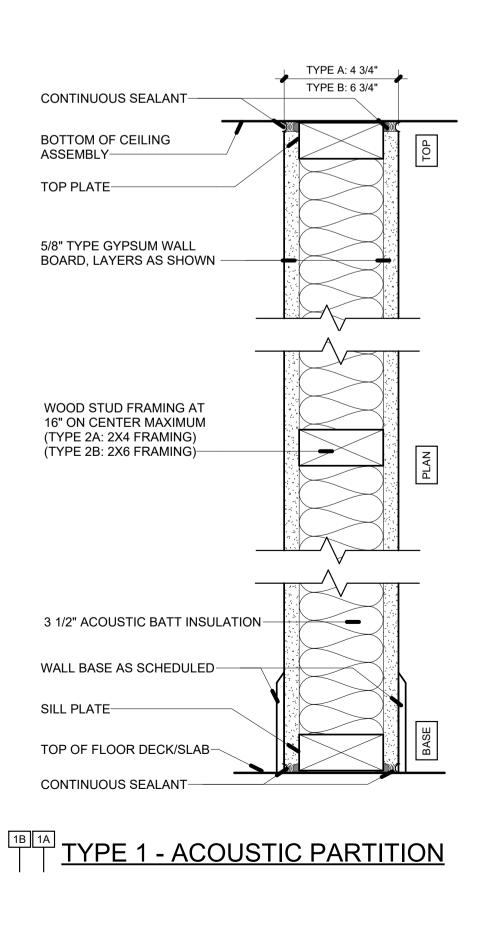




LOOKING NORTH FROM PINNEY HILL LANE TOWARD SOUTH BUILDING FACADE; METAL AND FABRIC AWNING PICTURED TO BE REMOVED



LOOKING NORTH WEST FROM PINNEY HILL LANE TOWARD SOUTH AND EAST BUILDING FACADES; METAL AND FABRIC AWNING PICTURED TO BE REMOVED LOOKING NORTH EAST FROM PINNEY HILL LANE TOWARD SOUTH AND WEST BUILDING FACADES AND EXISTING PATIO

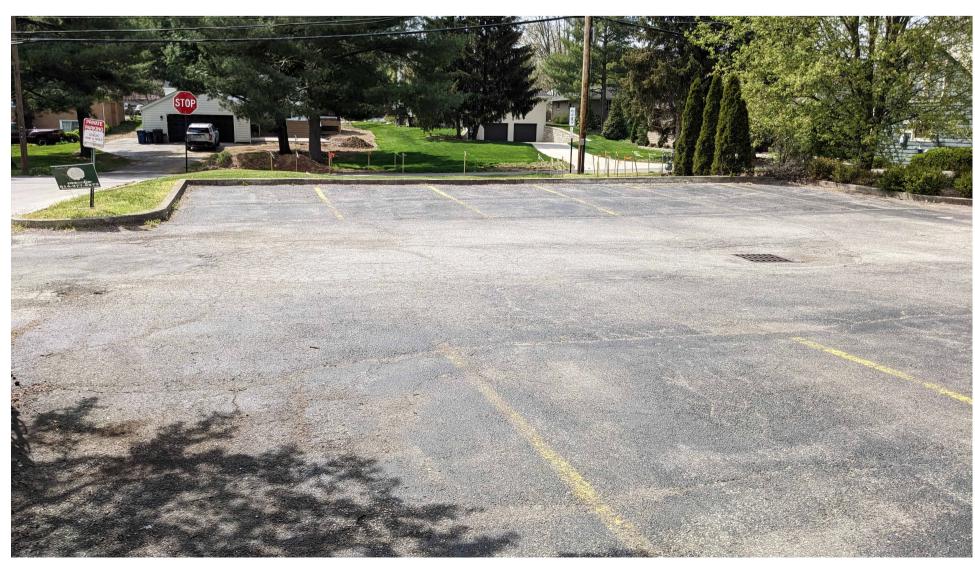

LOOKING WEST EXISTING SIDEWALK AT WEST BUILDING FACADE TOWARD EXISTING PARKING LOT AND MILL LANE BEYOND






LOOKING WEST FROM EAST SIDEWALK ON S. HIGH STREET TOWARD EAST BUILDING FACADE



LOOKING SOUTHWEST FROM WEST SIDEWALK ON S. HIGH STREET TOWARD NORTH AND EAST BUILDING FACADES



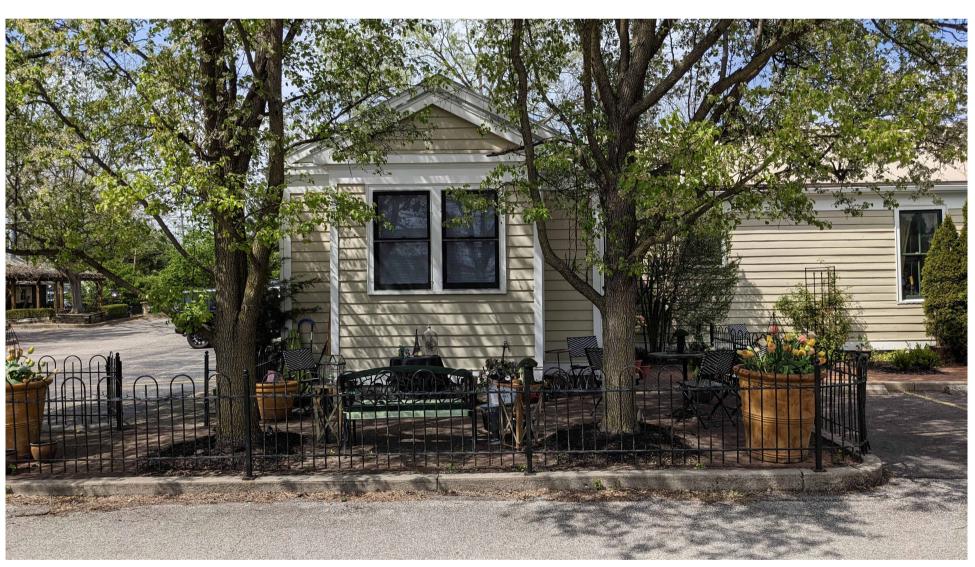

LOOKING NORTH FROM PINNEY HILL LANE TOWARD SOUTH BUILDING FACADE AND EXISTING PATIO

LOOKING EAST FROM EXISITNG PARKING LOT TOWARD NORTH BUILDING FACADE




LOOKING EAST FROM EXISTING PARKING LOT TOWARD WEST BUILDING FACADE, EXISTING RAMP, AND EXISTING SURFACE PARKING LOT

LMAN	+interiors	art Ave DH 43206 -6696
GUNZELMAN	architecture + interiors	333 Stewart Ave Columbus, OH 43206 614-674-6696
PJT	# : 23	-124
91 S. High Street	2	
		REVISIONS DATE
EXISTING CONDITIONS PHOTOGRAPHY		PHASE : ARB Application
DATI	E: 06,	/30/2023
<i> </i>	7-	0.4


O CEILING-MOUNTED LIGHT FIXTURE	
RECESSED CEILING-MOUNTED DOWNLIGHT	
PENDANT LIGHT FIXTURE	
Ď	WALL MOUNTED SCONCE LIGHT FIXTURE
	SURFACE-MOUNTED OR UNDERCABINET STRIP LIGHT
0	UNDERCABINET RECESSED "PUCK" LIGHT
CEILING EXHAUST FAN, SEE HVAC DRAWINGS	
CEILING RECESSED AUDIO SPEAKER	
\bigcirc	CIRCULAR HVAC DIFFUSER, SEE HVAC DRAWINGS
	EXISTING GYPSUM / PLASTER CEILING
	NEW OR REPAIRED GYPSUM CEILING

NOTES:

- 1. SEE ELECTRICAL DRAWINGS FOR LIGHT FIXTURE SPECIFICATION AND CIRCUITING, AND OTHER ELECTRICAL INFORMATION
- WHERE A SINGLE LIGHT IS SHOWN ON REFLECTED CEILING PLANS IN A ROOM, CONTRACTOR TO LOCATE THE LIGHT WITHIN THE CENTER OF THE ROOM IN BOTH DIRECTIONS UNLESS NOTED OTHERWISE
- 3. WHERE LIGHT FIXTURES ARE GRAPHICALLY SHOWN BETWEEN PARTITIONS, CENTER LIGHT FIXTURES BETWEEEN PARTITIONS UNLESS DIMENSIONS OR NOTES INDICATE OTHERWISE

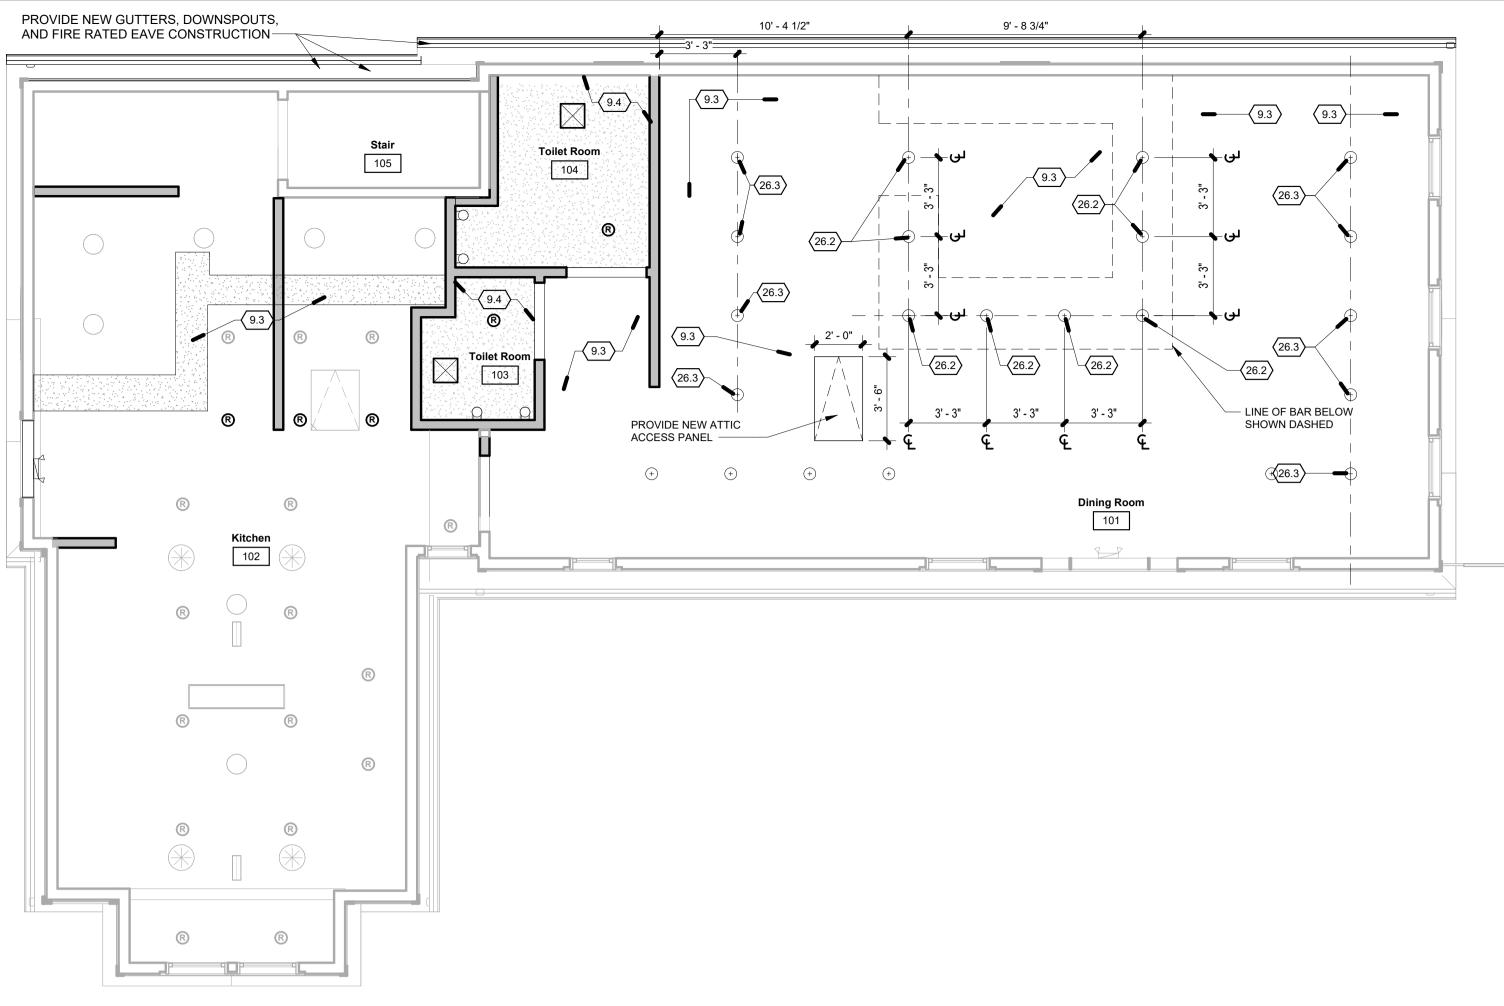



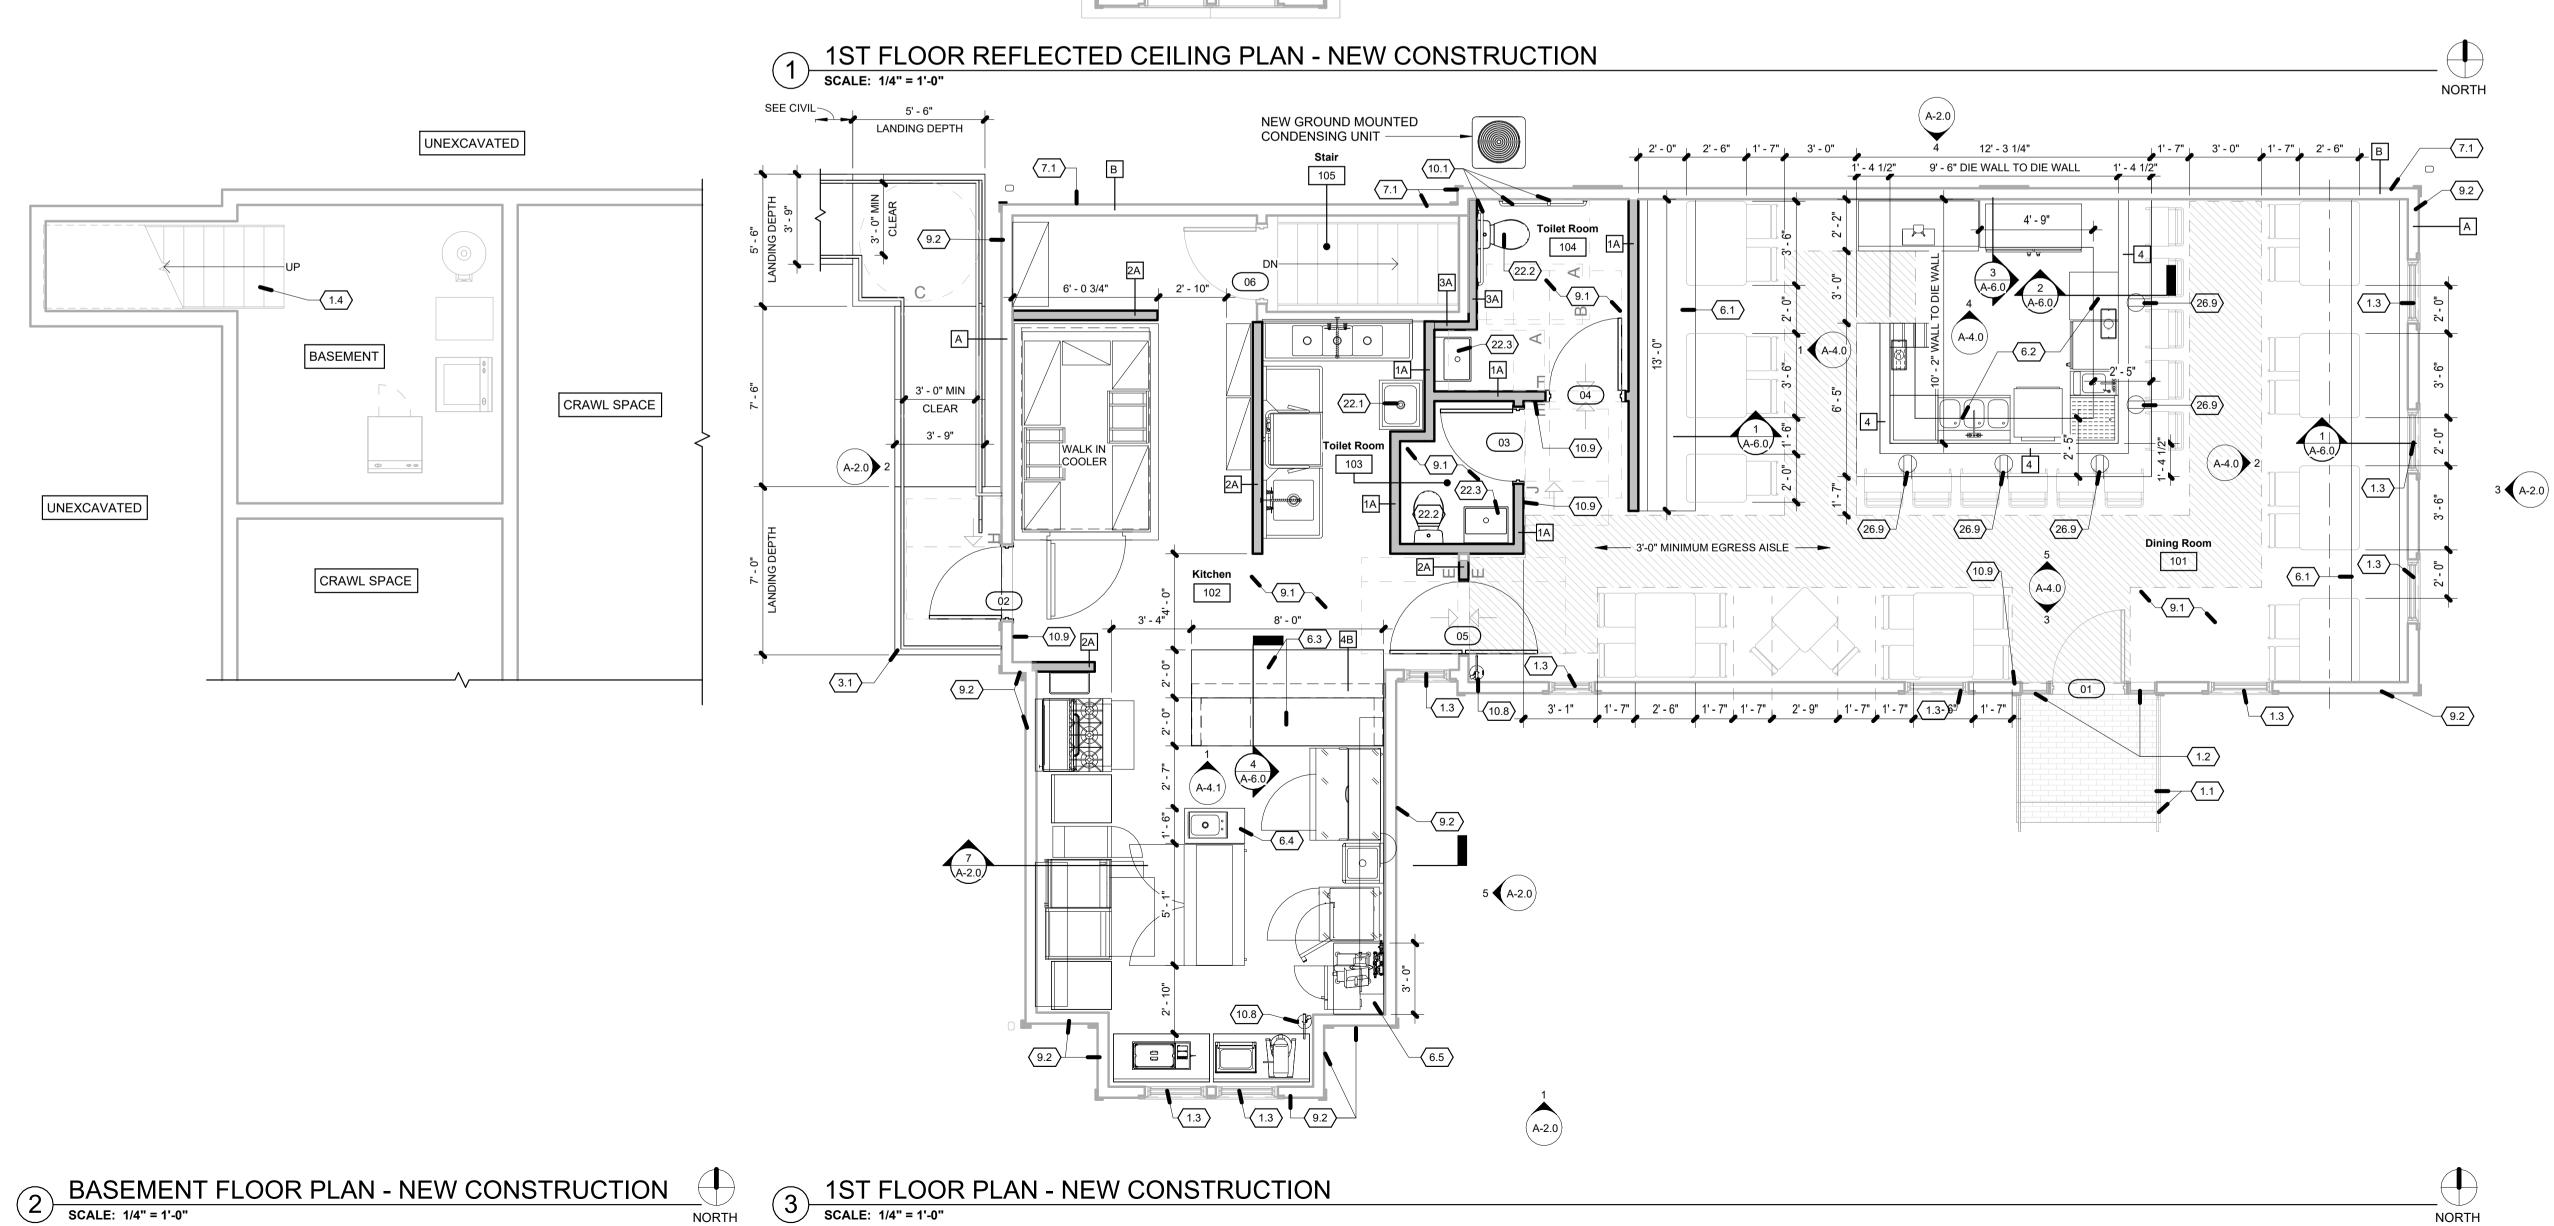

GENERAL PLAN NOTES

1. ALL ELEMENTS OF CONSTRUCTION ARE TO BE NEW UNLESS NOTED OTHERWISE

- 2. FINISH NOTES:
 A. ALL GYPSUM WALL BOARD PARTITIONS TO BE PROVIDED WITH A LEVEL 4 FINISH
 B. ALL FINISHES INSTALLED SHALL HAVE A FLAME SPREAD INDEX OF NOT GREATER THAN 200 AND A SMOKE-DEVELOPED INDEX OF NOT GREATER THAN 450
 C. SINAL OCI ORD AND REDOPTION FOR FLOOR MANY AND C. FINAL COLORS AND PRODUCTS FOR FLOOR, WALL, AND MILLWORK FINISHES ARE TO BE SELECTED BY THE OWNER D. WHERE TILE IS TO BE INSTALLED ON PARTITIONS, CONTRACTOR TO PROVIDE MOISTURE RESISTANT BACKER BOARD
- 3. INSULATION NOTES: A. INSULATION PROVIDED THROUGHOUT THE PROJECT SHALL HAVE A FLAME SPREAD INDEX OF NOT MORE THAN 25 AND A SMOKE-DEVELOPED INDEX OF NOT MORE THAN 450

4. DIMENSIONS ARE TO FINISH FACE OF WALL UNLESS NOTED OTHERWISE


5. SEE SHEET A-1.1 FOR REFLECTED CEILING PLANS AND SEE SHEET A-5.0 FOR DOOR DETAILS AND DOOR SCHEDULE


	NEW WORK CEILING PLAN KEYED NOTES				
NO.	NOTE				
9.3	REPAIR GYPSUM CEILING WHERE PARTITIONS HAVE BEEN DEMOLISHED; FEATHER AND FINISH TO MATCH EXISTING CEILING				
9.4	PROVIDE NEW GYPSUM WALL BOARD CEILING SUSPENDED BELOW EXISTING ROOF TRUSS FRAMING				
26.2	PROVIDE PENDANT LIGHT FIXTURE ALIGNED WITH BARTOP CENTERLINE				
26.3	PROVIDE PENDANT LIGHT FIXTURE				

NEW WORK PLAN LEGEND				
	- PARTITION TYPE, SEE A-0.3 - PROVIDE NEW WALL CONSTRUCTION			
	- PARTITION TYPE, SEE A-0.3 - EXISTING WALL CONSTRUCTION TO REMAI			
	— DOOR TAG, SEE DOOR SCHEDULE — DOOR AND FRAME			

EXISTING ELEMENTS TO REMAIN			
NO.	NOTE		
1.1	EXISTING BRICK STAIR, BRICK LANDING, AND METAL RAILING TO REMAIN		
1.2	EXISTING WOOD DOOR AND WOOD FRAME SIDE LITES TO REMAIN IN PLACE		
1.3	EXISTING WOOD WINDOW TO REMAIN; INTERIOR TRIM TO BE RE-FINISHED, EXTERIOR APPEARANCE TO REMAIN UNCHANGED		
1.4	EXISTING WOOD STAIR TO REMAIN IN PLACE		

NEW WORK FLOOR PLAN KEYED NOTES				
NO.	NOTE			
3.1	PROVIDE CAST IN PLACE CONCRETE RAMP AND INTERMEDIATE LANDINGS DOWN TO GRADE, SEE ALSO CIVIL DRAWINGS			
6.1	PROVIDE CUSTOM BUILT BANQUET MILLWORK TO EXTENT SHOWN			
6.2	PROVIDE CUSTOM BUILT BAR MILLWORK. GENERAL CONTRACTOR TO COORDINATE MILLWORK WITH BAR EQUIPMENT AND PLUMBING BETWEEN TRADES			
6.3	PROVIDE SOLID SURFACE KITCHEN PASS COUNTERTOP			
6.4	PROVIDE SOLID SURFACE COUNTERTOP AND BASE WITH SINK OPENING, COORDIANTE WITH KITCHEN EQUIPMENT AND PLUMBING SCOPE			
6.5	PROVIDE SOLID SURFACE COUNTERTOP AND OPEN FRONT BASE CABINET WITH MICROWAVE SHELF			
7.1	PROVIDE ENGINEERED WOOD SIDING AND 5/8" TYPE X GLASS MAT SHEATHING AT EXTERIOR SIDE OF EXISTING WOOD STUD FRAMED EXTERIOF WALL; PROVIDE 5/8" TYPE X GYPSUM BOARD AT INTERIOR SIDE OF WALL; SEI WALL ASSEMBLY DIAGRAM, FULL LENGTH OF EXISTING WALL			
9.1	PROVIDE NEW FLOOR FINISHES THROUGHOUT ROOM, SEE FINISH SCHEDULE			
9.2	PROVIDE NEW PAINT FINISHES AT FULL EXTENT OF BUILDING FACADE WITH AHJ'S PRE-APPROVED PAINT COLORS AT EXISTING EXTERIOR SIDING; SCRAPE, PRIME, AND PREPARE EXISTING WOOD SUBSTRATES FOR NEW PAINT FINISHES PER AHJ'S HISTORIC DESIGN STANDARDS			
10.1	PROVIDE WALL MOUNTED STAINLESS STEEL GRAB BARS AND IN WALL BLOCKING			
10.8	PROVIDE FIRE EXTINGUISHER AND WALL MOUNTED BRACKET			
10.9	PROVIDE WALL MOUNTED INTERIOR SIGNAGE, SEE SIGNAGE SCHEDULE			
22.1	PROVIDE UTILITY SINK, SEE PLUMBING DRAWINGS			
22.2	PROVIDE WATER CLOSET, SEE PLUMBING DRAWINGS			
22.3	PROVIDE WALL HUNG LAVATORY, SEE PLUMBING DRAWINGS			
26.9	PROVIDE RECESSED WALL OUTLET AT PATRON SIDE OF BAR DIE WALL			

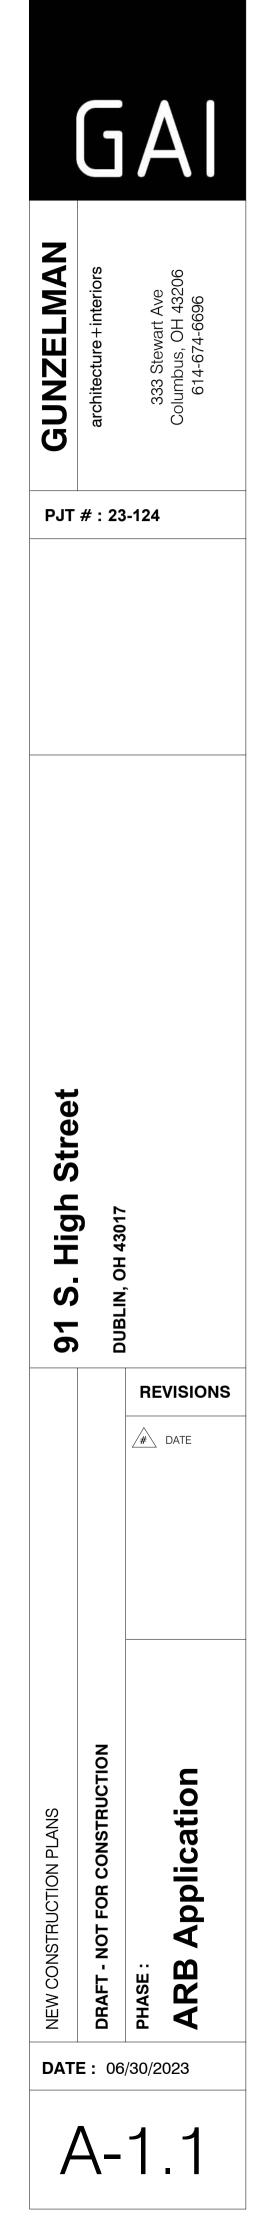

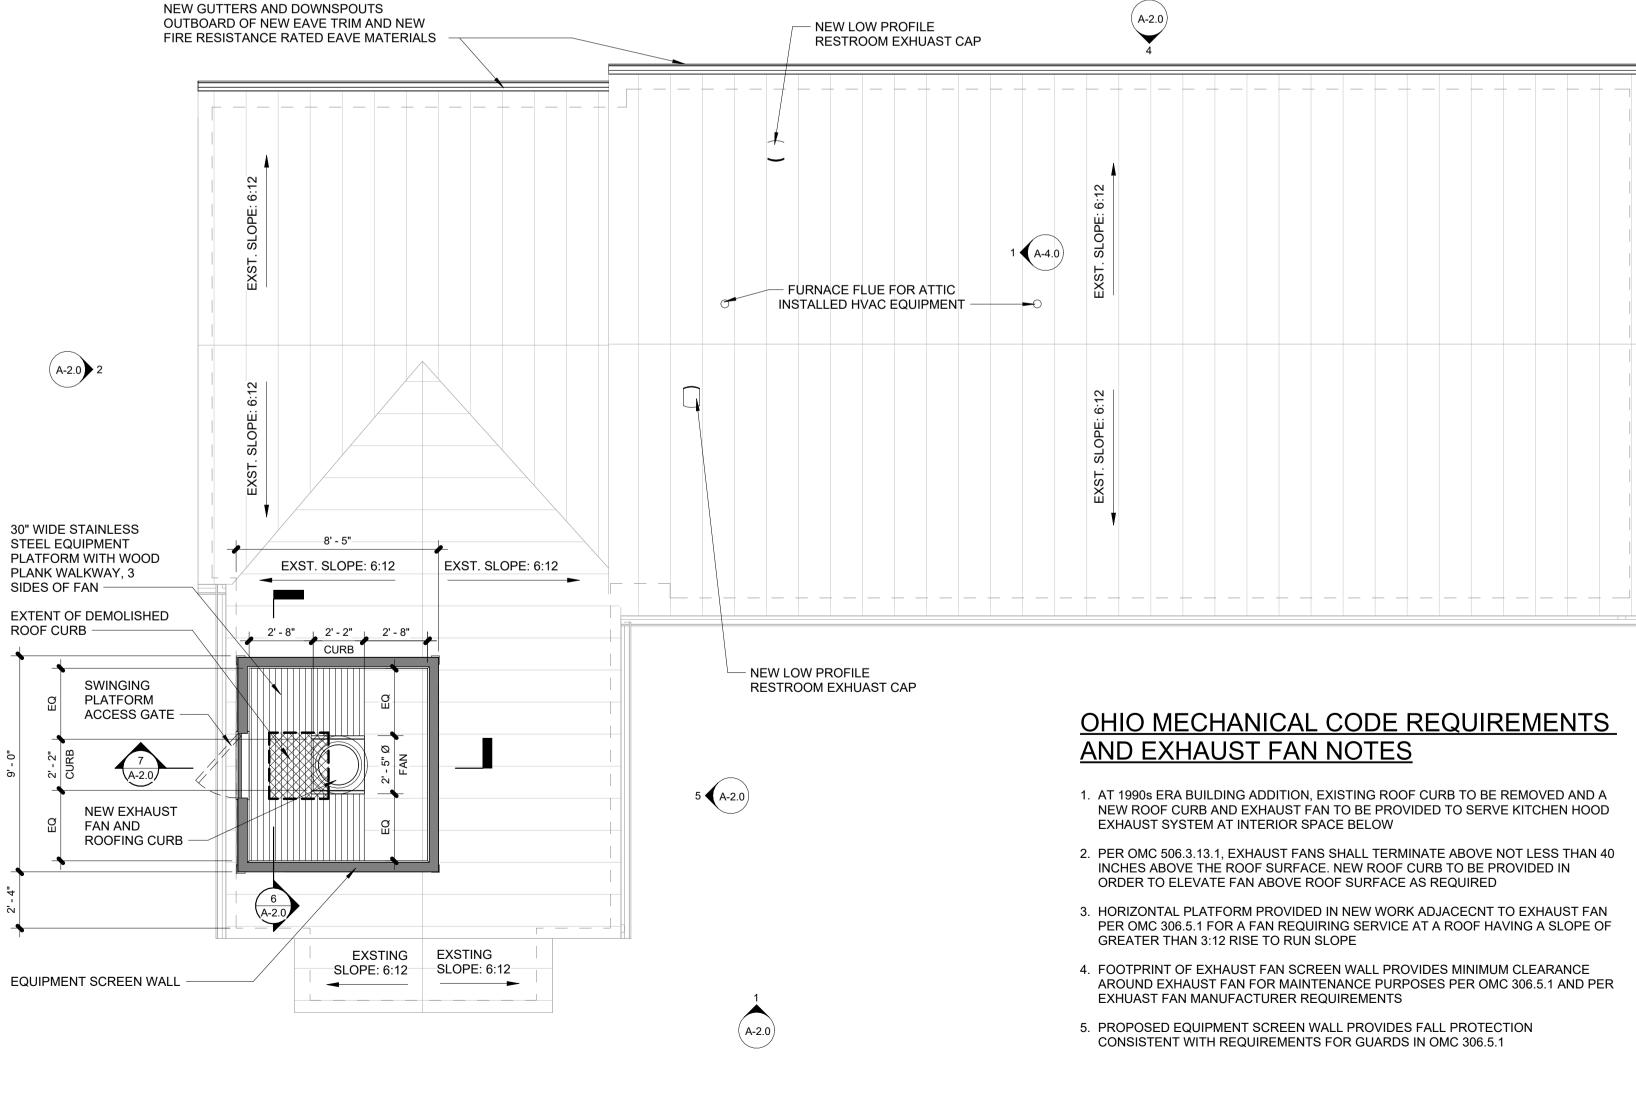

ROOF PLAN - EXISTING CONDITIONS AND NEW WORK SCALE: 1/4" = 1'-0"

GENERAL PLAN NOTES

1. ALL ELEMENTS OF CONSTRUCTION ARE TO BE NEW UNLESS NOTED OTHERWISE

2. FINISH NOTES: A. ALL GYPSUM WALL BOARD PARTITIONS TO BE PROVIDED

3 (A-2.0)


NORTH

- WITH A LEVEL 4 FINISH B. ALL FINISHES INSTALLED SHALL HAVE A FLAME SPREAD INDEX OF NOT GREATER THAN 200 AND A SMOKE-DEVELOPED INDEX OF NOT GREATER THAN 450 C. FINAL COLORS AND PRODUCTS FOR FLOOR, WALL, AND
- C. FINAL COLORS AND PRODUCTS FOR FLOOR, WALL, AND MILLWORK FINISHES ARE TO BE SELECTED BY THE OWNER D. WHERE TILE IS TO BE INSTALLED ON PARTITIONS, CONTRACTOR TO PROVIDE MOISTURE RESISTANT BACKER BOARD 3. INSULATION NOTES: A. INSULATION PROVIDED THROUGHOUT THE PROJECT SHALL
- HAVE A FLAME SPREAD INDEX OF NOT MORE THAN 25 AND A SMOKE-DEVELOPED INDEX OF NOT MORE THAN 450


4. DIMENSIONS ARE TO FINISH FACE OF WALL UNLESS NOTED OTHERWISE

5. SEE SHEET A-1.1 FOR REFLECTED CEILING PLANS AND SEE SHEET A-5.0 FOR DOOR DETAILS AND DOOR SCHEDULE


GUNZELMAN	# architecture+interiors	333 Stewart Ave Columbus, OH 43206 614-674-6696
91 S. High Street		

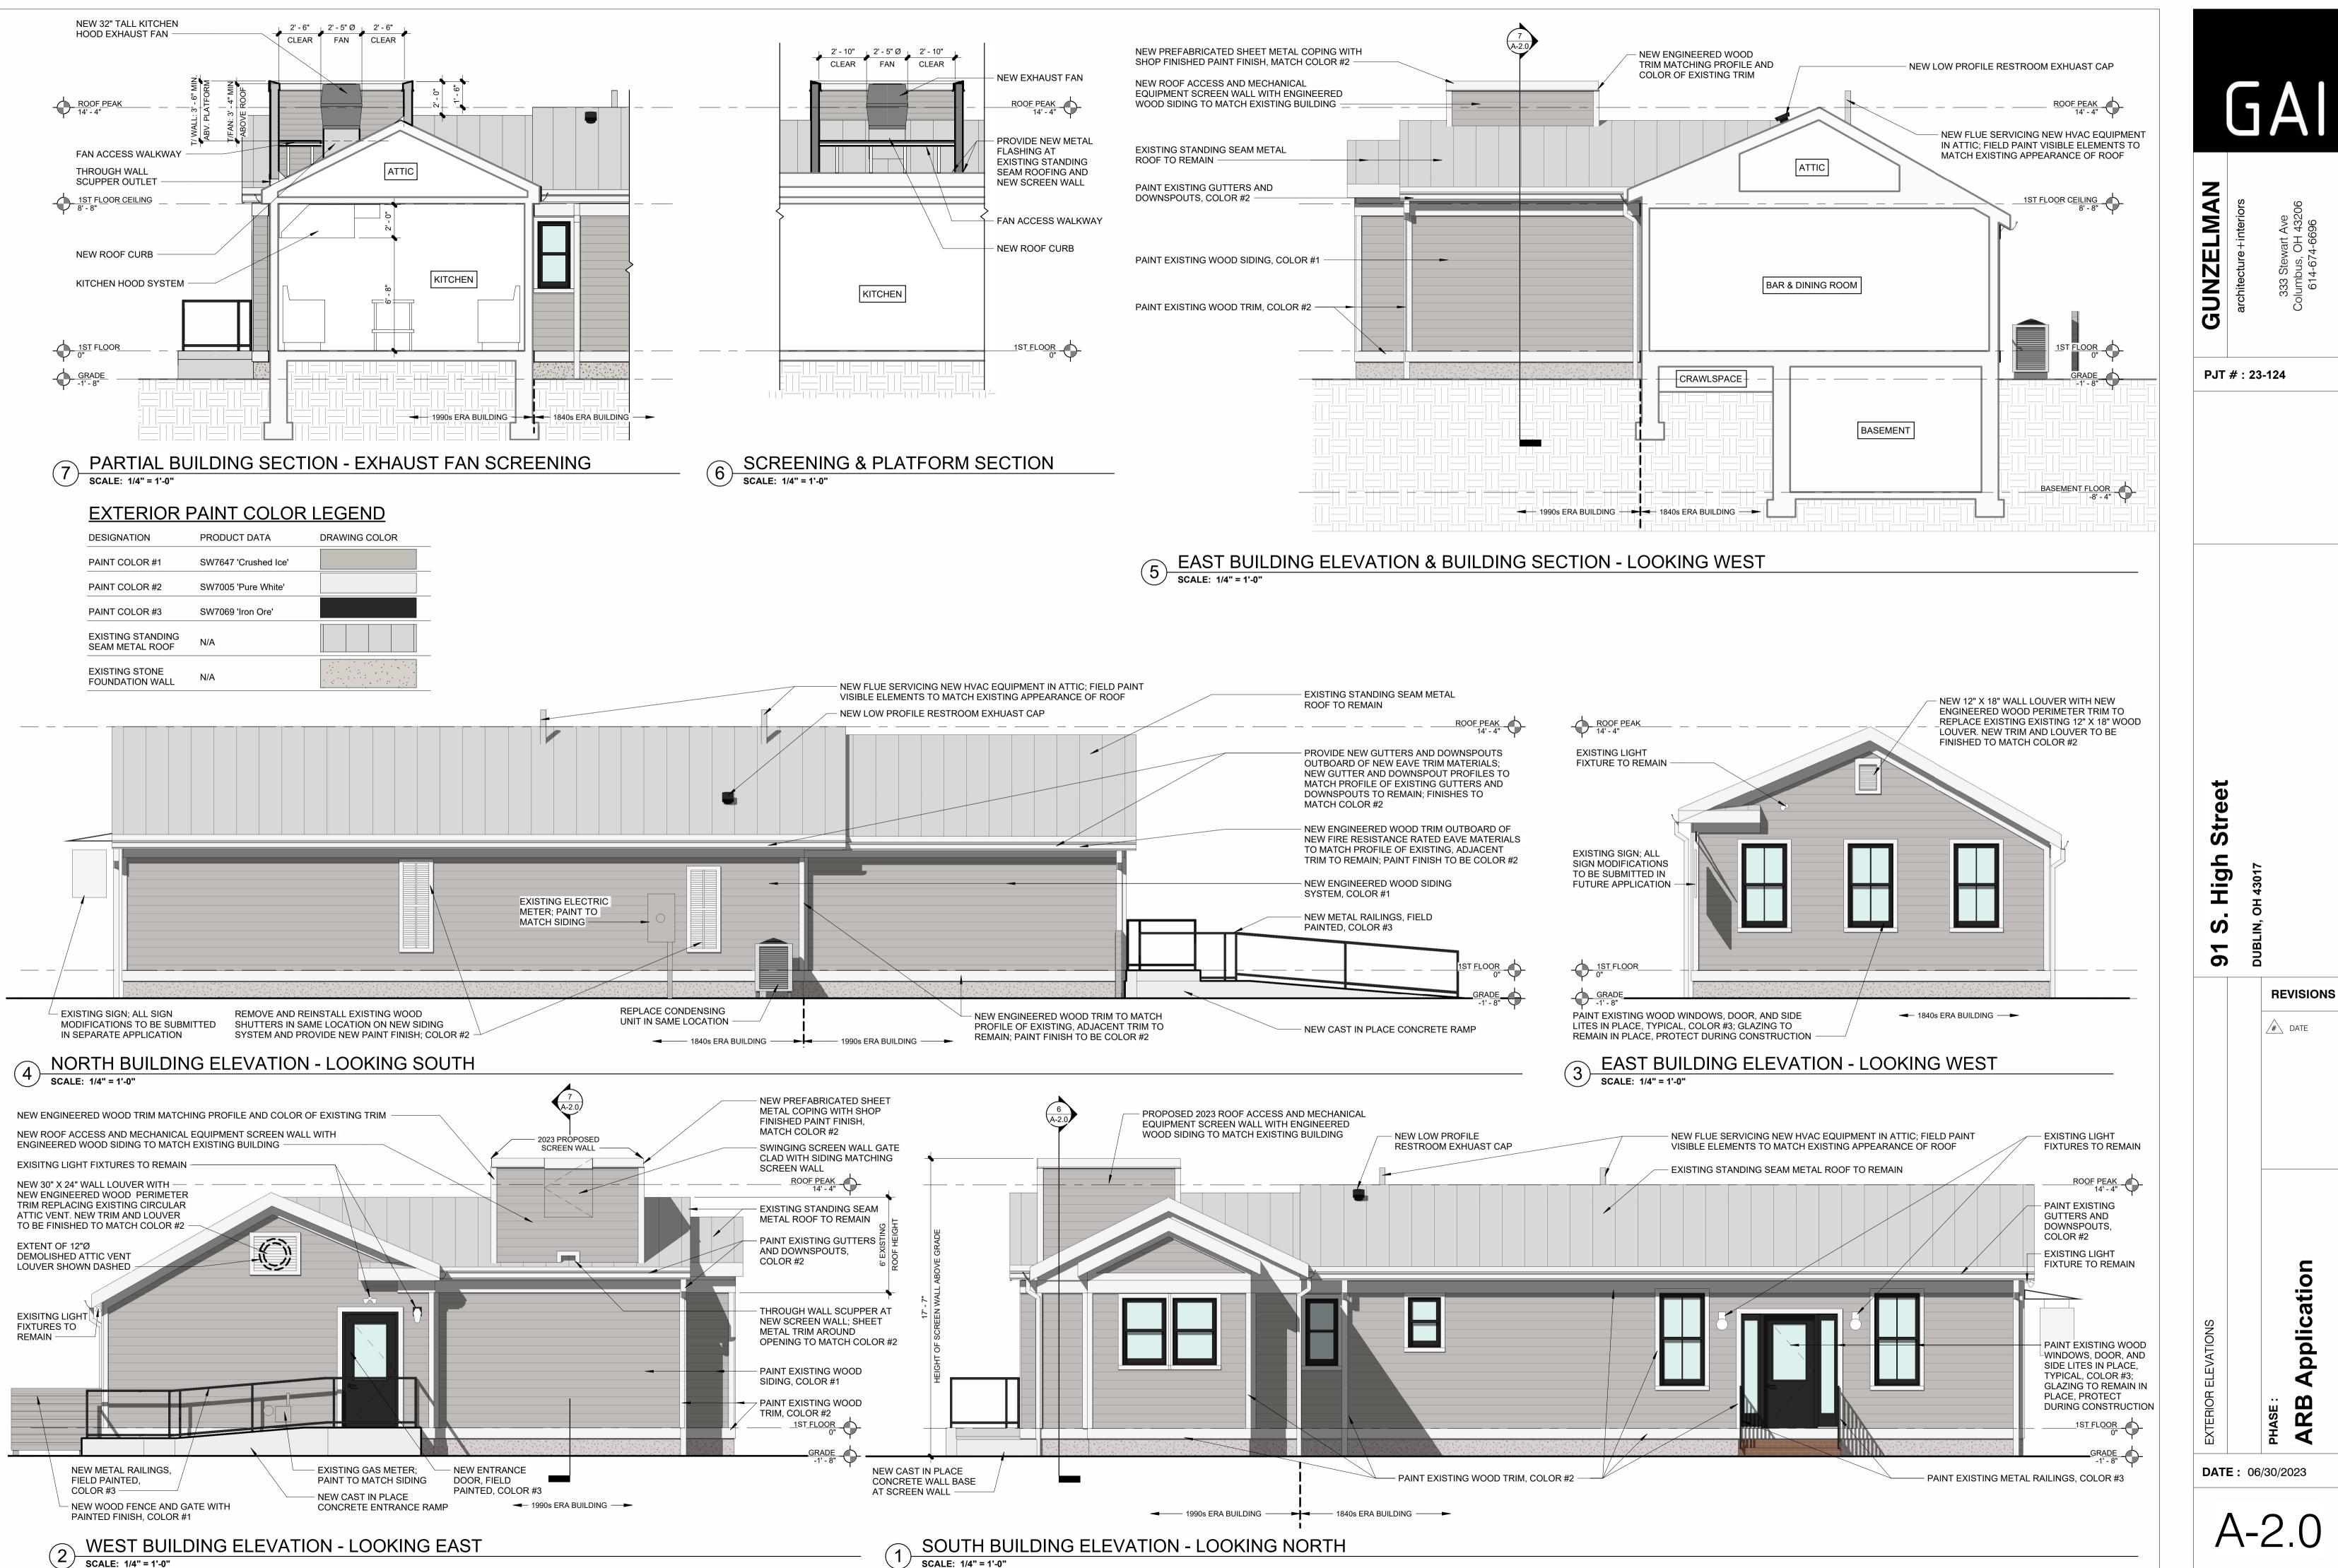

SCALE: 1/4" = 1'-0"

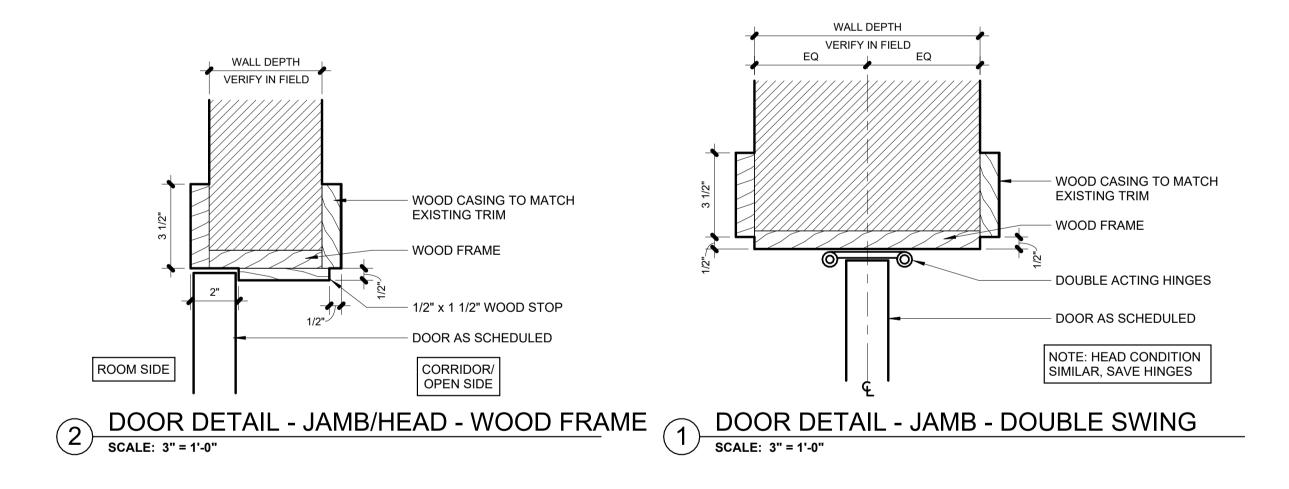




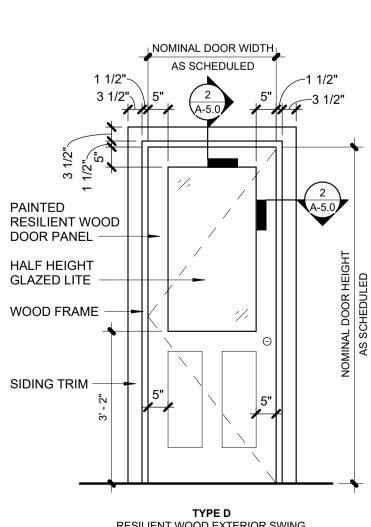

TYPE D RESILIENT WOOD EXTERIOR SWING DOOR, HALF-LITE, 2 PANEL

DOOR TYPE C EXISTING DOOR TO REMAIN, DOOR KNOB TO BE REPLACED WITH LEVER-STYLE LOCKSET

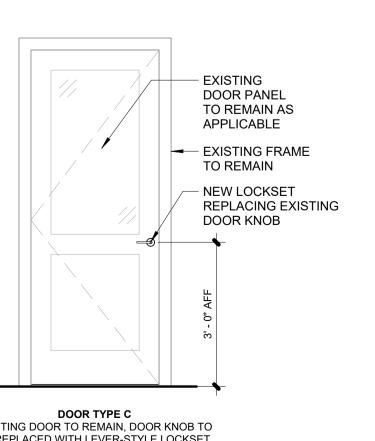

A-5.0

<u>DOOR SCHEDULE REMARKS:</u> i. EXISTING EXTERIOR DOOR TO REMAIN IN PLACE ii. NEW EXTERIOR DOOR REPLACING DEMOLISHED DOOR AT EXISTING EXTERIOR WALL OPENING

iii. NEW INTERIOR DOOR AT NEW LOCATION iv. EXISTING INTERIOR DOOR TO REMAIN IN PLACE

GENERAL NOTES

EXISTING

NEW

NEW

NEW

NEW

06 EXISTING

MACHINE ALL DOORS TO RECEIVE OPERATING HARDWARE. SEE PLANS FOR SWING DIRECTION AND DOOR HANDEDNESS

NO. NEW / EXISTING WIDTH HEIGHT DOOR TYPE

3' - 0"

NOMINAL SIZE

6' - 8"

3' - 0" 6' - 8"


3' - 0" 6' - 8"


3' - 0" 6' - 8"

3' - 0" 6' - 8"

3' - 0" 6' - 8"

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91 S. High Street	LIN, OH 43017	
		REVISIONS Image: Date 1 10/28/2021
DOOR SCHEDULES AND DETAILS		PHASE : ARB Application
		/30/2023

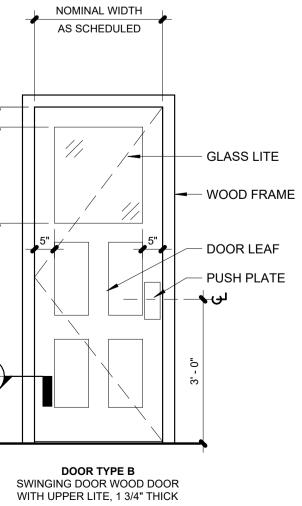

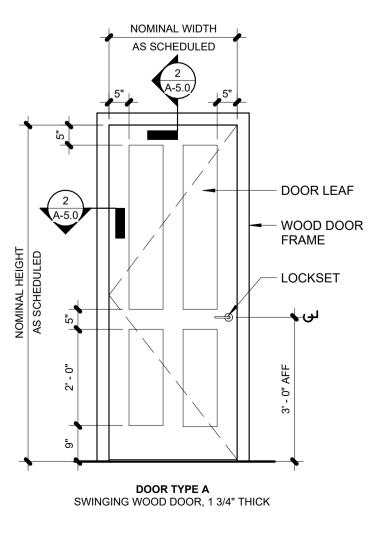


DOOR	SCHEDULE

۲H	IANDEDNESS						
	FRAME	DOC	R		HARD	WARE	
Ξ	MATL.	MATL.	OPERATION	SET	FUNCTION	ACCESSORIES	REMARKS
						· · ·	
	PAINTED WOOD	PAINTED WOOD	SINGLE SWING				i
	PAINTED WOOD	PAINTED RESILIENT WOOD	SINGLE SWING		ENTRY		ii
	PAINTED HOLLOW METAL	PAINTED WOOD	SINGLE SWING		PRIVACY	OCCUPANCY INDICATOR	iii
	PAINTED HOLLOW METAL	PAINTED WOOD	SINGLE SWING		PRIVACY	OCCUPANCY INDICATOR	iii
	PAINTED WOOD	PAINTED WOOD	DOUBLE-ACTING SWING		PASSAGE	DOUBLE ACTION HINGES	iii
	PAINTED WOOD	PAINTED WOOD	SINGLE SWING				iv


EXTERIOR PAINT COLOR LEGEND


DESIGNATION	PRODUCT DATA	DRAWING COLOR
PAINT COLOR #1	SW7647 'Crushed Ice'	
PAINT COLOR #2	SW7005 'Pure White'	
PAINT COLOR #3	SW7069 'Iron Ore'	
EXISTING STANDING SEAM METAL ROOF	N/A	
EXISTING STONE FOUNDATION WALL	N/A	




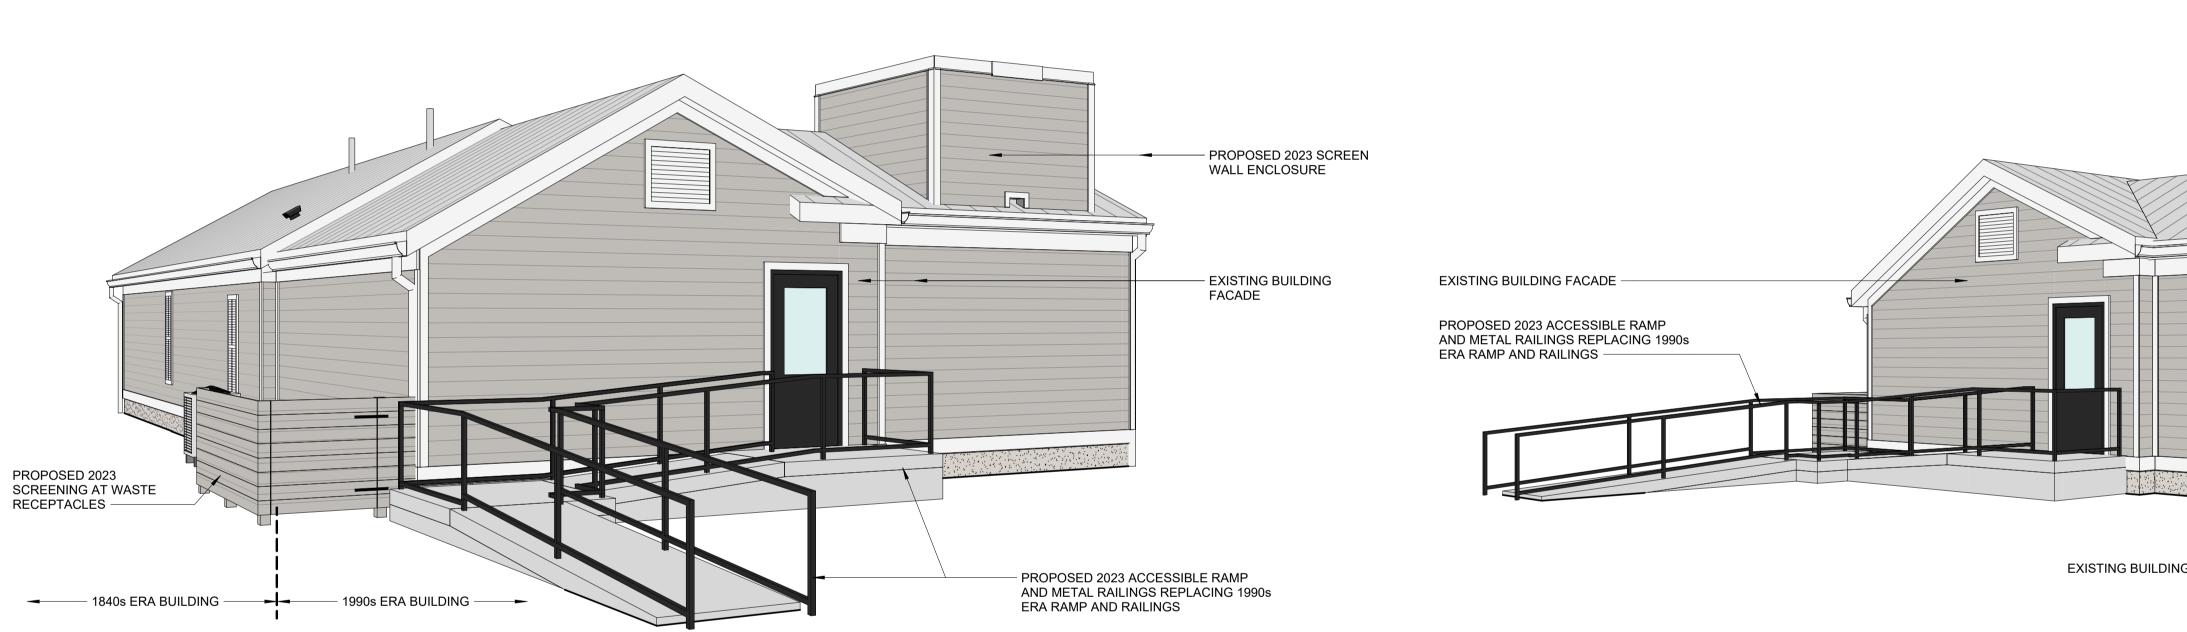


3 LOOKING EAST FROM REAR OF PROPERTY TOWARD NEW RAMP AND SCREEN WALL SCALE:

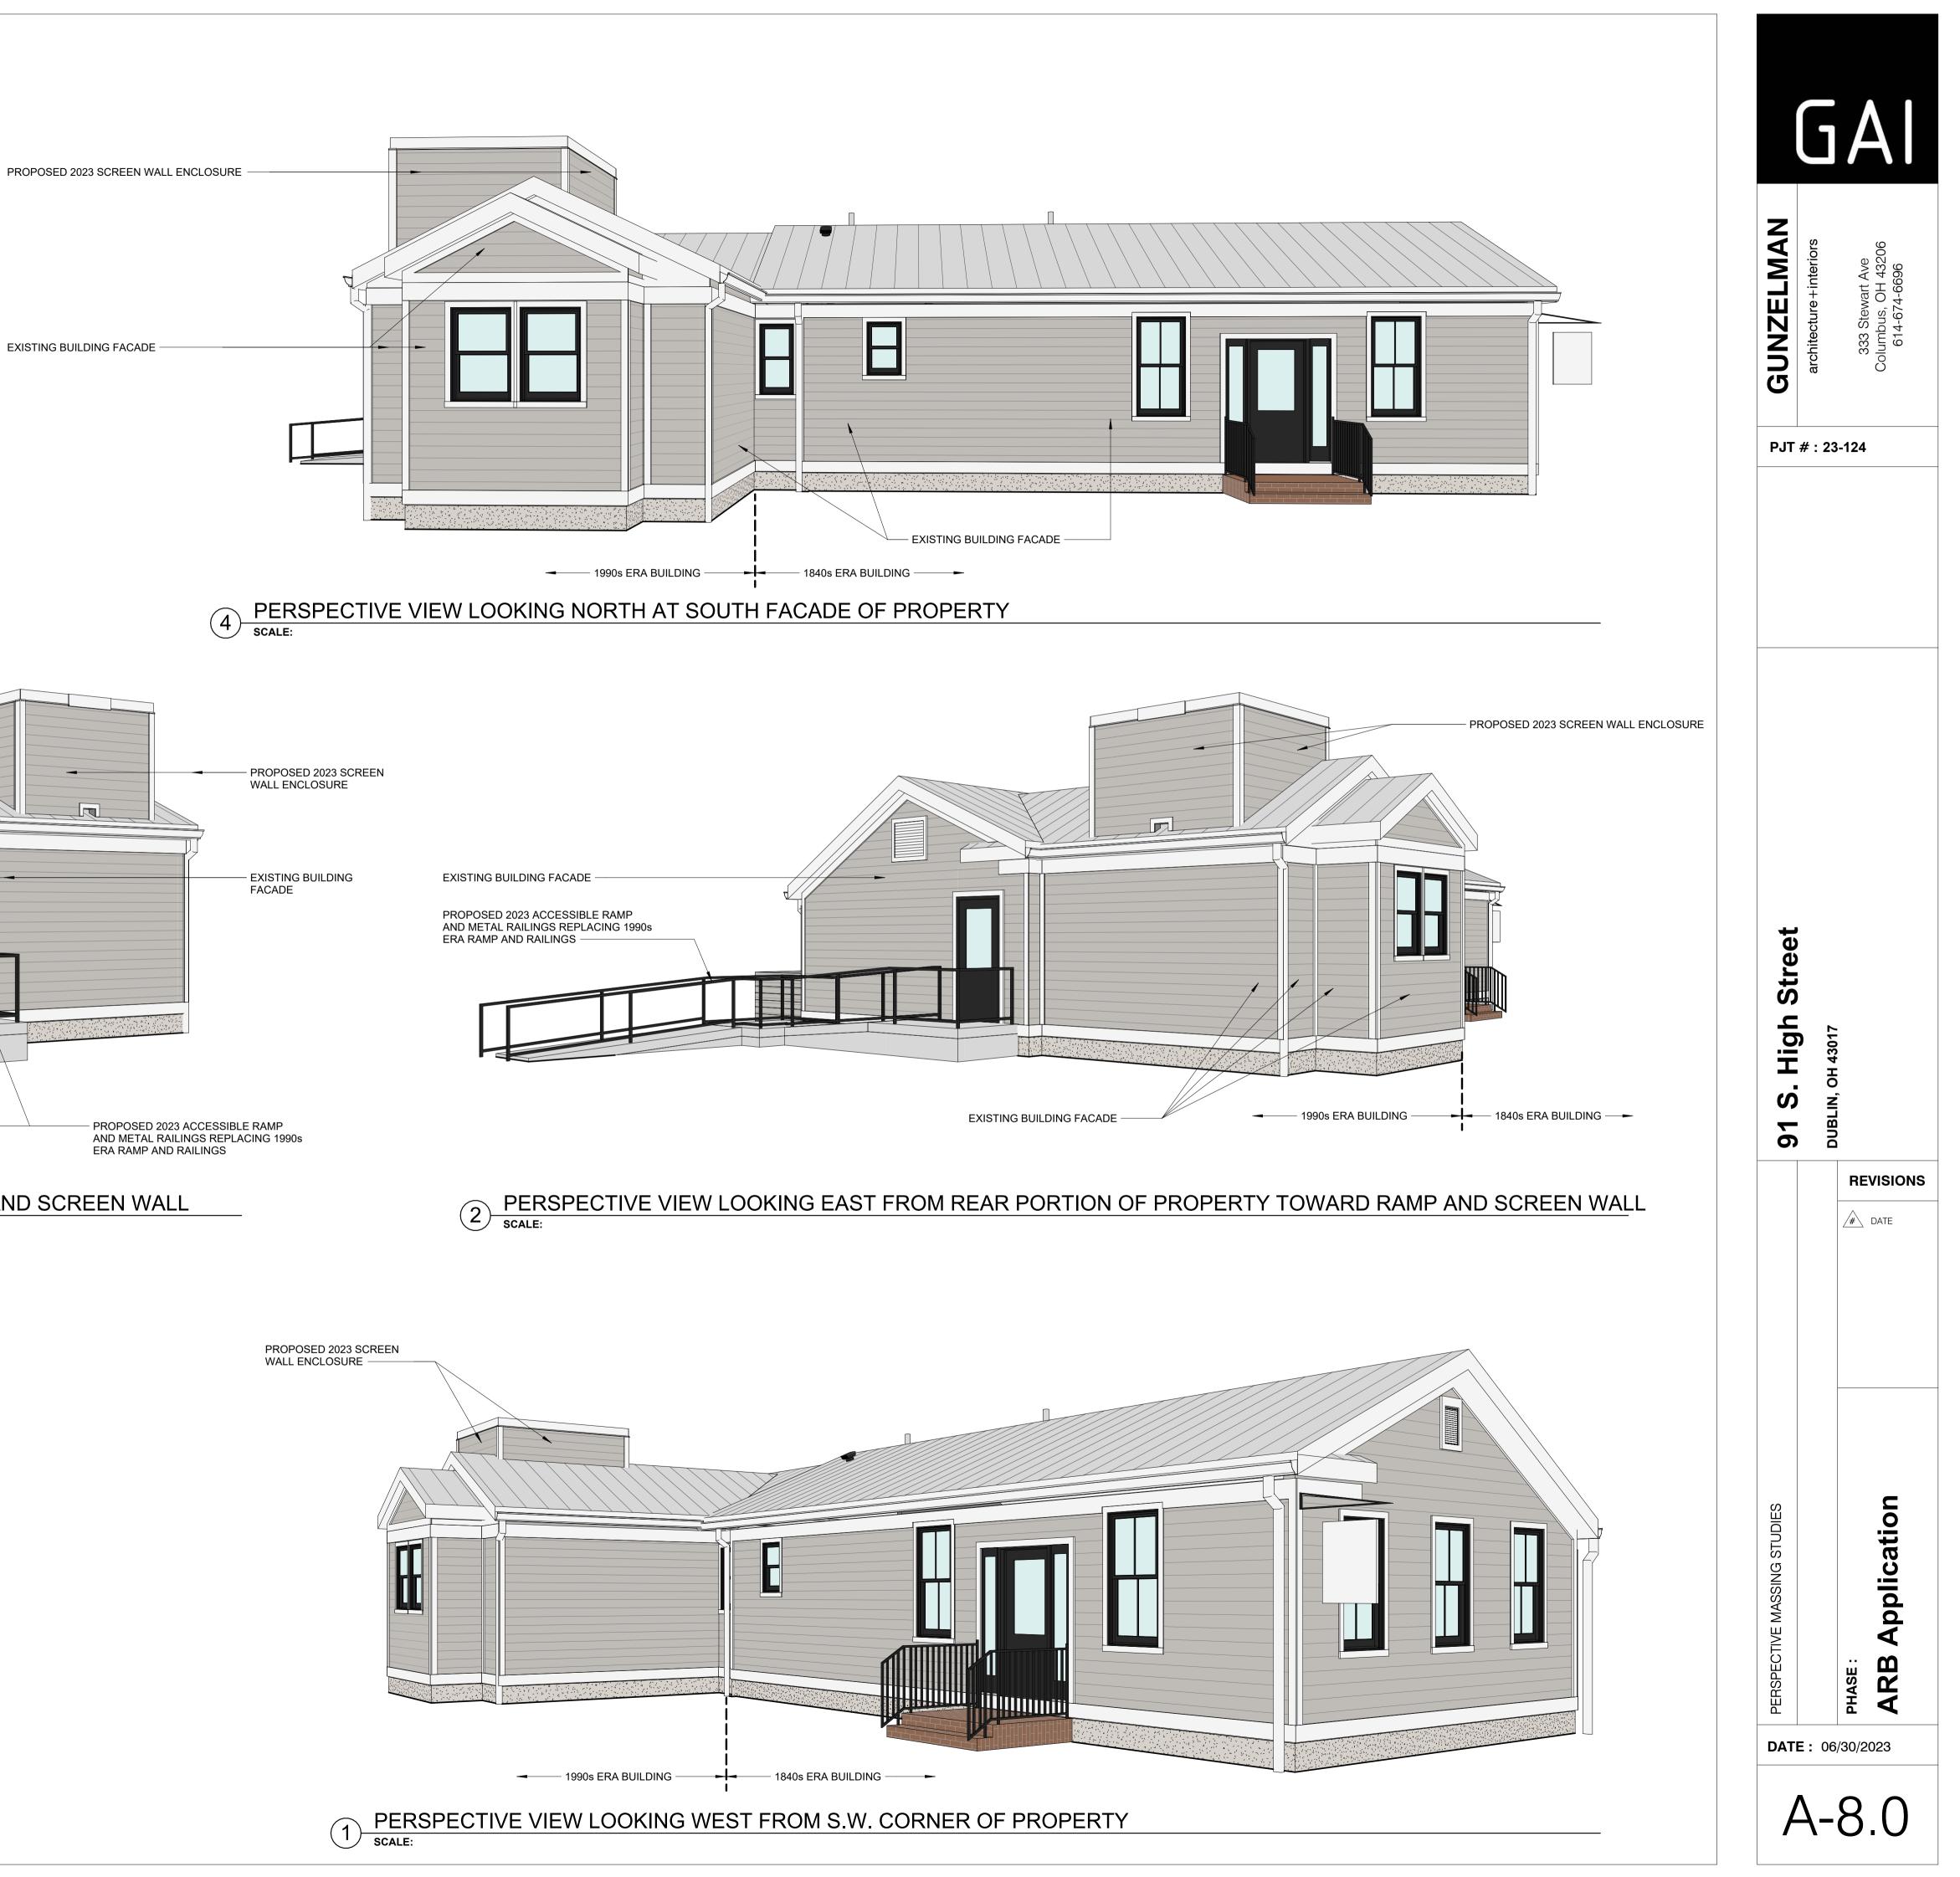

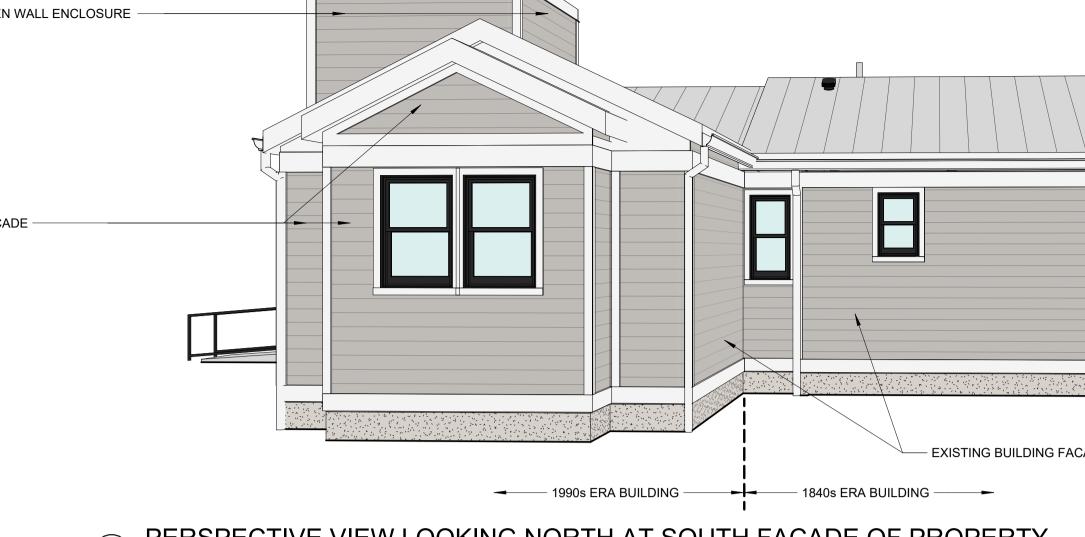

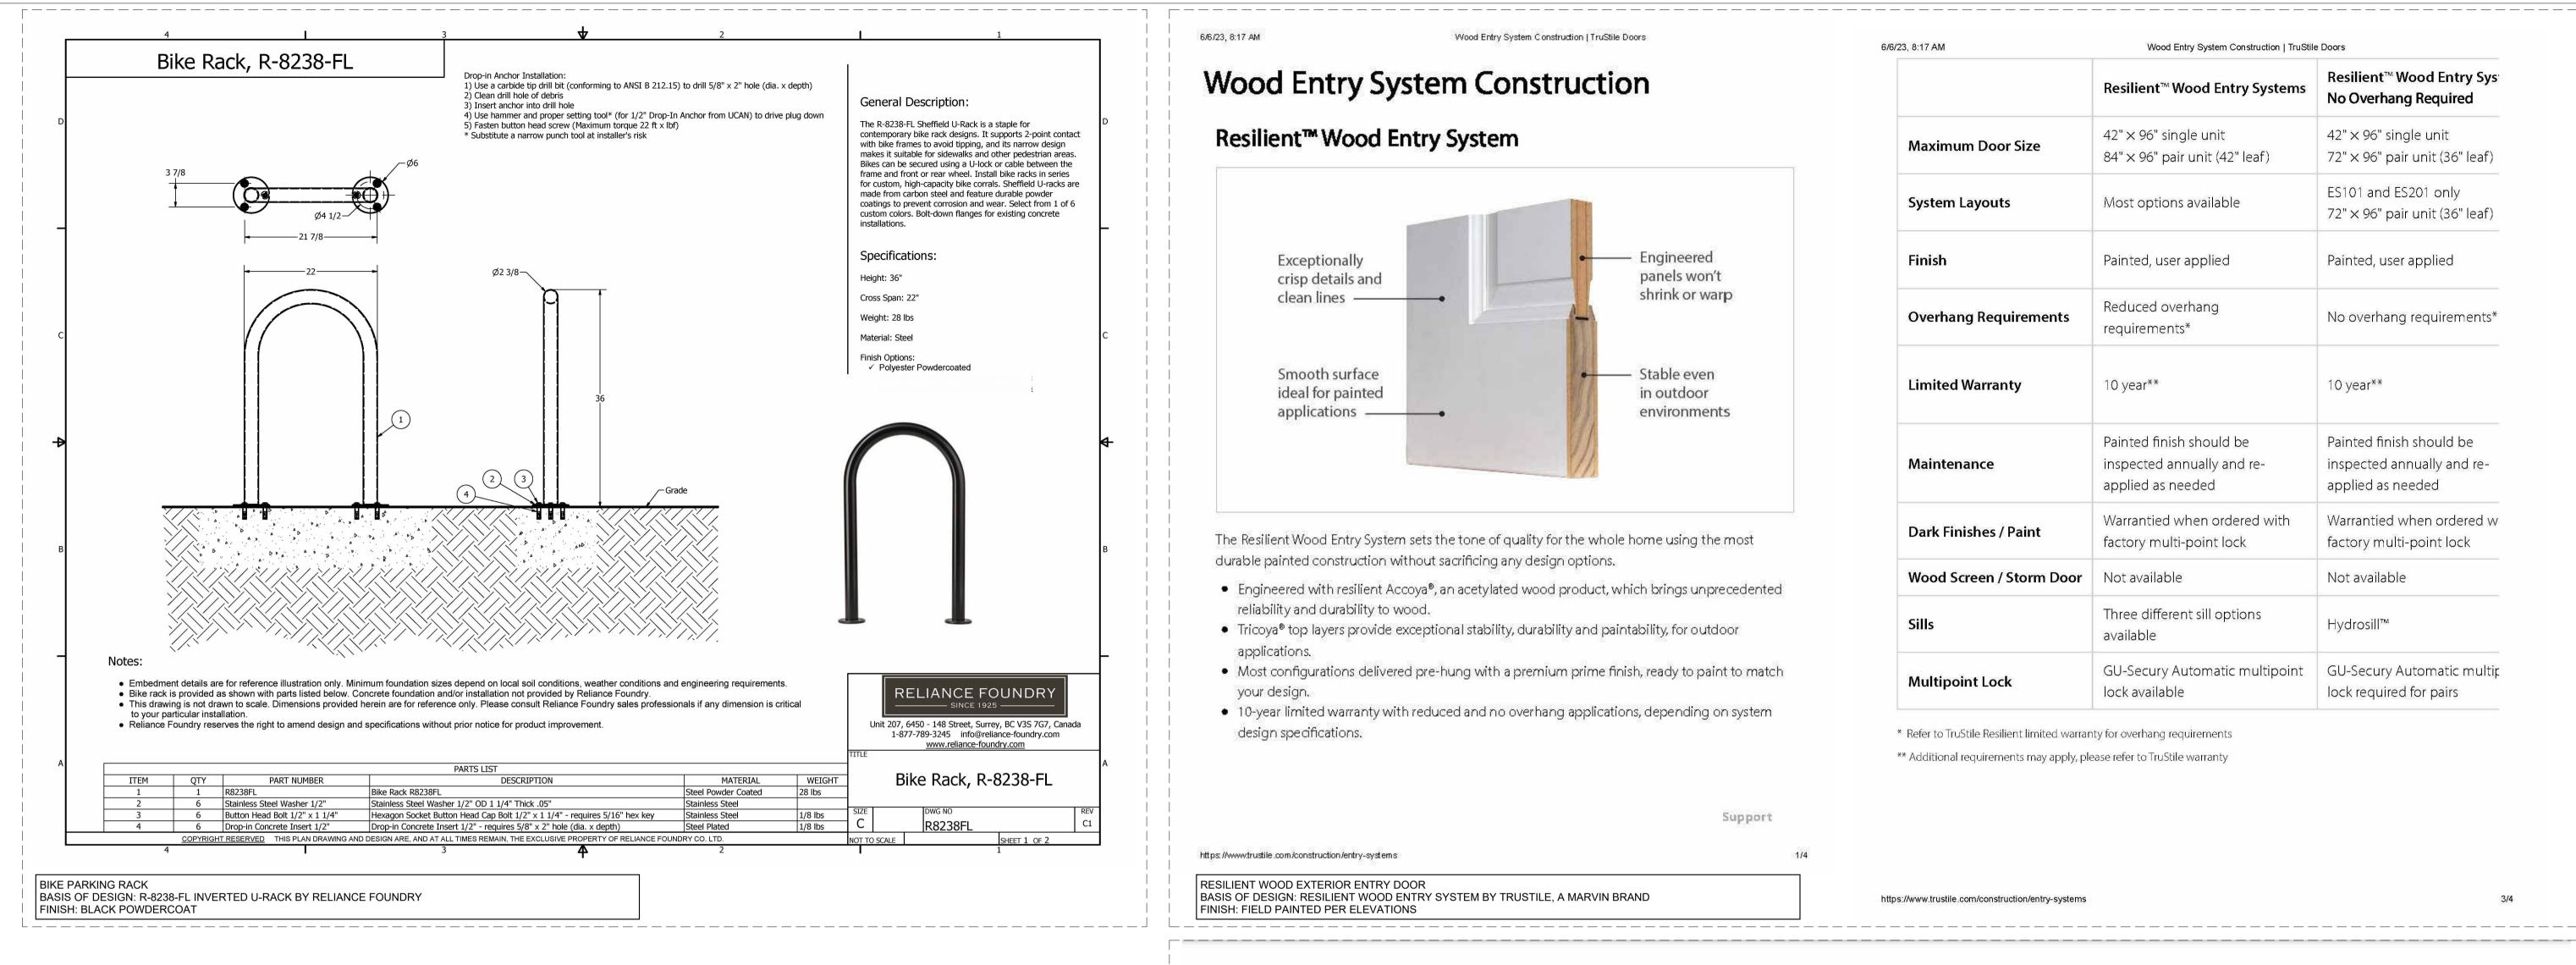

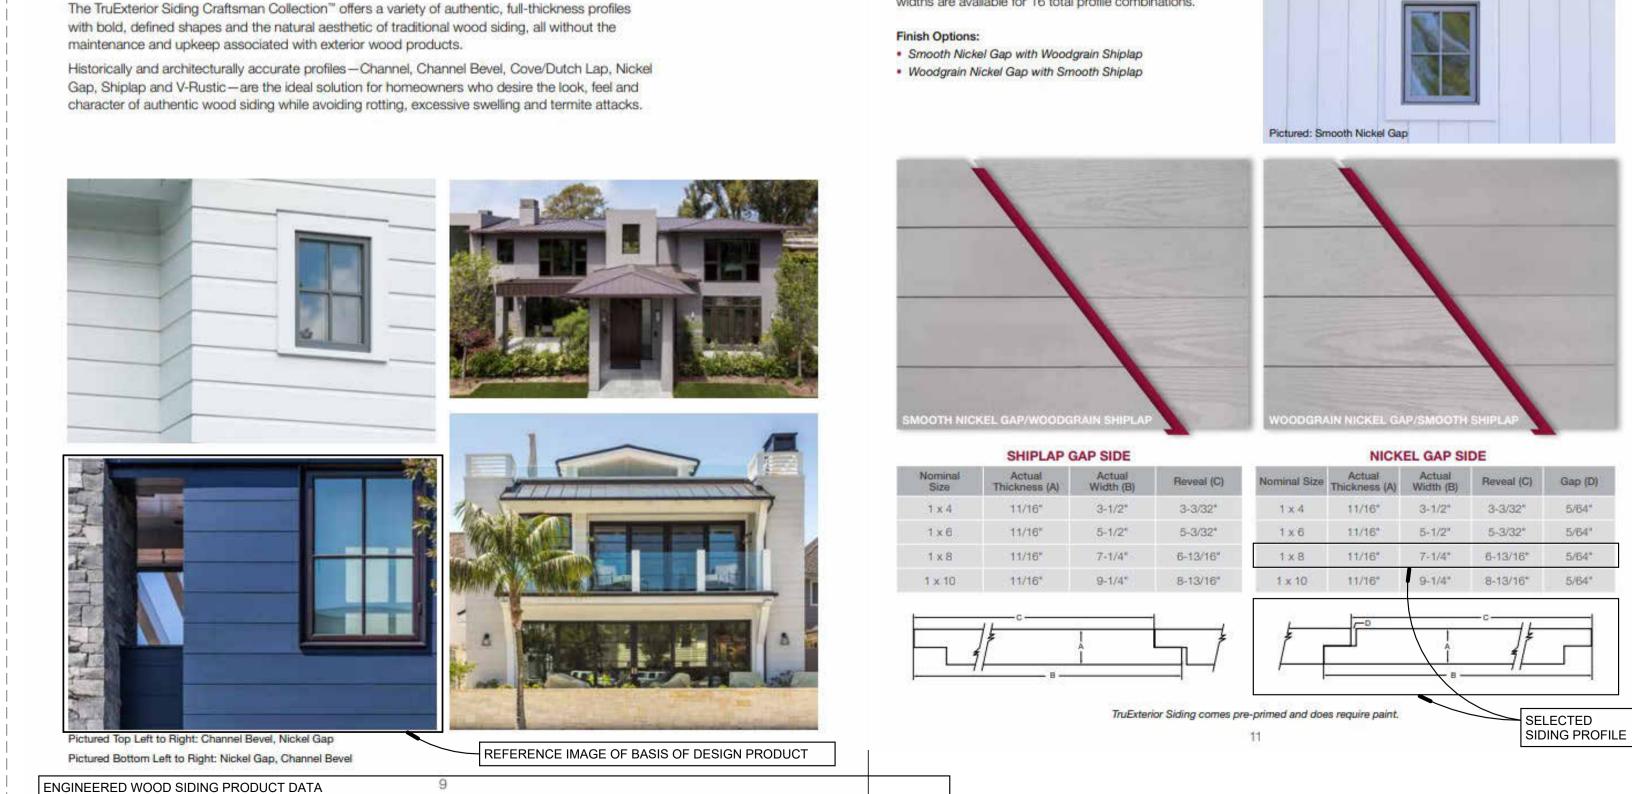

BASIS OF DESIGN: TRU-EXTERIOR SIDING CRAFTSMAN COLLECTION, SMOOTH FINISH, CHANNEL PROFILE NICKEL GAP PROFILE, 1X8 SIZE FINISH: FIELD PAINTED AS INDICATED ON ELEVATIONS ______

Craftsman Collection

Wood Entry System Construction TruStile Doors				
	Resilient™ Wood Entry Systems	Resilient™ Wood Entry Sys No Overhang Required		
um Door Size	42" × 96" single unit 84" × 96" pair unit (42" leaf)	42" × 96" single unit 72" × 96" pair unit (36" leaf)		
Layouts	Most options available	ES101 and ES201 only 72" × 96" pair unit (36" leaf)		
	Painted, user applied	Painted, user applied		
ng Requirements	Reduced overhang requirements*	No overhang requirements*		
Warranty	10 year**	10 year**		
nance	Painted finish should be inspected annually and re- applied as needed	Painted finish should be inspected annually and re- applied as needed		
nishes / Paint	Warrantied when ordered with factory multi-point lock	Warrantied when ordered w factory multi-point lock		
creen / Storm Door	Not available	Not available		
	Three different sill options available	Hydrosill™		
oint Lock	GU-Secury Automatic multipoint lock available	GU-Secury Automatic multip lock required for pairs		

* Refer to TruStile Resilient limited warranty for overhang requirements


** Additional requirements may apply, please refer to TruStile warranty

https://www.trustile.com/construction/entry-systems


REVERSIBLE SHIPLAP-NICKEL GAP


TruExterior Siding & Trim's Reversible Shiplap/Nickel Gap siding panels offer two authentic, on-trend looks in one for increased versatility and convenience. The profile comes in two formats: one features smooth Nickel Gap on one side and woodgrain Shiplap on the other; the second combines woodgrain Nickel Gap with smooth Shiplap on the flip side. A rabbeted edge ensures panels install with authentic spacing depending on which side is installed-the tight joint appearance of Shiplap or the nickel-sized space of Nickel Gap. Four widths are available for 16 total profile combinations.

ominal Size	Actual Thickness (A)	Actual Width (B)	Reveal (C
1 x 4	11/16"	3-1/2*	3-3/32*
1 x 6	11/16"	5-1/2*	5-3/32*
1 x 8	11/16"	7-1/4°	6-13/16"
x 10	11/16*	9-1/4*	8-13/16

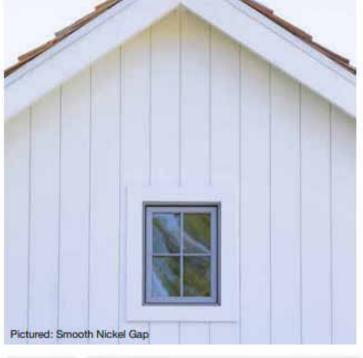





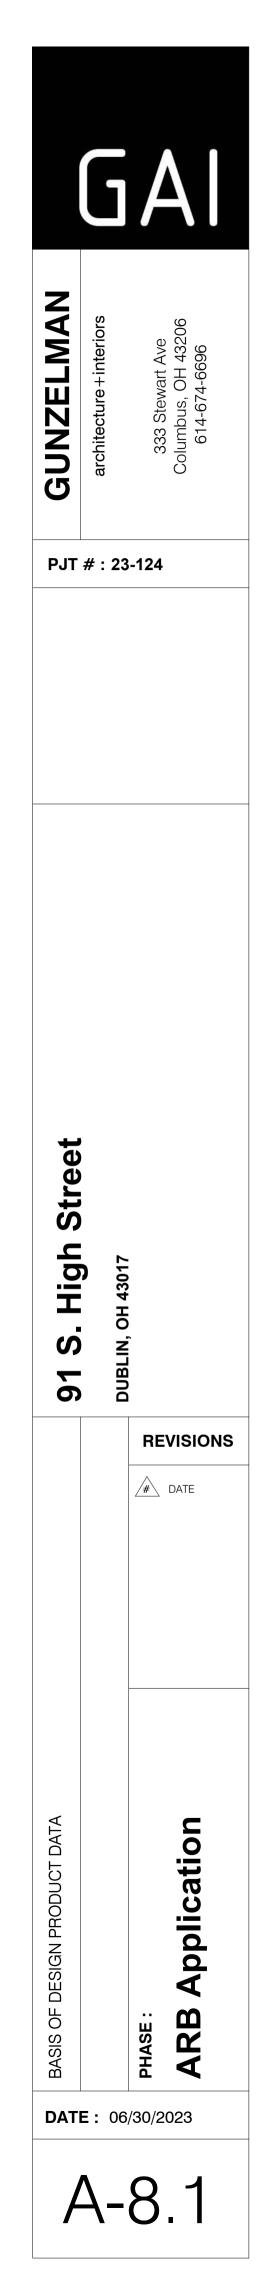

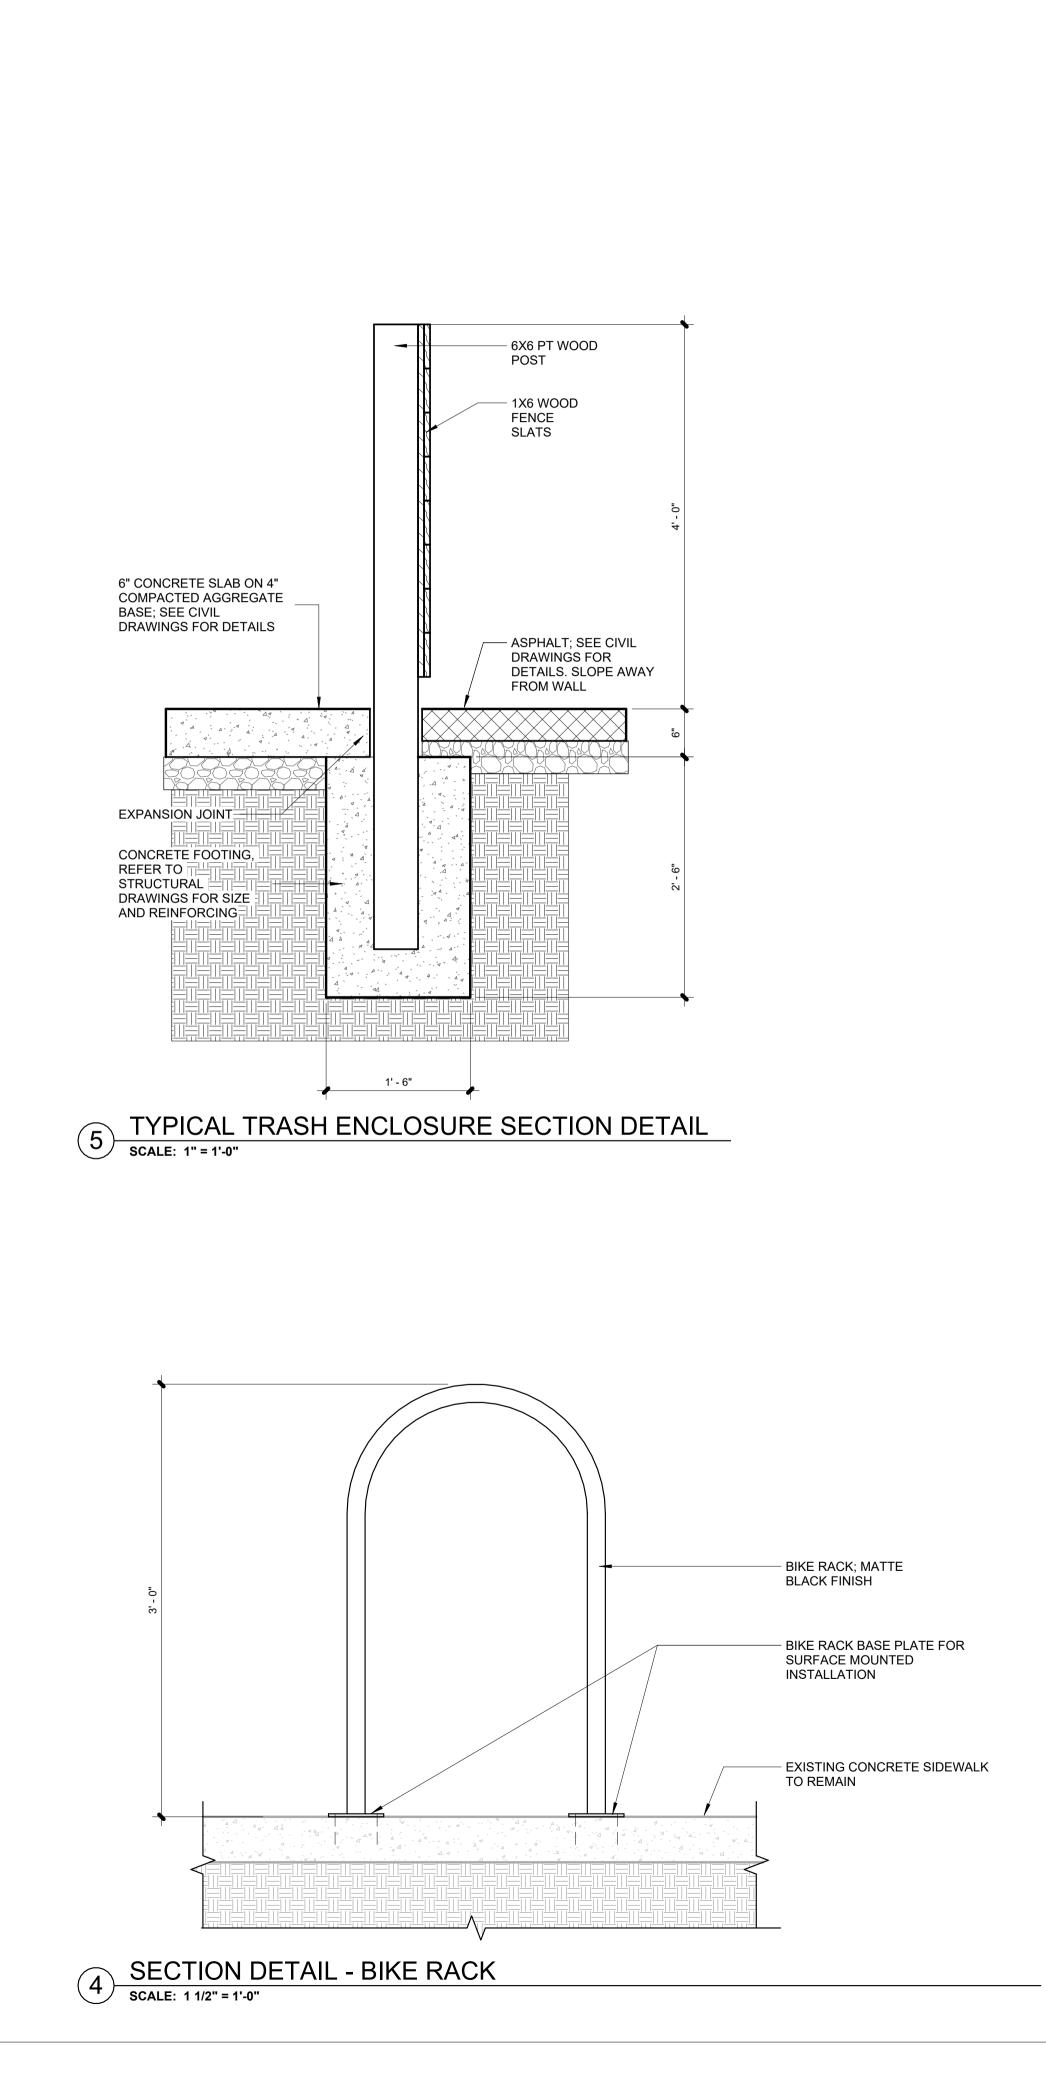


3 DOWNSPOUT AND GUTTER PROFILES SCALE: 3" = 1'-0"

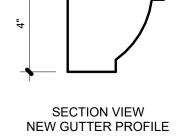

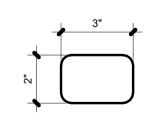


PLAN VIEW NEW DOWNSPOUT PROFILE

SEE ALSO GUTTER AND DOWNSPOUT SPECIFICATIONS

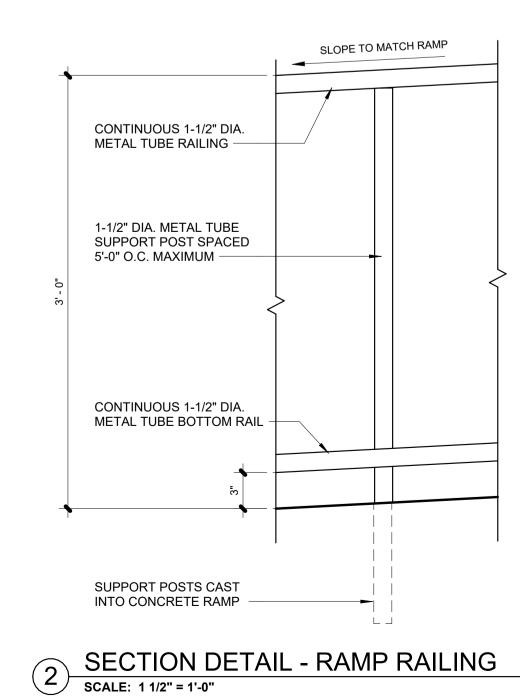

RAMP AND LANDING RAILING NOTES 1. ALL METAL COMPONENTS TO BE CORROSION RESISTANT 2. FASTENER TYPE: EXPOSED 3. METAL FINISHES: PAINTED TO MATCH COLOR #3 4. TOP RAILING PROFILE TO MEET ADA AND ICC A117.1 REQUIREMENTS FOR ACCESSIBLE RAMP AND STAIR RAILINGS 5. RAMPS AND STAIR RAILINGS TO EXTEND 1'-0" BEYOND TOP AND BOTTOM OF RAMP/STAIR RUNS

Output: Aligh Street 91 S. High Street architecture + interiors architecture + interiors 333 Stewart Ave Stewart Ave Columpus, OH 43206 614-674-6696 614-674-6696	PJT # : 23-124
31 S. High Street DBLIN, OH 43017 BEANN BEANN	EXTERIOR DETAILS
High BUBLIN, OH 43017 REVISIONS	EXTERIOR DETAILS BIBLIN, OH 43017 PHASE : PHASE : PHA
	EXTERIOR DETAILS PHASE : ARB Application
	EXTERIOR DETAILS PHASE : ARB Applicati

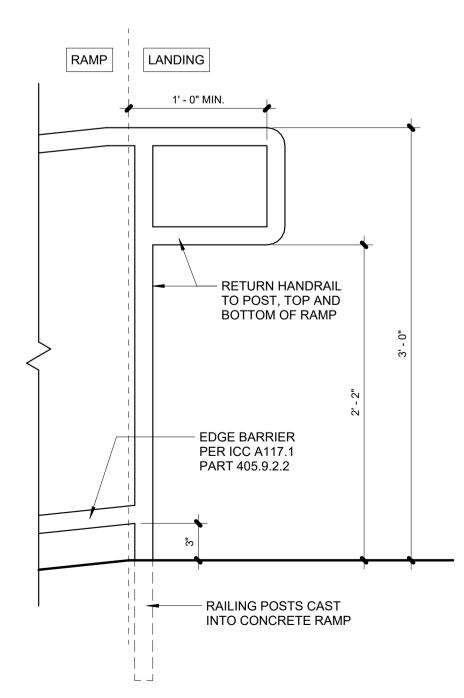

SECTION DETAIL - RAMP RAILING RETURN SCALE: 1 1/2" = 1'-0"

(1)

Prefabricated with custom			Model # 612108
They offer great supp With our pedestal pla expensive flashing bo		Min 30" Max 20.5" Max 20.5"	Front View
<section-header><section-header><section-header></section-header></section-header></section-header>	6/5/23, 10:45 PM Accurex XCUE-140-A/GPF-26-G22/XMSF-P115-H20-VG/TAP-GPI Model: XRUD-160-V	100d System Parts & Accessories 5-H20- ce: or Power	Ø 28.88
Standard Details ESD-403 Standard Details Structural reinforcing members may be required to adequately support and install multiple louver sections within a large opening. Structural reinforcing members along with any associated installation hardware is	Model: XRUD-160-VG Performance: Volume (CFM): SP (in. wg): FRPM (RPM): Motor Power (hp): Ope Power (hp): Voltage: Phase: Hertz: 2,250 1.2 1272 1 0.75 115 1 60 Cycle Configuration: Direct Drive F - High Efficiency Brushless DC - 1 hp, TENV, 115/60/1, 1300 rpm - Factory Mounted Motor - Vari-Gree motor Control - 0-10VDC Input UL/cUL 762 Listed - "Power Ventilators for Rest. Exh. Appliances" Swit NEMA-3R, Toggle, Shipped with Unit Junction Box Mounted & Wired Hinge, Factory Installed Grease T 475538) Unit Warranty: 1 Yr (Standard) Accessories: High Temp Curb Seal Rated for Continuous Duty F (Factory Attached) Model: GPI-26-G24 Dimension: Tag Quantity Width Length Height KEF - 1, Roof C 26 24 Configuration: Flat Roof, Welded with Insulation Material - Galvanized Nominal Curb Size Mode P115-H20-VG Performance: Volume (CFM): SP (in. wg): FRPM (RPM): Motor Power (hp): Operating M	an Motor n EC ch, rap (PN at 1500 curb 1 26 : XMSF-	CURB BY OTHERS

_ _ _ _

ROOF BASIS

GREENHECK

L _ _ _

Standard Construction

Frame Heavy gauge extruded 6063-T5 aluminum, 4 in. (102 mm) × 0.031 in. (2 mm) nominal wall thidkness	
Blades	Drainable design, heavy gauge extruded 6063-TS aluminum, 0.031 in. (2 mm) nominal wall thickness, positioned 37° and 49° on approximately 4 in. (102 mm) centers
Louver Depth 4 in. (102 mm)	
Construction	Mechanically fastened
Finish	Mil
Minimum Size	12 in. W x 12 in. H (305 mm W x 305 mm H)
Maximum Single 120 in .W x 120 in . H (3048 mm W x 3048 mm Section Size Limited to 70 ft. sq. (6.5 sq. m)	
Wind Load	25 PSF (1 2 kPa)

Performance Ratings

Greenheck Pan Corporation certifies that the ESD-403 louvers shown herein are licensed to bear the AMCA Seal. The ratings shown are based on tests and procedures performed in accordance with AMCA Publication 511 and comply with the requirements of the AMCA Certified Ratings Progra The AMCA Certified Ratings Seal applies to Water Penetration and Air Performance ratings.

Performance of 48 in. x 48 in. (1219 mm x 1219 mm) Louver Free Area Area 8.00 sq. ft. (0.743 sq. m)

Percent 90.0% Performance at Beginning Point of Water Penetration Free Area Velocity 1007 (pm (S.116 m/s) Maxintake Volume 8056 cfm (3.802 m%s) Performance at 6,000 CFM (2.832 m²/s) Intake

Pressure Drop 0.028 in. wg (0.024 kPa) **Document Links**

Lauver Finishes & Odors

Louver Product Selection Guide Louver Products Catalog Louver Warranty Statement

ESD - 403

NEW GABLE LOUVERS

BASIS OF DESIGN: GREENHECK ESD 403 SERIES LOUVER

