23-124

91 S. High Street

ABBR. DESCRIPTION

NUMBER

NOMINAL NOT TO SCALE

OPPOSITE

PLAM PLASTIC LAMINATE

POLISHED

PAINTED

PLATE

PLAS PLASTER

PLYWD PLYWOOD

POL

REQD

RM

R.O.

SECT

STD

T.O.C.

T.O.S.

GROUND FAULT INTERUPTER T.O.W. TOP OF WALL

STL STEEL

STRUCT STRUCTURAL

T.O.B. TOP OF BEAM

NOT IN CONTRACT

OUTSIDE DIAMETER

PRESSURE TREATED

RISER OR RADIUS

REFRIGERATOR

ROUGH OPENING

REVISED OR REVISION

RETURN AIR

RADIATOR

REFER TO

REQUIRED

SOLID CORE

SQUARE FEET

SPECIFICATIONS

STAINLESS STEEL

TONGUE AND GROOVE

TOP OF CONCRETE

UON UNLESS OTHERWISE NOTED

VERIFY IN FIELD

WATER CLOSET

WWF WELDED WIRE FABRIC

WATER RESISTANT

WITHOUT

VINYL COMPOSITION TILE

TOP OF SLAB

TYPICAL

TOP OF

---- HIDDEN LINE ABOVE

SURFACE

FINISH SURFACE

DIMENSION TO OR FROM INDICATED

→ DIMENSION TO OR FROM CENTER

CLEAR DIMENSION TO OR FROM

4' - 0"

SECTION

SHEET

SIMILAR

STANDARD

TELEPHONE

ROOM

SCHED SCHEDULE

DUBLIN, OH 43017

RETAIL TO RESTAURANT CONVERSION PROJECT

OWNER

Dustin Snow

ABBREVIATIONS LEGEND

BOARD

BUILDING

CABINET

CLOSET

CEILING

COLUMN

CONCRETE

DIAMETER

DRAWING

ELECTRICAL

ELEVATION

ENCLOSURE

EQUIPMENT

FINISH FLOOR

FIRE-RATED

GALVANIZED

HOLLOW CORE

HOLLOW METAL

HORIZONTAL

HOUR

HEIGHT

FOOT OR FEET

GAUGE OR GAGE

FIRE-RETARDANT OR

GENERAL CONTRACTOR

HEATING, VENTILATION, AND

AIR CONDITIONING

INSIDE DIAMETER

INCH OR INCHES

LENGTH OVERALL

INCLUDING

LAMINATED LAVATORY

MATERIAL MAXIMUM

MINIMUM

METAL

MECHANICAL MANUFACTURER

MISCELLANEOUS MASONRY OPENING

GYPSUM WALL BOARD

EXISTING

FINISH

FIXTURE

FLOOR

DOWN

DETAIL

EACH

EQUAL

CERAMIC TILE

DISHWASHER

CLEAR

BY OTHERS

BOTTOM OF

CUBIC FEET PER MINUTE

BLDG

B.O.

CFM

CLR

C.T.

DIA

DN

DTL

DW

DWG

ELEC

ENCL

EXIST

FIXT

FLR

F.R.

GFI

H.C.

H.M.

HOR

LAV

MECH

MFR

MISC

M.O. MTL

COL

<u>Dustin.snow@gmail.com</u>;tin.snow@gmail.com" 312.505.7579 7739 Sudbrook Sq. New Albany, OH 43054 GUNZELMAN architecture + interiors, LLC 333 STEWART AVE, COLUMBUS, OHIO 43206 Laurie A Gunzelman, AIA P 614-674-6696 Igunzelman@gunzelmanai.com PROJECT ARCHITECTS


PRATER ENGINEERING ASSOCIATES, INC. 6130 WILCOX ROAD, DUBLIN, OH 43016 P: 614-766-4896 MEP ENGINEER


ELHERS ENGINEERING
STRUCTURAL ENGINEER

WASSERSTROM FOOD SERVICE EQUIPMENT CONSULTANT

ARCHITECTURAL SYMBOLS LEGEND ARCHITECTURAL MATERIALS LEGEND **BRICK MASONRY BUILDING SECTION REFERENCE** SHOWING DWG. NO. OVER SHEET NO. CONCRETE MASONRY UNITS, (CMU) CONCRETE SHOWING DWG. NO. OVER SHEET NO. RIGID INSULATION INTERIOR ELEVATION(S) REFERENCE SHOWING DWG. NO(S). AND SHEET NO. THERMAL OR SOUND ATTENUATION BATT INSULATION DETAIL SECTION REFERENCE SHOWING UNDISTURBED EARTH DWG. NO. OVER SHEET NO. DISTURBED EARTH OR FILL DETAIL REFERENCE SHOWING DWG. NO. OVER SHEET NO. SOLID WOOD PLAN DATUM SHOWING REFERENCE CLG. HT. 8'-0" AFF PLYWOOD OR WOOD PANEL PRODUCT SURFACE AND ELEVATION HEIGHT SECTION OR ELEVATION DATUM REFERENCE SHOWING REFERENCE HT & EL SPRAY APPLIED INSULATION DOOR INDICATOR SHOWING DOOR WINDOW INDICATOR SHOWING WINDOW TYPE WALL INDICATOR SHOWING WALL PROJECT LOCATION: REVISION INDICATOR SHOWING 91 S. HIGH STREET REVISION NO. NOTE INDICATOR SHOWING NOTE NO. _____ CENTERLINE _____



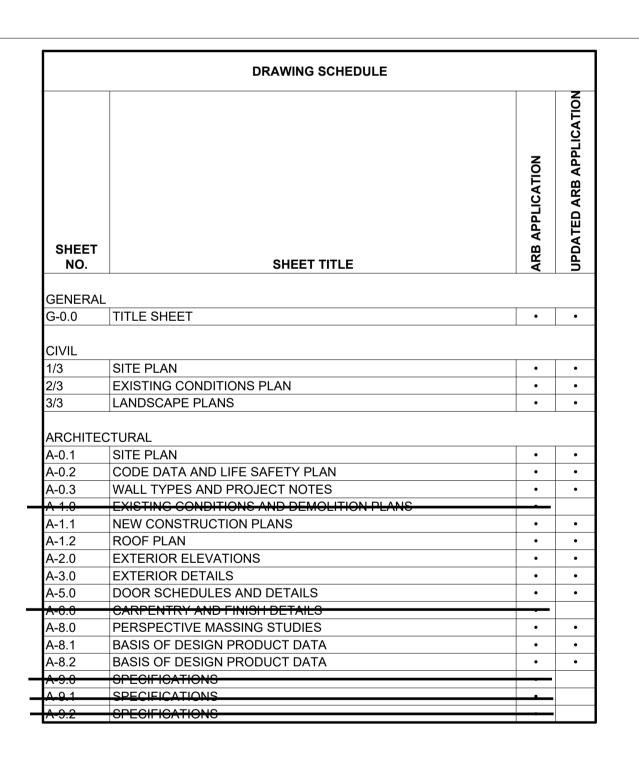

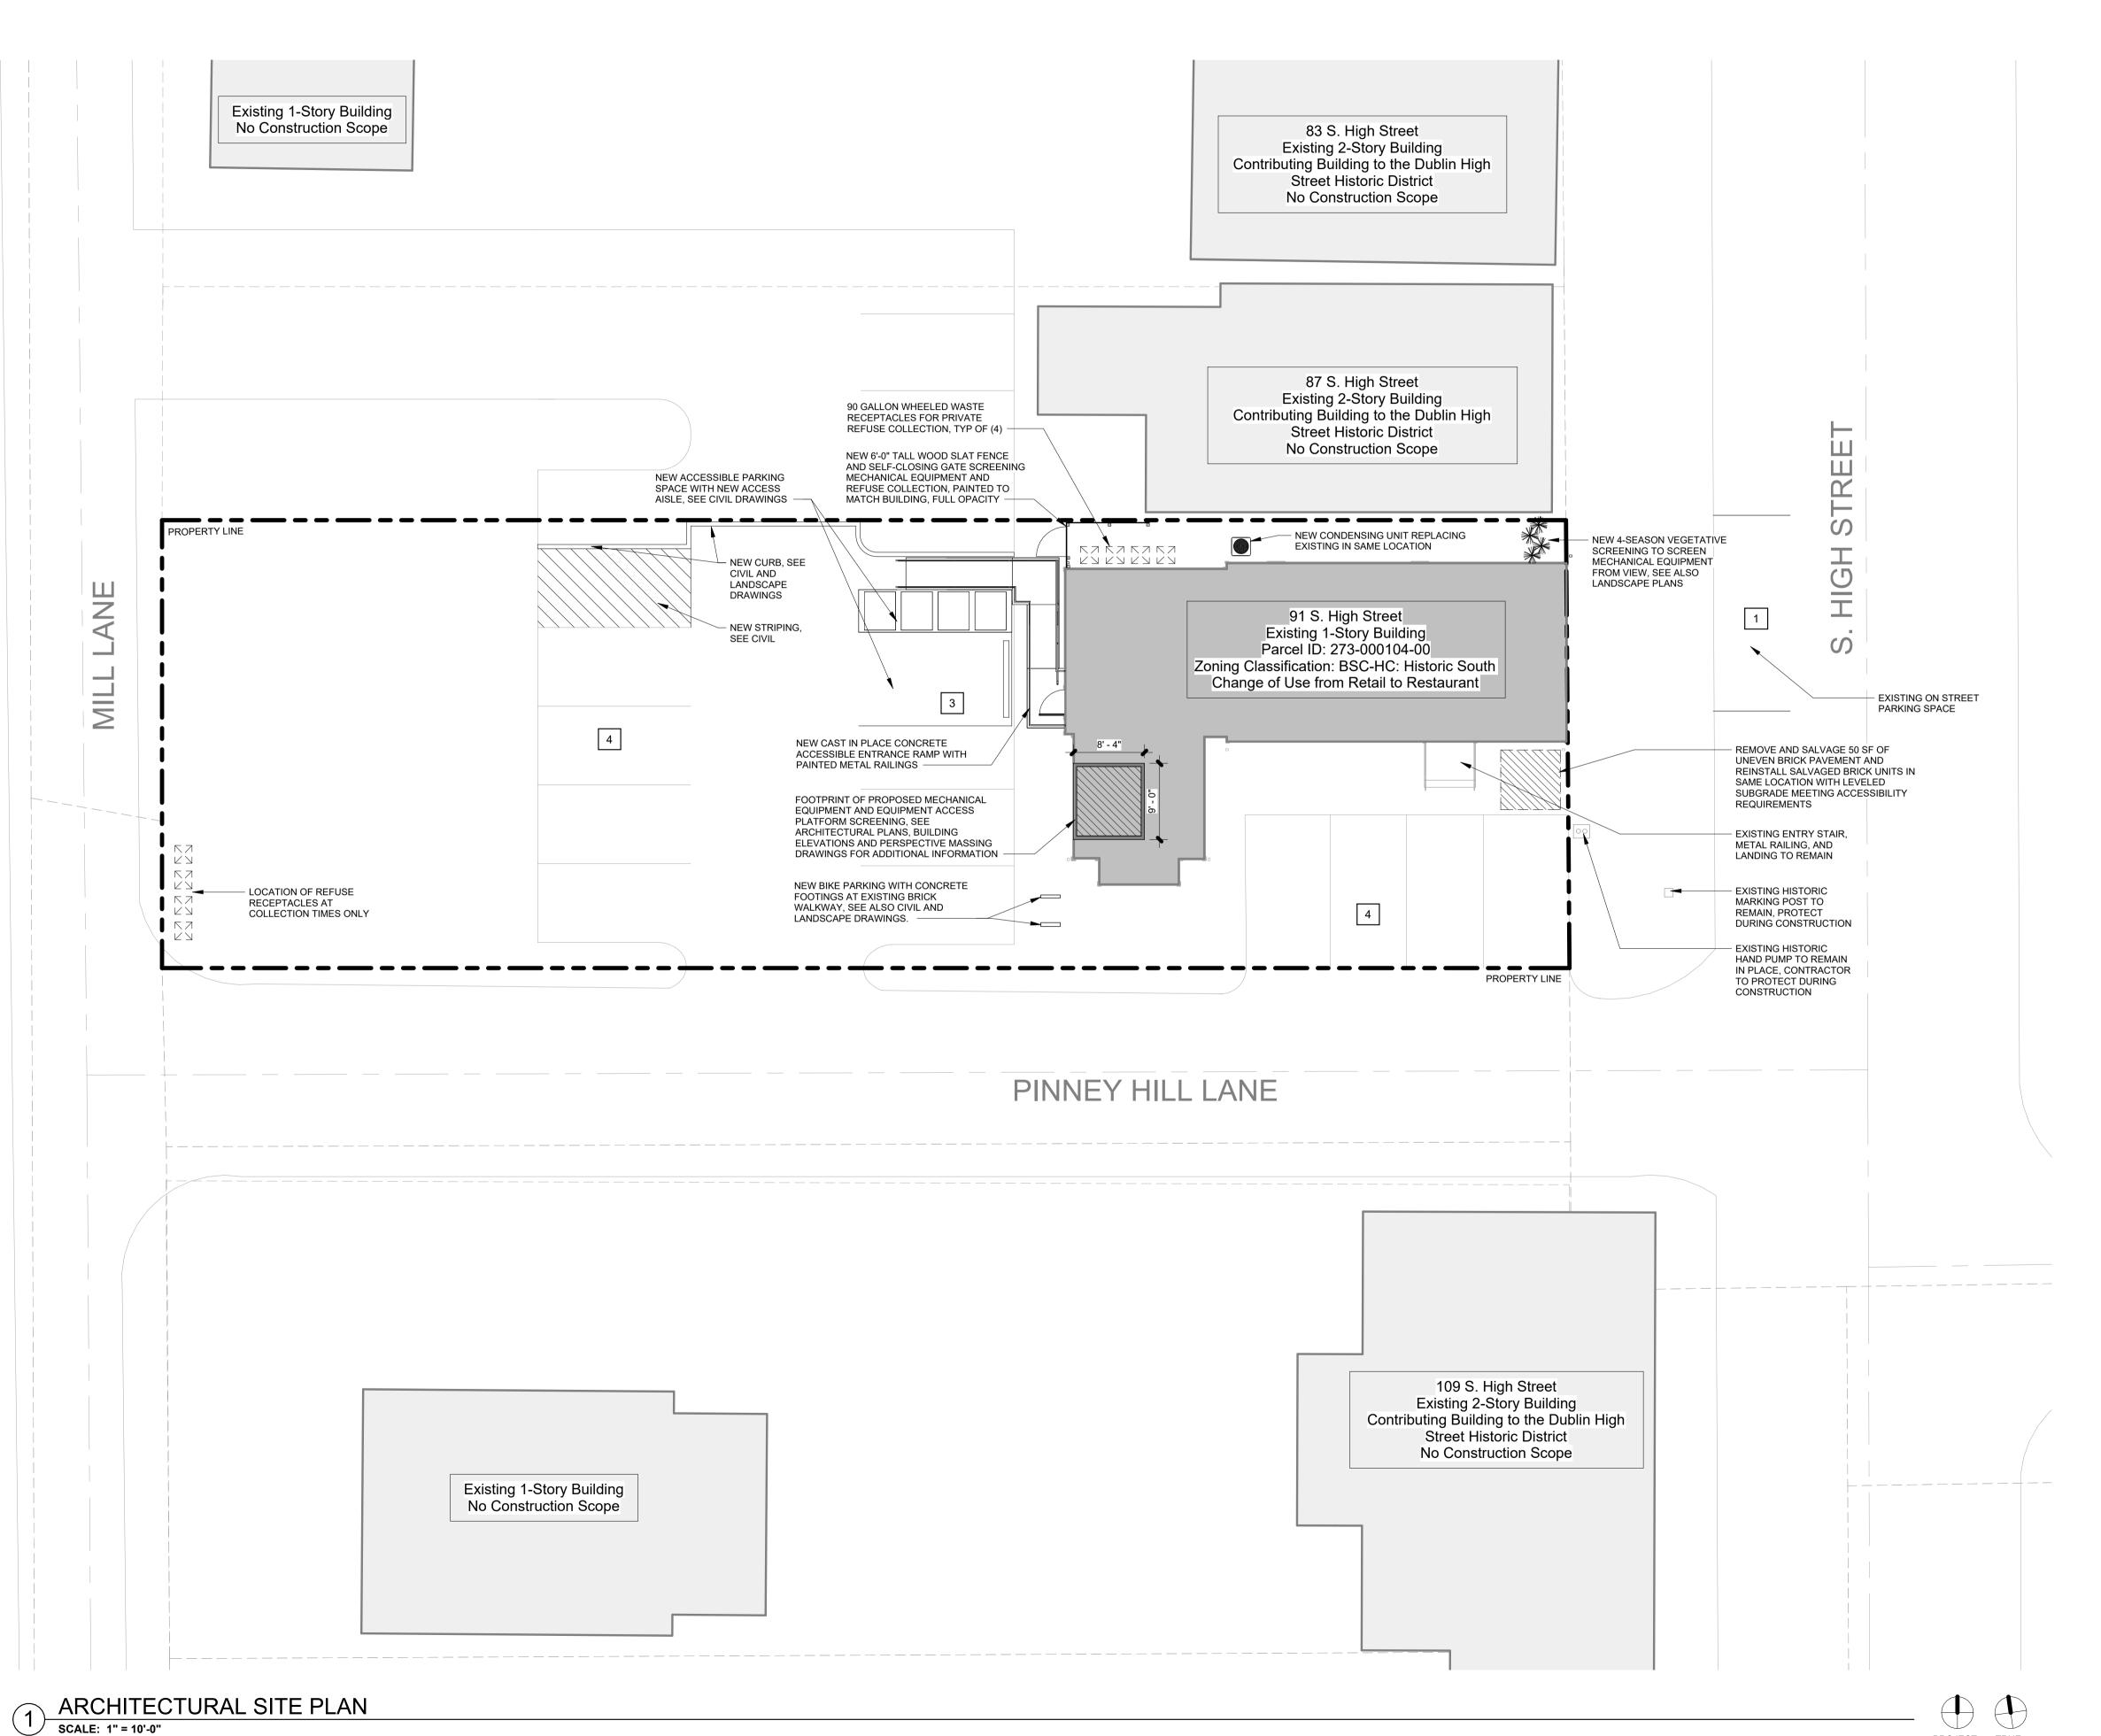

<u>LEGAL DESCRIPTION</u>: 91 S HIGH ST VILLAGE OF DUBLIN 55.70'MID PT LOT 134

SITE ADDRESS: 91 S HIGH ST, DUBLIN OH 43017 TOTAL LOT AREA: 0.2 ACRES, 8,693 SF

ZONING CLASSIFICATION: BSC-HC: HISTORIC SOUTH

PARCEL #: 273-000104-00

ZONING REQUIREMENT AND DATA SUMMARY

Change of use at an existing one-story building from retail to restaurant DESCRIPTION: uses. No change in building footprint proposed. New work includes addition of accessible parking space, painting of building exterior with colors from ARB preapproved list, and addition of rooftop HVAC equipment to serve new restaurant kitchen.

EXISTING USE: Retail, General PROPOSED USE: Eating and Drinking (PERMITTED PER TABLE 153.172A)

GROSS BUILDING FOOTPRINT AREA: 1457 SF (EXISTING AREA, NO CHANGE PROPOSED) PROPOSED INDOOR GROSS AREA*: 1190 SF BUILDING HEIGHT: 16'-0" (EXISTING HEIGHT, NO CHANGE PROPOSED)

SETBACKS: NO CHANGES PROPOSED

OFF-STREET PARKING CALCULATION

11 Off Street Vehicle parking spaces proposed

TABLE 153.173C: REQUIRED VEHICLE PARKING

Maximum Permitted
125% of minimum Minimum Required 10 per 1,000 sq ft.

Indoor Gross Area* = 1190 SF

• 635 SF Dining Room & Bar 475 SF Kitchen

80 SF Toilet Rooms

Eating and Drinking

Vehicle Parking Calculation = 1190 SF @ 10 per 1000 sf = 11.9 vehicle parking spaces

12 minimum vehicle parking spaces required

11 vehicle parking spaces to be provided on site 1 existing street parking space at front of property

*Per 153.173 (7)(a)3, all square footage requirements for required vehicle parking are based

on indoor gross floor area

PROJECT TRUE NORTH NORTH

GUNZELMAN

PJT # : 23-124

reet St High

6

REVISIONS

DATE

ARB



- 1. THE INFORMATION SHOWN CONCERNING EXISTING UTILITIES IS NOT REPRESENTED, WARRANTED OR GUARANTEED TO BE COMPLETE OR ACCURATE. INVESTIGATION, LOCATION, SUPPORT, PROTECTION AND RESTORATION OF ALL EXISTING UTILITIES AND APPURTENANCES SHALL BE THE RESPONSIBILITY OF THE CONTRACTOR. IT SHALL BE THE RESPONSIBILITY OF THE CONTRACTOR, PRIOR TO CONSTRUCTION TO DETERMINE IN THE FIELD THE ACTUAL LOCATION AND ELEVATIONS OF ALL EXISTING UTILITIES WHETHER SHOWN ON THE PLANS OR NOT. THE CONTRACTOR SHALL CALL THE OHIO UTILITIES PROTECTION SERVICES, OUPS, AT 1-800-362-2764 TWO (2) WORKING DAYS PRIOR TO THE START OF CONSTRUCTION.
- 2. THE CONTRACTOR IS RESPONSIBLE FOR OBTAINING ALL LOCAL AND STATE PERMITS REQUIRED FOR DEMOLITION WORK.
- 3. THE CONTRACTOR SHALL IDENTIFY AND HOLD HARMLESS THE OWNER AND/OR ENGINEER FOR ANY AND ALL INJURIES OR DAMAGES TO PERSONNEL, EQUIPMENT, AND/OR EXISTING FACILITIES IN THE DEMOLITION AND CONSTRUCTION DESCRIBÉD IN THE PLANS AND SPECIFICATIONS.
- 4. EXISTING CONDITIONS AS DEPICTED ON THESE PLANS ARE GENERAL AND ILLUSTRATIVE IN NATURE AND DO NOT INCLUDE MECHANICAL, ELECTRICAL, AND MISCELLANEOUS STRUCTURES. IT IS THE RESPONSIBILITY OF THE CONTRACTOR TO EXAMINE THE SITE AND BE FAMILIAR WITH EXISTING CONDITIONS PRIOR TO BIDDING ON THE DEMOLITION WORK FOR THIS PROJECT. IF CONDITIONS ENCOUNTERED DURING EXAMINATION ARE SIGNIFICANTLY DIFFERENT THAN THOSE SHOWN, THE CONTRACTOR SHALL NOTIFY THE ENGINEER IMMEDIATELY
- 5. ALL DEMOLITION WASTE AND CONSTRUCTION DEBRIS SHALL BE REMOVED BY THE CONTRACTOR AND DISPOSED OF IN A STATE APPROVED WASTE SITE AND IN ACCORDANCE WITH ALL LOCAL AND STATE CODES AND PERMIT
- 6. THE BURNING OF CLEARED MATERIAL AND DEBRIS SHALL NOT BE ALLOWED UNLESS CONTRACTOR GETS WRITTEN AUTHORIZATION FROM LOCAL
- EROSION AND SEDIMENTATION CONTROL MEASURES AROUND AREAS OF DEMOLITION SHALL BE INSTALLED PRIOR TO INITIATION OF DEMOLITIONS ACTIVITIES. REFER TO THE EROSION CONTROL PLAN FOR DETAILS.
- ASBESTOS OR HAZARDOUS MATERIAL, IF FOUND ON SITE, SHALL BE REMOVED BY A LICENSED HAZARDOUS MATERIALS CONTRACTOR. CONTRACTOR SHALL NOTIFY OWNER IMMEDIATELY IF HAZARDOUS MATERIAL ARE ENCOUNTERED.
- 9. CONTRACTOR SHALL PROTECT ALL CORNER PINS, MONUMENTS, PROPERTY CORNERS, AND BENCHMARKS DURING DEMOLITION ACTIVITIES. IF DISTURBED, THE CONTRACTOR SHALL HAVE DISTURBED ITEMS RESET BY A LICENSED SURVEYOR AT NO ADDITIONAL COST TO THE OWNER.
- 10. CONTRACTOR SHALL ADHERE TO ALL LOCAL, STATE, FEDERAL, AND OSHA REGULATIONS WHEN OPERATING DEMOLITION EQUIPMENT AROUND UTILITIES.

- ACCORDANCE WITH THE ODOT STANDARDS, AND AS REQUIRED BY LOCAL NEED, EXTENT, AND LIMITATIONS ASSOCIATED WITH INSTALLING AND
- 12. CONTRACTOR SHALL PROTECT AT ALL TIMES ADJACENT STRUCTURES AND

11. CONTRACTOR SHALL PROVIDE AND MAINTAIN TRAFFIC CONTROL MEASURES IN AGENCIES WHEN WORKING IN AND/OR ALONG STREETS, ROADS, HIGHWAYS, ETC. IT SHALL BE THE CONTRACTOR'S RESPONSIBILITY TO OBTAIN APPROVAL AND COORDINATE WITH LOCAL AND/OR STATE AGENCIES REGARDING THE

MAINTAINING TRAFFIC CONTROL MEASURES.


ITEMS FROM DAMAGE DUE TO DEMOLITION ACTIVITIES. 13. CONTRACTOR SHALL REFER TO OTHER PLANS WITHIN THIS CONSTRUCTION SET FOR OTHER PERTINENT INFORMATION.




GRAPHIC SCALE

1 INCH = 10 FEET

OAST WINE HOUSE
91 S. HIGH STREET, DUBLIN, OH
PROJECT NUMBER 23-124

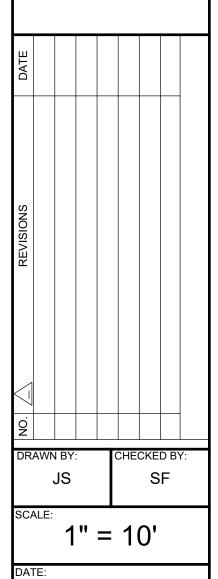

07-01-2023

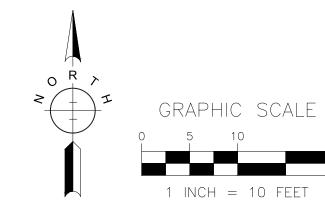

LANDSCAPE REQUIREMENTS: CITY OF DUBLIN CODE SECTION 153.130 & 153.173

LOT COVERAGE:

PARCEL: 9,125 S.F. (0.21 AC.) VEHICULAR USE AREA: 2,930 S.F. (32%) BUILDING AREA: 1,190 S.F. (13%)

PARKING LOT SCREENING AND LANDSCAPING: PERIMETER BUFFER LANDSCAPING


REQUIRED: CONTINUOUS HEDGE AND 1 TREE PER 40 L.F..

PROVIDED: CONTINUOUS HEDGE AND 1 TREE PER 40 L.F..

INTERIOR VEHICULAR USE AREA LANDSCAPING DOES NOT APPLY - FEWER THAN 20 SPACES AND LESS

THAN 6,00 S.F. OF PARKING AREA.

SERVICE STRUCTURES
ALL SERVICE STRUCTURES SHALL HAVE CONTINUOUS (100% OPACITY) SCREENING.

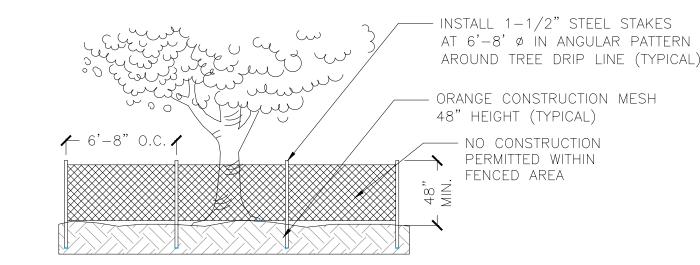

TREE PROTECTION DETAIL

TO BE USED ON ALL EXISTING TREES NO SCALE

NOTES:

STEMS.

ALL PLANT MATERIALS TO COMPLY WITH THE LATEST EDITION OF AMERICAN STANDARD FOR NURSERY STOCK BY AMERICAN NURSERY AND LANDSCAPE ASSOCIATION, AND BE GUARANTEED FOR A PERIOD OF ONE (1) YEAR FROM THE DATE OF JOB ACCEPTANCE.

CONTRACTOR IS RESPONSIBLE FOR LOCATING AND PROTECTING ALL UTILITIES PRIOR TO INSTALLATION. NOTIFY ENGINEER IF FIELD CONDITIONS NECESSITATE ADJUSTMENT OF PLANT LOCATIONS.

SCREENING SHRUBS TO PROVIDE 100% OPACITY PER DUBLIN ZONING CODE, SECTION 153.

CONSULT PLANT SCHEDULE FOR PLANT SIZES AND SPECIFICATIONS.

CONTRACTOR IS RESPONSIBLE FOR ALL PLANTS SHOWN ON PLANS. PLANT LIST QUANTITIES ARE FOR CONVENIENCE ONLY.

PARKING LOT AND STREET TREES SHALL HAVE A CLEAR CANOPY HEIGHT OF 6' MIN.

ALL SHRUB AND GROUND COVER BEDS TO BE MULCHED WITH A MINIMUM OF 2 INCHES OF SHREDDED HARDWOOD MULCH. MULCH PLANTING BEDS WITH SHREDDED HARDWOOD MULCH OF UNIFORM DARK BROWN COLOR. MULCH SHALL BE FREE OF TWIGS, LEAVES, DISEASE, PEST OR OTHER MATERIAL UNSIGHTLY OR INJURIOUS TO PLANTS. PULL MULCH AWAY FROM SHRUB

CONTRACTOR SHALL PROVIDE A ONE YEAR GUARANTEE ON ALL PLANTS INSTALLED AND PROVIDE COMPLETE MAINTENANCE ON ALL WORK FROM THE DAY OF APPROVAL OF THE OWNER'S REPRESENTATIVE CONTINUING FOR A THREE MONTH DURATION AT WHICH TIME THE OWNER WILL DECLARE JOB ACCEPTANCE.

EACH PLANTING TO BE FREE FROM DISEASE, INSECT INFESTATION AND DAMAGE AND IN ALL RESPECTS BE READY FOR FIELD PLANTING.

PLANTING HOLES TO BE DUG A MINIMUM OF TWICE THE WIDTH AND EQUAL IN DEPTH TO THE SIZE OF THE ROOT BALL AND TO BE AMENDED WITH ORGANIC SOIL CONDITIONER.

BED EDGES SHALL BE SMOOTH, CONSISTENT, HAND TRENCHED

6" DEEP AND 'V' SHAPED UNLESS OTHERWISE NOTED. ALL EXCAVATED MATERIAL SHALL BE REMOVED FROM THE BED EDGE AND THE PLANTING BED.

IN AREAS WHERE BEDROCK OR HEAVILY COMPACTED ROCK FILL IS ENCOUNTERED, THE PLANTING HOLES ARE TO BE DUG TO A MINIMUM OF THREE TIMES THE WIDTH AND ONE FOOT DEEPER THAN THE SIZE OF THE ROOT BALL. NOTIFY ENGINEER IF FIELD CONDITIONS WARRANT ADJUSTMENT OF PLANT LOCATIONS.

EXISTING GRASS TO BE REMOVED, IF PRESENT, AND TOPSOIL TO BE SPREAD SMOOTH AND HAND RAKED TO REMOVE ALL ROCKS AND DEBRIS LARGER THAN 1 INCH IN DIAMETER PRIOR TO LAYING SOD OR SEEDING.

ALL CHANGES TO DESIGN OR PLANT SUBSTITUTIONS ARE TO BE AUTHORIZED BY THE LANDSCAPE ARCHITECT.


TOPSOIL IN LAWN AREA TO BE 4" IN DEPTH. TOPSOIL MIX IN PLANTING BEDS TO BE 3 PARTS SCREENED TOPSOIL AND 1 PART ORGANIC MATERIAL TO A DEPTH OF 24".

ALL SEEDING INSTALLATION SHALL CONFORM TO ODOT SPECIFICATIONS. SEED AT 6 LBS/1000 SF WITH THE FOLLOWING SEED MIXTURE: KENTUCKY BLUEGRASS 30% CREEPING FESCUE 20% ANNUAL RYEGRASS PERENNIAL RYEGRASS 10%

ALL TREES, SHRUBS, GROUNDCOVER AND LAWNS TO BE FERTILIZED WITH A COMMERCIAL GRADE FERTILIZER CONSISTING OF FAST AND SLOW RELEASE NITROGEN. SEED AREAS TO BE COVERED WITH CLEAN OAT OR WHEAT STRAW WELL SEASONED BEFORE BAILING, FREE FROM MATURE SEED—BEARING STALKS OR FORM & MULCH BEYOND ROOTS OF PROHIBITED NOXIOUS WEEDS.

CONTRACTOR SHALL THOROUGHLY WATER ALL PLANTS AT TIME OF INSTALLATION AND AS NEEDED UNTIL PROJECT ACCEPTANCE BY OWNER.

			PLANT LIST	Γ				
KEY	SYMBOL	BOTANICAL NAME	COMMON NAME	QTY.	SIZE	CONDITION	DECID./EV.	REMARKS
		TREES						
MAG VIR	Θ	MAGNOLIA VIRGINIANA	HOPHORNBEAM	1	2.5" CAL.	B&B	D	
		SHRUBS						
TAX CUS		TAXUS CUSPIDATA 'CAPITATA'	JAPANESE YEW	3	42"	B&B		
THU SMA	0	TJUJA OCCIENTALIS 'SMARAGD'	SMARAGD ARBORVITAE	12	6-7'	B&B	E	3.0' O.C.
THU LIT	0	THUJA OCCIDENTALIS 'LITTLE GIANT'	LITTLE GIANT ARBORVITAE	11	#3	CONT.	E	24" MIN. HT., 3.0' O.C.

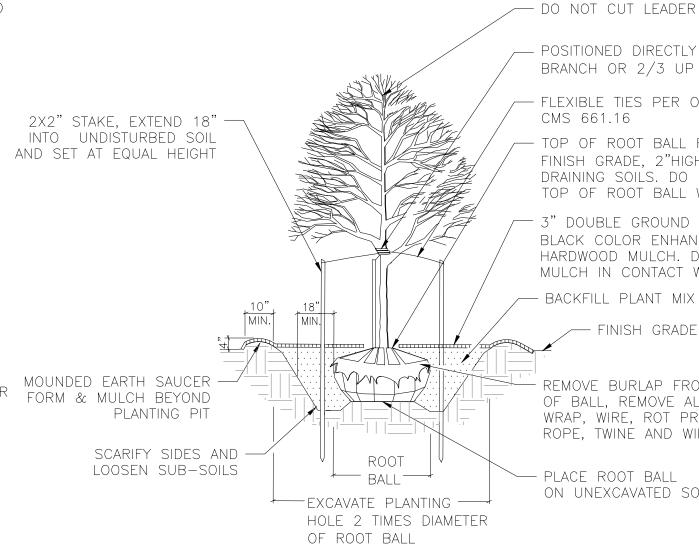

- POSITIONED DIRECTLY ABOVE FIRST BRANCH OR 2/3 UP TREE - FLEXIBLE TIES PER ODOT CMS 661.16

TOP OF ROOT BALL FLUSH TO FINISH GRADE, 2"HIGHER IN SLOW DRAINING SOILS. DO NOT COVER TOP OF ROOT BALL WITH SOIL

3" DOUBLE GROUND BROWN OR BLACK COLOR ENHANCED (DYED) HARDWOOD MULCH. DO NOT PLACE MULCH IN CONTACT WITH TRUNK. - BACKFILL PLANT MIX

REMOVE BURLAP FROM TOP 2/3 OF BALL, REMOVE ALL PLASTIC WRAP, WIRE, ROT PROOF WRAP, ROPE, TWINE AND WIRE CAGE

— FINISH GRADE


— PLACE ROOT BALL ON UNEXCAVATED SOIL

REMOVE ALL BURLAP, WIRE CAGE, — 3" DOUBLE GROUND BROWN OR BLACK TWINE AND ROPE FROM UPPER COLOR ENHANCED (DYED) HARDWOOD 2/3 OF ROOT BALL AFTER FIRMLY MULCH. DO NOT PLACE MULCH IN STABILIZING LOWER 1/3 OF ROOT CONTACT WITH TRUNK. BALL IN PLANTING MIX PLANTING BED ----EDGE TREATMENT, REFER TO PLANS FINISH GRADE - PLANTING MIXTURE SET ROOTBALL ON UNEXCAVATED SOIL

NOTES:

ALL SHRUBS PLANTED IN ROWS OR MASSES SHALL BE MATCHED IN SIZE AND FORM. SHRUBS SHALL BEAR SAME RELATION TO FINISH GRADE AS THEY BORE TO EXISTING GRADE IN THE PREVIOUSLY PLANTED CONDITION.

> MASS SHRUB PLANTING DETAIL (B&B OR CONTAINER) NOT TO SCALE

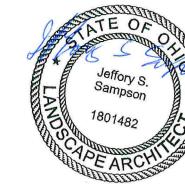


1" = 10'

07-01-2023

AST WINE HOUS 91 S. HIGH STREET, DUBLIN, OH ROJECT NUMBER 23-124

SIT

DECIDUOUS TREE PLANTING DETAIL

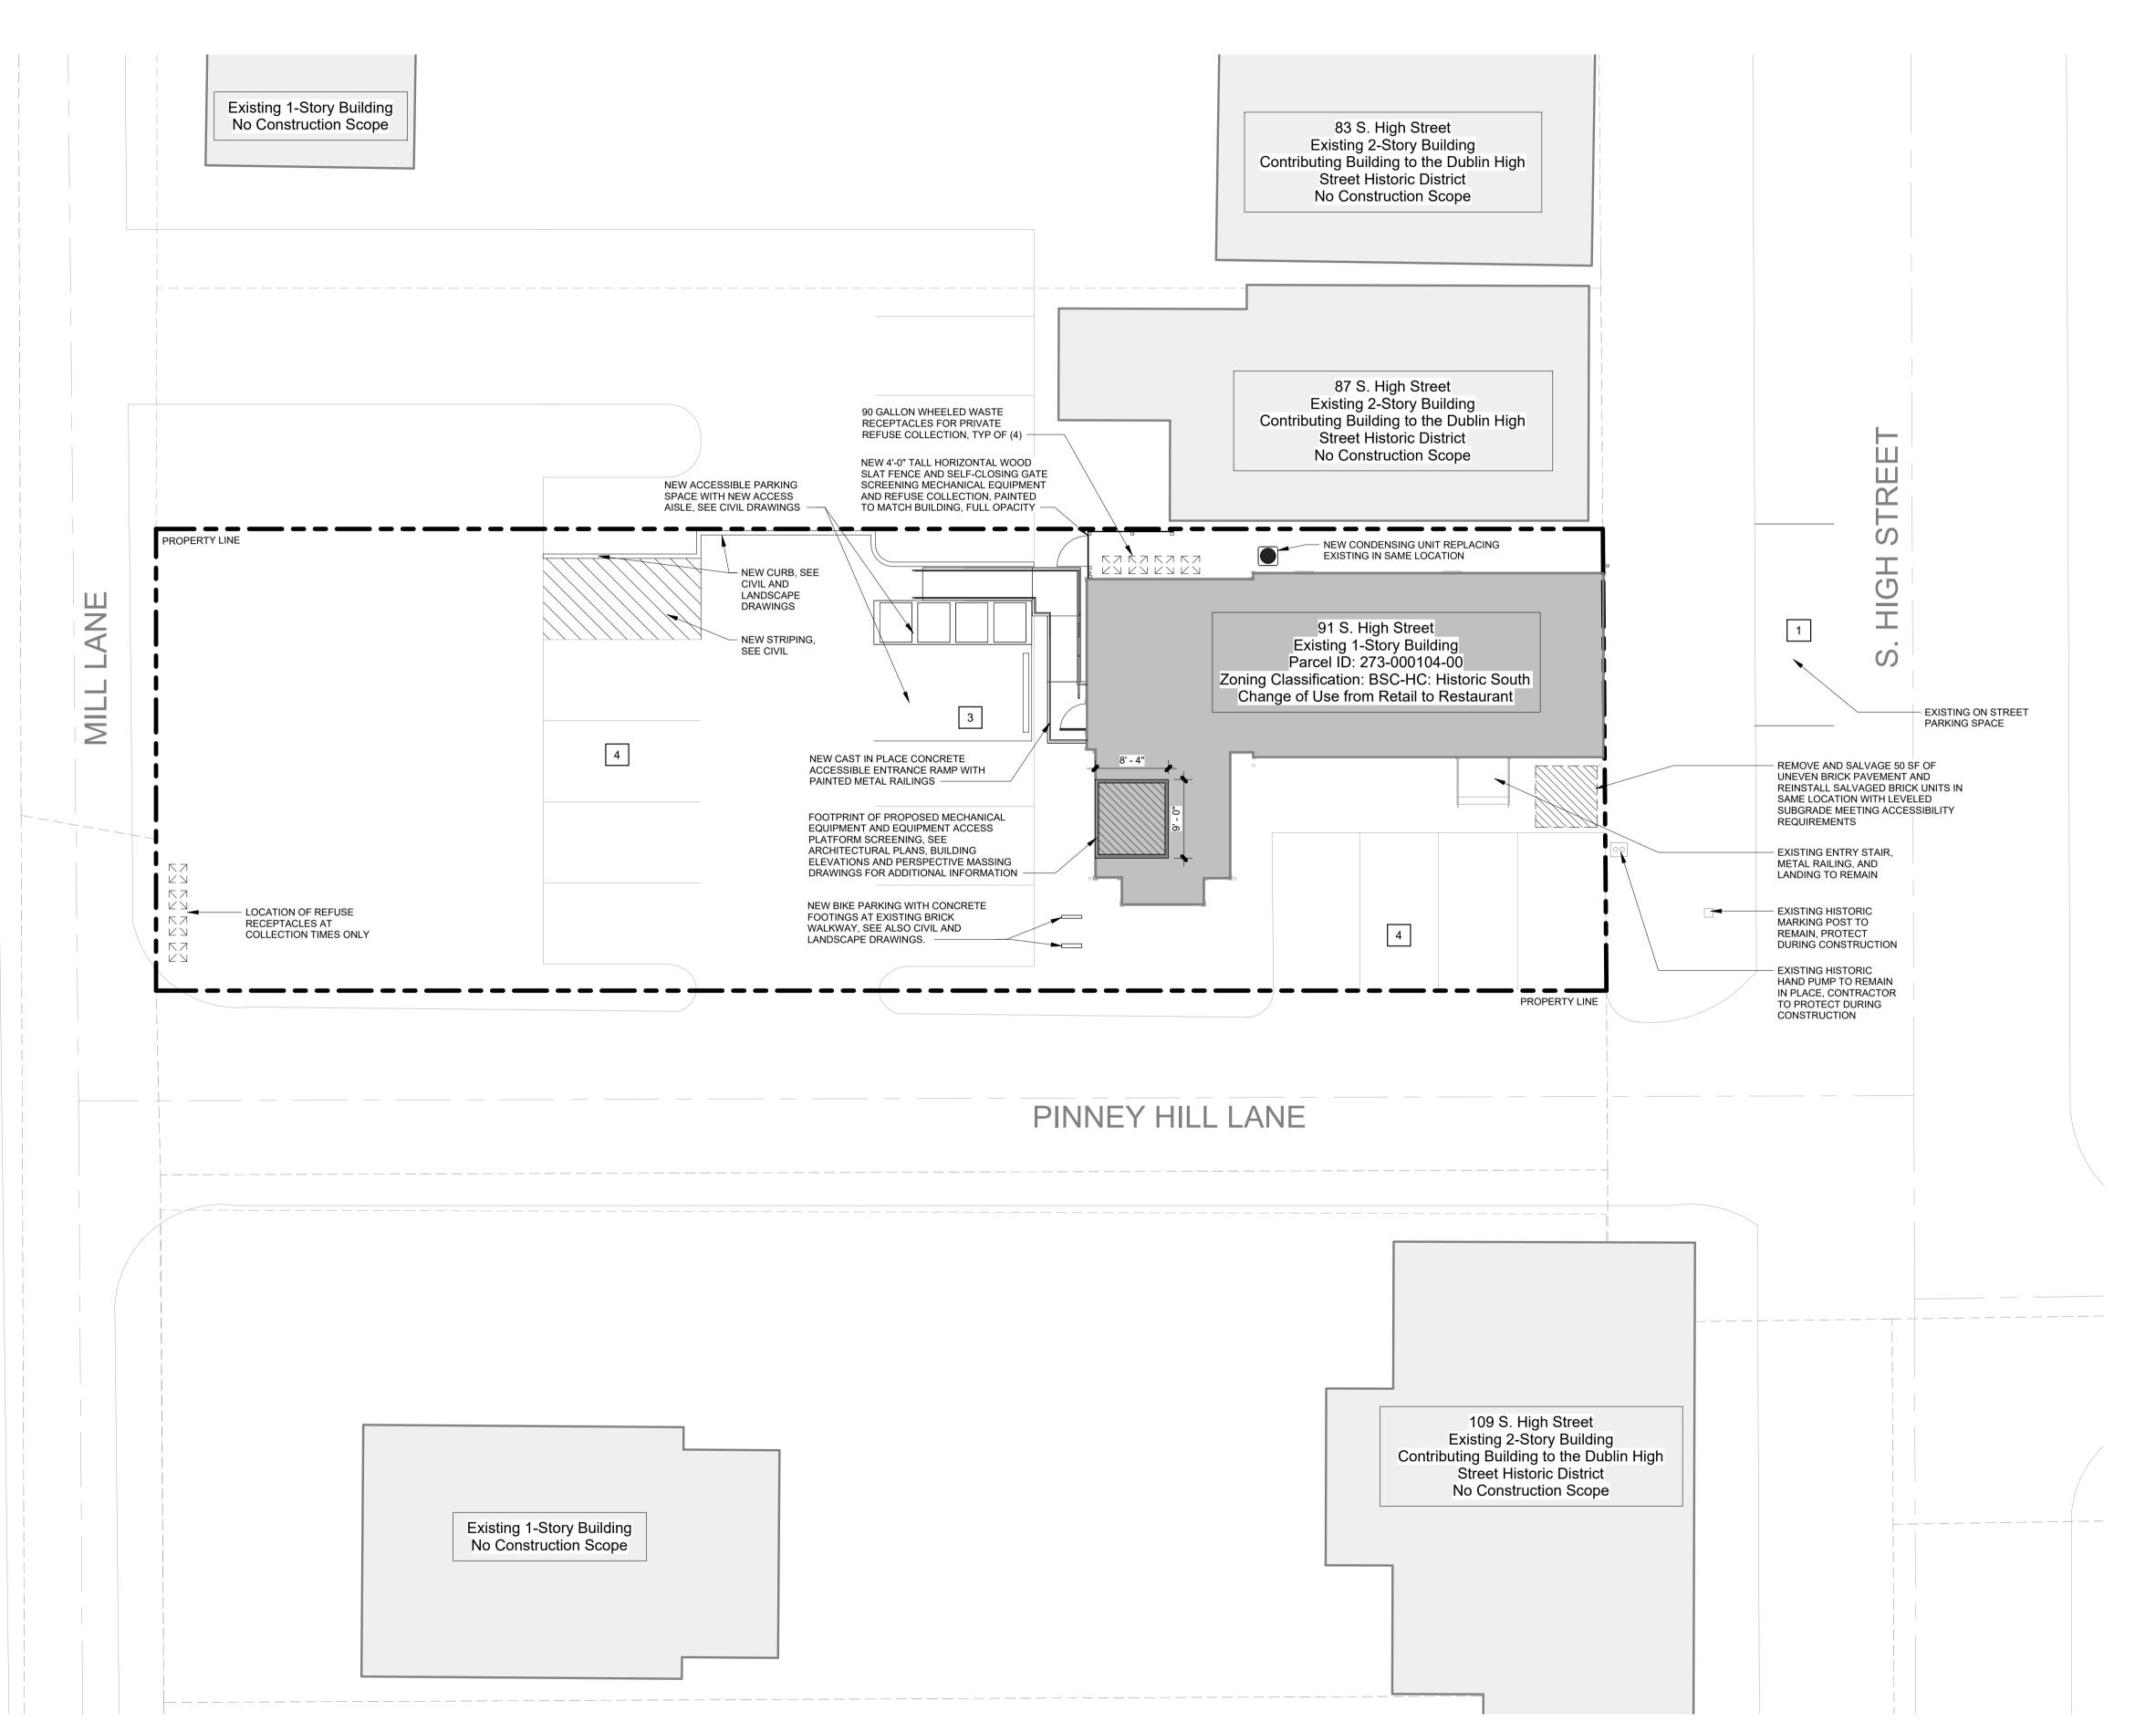

ARCHITECTURAL SITE PLAN

SCALE: 1" = 10'-0"

<u>LEGAL DESCRIPTION</u>: 91 S HIGH ST VILLAGE OF DUBLIN 55.70'MID PT LOT 134

SITE ADDRESS: 91 S HIGH ST, DUBLIN OH 43017 TOTAL LOT AREA: 0.2 ACRES, 8,693 SF

ZONING CLASSIFICATION: BSC-HC: HISTORIC SOUTH

PARCEL #: 273-000104-00

ZONING REQUIREMENT AND DATA SUMMARY

Change of use at an existing one-story building from retail to restaurant DESCRIPTION: uses. No change in building footprint proposed. New work includes addition of accessible parking space, painting of building exterior with colors from ARB preapproved list, and addition of rooftop HVAC equipment to serve new restaurant kitchen.

EXISTING USE: Retail, General PROPOSED USE: Eating and Drinking (PERMITTED PER TABLE 153.172A)

GROSS BUILDING FOOTPRINT AREA: 1457 SF (EXISTING AREA, NO CHANGE PROPOSED) PROPOSED INDOOR GROSS AREA*: 1190 SF BUILDING HEIGHT: 16'-0" (EXISTING HEIGHT, NO CHANGE PROPOSED)

SETBACKS: NO CHANGES PROPOSED

OFF-STREET PARKING CALCULATION

11 Off Street Vehicle parking spaces proposed

TABLE 153.173C: REQUIRED VEHICLE PARKING

Maximum Permitted
125% of minimum Minimum Required Eating and Drinking 10 per 1,000 sq ft.

Indoor Gross Area* = 1190 SF

• 635 SF Dining Room & Bar 475 SF Kitchen

80 SF Toilet Rooms

Vehicle Parking Calculation = 1190 SF @ 10 per 1000 sf = 11.9 vehicle parking spaces

12 minimum vehicle parking spaces required

11 vehicle parking spaces to be provided on site 1 existing street parking space at front of property

*Per 153.173 (7)(a)3, all square footage requirements for required vehicle parking are based on indoor gross floor area

PROJECT TRUE NORTH NORTH

GUNZELMAN

PJT # : 23-124

reet St High

6

REVISIONS

DATE

ARB

CODE PLAN LEGEND



-MEASURED MAXIMUM EXIT │ T.D. = ## FT-ACCESS TRAVEL OCC = # --ACTUAL OCCUPANTS SERVED CAP = ### 👡 -MAXIMUM EXIT CAPACITY

CODE REQUIREMENTS AND ANALYSIS

PROJECT DESCRIPTION: Alteration of existing building to change use of building from retail and salon business to restaurant.

BUILDING ADDRESS: 91 S. High Street YEAR CONSTRUCTED:

AHJ: CITY OF DUBLIN

AREA OF BUILDING: 1457 SF

APPLICABLE CODES: 2017 OHIO BUILDING CODE 2017 OHIO MECHANICAL CODE 2017 OHIO PLUMBING CODE 2017 OHIO FIRE CODE

2012 INTERNATIONAL ENERGY CODE 2010 ASHRAE 90.1 2015 INTERNATIONAL FUEL GAS CODE 2017 NATIONAL ELECTRIC CODE, NFPA 70

CHAPTER 3: USE AND OCCUPANCY EXISTING BUILDING USE: MIXED USE. NON-SEPARATED - GROUP M MERCHANTILE (309.1: RETAIL STORE)

- GROUP B BUSINESS (304.1: BEAUTY SHOP) PROPOSED BUILDING USE:

- GROUP A-2 ASSEMBLY (303.3: RESTAURANTS)

CHAPTER 5: GENERAL BUILDING HEIGHTS AND AREAS TYPE V-B, NON-SPRINKLERED, A-2 OCCUPANCY

EXISTING BUILDING HEIGHT: 18 FEET, 1 STORY; NO HEIGHT CHANGE PROPOSED EXISTING BUILDING AREA: 1,457 SF; NO AREA CHANGES PROPOSED

ALLOWABLE HEIGHT AND TABULAR AREA Table 504.3 Table 504.4 Table 506.2 HEIGHT STORIES TABULAR AREA (NS)

(PROPOSED OCCUPANCY COMPLIES WITH HEIGHT AND AREA LIMITS FOR V-B CONSTRUCTION TYPE)

CHAPTER 6: TYPE OF CONSTRUCTION

CONSTRUCTION TYPE: **EXISTING TYPE V-B** (OBC TABLE 601) REQUIRED FIRE RATING IN HRS (F.R.R.) **COMPONENT** STRUCTURAL FRAME (NO CHANGES) 0 HRS BEARING WALLS (EXT) 0 HRS (NO CHANGES) 0 HRS BEARING WALLS (INT) (NO CHANGES) NON BEARING WALL (EXT) Varies, see Table 602

NON BEARING WALL (INT) (NEW WALLS TO COMPLY) 0 HRS 0 HRS (NO CHANGES) **FLOOR** ROOF 0 HRS (NO CHANGES)

TABLE 602 FIRE-RESISTANCE RATING REQUIREMENTS FOR EXTERIOR WALLS

GROUPS A-2; TYPE V-B FIRE SEP. DISTANCE RATING

NOT APPLICABLE 5 ≤ X < 10 COMPLIES, SEE WALL TYPE 'B'

 $10 \le X < 30$ NOT APPLICABLE EXST. EXTERIOR WALLS COMPLY, NO WORK X ≥ 30

CHAPTER 9: FIRE PROTECTION SYSTEMS FIRE SUPPRESSION: NONE EXISTING, NO CHANGES PROPOSED SUPPRESSION NOT REQUIRED PER OBC 903

FIRE ALARM: NONE EXISTING IN TENANT SPACE, NO CHANGES PROPOSED FIRE ALARM SYSTEM NOT REQUIRED PER OBC 907

CHAPTER 10: MEANS OF EGRESS OCCUPANT LOAD CALCULATIONS

FLOOR AREAS WITHOUT FIXED SEATING (TABLE 1004.1.2) **FACTOR** FUNCTION OF SPACE <u>AREA</u> OCC. LOAD Dining Room and Bar 15 net 440

FLOOR AREAS WITH FIXED SEATING (SECTION 1004.4) FACTOR LENGTH OCC. LOAD SEATING AREA Dining Room East Banquet 1 occ. / 24" Dining Room West Banquet 1 occ. / 24" 13'-0"

200 gross

TOTAL OCCUPANCY OF TENANT SPACE: 49 OCCUPANTS

CHAPTER 11: ACCESSIBILITY - SEE CH. 3411

CHAPTER 13: ENERGY EFFICIENCY 1301.1.1 Criteria - Buildings shall be designed and constructed in accordance with the International Energy Conservation Code - (2012 IECC REFERNCED IN OBC CH 35)

IECC C101.4.2 Historic Buildings: Any building or structure that is listed in the State or National Register of Historic Places; designated as a historic property under local or state designation law or survey; certified as a contributing resource with a National Register listed or locally designated historic district; ... are exempt from this code. (BUILDING IS LISTED ON NATIONAL REGISTER OF HISTORIC PLACES AND IS A CONTRIBUTING RESOURCE TO HISTORIC DISTRIC; STRUCTURE IS EXEMPT FROM

REQUIREMENTS OF IECC PER C101.4.2)

CHAPTER 29: PLUMBING OBC TABLE 2902.1 Minimum Number of Required Plumbing Fixtures

USE: A-2, Restaurant

WCs <u>Female</u> **TUB/SHOWERS** None Required 1 per 500 1 per 75 1 per 75 1 per 200

FIXTURES PROVIDED: 2 WATER CLOSETS, 2 LAVATORYS, 1 SERVICE SINK

*(See Section 410 of the plumbing code for Drinking Fountain exceptions) **OPC Section 410.4 Substitution** Where restaurants provide drinking water in a container free of charge, drinking fountains shall not be required in those restaurants. In other occupancies, where water dispensers are provided, drinking fountains shall not be required.

(WATER TO BE PROVIDED BY RESTAURANT FREE OF CHARGE) **CHAPTER 34: EXISTING BUILDINGS AND STRUCTURES** Section 3401.1.1 Compliance:

Compliance shall be demonstrated by meeting the requirements of one of the following: 1. Chapters 2 through 33 of this code; or 2. Sections 3403 through 3411; or 3. Section 3412 Compliance Alternatives.

(COMPLIANCE SHALL BE DEMONSTRATED BY OPTION #2, 3403-3411)

3401.1.1.1 Energy Code Compliance: Alterations, repairs, additions and changes of occupancy to, or relocation of, existing buildings and structures shall also comply with the provisions for alterations, repairs, additions and changes of occupancy or relocation in the International Energy Conservation Code, and the ASHRAE 90.1 as referenced in Chapter 35...

(STRUCTURE IS EXEMPT FROM REQUIREMENTS OF IECC PER IECC C101.4.2)) 3411 Accessibility for Existing Buildings
3411.4.2 Complete Change of Occupancy: Where an entire building undergoes a change of

1.At least one accessible building entrance. (COMPLIES)


2. At least one accessible route from an accessible building entrance to primary function areas.

(COMPLIES)

occupancy, it shall comply with Section 3411.4.1 and shall have all of the following accessible

3. Signage complying with Section 1111. (COMPLIES) 4. Accessible parking, where parking is being provided.

5. At least one accessible passenger loading zone, when loading zones are provided. 6. At least one accessible route connecting accessible parking and accessible passenger loading zones to an accessible entrance. (COMPLIES)

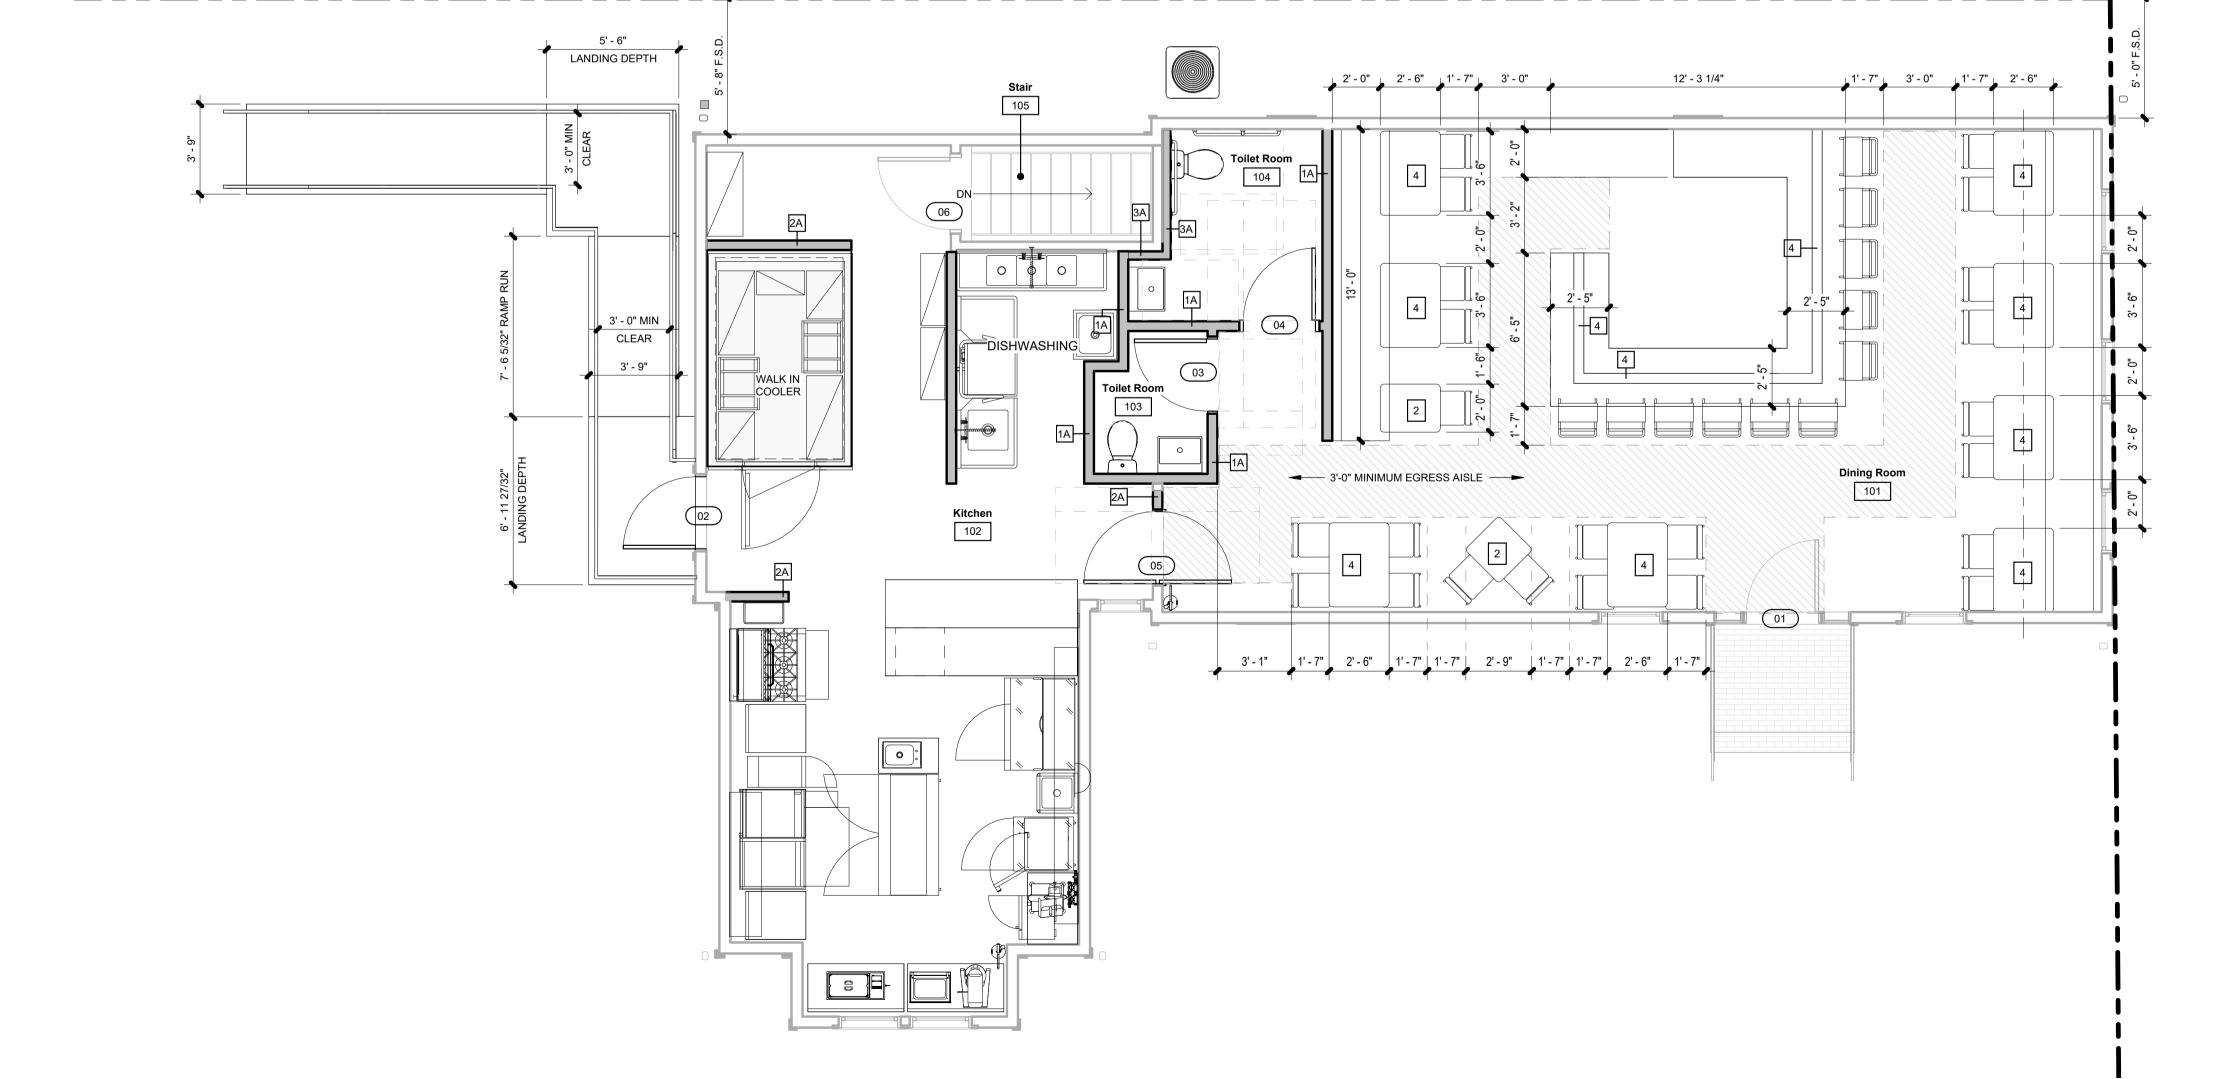

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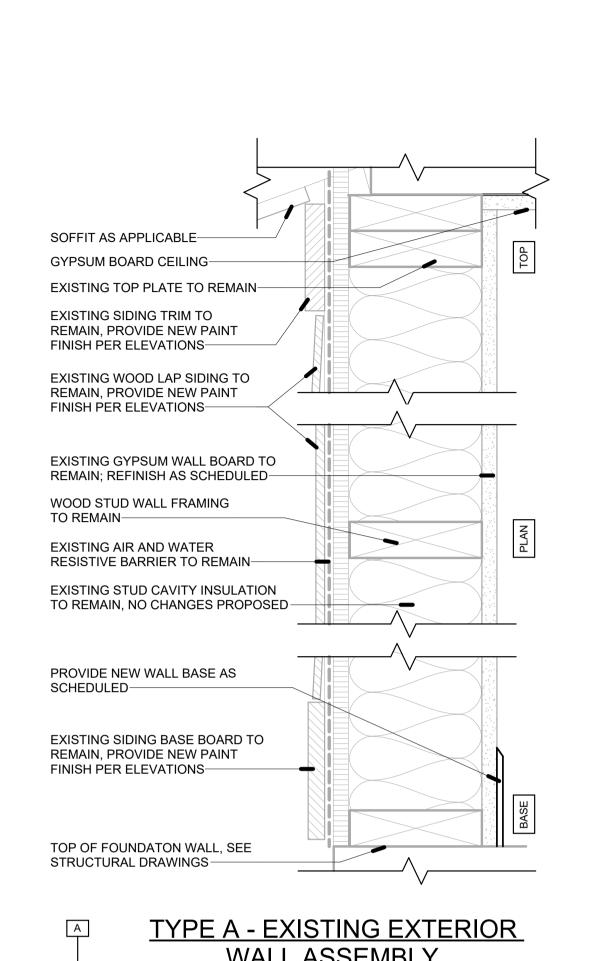
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TYPE B - 1-HOUR FIRE RESISTANCE RATED EXTERIOR WALL ASSEMBLY

PROVIDE 2X FIRE BLOCKING AT NEW GYPSUM

BOARD SPACED 16" O.C. MAXIMUM-

NEW ENGINEERED WOOD SOFFIT PANEL-

PROVIDE NEW ENGINEERED WOOD SIDING

PROVIDE NEW ENGINEERED WOOD LAP

PROFILE TO MATCH PROFILE OF EXISTING

5/8" TYPE X GLASS MAT GYPSUM SHEATING-

FLOOR UP TO UNDERSIDE OF ROOF DECK-

TRIM TO MATCH PROFILE OF EXISTING TRIM—

SIDING SYSTEM WITH PAINTED FINISH; SIDING

EXISTING GYPSUM BOARD / PLASTER TO REMAIN-

5/8" TYPE GYPSUM WALL BOARD FROM FINISHED

PROVIDE AIR AND WATER RESISTIVE BARRIER SYSTEM AT FULL EXTENT OF NEW SIDING

EXISTING STUD CAVITY INSULATION TO REMAIN,

PROVIDE NEW WALL BASE AS SCHEDULED -

TO MATCH PROFILE OF EXISTING TRIM-

PROVIDE NEW ENGINEERED WOOD SIDING TRIM

NO CHANGES PROPOSED-

CONTINUOUS SEALANT-

SHEET METAL PAN FLASHING-

TOP OF EXISTING FOUNDATON WALL

WOOD STUD WALL FRAMING AT 16" O.C. TO REMAIN-

EXISTING ROOF TO REMAIN-

5/8" TYPE X GLASS MAT

GYPSUM SHEATING ON

EXISTING 2X FRAMING

AT EXISTING ROOF PROJECTION———

NEW GUTTERS AND ROOF FLASHING——

GYPSUM BOARD CEILING-

LAP SIDING-

EXISTING TOP PLATE TO REMAIN-

WALL AND PARTITION NOTES

1. ALL SEAMS BETWEEN THE LAYERS OF GYPSUM BOARD IN MULTI-LAYER PARTITIONS SHOULD BE STAGGERED AND TAPED. THE ENTIRE PERIMETER OF THE OUTER LAYER OF GYPSUM BOARD SHOULD BE SEALED AIRTIGHT WITH RESILIENT SEALANT.

2. AT PARTITIONS INDICATED TO HAVE ACOUSTIC DESIGNS, CONTRACTOR TO SEPARATE ELECTRICAL ROUGH-IN BOXES BY 24" MINIMUM, SEAL ALL BOX OPENINGS WITH 1/8" THICK MINIMUM CLAY PACKING MATERIAL, AND CAULK ALL JOINTS BETWEEN THE ELECTRICAL ROUGH-IN BOXES AND THE GYPSUM BOARD. SEE ACOUSTIC DETAILS ON SHEET A-7.0

3. PROVIDE PAINTABLE RESILIENT SEALANT AT ALL PENETRATIONS IN PARTITIONS, SEE ACOUSTIC DETAILS ON SHEET A-7.0

4. GYPSUM WALL BOARD INSTALLED AS PART OF PARTITIONS WITH LINEAR PLAN GEOMETRY TO BE 5/8" THICK UNLESS NOTED OTHERWISE


5. WHERE WALL TILE IS INSTALLED FRAMED PARTITIONS, PROVIDE STUD SPACING AT NO GREATER THAN 16" ON CENTER AND PROVIDE FRAMING DESIGNED TO PROVIDE LATERAL DEFELECTION OF NO MORE THAN L/360 WHEN STUDS ARE INSTALLED BETWEEN FLOOR AND DECK ABOVE

6. FOR PARTITIONS SUPPORTING WALL MOUNTED CASEWORK, A/V DISPLAY SCREENS, OR SIMILAR ITEMS, PROVIDE IN-WALL BLOCKING AT MOUNTING HEIGHTS SHOWN ON DRAWINGS. IF MOUNTING HEIGHTS ARE NOT NOTED, SUBMIT R.F.I. TO OWNER AND ARCHITECT


7. GENERAL CONTRACTOR TO COORDINATE STUD DEPTHS BETWEEN TRADES TO ENSURE ALL CONDUITS, PIPES, DRAIN LINES, CABLES, AND SIMILAR ITEMS ARE CONCEALED WITHIN OR BEHIND STUD CAVITIES IN SPACES BELOW FINISHED CEILINGS UNLESS OTHER DRAWINGS SPECIFICALLY INDICATE THAT ABOVE REFERENCED ITEMS ARE INTENDED TO BE EXPOSED TO VIEW. IF CONDUITS, PIPES, DRAIN LINES, CABLES, OR SIMILAR ITEMS DO NOT FIT WITHIN MINIMUM STUD SIZES INDICATED ON PARTITION TYPE DETAILS, CONTRACTOR TO PROVIDE WIDER STUD CAVITY AS REQUIRED.

WALL TYPES - EXTERIOR

SCALE: 3" = 1'-0"

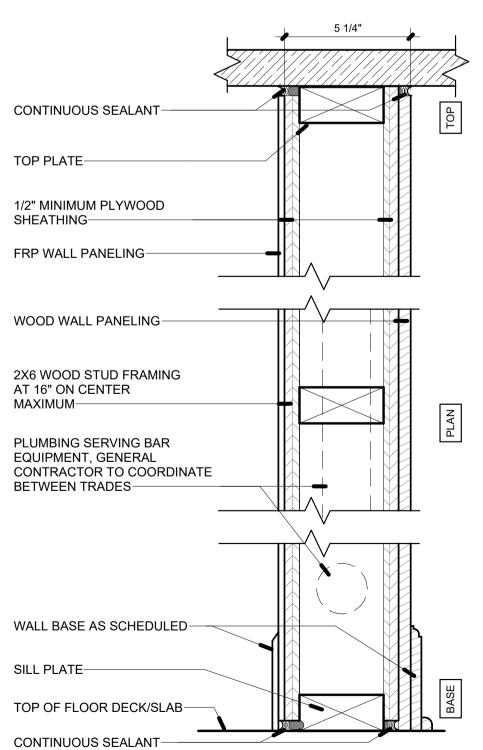

TYPE 4 - BAR DIE WALL

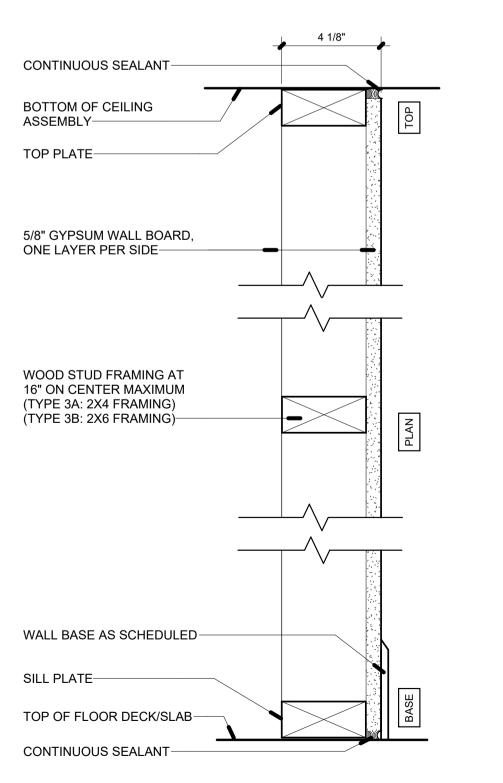

BOTTOM OF CEILING
ASSEMBLY

TOP PLATE

5/8" GYPSUM WALL BOARD,
ONE LAYER PER SIDE

WOOD STUD FRAMING AT
16" ON CENTER MAXIMUM
(TYPE 2A: 2X4 FRAMING)
(TYPE 2B: 2X6 FRAMING)

WALL BASE AS SCHEDULED

SILL PLATE

TOP OF FLOOR DECK/SLAB

CONTINUOUS SEALANT

CONTINUOUS SEALANT

TYPE B: 6 3/4"

BOTTOM OF CEILING
ASSEMBLY

TOP PLATE

5/8" TYPE GYPSUM WALL
BOARD, LAYERS AS SHOWN

WOOD STUD FRAMING AT
16" ON CENTER MAXIMUM
(TYPE 2A: 2X4 FRAMING)
(TYPE 2B: 2X6 FRAMING)

WALL BASE AS SCHEDULED

SILL PLATE

TOP OF FLOOR DECK/SLAB

CONTINUOUS SEALANT-

TYPE A: 4 3/4"

TYPE B: 6 3/4"

TYPE 3 - SINGLE SIDED PARTITION

TYPE 2 - BALANCED PARTITION

TYPE 1 - ACOUSTIC PARTITION

CONTINUOUS SEALANT—

WALL TYPES - INTERIOR

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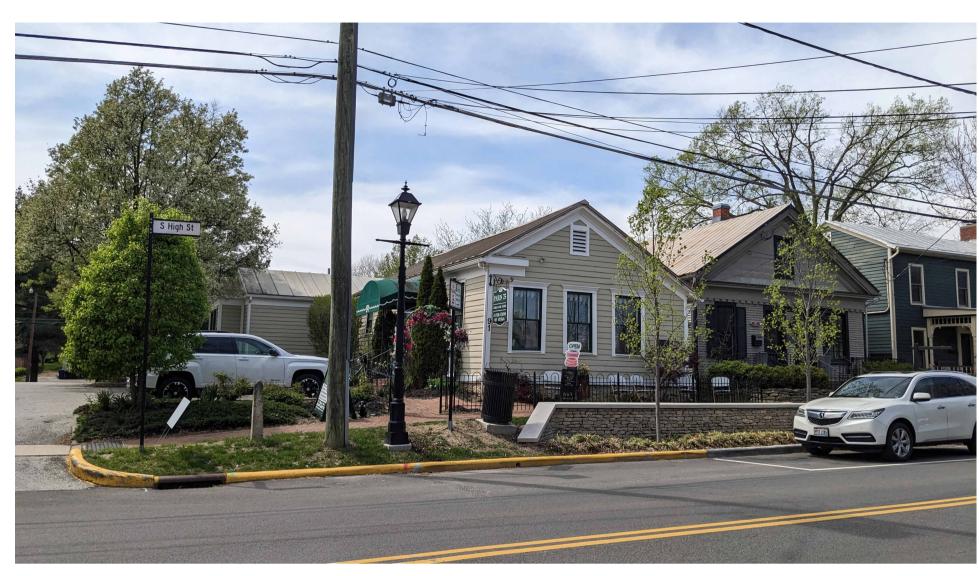
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A-0.3





LOOKING WEST FROM EAST SIDEWALK ON S. HIGH STREET TOWARD EAST BUILDING FACADE



LOOKING SOUTHWEST FROM WEST SIDEWALK ON S. HIGH STREET TOWARD NORTH AND EAST BUILDING FACADES




LOOKING NORTH WEST FROM PINNEY HILL LANE TOWARD SOUTH AND EAST BUILDING FACADES; METAL AND FABRIC AWNING PICTURED TO BE REMOVED LOOKING NORTH EAST FROM PINNEY HILL LANE TOWARD SOUTH AND WEST BUILDING FACADES AND EXISTING PATIO





LOOKING NORTH FROM PINNEY HILL LANE TOWARD SOUTH BUILDING FACADE AND EXISTING PATIO

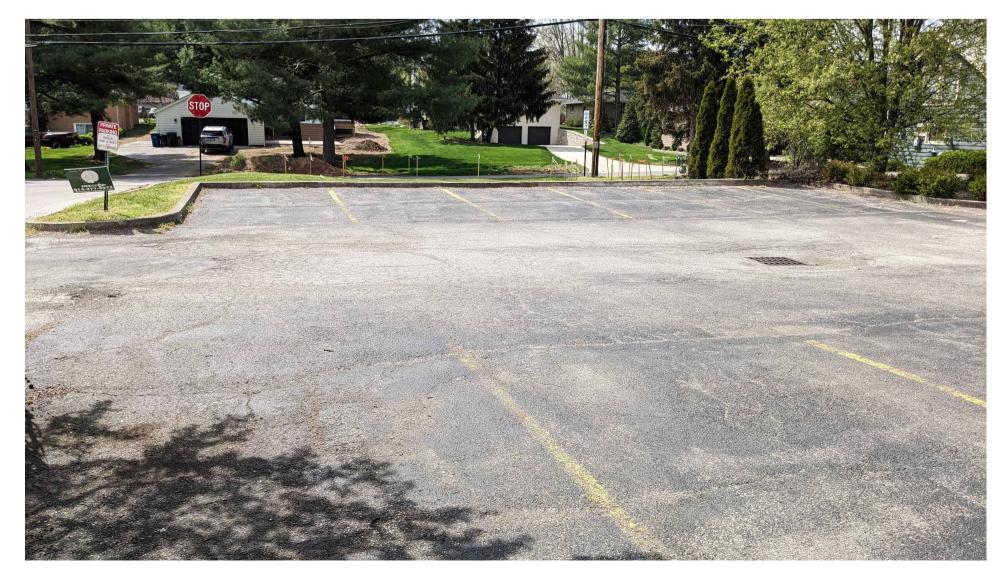

LOOKING WEST EXISTING SIDEWALK AT WEST BUILDING FACADE TOWARD EXISTING PARKING LOT AND MILL LANE BEYOND



LOOKING EAST FROM EXISITNG PARKING LOT TOWARD NORTH BUILDING FACADE



LOOKING EAST FROM EXISTING PARKING LOT TOWARD WEST BUILDING FACADE, EXISTING RAMP, AND EXISTING SURFACE PARKING LOT


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OT FOR CONSTRUCTION

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A-1.1

GENERAL PLAN NOTES

1. ALL ELEMENTS OF CONSTRUCTION ARE TO BE NEW UNLESS NOTED OTHERWISE

2. FINISH NOTES:

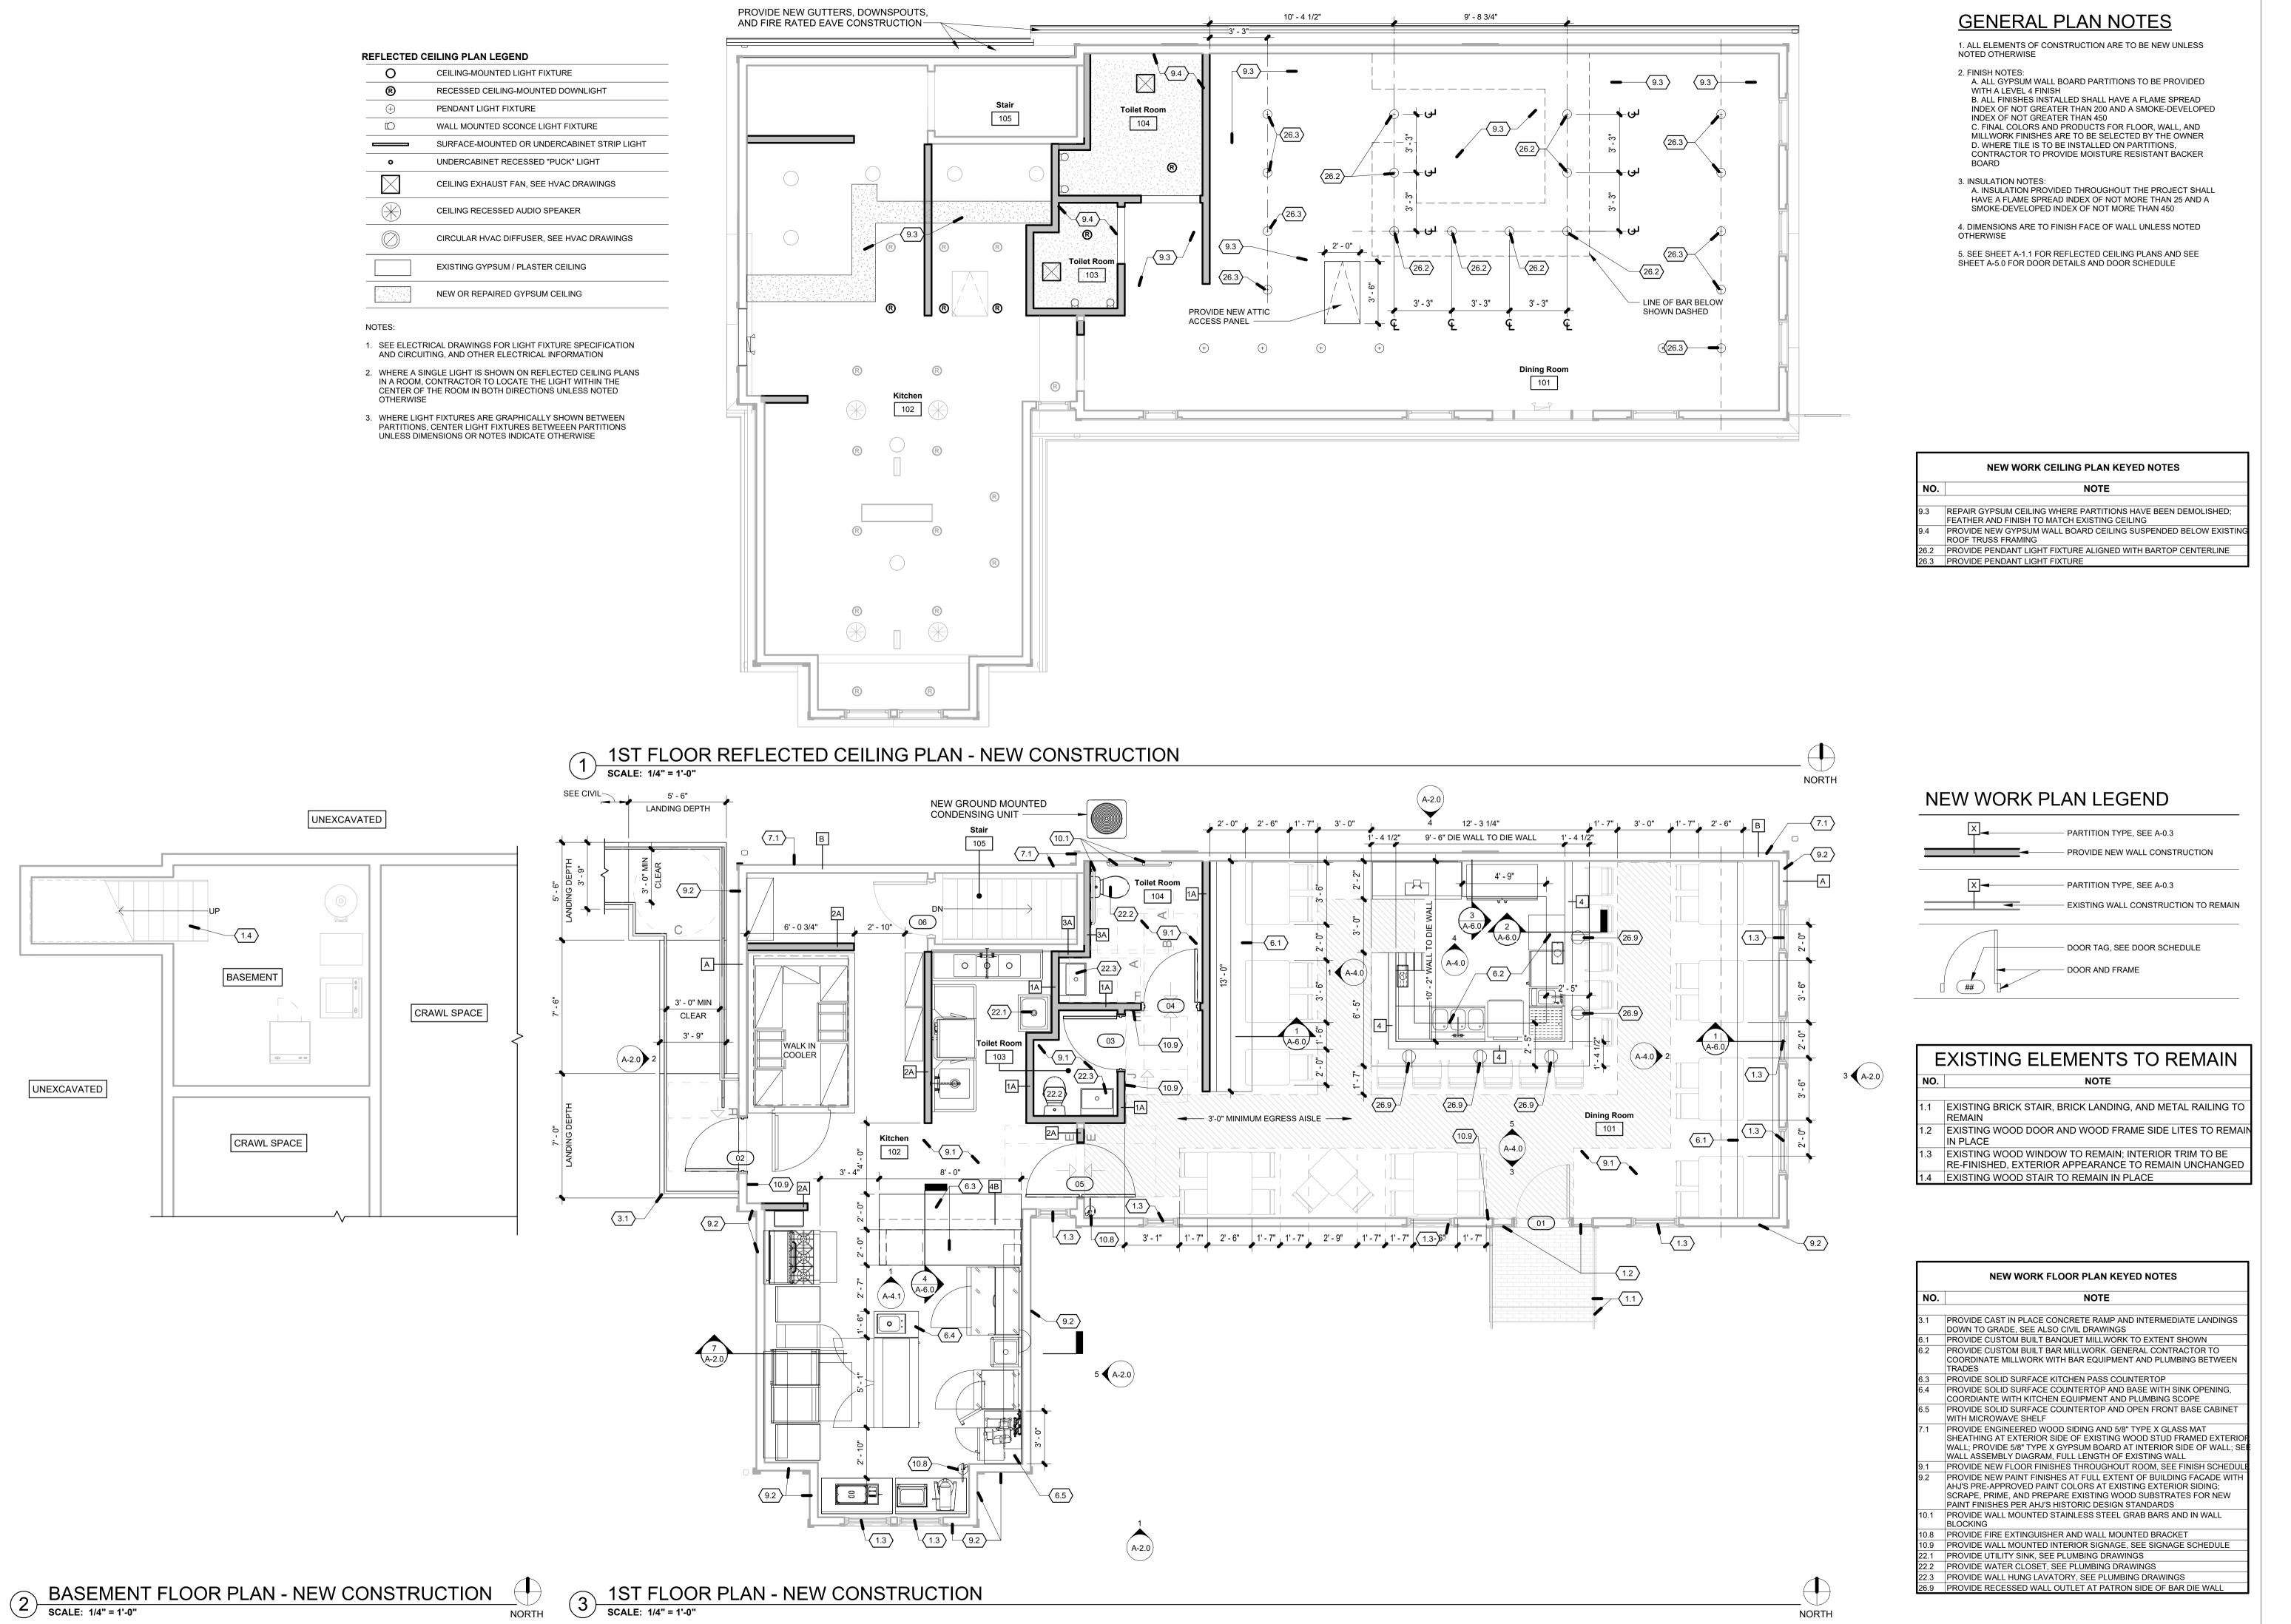
NORTH

A. ALL GYPSUM WALL BOARD PARTITIONS TO BE PROVIDED WITH A LEVEL 4 FINISH
B. ALL FINISHES INSTALLED SHALL HAVE A FLAME SPREAD INDEX OF NOT GREATER THAN 200 AND A SMOKE-DEVELOPED INDEX OF NOT GREATER THAN 450
C. FINAL COLORS AND PRODUCTS FOR FLOOR, WALL, AND MILLWORK FINISHES ARE TO BE SELECTED BY THE OWNER D. WHERE TILE IS TO BE INSTALLED ON PARTITIONS, CONTRACTOR TO PROVIDE MOISTURE RESISTANT BACKER

3. INSULATION NOTES:
A. INSULATION PROVIDED THROUGHOUT THE PROJECT SHALL
HAVE A FLAME SPREAD INDEX OF NOT MORE THAN 25 AND A
SMOKE-DEVELOPED INDEX OF NOT MORE THAN 450

4. DIMENSIONS ARE TO FINISH FACE OF WALL UNLESS NOTED

5. SEE SHEET A-1.1 FOR REFLECTED CEILING PLANS AND SEE SHEET A-5.0 FOR DOOR DETAILS AND DOOR SCHEDULE

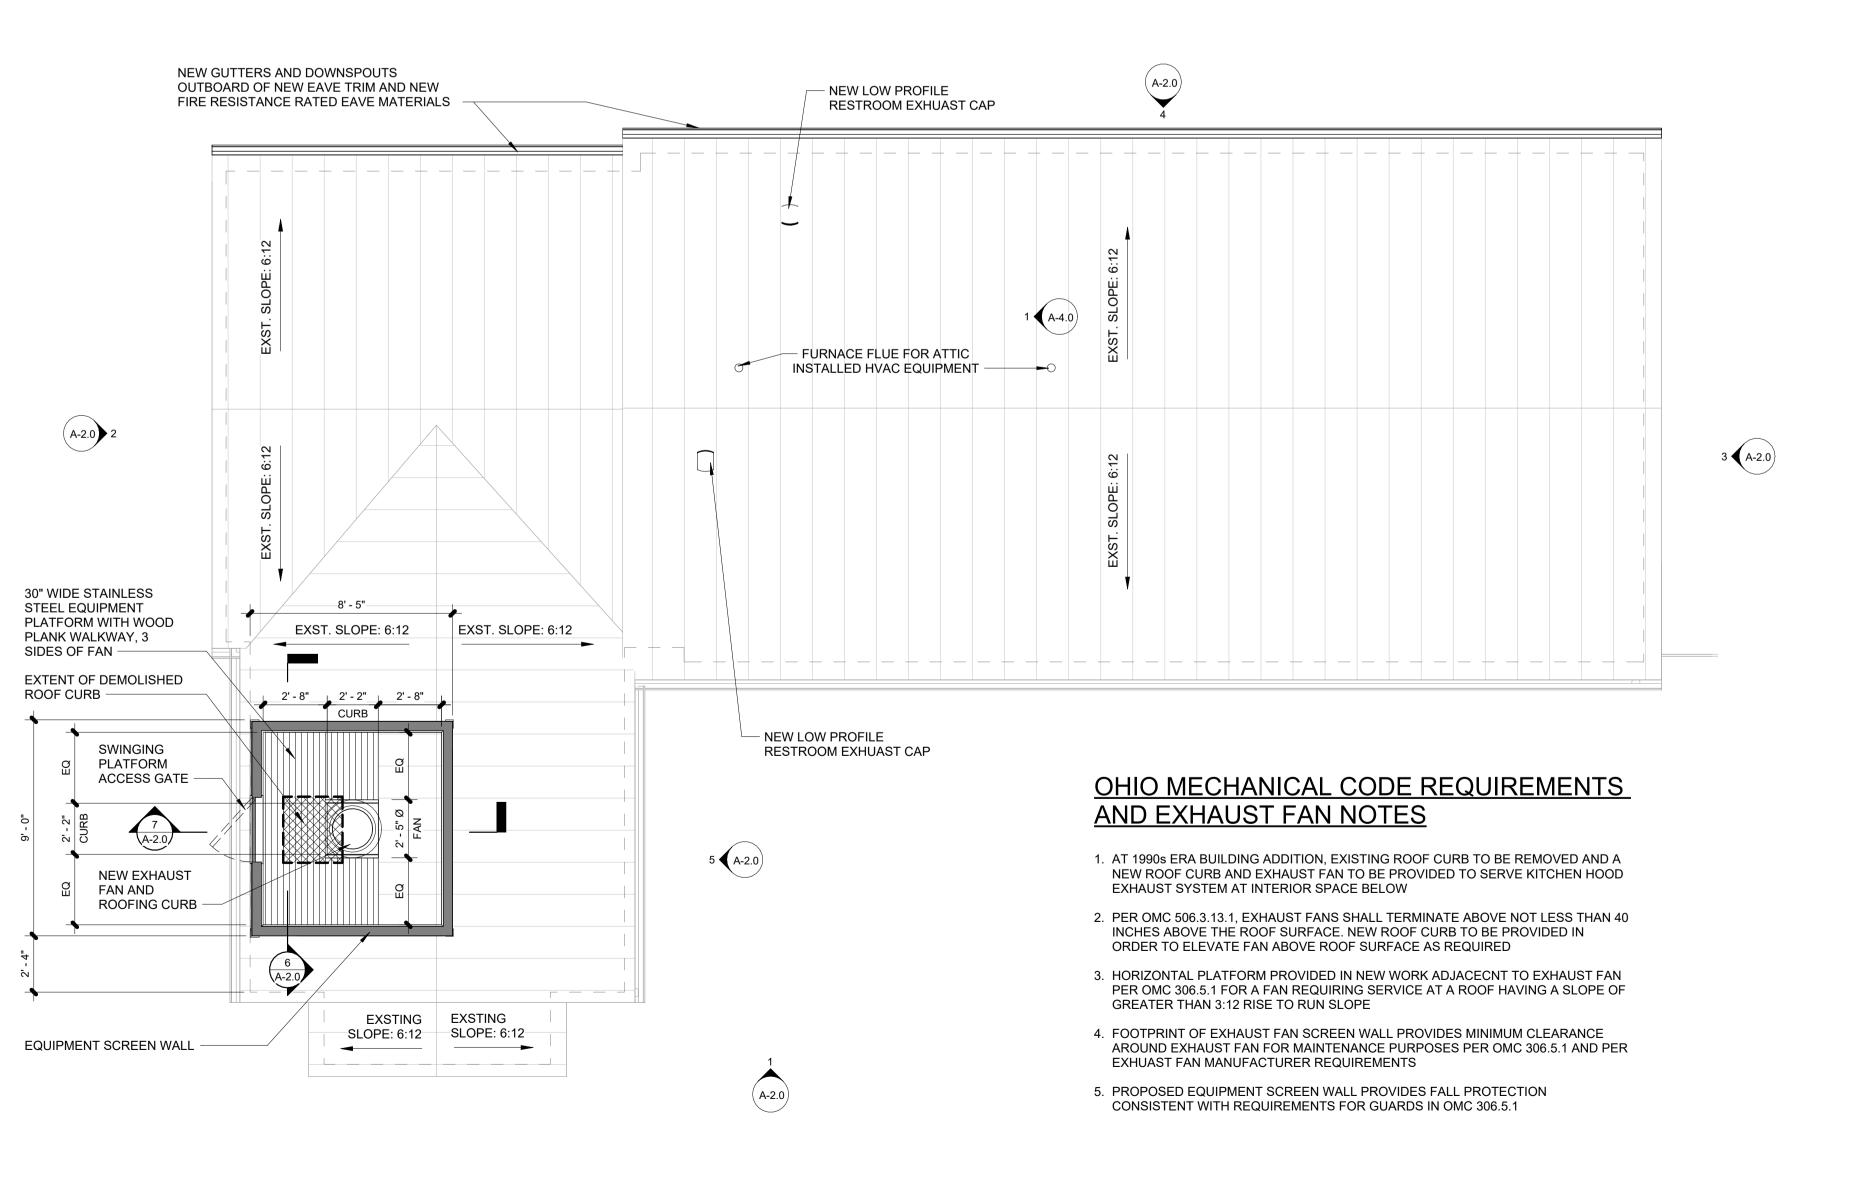

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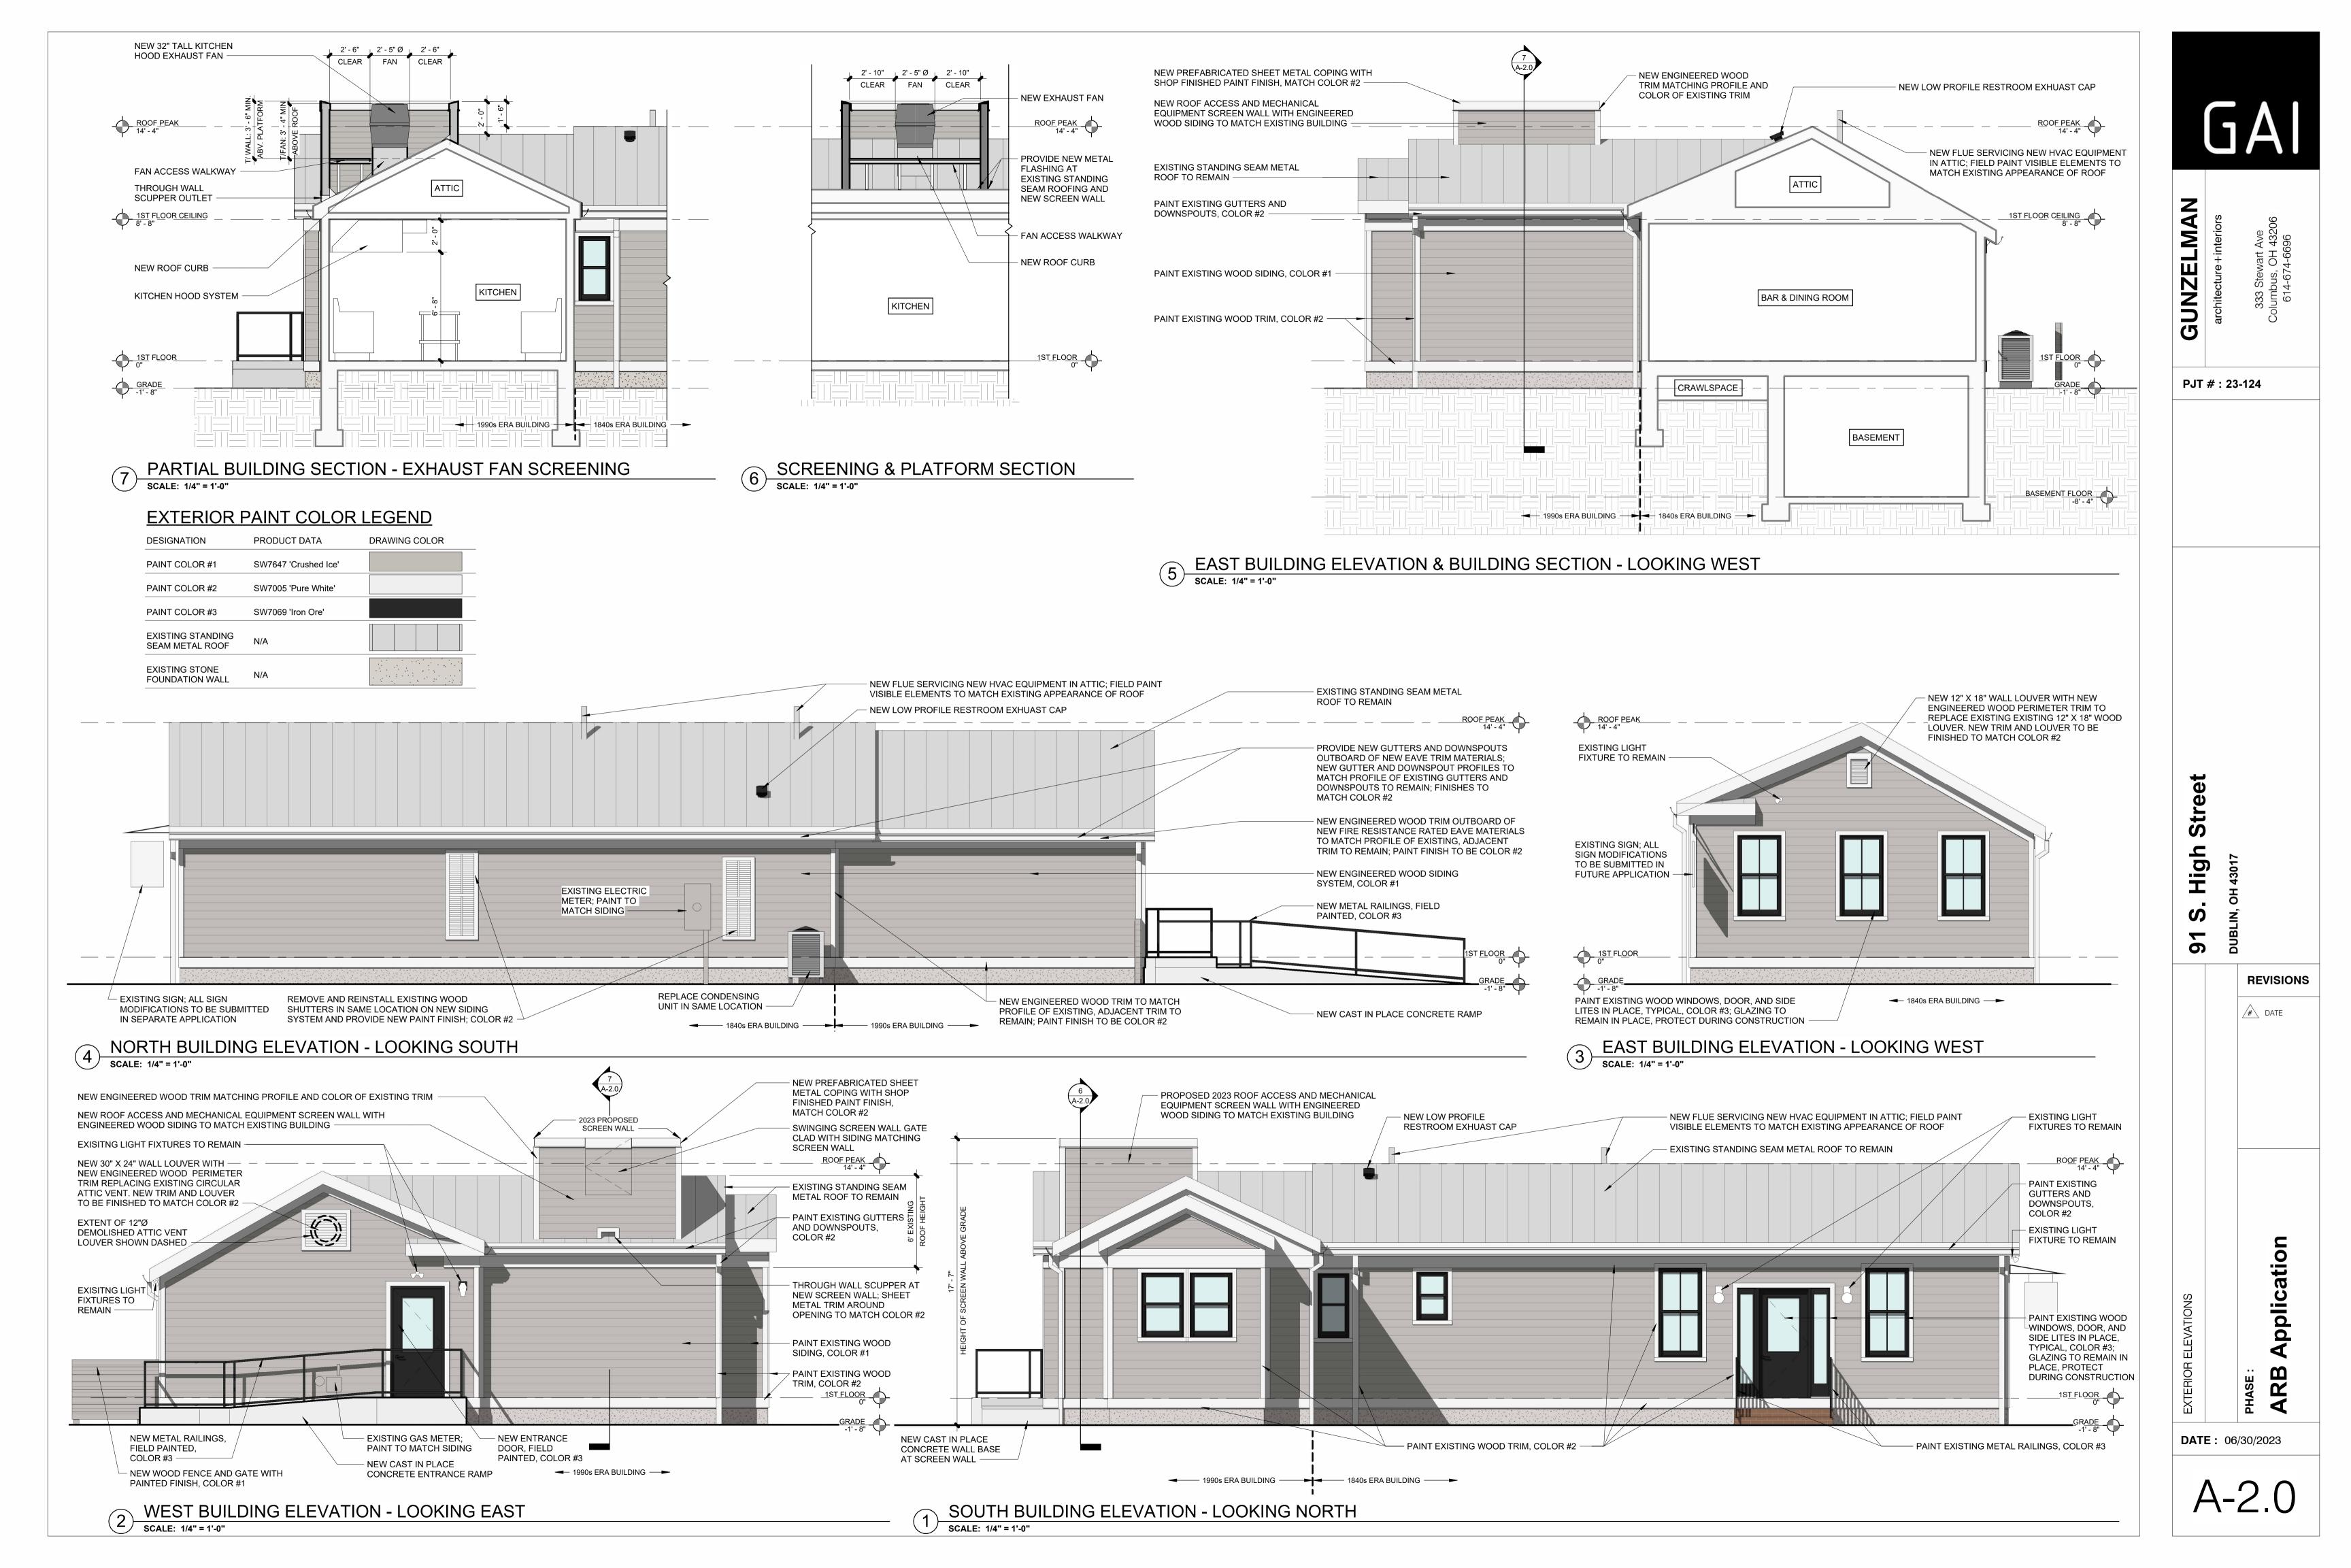
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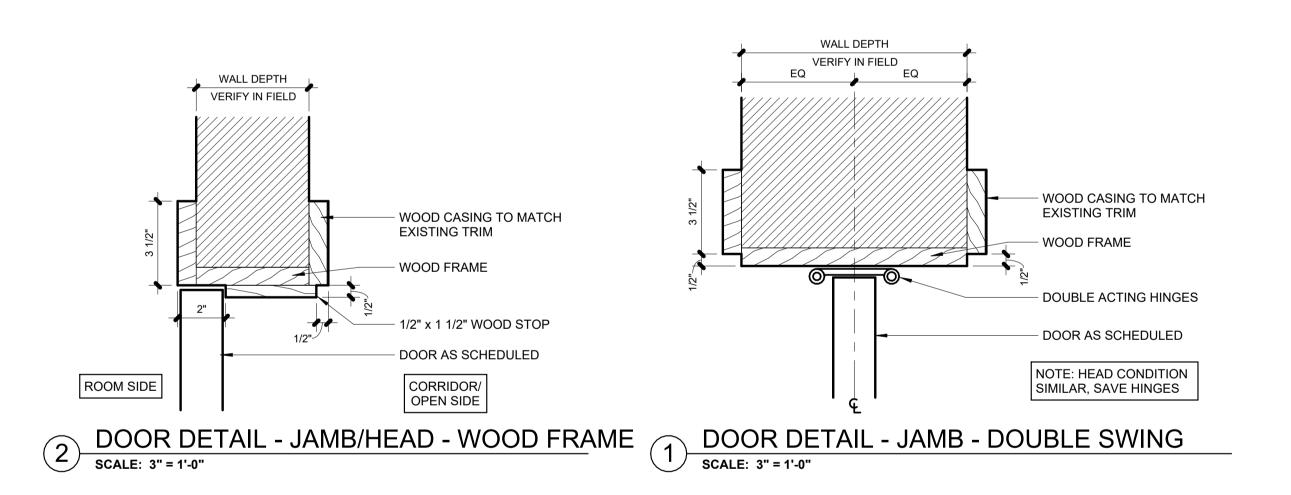
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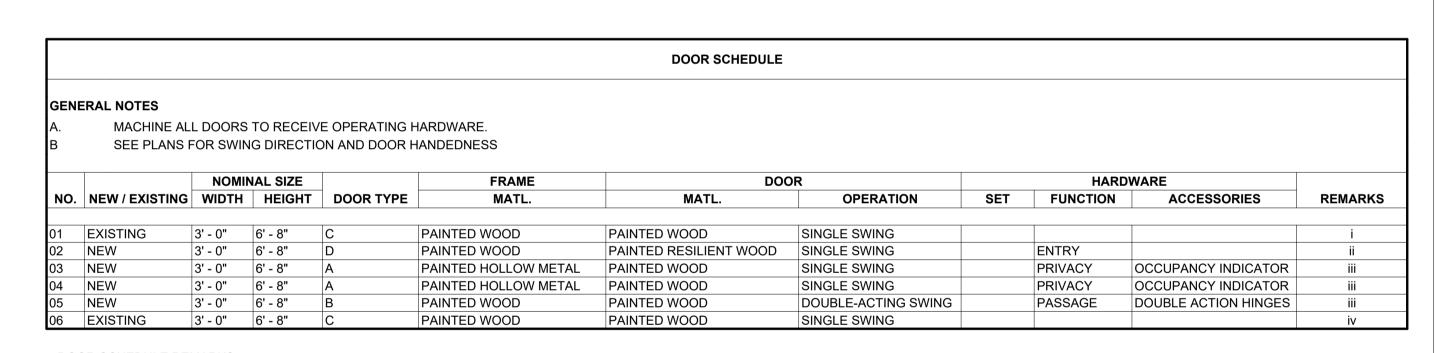
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SCALE: 1/2" = 1'-0"




DOOR SCHEDULE REMARKS:

i. EXISTING EXTERIOR DOOR TO REMAIN IN PLACE

ii. NEW EXTERIOR DOOR REPLACING DEMOLISHED DOOR AT EXISTING EXTERIOR WALL OPENING

iii. NEW INTERIOR DOOR AT NEW LOCATION

iv. EXISTING INTERIOR DOOR TO REMAIN IN PLACE

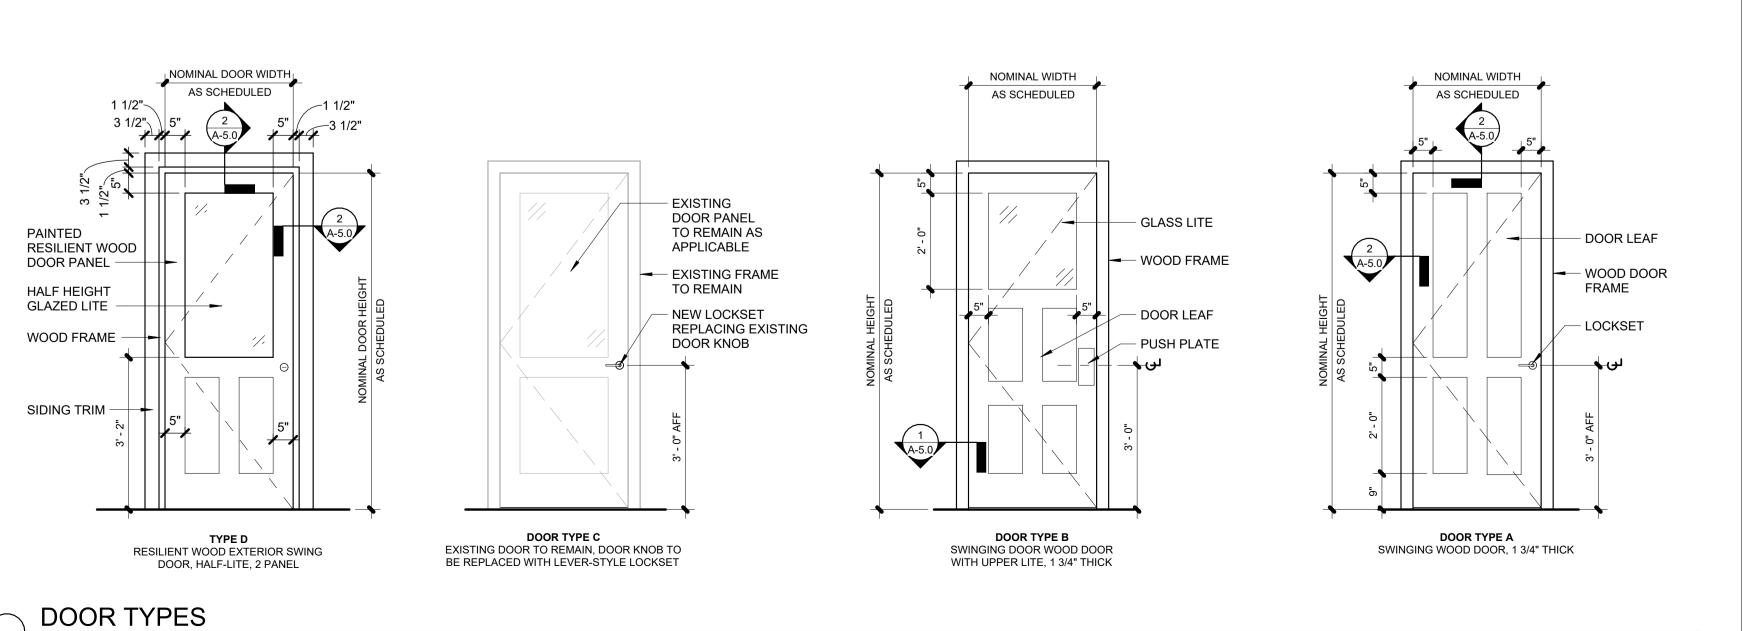

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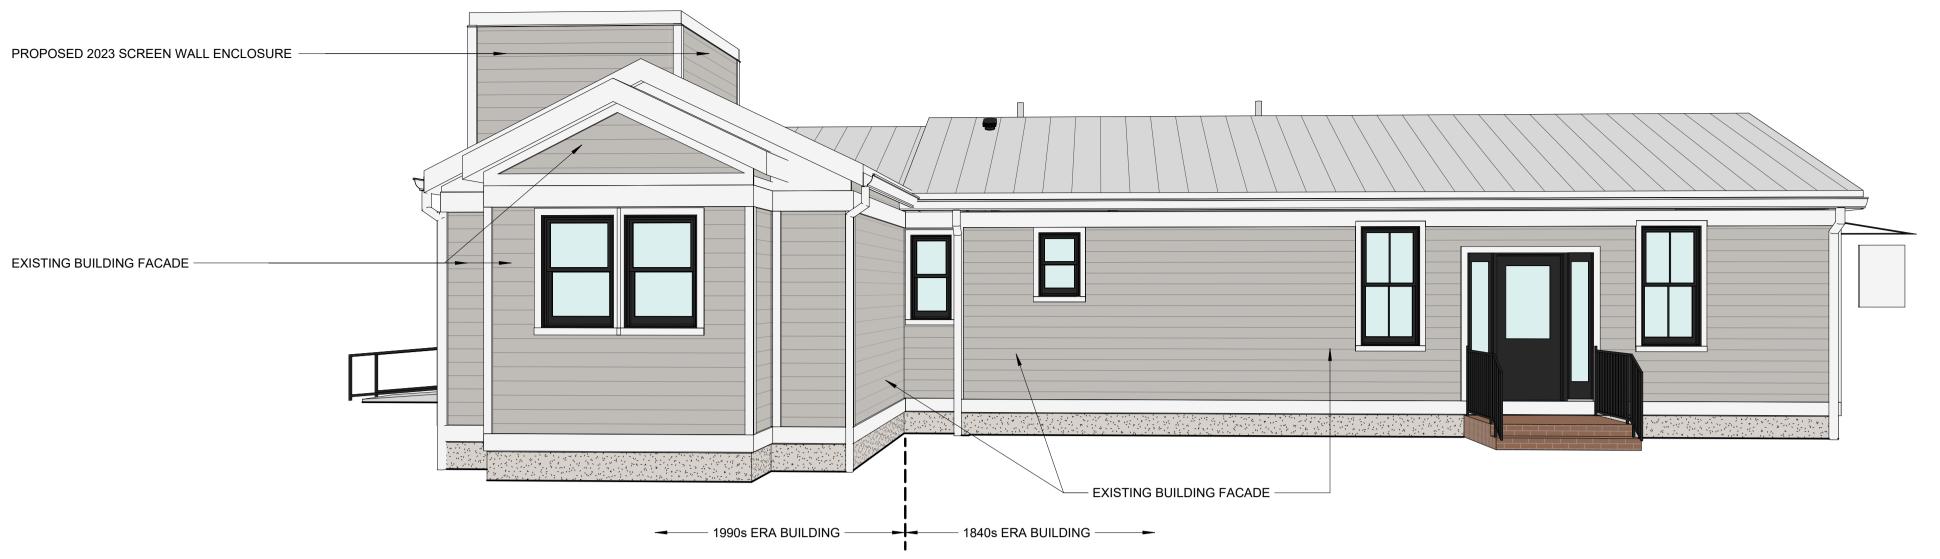
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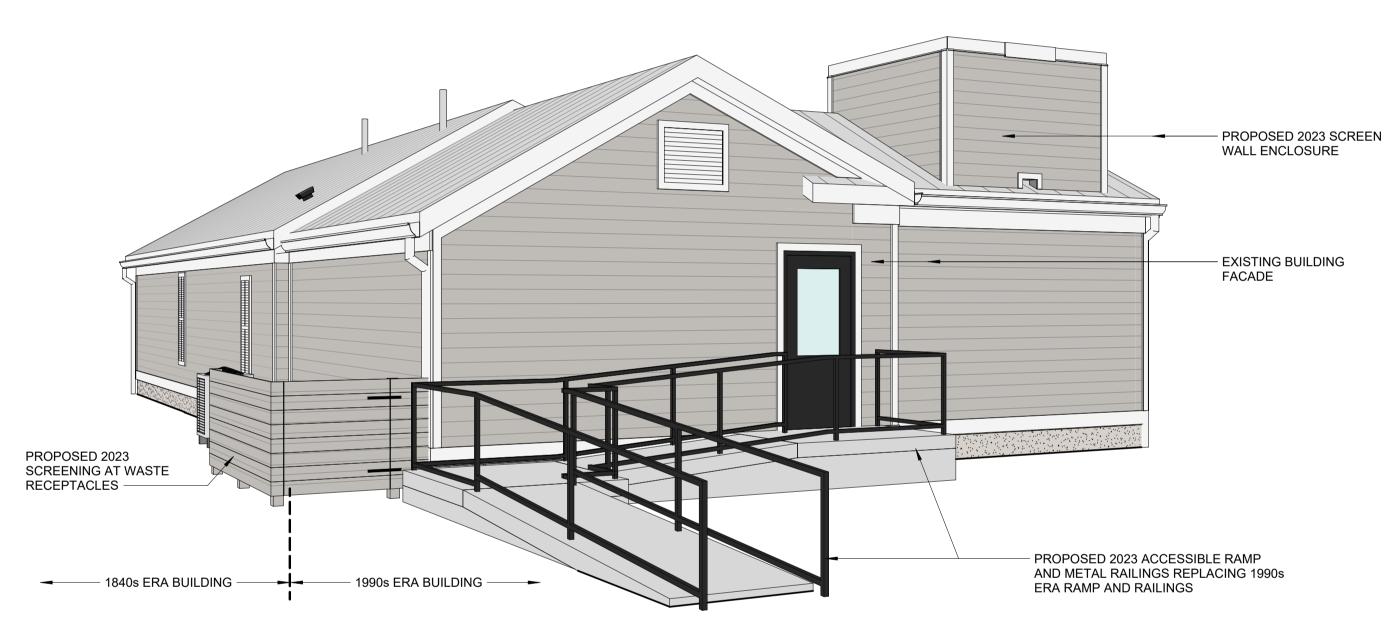
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EXTERIOR PAINT COLOR LEGEND


DESIGNATION	PRODUCT DATA	DRAWING COLOR
PAINT COLOR #1	SW7647 'Crushed Ice'	
PAINT COLOR #2	SW7005 'Pure White'	
PAINT COLOR #3	SW7069 'Iron Ore'	
EXISTING STANDING SEAM METAL ROOF	N/A	
EXISTING STONE FOUNDATION WALL	N/A	




PERSPECTIVE VIEW LOOKING NORTH AT SOUTH FACADE OF PROPERTY SCALE:



3 LOOKING EAST FROM REAR OF PROPERTY TOWARD NEW RAMP AND SCREEN WALL SCALE:

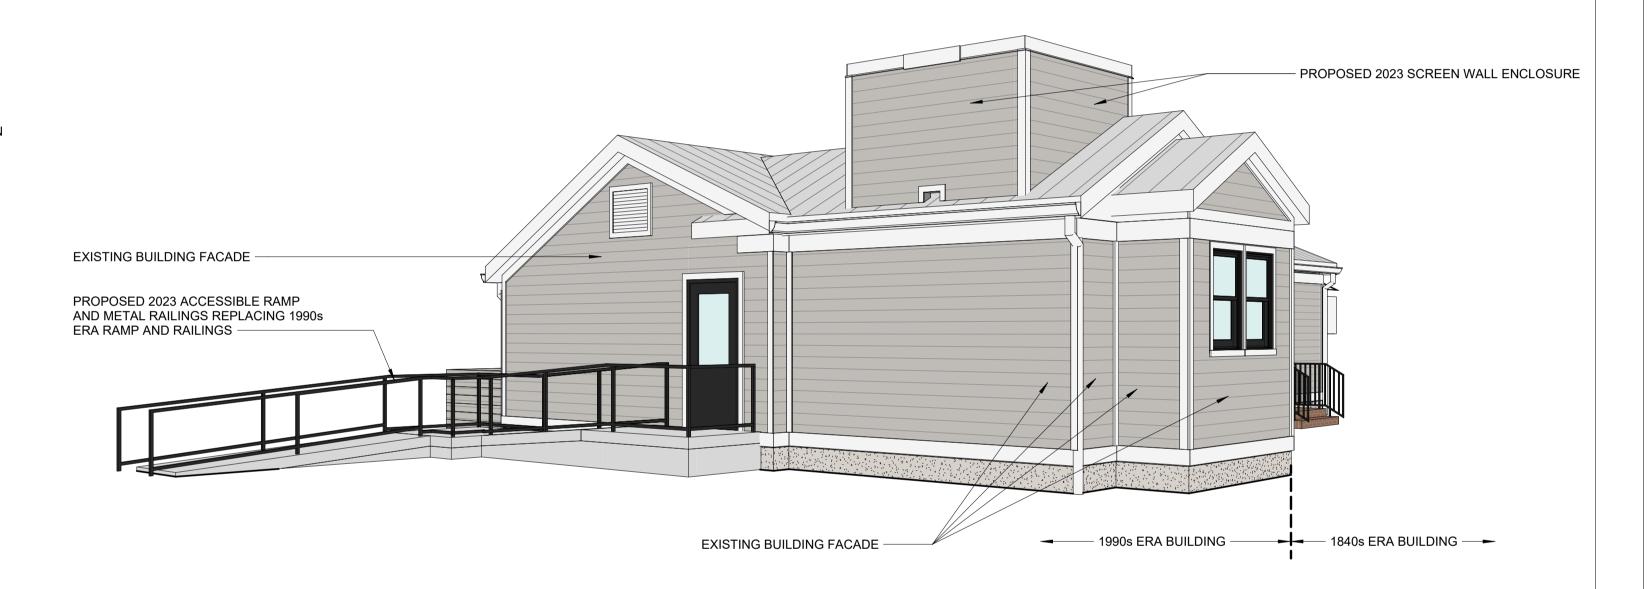

PERSPECTIVE VIEW LOOKING EAST FROM REAR PORTION OF PROPERTY TOWARD RAMP AND SCREEN WALL scale:

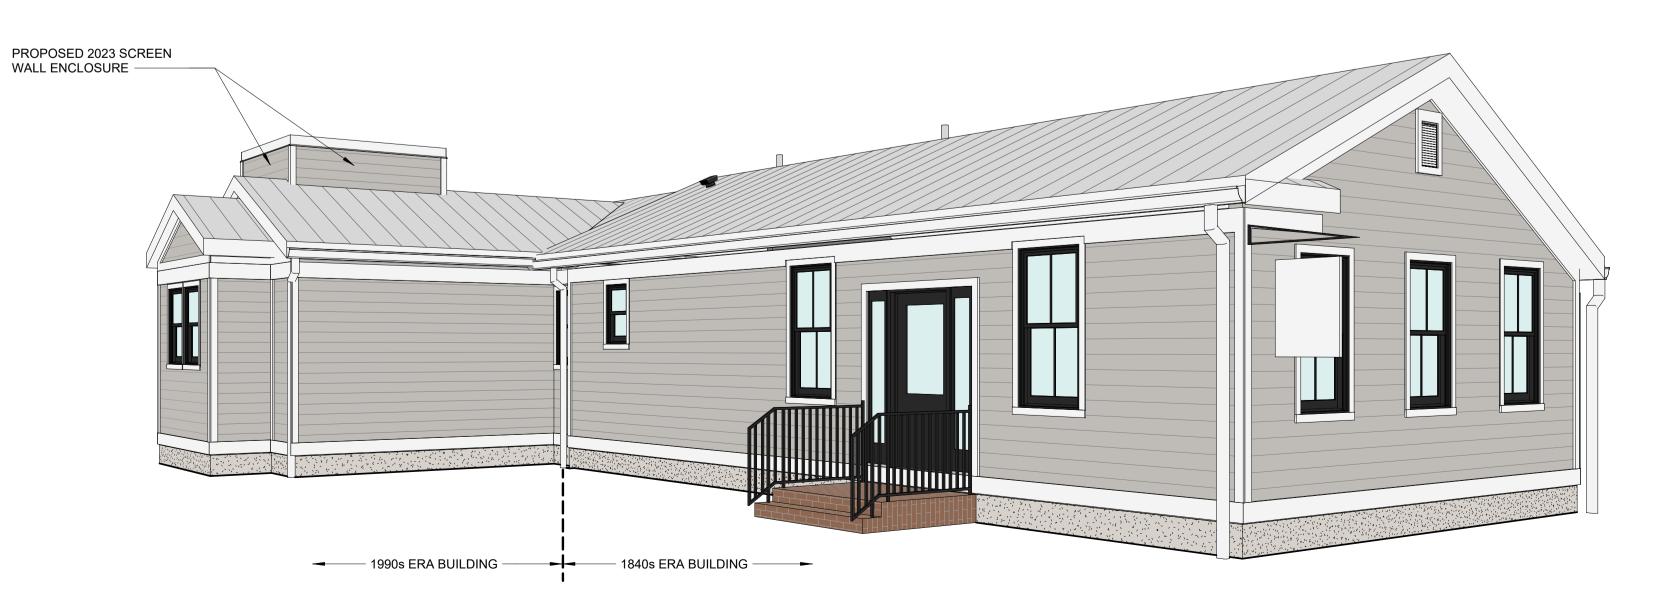

PERSPECTIVE VIEW LOOKING WEST FROM S.W. CORNER OF PROPERTY SCALE:

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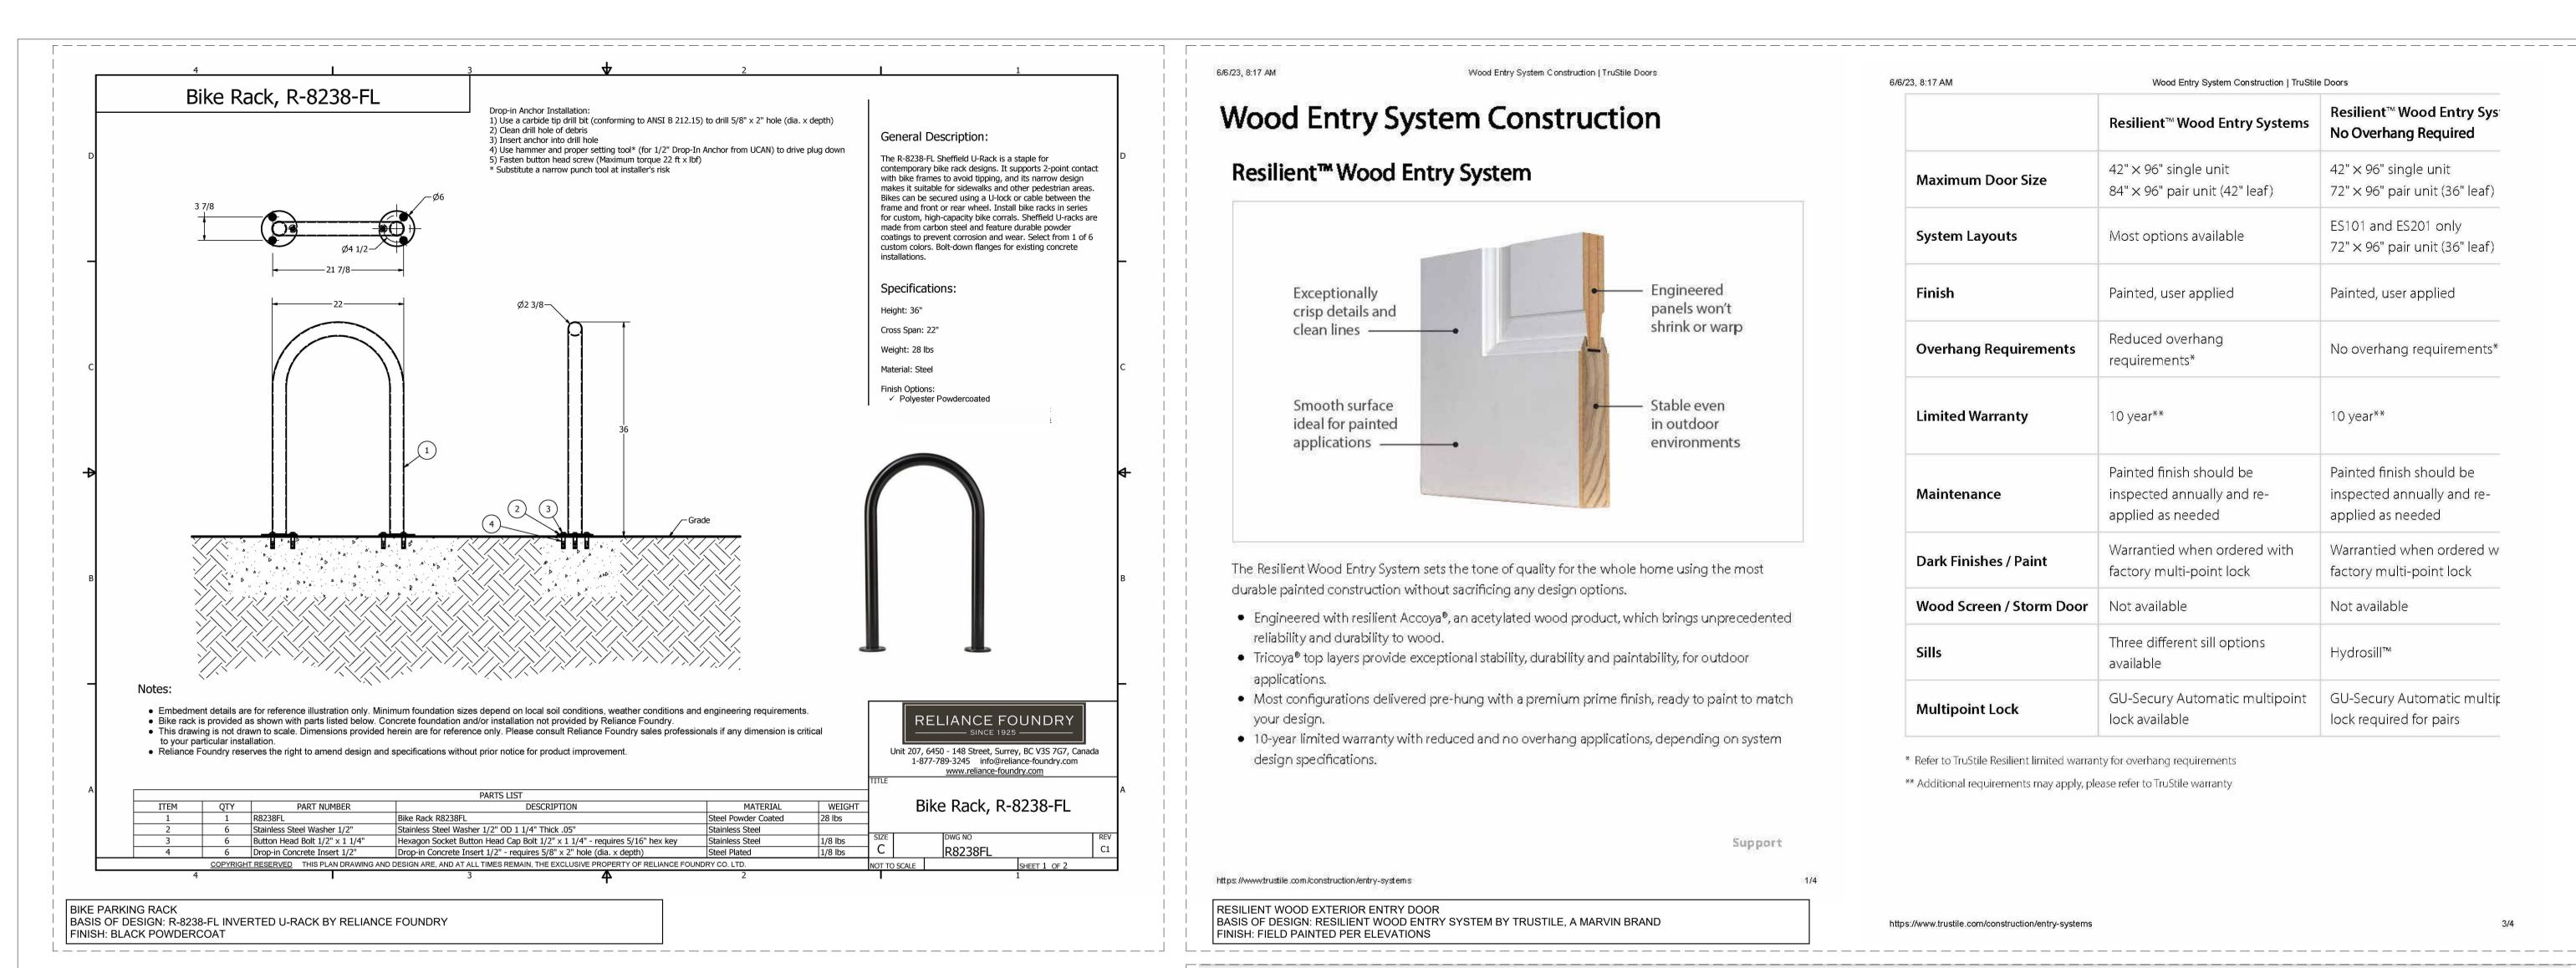
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6/6/23, 8:17 AM Wood Entry System Construction | TruStile Doors

Wood Entry System Construction

Resilient™ Wood Entry System



The Resilient Wood Entry System sets the tone of quality for the whole home using the most durable painted construction without sacrificing any design options.

- Engineered with resilient Accoya®, an acetylated wood product, which brings unprecedented reliability and durability to wood.
- Tricoya® top layers provide exceptional stability, durability and paintability, for outdoor
- Most configurations delivered pre-hung with a premium prime finish, ready to paint to match
- 10-year limited warranty with reduced and no overhang applications, depending on system design specifications.

Support

https://www.trustile.com/construction/entry-systems

RESILIENT WOOD EXTERIOR ENTRY DOOR BASIS OF DESIGN: RESILIENT WOOD ENTRY SYSTEM BY TRUSTILE, A MARVIN BRAND FINISH: FIELD PAINTED PER ELEVATIONS

Resilient™ Wood Entry Systems No Overhang Required $42" \times 96"$ single unit $42" \times 96"$ single unit **Maximum Door Size** $84" \times 96"$ pair unit (42" leaf) $72" \times 96"$ pair unit (36" leaf) ES101 and ES201 only System Layouts Most options available $72" \times 96"$ pair unit (36" leaf) Painted, user applied Painted, user applied Reduced overhang **Overhang Requirements** No overhang requirements* requirements* 10 year** **Limited Warranty** 10 year** Painted finish should be Painted finish should be Maintenance inspected annually and reinspected annually and reapplied as needed applied as needed Warrantied when ordered with Warrantied when ordered w Dark Finishes / Paint factory multi-point lock factory multi-point lock Wood Screen / Storm Door Not available Not available Three different sill options Hydrosill™ available GU-Secury Automatic multip GU-Secury Automatic multipoint **Multipoint Lock** lock available lock required for pairs

Wood Entry System Construction | TruStile Doors

Resilient™ Wood Entry Sys

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Craftsman Collection™

The TruExterior Siding Craftsman Collection™ offers a variety of authentic, full-thickness profiles with bold, defined shapes and the natural aesthetic of traditional wood siding, all without the maintenance and upkeep associated with exterior wood products.

Historically and architecturally accurate profiles—Channel, Channel Bevel, Cove/Dutch Lap, Nickel Gap, Shiplap and V-Rustic - are the ideal solution for homeowners who desire the look, feel and character of authentic wood siding while avoiding rotting, excessive swelling and termite attacks.



BASIS OF DESIGN: TRU-EXTERIOR SIDING CRAFTSMAN COLLECTION, SMOOTH FINISH, CHANNEL PROFILE NICKEL GAP PROFILE, 1X8 SIZE

FINISH: FIELD PAINTED AS INDICATED ON ELEVATIONS

REVERSIBLE SHIPLAP-NICKEL GAP

TruExterior Siding & Trim's Reversible Shiplap/Nickel Gap siding panels offer two authentic, on-trend looks in one for increased versatility and convenience. The profile comes in two formats: one features smooth Nickel Gap on one side and woodgrain Shiplap on the other; the second combines woodgrain Nickel Gap with smooth Shiplap on the flip side. A rabbeted edge ensures panels install with authentic spacing depending on which side is installed—the tight joint appearance of Shiplap or the nickel-sized space of Nickel Gap. Four widths are available for 16 total profile combinations.

Finish Options:

 Smooth Nickel Gap with Woodgrain Shiplap Woodgrain Nickel Gap with Smooth Shiplap







NICKEL GAP SIDE					
Actual Actual Reveal (C) Gap (D)					
11/16" 3-1/2" 3-3/32" 5/64"					
11/16" 5-1/2" 5-3/32" 5/64"					
11/16" 7-1/4" 6-13/16" 5/64"					
9-1/4" 8-13/16" 5/64"					

^{*} Refer to TruStile Resilient limited warranty for overhang requirements

^{**} Additional requirements may apply, please refer to TruStile warranty

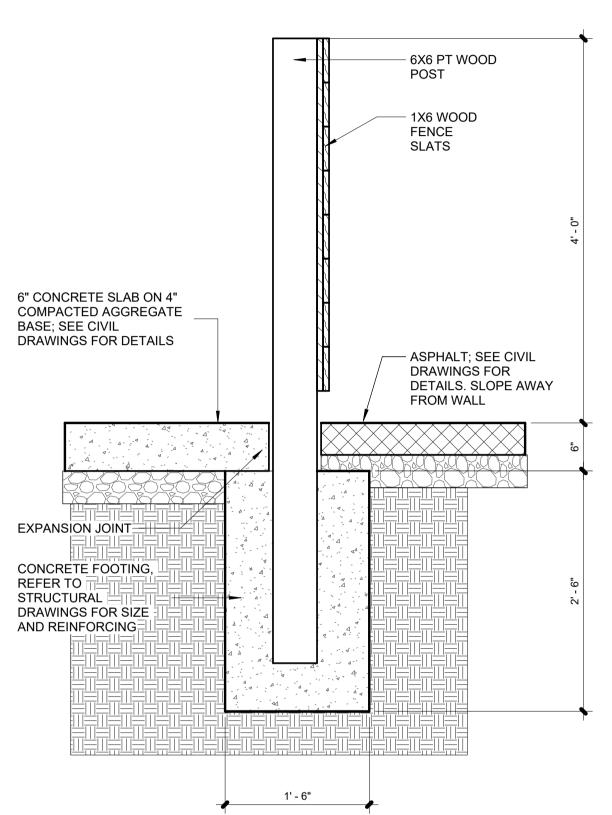

5 TYPICAL TRASH ENCLOSURE SECTION DETAIL
SCALE: 1" = 1'-0"

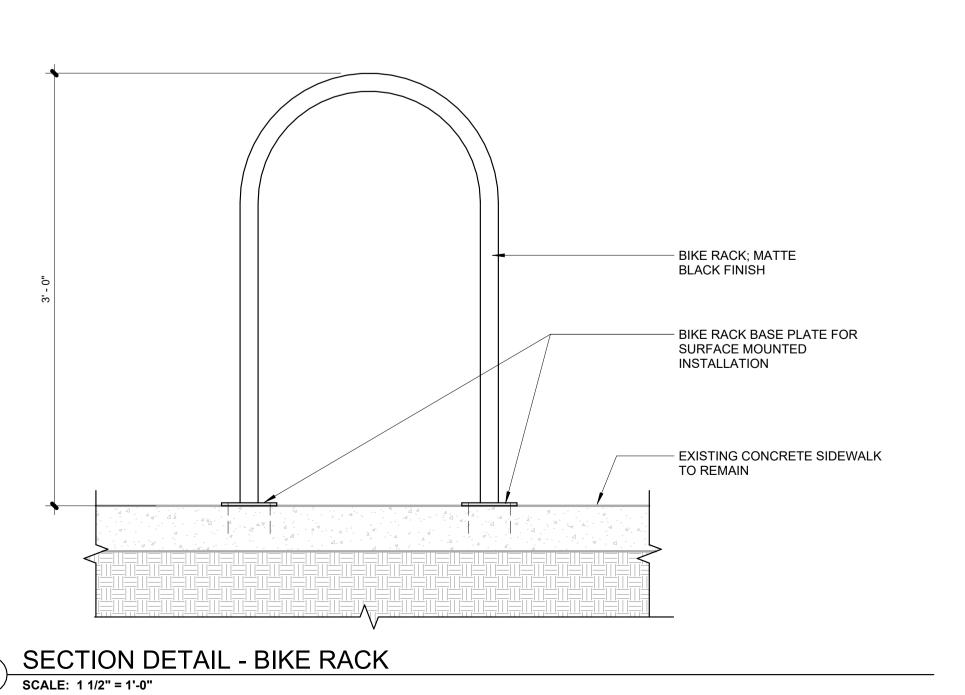

SECTION VIEW
NEW GUTTER PROFILE

SECTION VIEW
NEW DOWNSPOUT PROFILE

3 DOWNSPOUT AND GUTTER PROFILES

SCALE: 3" = 1'-0"

CONTINUOUS 1-1/2" DIA.
METAL TUBE RAILING

1-1/2" DIA. METAL TUBE SUPPORT POST SPACED 5'-0" O.C. MAXIMUM

CONTINUOUS 1-1/2" DIA.
METAL TUBE BOTTOM RAIL

SUPPORT POSTS CAST INTO CONCRETE RAMP

RAMP AND LANDING RAILING NOTES

1. ALL METAL COMPONENTS TO BE CORROSION RESISTANT
2. FASTENER TYPE: EXPOSED

REQUIREMENTS FOR ACCESSIBLE RAMP AND STAIR RAILINGS

5. RAMPS AND STAIR RAILINGS TO EXTEND 1'-0" BEYOND TOP AND BOTTOM OF RAMP/STAIR RUNS

3. METAL FINISHES: PAINTED TO MATCH COLOR #3
4. TOP RAILING PROFILE TO MEET ADA AND ICC A117.1

SECTION DETAIL - RAMP RAILING

SCALE: 1 1/2" = 1'-0"

RETURN HANDRAIL
TO POST, TOP AND
BOTTOM OF RAMP

EDGE BARRIER
PER ICC A117.1
PART 405.9.2.2

RAILING POSTS CAST
INTO CONCRETE RAMP

SECTION DETAIL - RAMP RAILING RETURN

SCALE: 1 1/2" = 1'-0"

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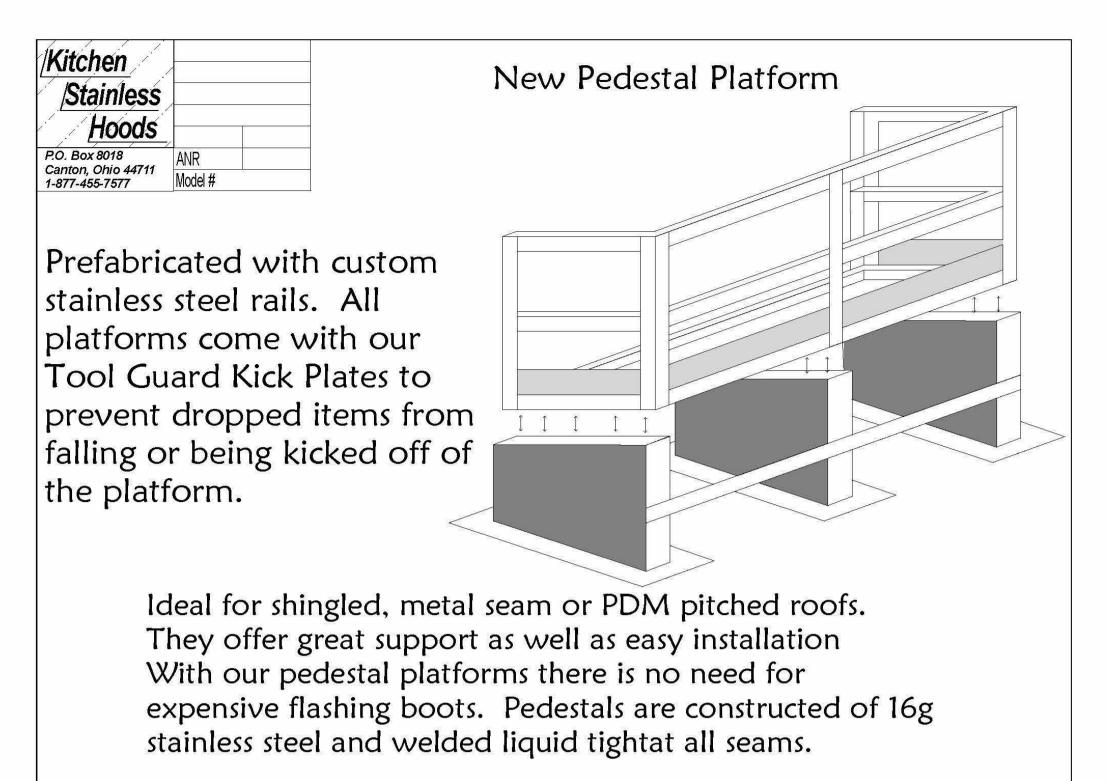
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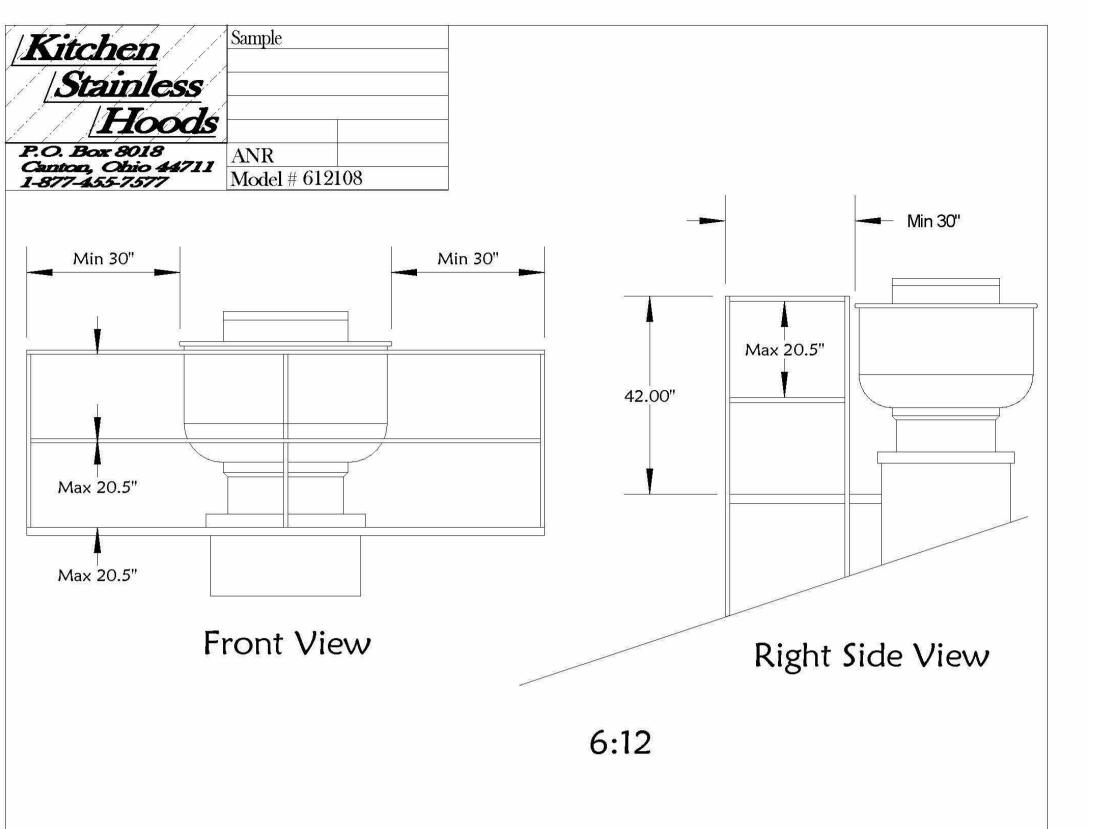
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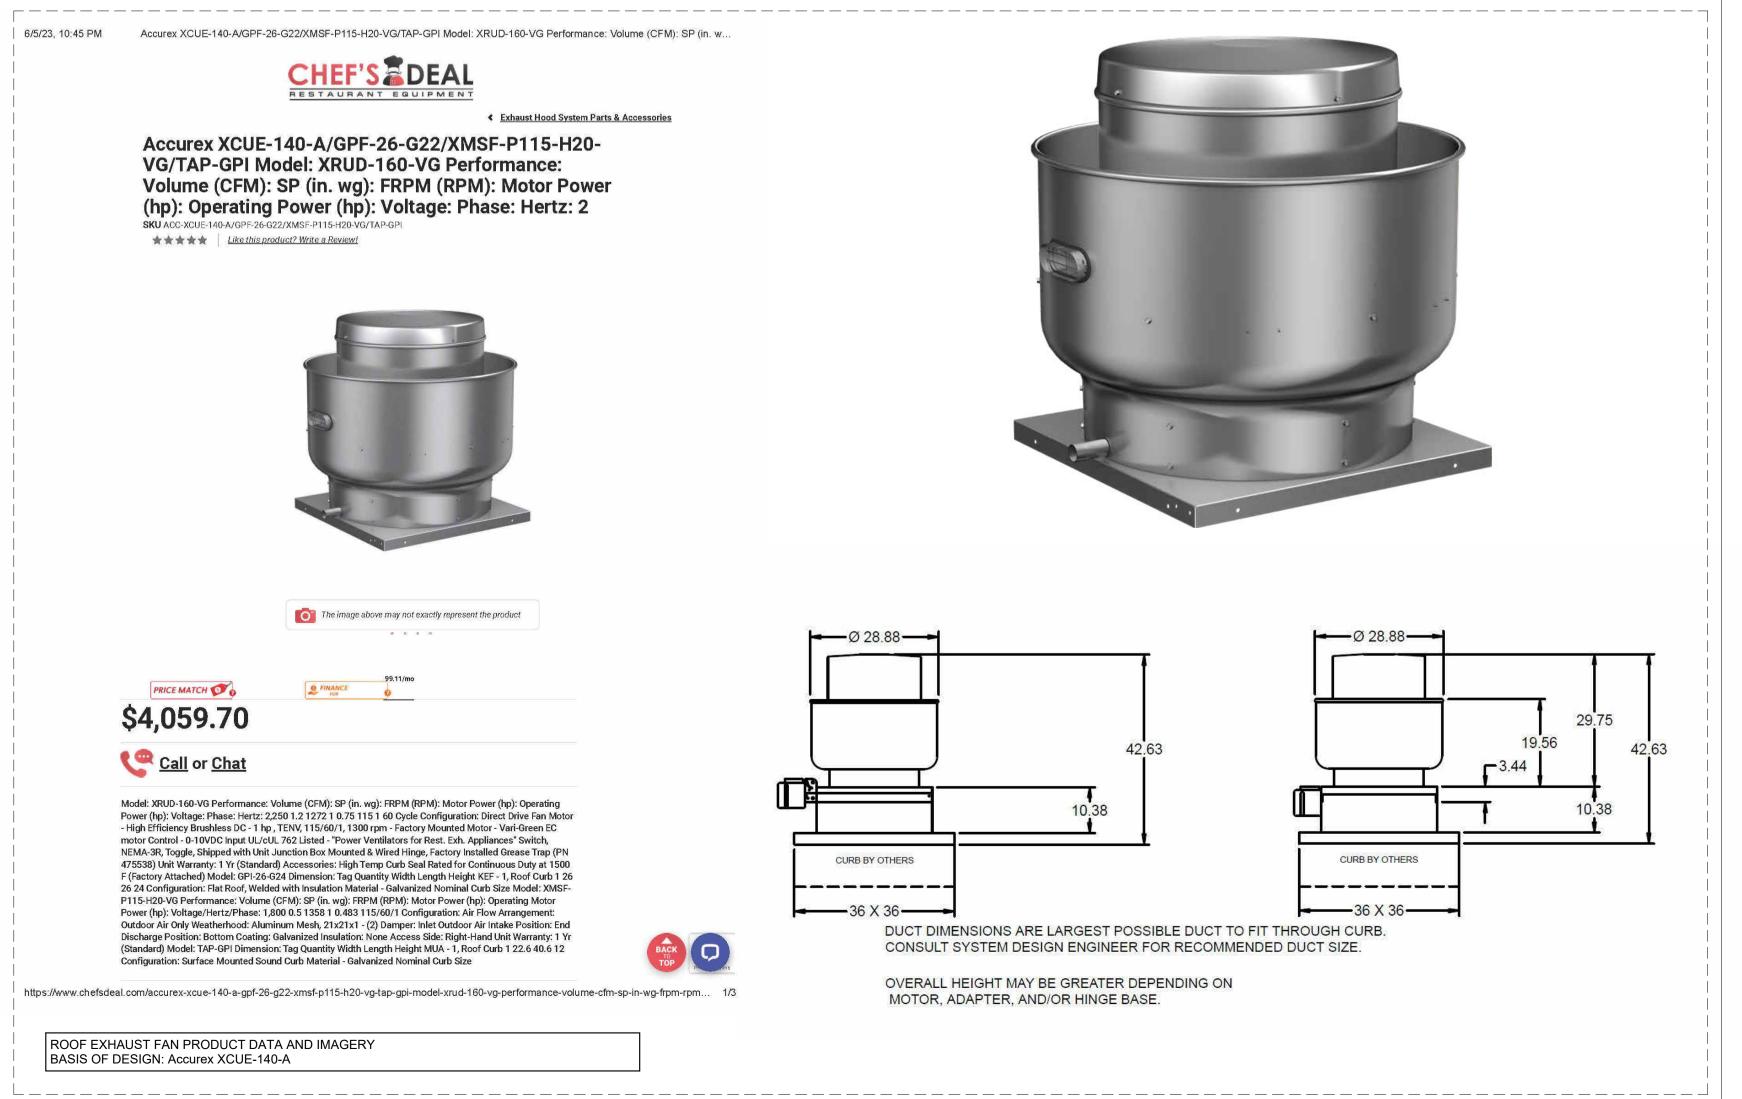
A-3.0





ROOF EQUIPMENT WALKWAY SYSTEM
BASIS OF DESIGN: SERVICE PLATFORMS FOR PITCHED OR SLOPED ROOFTOPS BY KITCHEN STAINLESS STEEL







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A-8.2