

EROSION AND SEDIMENTATION CONTROL NARRATIVE

PLAN DESIGNER: E.P. FERRIS & ASSOCIATES

2130 QUARRY TRAILS DRIVE, 2ND FLOOR COLUMBUS, OH 43228

OWNER/DEVELOPER: PHONE: 614-299-2999 FAX: 614-299-2992

EASTPORT DUBLIN IRF LLC (OWNER)

SELECT MEDICAL CORPORATION (DEVELOPER)
4714 GETTYSPURG ROAD

MECHANICSBURG, PA 17055 PHONE: (888) 735-6332

PROJECT DESCRIPTION:

THE EXISTING SITE CONSISTS OF AN EXISTING MEDICAL BUILDING WITH PARKING LOTS, A DETENTION POND, STORM SEWERS, UNDERGROUND STORAGE, AND UTILITIES RELATED TO THE EXISTING

DEVELOPMENT IN DUBLIN, OHIO. THE PROPOSED IMPROVEMENTS INCLUDES AN EXPANSION TO THE REHABILITATION HOSPITAL CONTAINING 20 NEW BEDS AND ASSOCIATED PARKING ALONG THE WEST SIDE OF THE EXEISTING BUILDING. DISTURBED AREA IS LIMITED ON THE LOT TO THE ABOVE MENTIONED

IMPROVEMENTS AND TO THE AREA WITHIN THE EXISTING EASEMENT.

SITE DRAINS TO:

THE DEVELOPED PORTION OF THE SITE DRAINS TO AN EXISTING STORM SEWER SYSTEM ALONG EMERALD PARKWAY AND AN EXISTING STORM SEWER LOCATED WITHIN THE EXISTING PRIVATE DRIVE. THE AREA IS TRIBUTARY TO THE HARD ROAD NORTH WATERSHED AND THE BILLINGSLEY CREEK WATERSHED, WHICH

BOTH ULTIMATELY DRAIN TO THE SCIOTO RIVER.

SOILS: BLE1B1 - BLOUNT SILT LOAM, END MORAINE, 2-4% SLOPES

EXISTING SITE CONDITIONS:

THE SITE CONSISTS OF AN EXISTING MEDICAL BUILDING WITH PARKING LOTS, A DETENTION POND, STORM SEWERS, UNDERGROUND STORAGE, AND UTILITIES RELATED TO THE EXISTING DEVELOPMENT.

ADJACENT AREAS:

THE EXISTING ADJACENT DEVELOPMENTS HAVE BEEN TAKEN INTO ACCOUNT FOR THE STORM SYSTEM AND FLOOD ROUTING FOLLOWING EXISTING DRAINAGE PATH.

CRITICAL AREAS: EXISTING POND

EROSION CONTROL MEASURES: EROSION AND SITE RUN-OFF WILL BE CONTROLLED THROUGH THE USE OF FILTER FABRIC FENCE PLACED AT LOW LYING AREAS AROUND THE SITE.

SEDIMENT CONTROL MEASURES: SEDIMENT WILL BE CONTROLLED THROUGH THE USE OF INLET PROTECTION AT PROPOSED AND EXISTING INLETS AS WELL AS FILTER FABRIC FENCE PLACED AT LOW LYING AREAS AROUND THE SITE.

PERMANENT STABILIZATION: ALL DISTURBED AREAS ARE TO BE SEEDED.

MAINTENANCE:

ALL EROSION CONTROL DEVICES WILL BE INSPECTED BY THE CONSTRUCTION SUPERINTENDENT DAILY

AND AFTER SIGNIFICANT RAINFALLS. ANY DAMAGED DEVICES WILL BE REPAIRED AND/OR REPLACED

IMMEDIATELY OR AS NECESSARY.

CONSTRUCTION SEQUENCE: SEE SHEET 4 FOR GENERAL SWPPP CONSTRUCTION SEQUENCE.

SITE CONTACT: NICK BELFER - SELECT MEDICAL CORPORATION

4714 GETTYSBURG RD
MECHANICSBURG, PA 17055
PH: (888) 735-6332 (OFFICE)
EMAIL: nbelfer@selectmedical.com

DISTURBED AREA: 0.770 ACRES

SEDIMENT & EROSION CONTROL NOTES:

EROSION/SEDIMENT/DUST CONTROL CONSTRUCTION PRACTICES

UTILIZE EROSION AND SEDIMENT CONTROL PRACTICES PER THE SOIL CONSERVATION SERVICE STANDARDS AND SPECIFICATIONS. EROSION CONTROL DEVICES ARE TO BE MAINTAINED IN EFFECTIVE WORKING CONDITION DURING CONSTRUCTION AND UNTIL THE CONSTRUCTION AREA HAS BEEN PERMANENTLY STABILIZED. THE CONTRACTOR SHALL CONSULT WITH SOIL CONSERVATION SERVICE AND THE ENGINEER CONCERNING PROPER FROSION AND SEDIMENT PRACTICES.

STOCKPILED TOPSOIL AND EXCAVATED MATERIAL IS TO BE PROTECTED THROUGH THE USE OF TEMPORARY SEEDING, OR COVERED WITH ANCHORED STRAW MULCH.

FINAL GRADING WILL BE CONSISTENT WITH PRE-CONSTRUCTION TOPOGRAPHY TO MAINTAIN DRAINAGE AND AESTHETICS.

REMOVE ONLY THOSE TREES, SHRUBS, AND GRASSES THAT MUST BE REMOVED TO PERMIT ACTUAL CONSTRUCTION: PROTECT THE REMAINING TO PRESERVE THEIR AESTHETIC AND EROSION CONTROL VALUE.

BACKFILL TRENCHES IMMEDIATELY AFTER COMPACTION. SEED AND MULCH TRENCHES WITHIN TWO WEEKS AFTER TRENCHES ARE OPENED.

SILT FROM CONSTRUCTION OPERATIONS SHALL NOT BE PERMITTED TO ENTER THE STORM DRAIN SYSTEM, WATERWAYS (NATURAL OR MAN-MADE), OR ADJACENT PRIVATE PROPERTY. CONSTRUCTION OCCURRING NEAR STORM DRAIN INLETS OR WATERWAYS (NATURAL OR MAN-MADE) SHALL REQUIRE EROSION CONTROL MEASURES, SUCH AS SILT FENCE BARRIERS, TO PREVENT SILT FROM ENTERING THE STORM DRAIN, WATERWAYS (NATURAL OR MAN-MADE) OR ADJACENT PRIVATE PROPERTY.

ALL EROSION/SEDIMENT/DUST CONTROL PRACTICES SHALL BE PERFORMED AS RECOMMENDED BY OHIO DEPARTMENT OF NATURAL RESOURCES RAINWATER AND LAND DEVELOPMENT MANUAL (CURRENT VERSION).

STABILIZATION OF DENUDED AREAS

DENUDED AREAS SHALL HAVE SOIL STABILIZATION APPLIED WITHIN SEVEN DAYS OF DISTURBANCE IF THEY ARE TO REMAIN SUBSTANTIALLY UNWORKED FOR MORE THAN 45 DAYS. PERMANENT OR TEMPORARY SOIL STABILIZATION SHALL BE APPLIED TO DENUDED AREAS WITHIN SEVEN DAYS AFTER FINAL GRADE IS REACHED ON ANY PORTION OF THE SITE. SOIL STABILIZATION SHALL ALSO BE APPLIED WITHIN SEVEN DAYS TO DENUDED AREAS WHICH MAY NOT BE AT FINAL GRADE, BUT WHICH WILL REMAIN DORMANT (UNDISTURBED) FOR LONGER THAN 45 DAYS.

SEDIMENT CONTRO

STORM WATER RUNOFF FROM DENUDED AREAS SHALL PASS THROUGH A SEDIMENT BASIN OR OTHER SUITABLE SEDIMENT TRAPPING FACILITY. THESE CONTROLS SHALL BE SELECTED AND LOCATED AS DIRECTED BY THE ENGINEER.

CONSTRUCTION ACCESS ROUTES

MEASURES SHALL BE TAKEN TO PREVENT SOIL TRANSPORT ONTO SURFACES WHERE RUNOFF IS NOT CHECKED BY SEDIMENT CONTROLS, OR ONTO PUBLIC ROADS. THE CONTRACTOR SHALL BE RESPONSIBLE TO ENSURE THAT OFF—SITE TRACKING OF SEDIMENTS BY VEHICLES, EQUIPMENT, AND WORKERS IS MINIMIZED.

SLOUGHING AND DUMPING

NO SOIL, ROCK, DEBRIS OR ANY OTHER MATERIAL SHALL BE DUMPED OR PLACED INTO A WATER RESOURCE OR INTO SUCH PROXIMITY THAT IT MAY READILY SLOUGH, SLIP, OR ERODE INTO A WATER RESOURCE UNLESS SUCH DUMPING OR PLACING IS AUTHORIZED BY THE CITY ENGINEER. UNSTABLE SOILS PRONE TO SLIPPING OR LAND SLIDING SHALL NOT BE GRADED, EXCAVATED, FILLED OR HAVE LOADS IMPOSED UPON THEM UNLESS THE WORK IS DONE IN ACCORDANCE WITH A QUALIFIED PROFESSIONAL ENGINEER'S RECOMMENDATIONS TO CORRECT, ELIMINATE OR ADEQUATELY ADDRESS THE PROBLEMS.

ESTABLISHMENT OF PERMANENT VEGETATION

PERMANENT VEGETATION SHALL NOT BE CONSIDERED ESTABLISHED UNTIL GROUND COVER IS ACHIEVED WHICH, IN THE OPINION OF THE CITY ENGINEER, IS MATURE ENOUGH TO CONTROL SOIL EROSION SATISFACTORILY AND TO SURVIVE ADVERSE WEATHER CONDITIONS.

SEEDING AND MULCHING:

1. TEMPORARY SEEDING SHALL CONSIST OF ANNUAL RYE-GRASS AS PER ITEM 207. SEED AND MULCHING SHALL BE APPLIED IN ACCORDANCE WITH ITEM 659.

2. PERMANENT SEEDING AND MULCHING SHALL BE TREATED IN ACCORDANCE WITH ITEM 659.

TIMING OF SEDIMENT-TRAPPING PRACTICES

SEDIMENT CONTROL PRACTICES SHALL BE FUNCTIONAL THROUGHOUT EARTH—DISTURBING ACTIVITY. SETTLING FACILITIES, PERIMETER CONTROLS AND OTHER PRACTICES INTENDED TO TRAP SEDIMENT SHALL BE IMPLEMENTED AS THE FIRST STEP OF GRADING OR CONSTRUCTION AND WITHIN SEVEN DAYS FROM THE START OF GRUBBING. THEY SHALL CONTINUE TO FUNCTION UNTIL THE UPSLOPE DEVELOPMENT AREA IS RE—STABILIZED. THESE CONTROLS SHALL BE SELECTED AND LOCATED AS DIRECTED BY THE ENGINEER.

NOTE: LOCATIONS SHOWN FOR SEDIMENT FILTERING BARRIERS ARE SUGGESTED LOCATIONS; THE FINAL AND MOST APPROPRIATE LOCATION FOR THESE DEVICES SHALL BE APPROVED BY THE ENGINEER, BASED ON SITE CONDITIONS AND OBSERVED TOPOGRAPHY. PROPER IMPLEMENTATION, INSTALLATION, MAINTENANCE, AND REPAIR OF SEDIMENT FILTERING BARRIERS SHALL BE THE SOLE RESPONSIBILITY OF THE CONTRACTOR.

OUTFLOWS FROM DEWATERING OPERATIONS

ALL WATER PRODUCED FROM CLEANING AND DEWATERING OPERATIONS, WHETHER SPECIFICALLY FROM TRENCH DEWATERING OPERATIONS OR FROM MORE EXTENSIVE DEWATERING OPERATIONS, SHALL BE DISCHARGED IN SUCH A MANNER AS TO ELIMINATE EROSION FROM SUCH A DISCHARGE BY DIVERTING THE WATER THROUGH ONE OR MORE FILTER FENCES. PRIOR TO PUMPING, THE ENGINEER SHALL APPROVE THE INSTALLATION OF THE FILTER FENCE.

ADDITIONAL CONTROLS


THE CONTRACTOR SHALL ENSURE THAT NO SEDIMENTS ARE TRACKED OFF—SITE BY CONSTRUCTION EQUIPMENT, VEHICLES, AND WORKERS. THE CONTRACTOR SHALL ALSO ENSURE THAT NO OTHER SOLID (OTHER THAN SEDIMENT) OR LIQUID WASTE IS DISCHARGED INTO ANY STORM WATER FLOW.

P. FERRIS

ASSOCIATES
INC

Consulting Civil Engineers and Surveyors

2130 QUARRY TRAILS DR, 2ND FLOOR COLUMBUS, OHIO 43228 (614) 299-2999 (614) 299-2992 (Fax) www.EPFERRIS.com

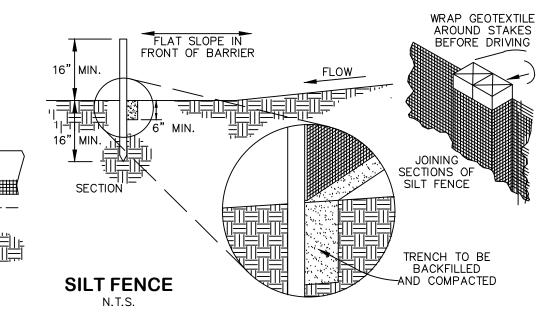

SILT FENCE SHALL BE CONSTRUCTED BEFORE UPSLOPE LAND DISTURBANCE BEGINS.

LEVEL CONTOUR

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ELEVATION

NO SLOPE —

- 2. ALL SILT FENCE SHALL BE PLACED AS CLOSE TO THE CONTOUR AS POSSIBLE SO THAT WATER WILL NOT CONCENTRATE AT LOW POINTS IN THE FENCE AND SO THAT SMALL SWALES OR DEPRESSIONS THAT MAY CARRY SMALL CONCENTRATED FLOWS TO THE SILT FENCE ARE DISSIPATED ALONG ITS LENGTH.
- 3. ENDS OF THE SILT FENCES SHALL BE BROUGHT UPSLOPE SLIGHTLY SO THAT WATER PONDED BY THE SILT FENCE WILL BE PREVENTED FROM FLOWING AROUND THE FINDS
- 4. SILT FENCE SHALL BE PLACED ON THE FLATTEST AREA AVAILABLE.
- 5. WHERE POSSIBLE, VEGETATION SHALL BE PRESERVED FOR 5 FEET (OR AS MUCH AS POSSIBLE) UPSLOPE FROM THE SILT FENCE. IF VEGETATION IS REMOVED, IT SHALL BE REESTABLISHED WITHIN 7 DAYS FROM THE INSTALLATION OF THE SILT FENCE.
- 6. THE HEIGHT OF THE SILT FENCE SHALL BE A MINIMUM OF 16 INCHES ABOVE THE ORIGINAL GROUND SURFACE.
- 7. THE SILT FENCE SHALL BE PLACED IN AN EXCAVATED OR SLICED TRENCH CUT A MINIMUM OF 6 INCHES DEEP. THE TRENCH SHALL BE MADE WITH A TRENCHER, CABLE LAYING MACHINE, SLICING MACHINE, OR OTHER SUITABLE DEVICE THAT WILL ENSURE AN ADEQUATELY UNIFORM TRENCH DEPTH
- 8. THE SILT FENCE SHALL BE PLACED WITH THE STAKES ON THE DOWNSLOPE SIDE OF THE GEOTEXTILE. A MINIMUM OF 8 INCHES OF GEOTEXTILE MUST BE BELOW THE GROUND SURFACE. EXCESS MATERIAL SHALL LAY ON THE BOTTOM OF THE 6-INCH DEEP TRENCH. THE TRENCH SHALL BE BACKFILLED AND COMPACTED ON BOTH SIDES OF THE FABRIC.
- 9. SEAMS BETWEEN SECTIONS OF SILT FENCE SHALL BE SPLICED TOGETHER ONLY AT A SUPPORT POST WITH A MINIMUM 6-IN. OVERLAP PRIOR TO DRIVING INTO THE GROUND, (SEE DETAILS).

10. MAINTENANCE—SILT FENCE SHALL ALLOW RUNOFF TO PASS ONLY AS DIFFUSE FLOW THROUGH THE GEOTEXTILE. IF RUNOFF OVERTOPS THE SILT FENCE, FLOWS UNDER THE FABRIC OR AROUND THE FENCE ENDS, OR IN ANY OTHER WAY ALLOWS A CONCENTRATED FLOW DISCHARGE, ONE OF THE FOLLOWING SHALL BE PERFORMED, AS APPROPRIATE: 1)THE LAYOUT OF THE SILT FENCE SHALL BE CHANGED, 2)ACCUMULATED SEDIMENT SHALL BE REMOVED, OR 3)OTHER PRACTICES SHALL BE INSTALLED.

SEDIMENT DEPOSITS SHALL BE ROUTINELY REMOVED WHEN THE DEPOSIT REACHES APPROXIMATELY ONE-HALF OF THE HEIGHT OF THE SILT

SILT FENCES SHALL BE INSPECTED AFTER EACH RAINFALL AND AT LEAST DAILY DURING A PROLONGED RAINFALL. THE LOCATION OF EXISTING SILT FENCE SHALL BE REVIEWED DAILY TO ENSURE ITS PROPER LOCATION AND EFFECTIVENESS. IF DAMAGED, THE SILT FENCE SHALL BE REPAIRED

CRITERIA FOR SILT FENCE MATERIALS

FENCE POST — THE LENGTH SHALL BE A MINIMUM OF 32 INCHES. WOOD POSTS WILL BE 2-BY-2-IN. NOMINAL DIMENSIONED HARDWOOD OF SOUND QUALITY. THEY SHALL BE FREE OF KNOTS, SPLITS AND OTHER VISIBLE IMPERFECTIONS, THAT WILL WEAKEN THE POSTS. THE MAXIMUM SPACING BETWEEN POSTS SHALL BE 10 FT. POSTS SHALL BE DRIVEN A MINIMUM 16 INCHES INTO THE GROUND, WHERE POSSIBLE. IF NOT POSSIBLE, THE POSTS SHALL BE ADEQUATELY SECURED TO PREVENT

2. SILT FENCE FABRIC — SEE CHART BELOW.

FABRIC PROPERTIES	VALUES	TEST METHOD
Minimum Tensile Strength	120 lbs. (535 N)	ASTM D 4632
Maximum Elongation at 60 lbs	50%	ASTM D 4632
Minimum Puncture Strength	50 lbs (220 N)	ASTM D 4833
Minimum Tear Strength	40 lbs (180 N)	ASTM D 4533
Apparent Opening Size	≤ 0.84 mm	ASTM D 4751
Minimum Permittivity	1X10-2 sec1	ASTM D 4491
UV Exposure Strength Retention	70%	ASTM G 4355

OVERTURNING OF THE FENCE DUE TO SEDIMENT/WATER LOADING.

SEDIMENT & EROSION CONTROL NOTES:

PROHIBITED CONSTRUCTION ACTIVITIES

THE CONTRACTOR SHALL NOT USE CONSTRUCTION PROCEEDINGS, ACTIVITIES, OR OPERATIONS THAT MAY UNNECESSARILY IMPACT THE NATURAL ENVIRONMENT OR THE PUBLIC HEALTH AND SAFETY. PROHIBITED CONSTRUCTION PROCEDURES, ACTIVITIES, OR OPERATIONS INCLUDE BUT ARE NOT LIMITED TO:

- 1. DISPOSING OF EXCESS OR UNSUITABLE EXCAVATED MATERIAL IN WETLANDS OR FLOOD PLAINS, EVEN WITH THE PERMISSION OF THE PROPERTY OWNER.
- INDISCRIMINATE, ARBITRARY, OR CAPRICIOUS OPERATION OF EQUIPMENT IN ANY STREAM CORRIDORS, ANY WETLANDS, ANY SURFACE WATERS, OR OUTSIDE THE EASEMENT
- 3. PUMPING OF SEDIMENT-LADEN WATER FROM TRENCHES OR OTHER EXCAVATIONS INTO ANY SURFACE WATERS, ANY STREAM CORRIDORS, ANY WETLANDS, OR STORM
- 4. DISCHARGING POLLUTANTS SUCH AS CHEMICALS, FUELS, LUBRICANTS, BITUMINOUS MATERIALS, RAW SEWAGE AND OTHER HARMFUL WASTE INTO OR ALONGSIDE OF RIVERS, STREAMS, IMPOUNDMENTS OR INTO NATURAL OR MAN-MADE CHANNELS LEADING THERETO.
- 5. PERMANENT OR UNSPECIFIED ALTERATION OF THE FLOW LINE OF A STREAM.
- 6. DAMAGING VEGETATION OUTSIDE OF THE CONSTRUCTION ARE
- 7. DISPOSAL OF TREES, BRUSH AND OTHER DEBRIS IN ANY STREAM CORRIDORS, ANY WETLANDS, ANY SURFACE WATERS, OR AT UNSPECIFIED LOCATIONS.
- 8. OPEN BURNING OF PROJECT DEBRIS WITHOUT A PERMIT.
- STORING CONSTRUCTION EQUIPMENT AND VEHICLES AND/OR STOCKPILING CONSTRUCTION MATERIALS ON PROPERTY, PUBLIC OR PRIVATE, NOT PREVIOUSLY SPECIFIED BY THE ENGINEER FOR SAID PURPOSES.


MAINTENANCE AND INSPECTION

ALL TEMPORARY AND PERMANENT EROSION AND SEDIMENT CONTROL PRACTICES SHALL BE DESIGNED AND CONSTRUCTED TO MINIMIZE MAINTENANCE REQUIREMENTS. THEY SHALL BE MAINTAINED AND REPAIRED AS NEEDED TO ASSURE CONTINUED PERFORMANCE OF THEIR INTENDED FUNCTION. MAINTENANCE AND INSPECTION OF ALL EROSION/SEDIMENT CONTROL DEVICES REQUIRED BY THE ENGINEER SHALL BE THE SOLE RESPONSIBILITY OF THE CONTRACTOR. INSPECTION SHALL BE PERFORMED AS PRESCRIBED IN THE NATIONAL POLLUTANT DISCHARGE ELIMINATION SYSTEM (N.P.D.E.S.) GENERAL PERMIT. INSPECTIONS SHALL BE PERFORMED BY THE CONTRACTOR, IN THE PRESENCE OF THE ENGINEER ONCE EVERY 7 CALENDAR DAYS AND/OR WITHIN 24 HOURS AFTER ANY RAIN EVENT OF GREATER THAN 0.5 INCHES IN A 24 HOUR PERIOD. THESE INSPECTIONS SHALL IDENTIFY AREAS CONTRIBUTING TO STORM WATER DISCHARGES ASSOCIATED WITH THE PROJECT; EVALUATE THE ADEQUACY, IMPLEMENTATION, AND MAINTENANCE OF EXISTING AND PROPOSED EROSION/ SEDIMENTATION MEASURES; AND DETERMINE WHETHER ADDITIONAL MEASURES ARE REQUIRED.

ACCEPTABLE INSPECTION REPORTS SHALL BE PREPARED BY THE CONTRACTOR AND SUBMITTED TO THE ENGINEER, IF REQUESTED, WITHIN 48 HOURS OF INSPECTION COMPLETION. THE REPORT SHALL CONTAIN THE RESULTS OF THE INSPECTION, NAME(S) AND QUALIFICATIONS OF PERSONNEL MAKING THE INSPECTION, MAJOR OBSERVATIONS RELATING TO THE IMPLEMENTATION OF THE STORM WATER POLLUTION PLAN, A CERTIFICATION THAT THE FACILITY IS IN COMPLIANCE WITH THE PLAN, AND IDENTIFICATION OF ANY INCIDENTS OF NON-COMPLIANCE.

POLLUTION PREVENTION PLAN AVAILABILITY AND UPDATES

THE CONTRACTOR SHALL BE SOLELY RESPONSIBLE TO ENSURE THE IMMEDIATE AVAILABILITY OF THE POLLUTION PREVENTION PLAN ON—SITE. THE CONTRACTOR SHALL ALSO BE SOLELY RESPONSIBLE TO PERFORM ALL UPDATES AND AMENDMENTS TO THE POLLUTION PREVENTION PLAN.

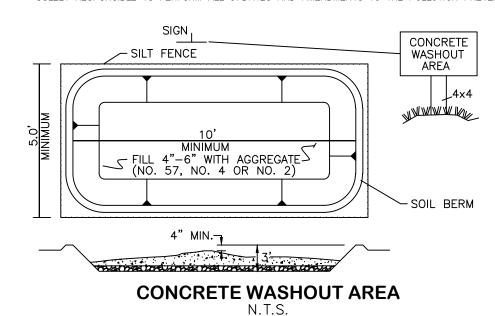

PLAN NOTES

. WEEKLY STREET CLEANING IS REQUIRED THROUGH THE DURATION OF THIS CONSTRUCTION PROJECT. THIS INCLUDES SWEEPING, POWER CLEANING AND MANUAL (IF NECESSARY) REMOVAL OF DIRT OR MUD IN THE STREET GUTTERS.

3805 EMERALD PARKWAY, CITY OF DUBLIN, OHIO
DUBLIN REHABILITATION HOSPITAL EXPANSION

	JOB NO.	1266.001	
	DESIGNED BY:		
	DRAWN BY:	AJF	
,	CHECKED BY:	JCP	
	APPROVED BY:	JCP	
	DATE:	08/17/2023	


STORMWATER POLLUTION PREVENTION PLAN NOTES


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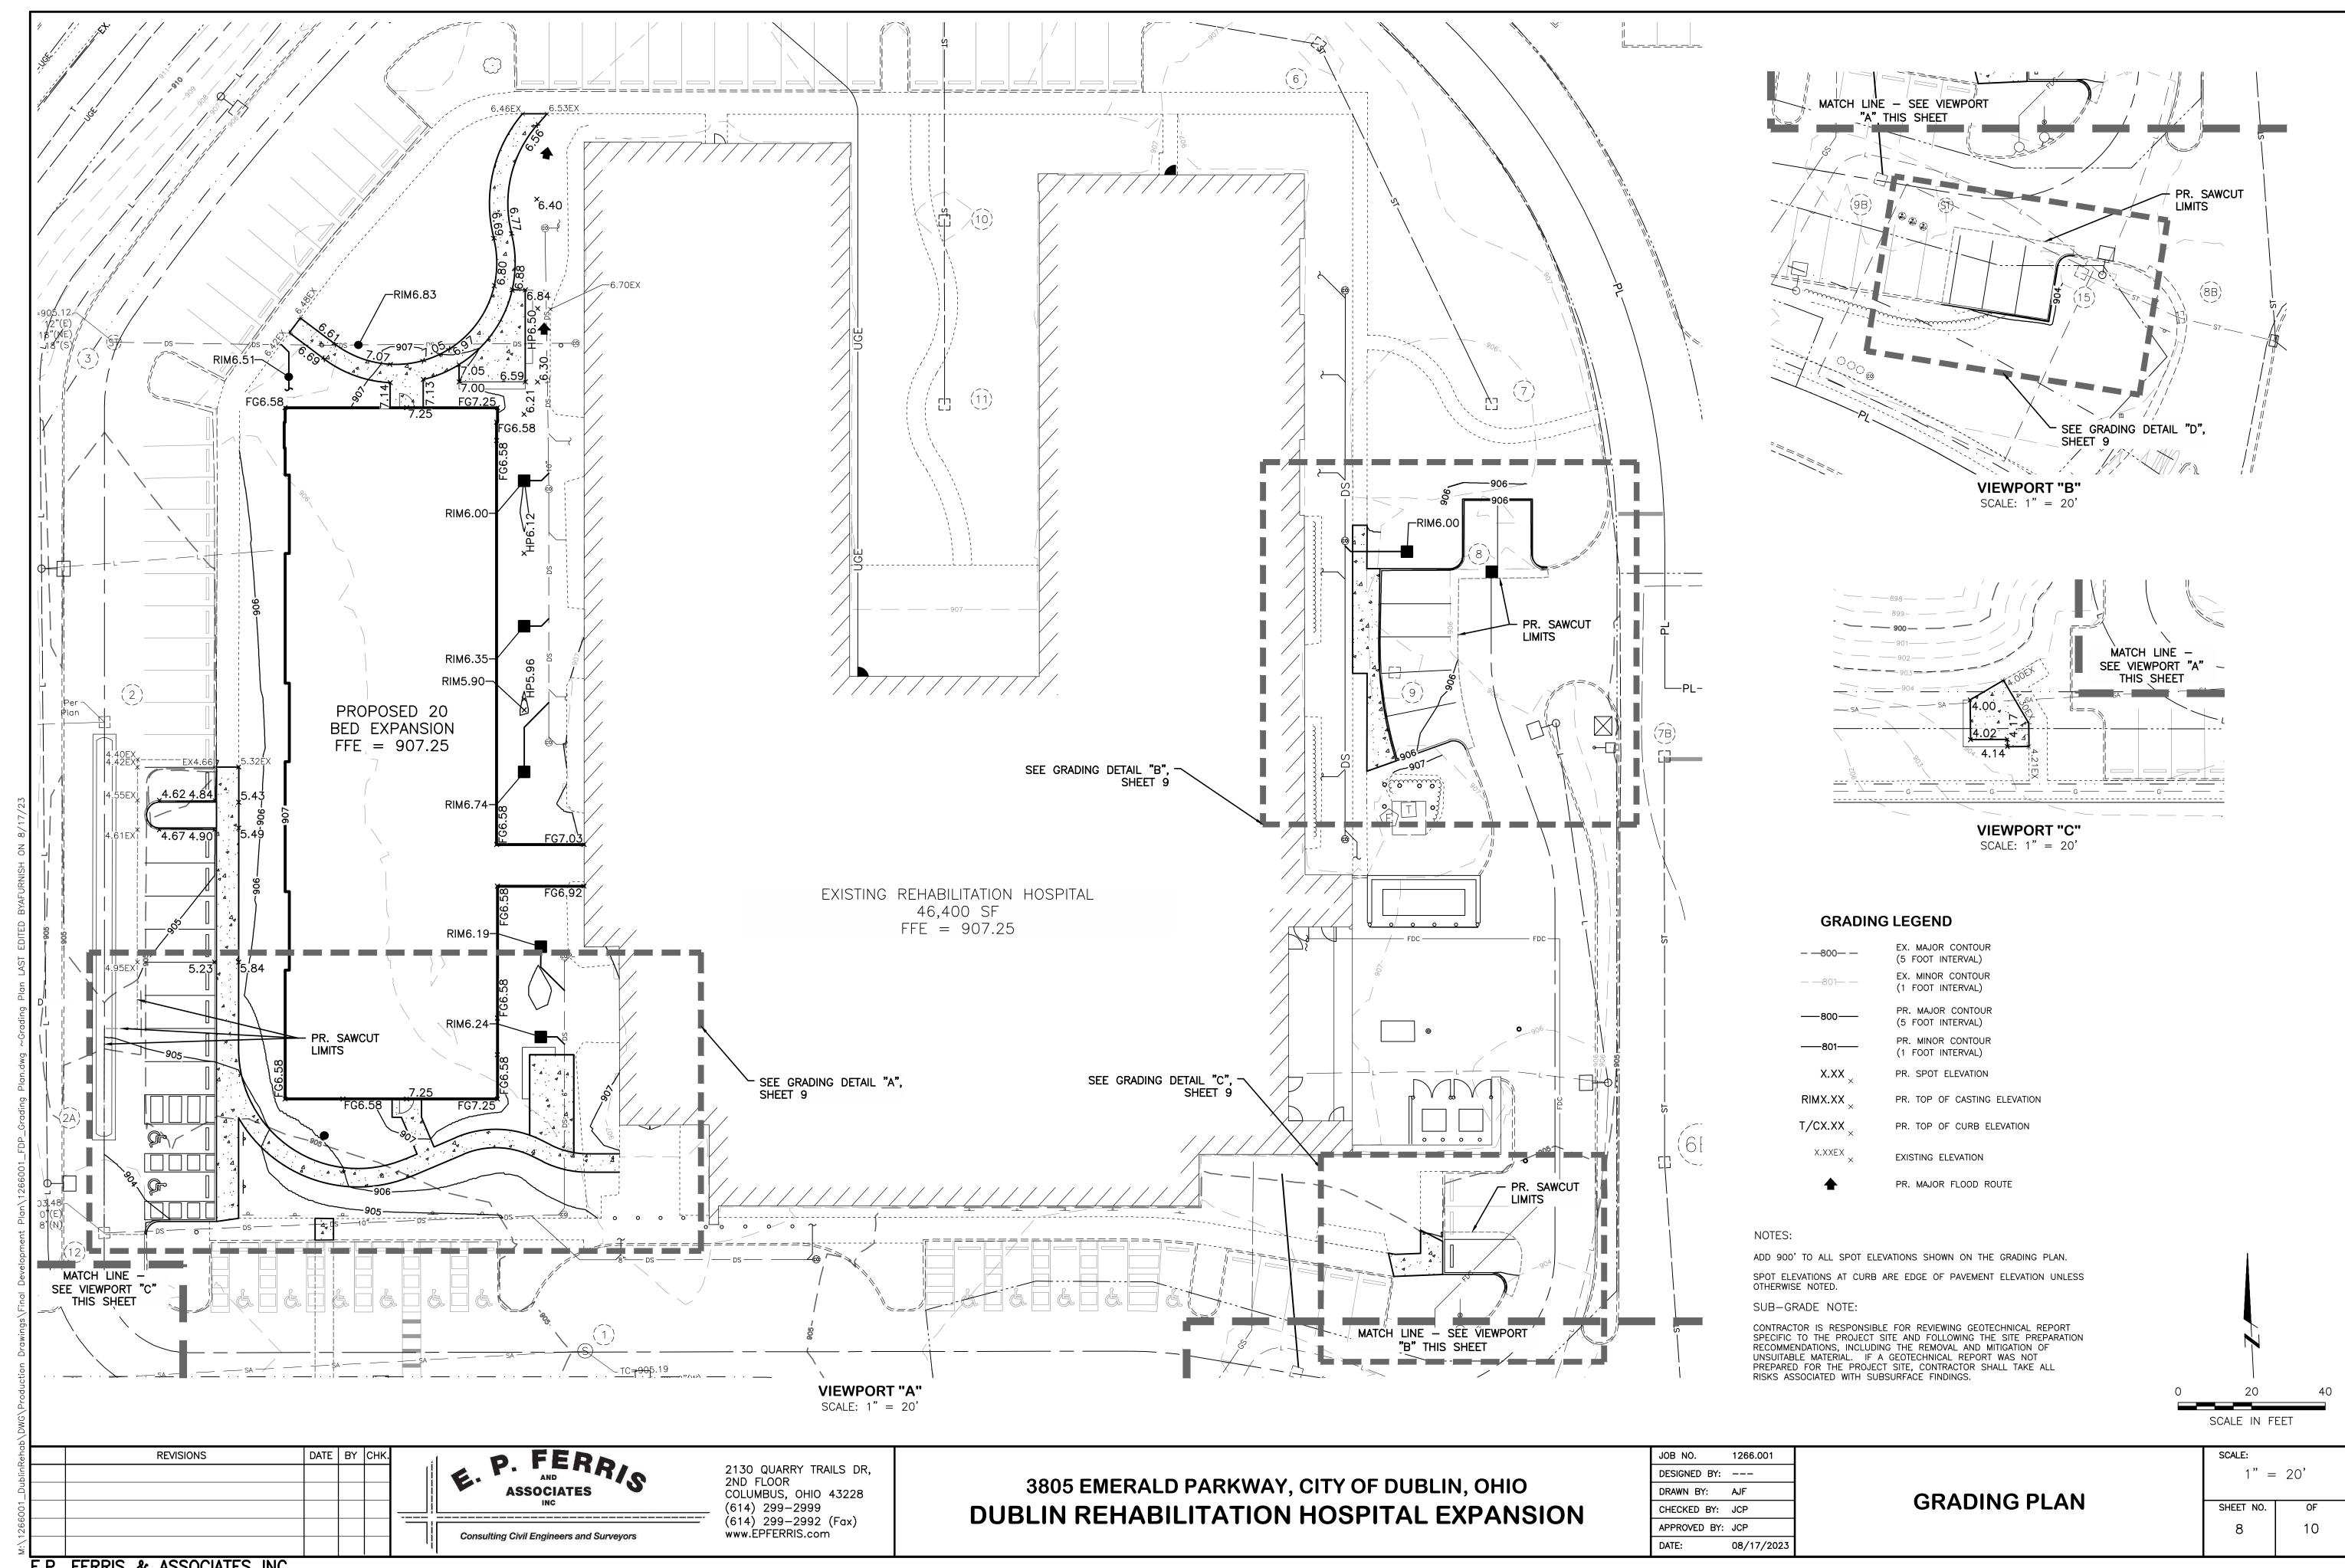
1" = 40'


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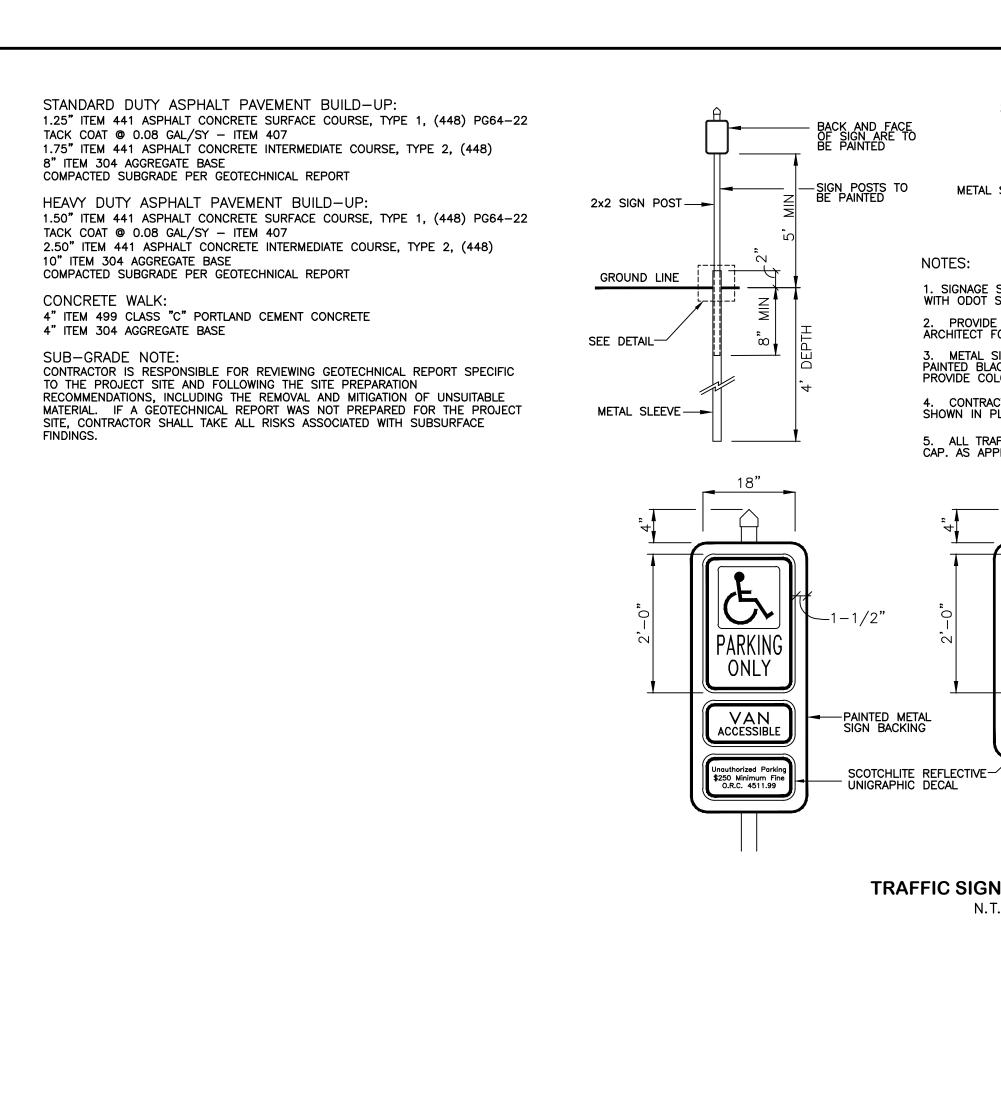
REVISIONS







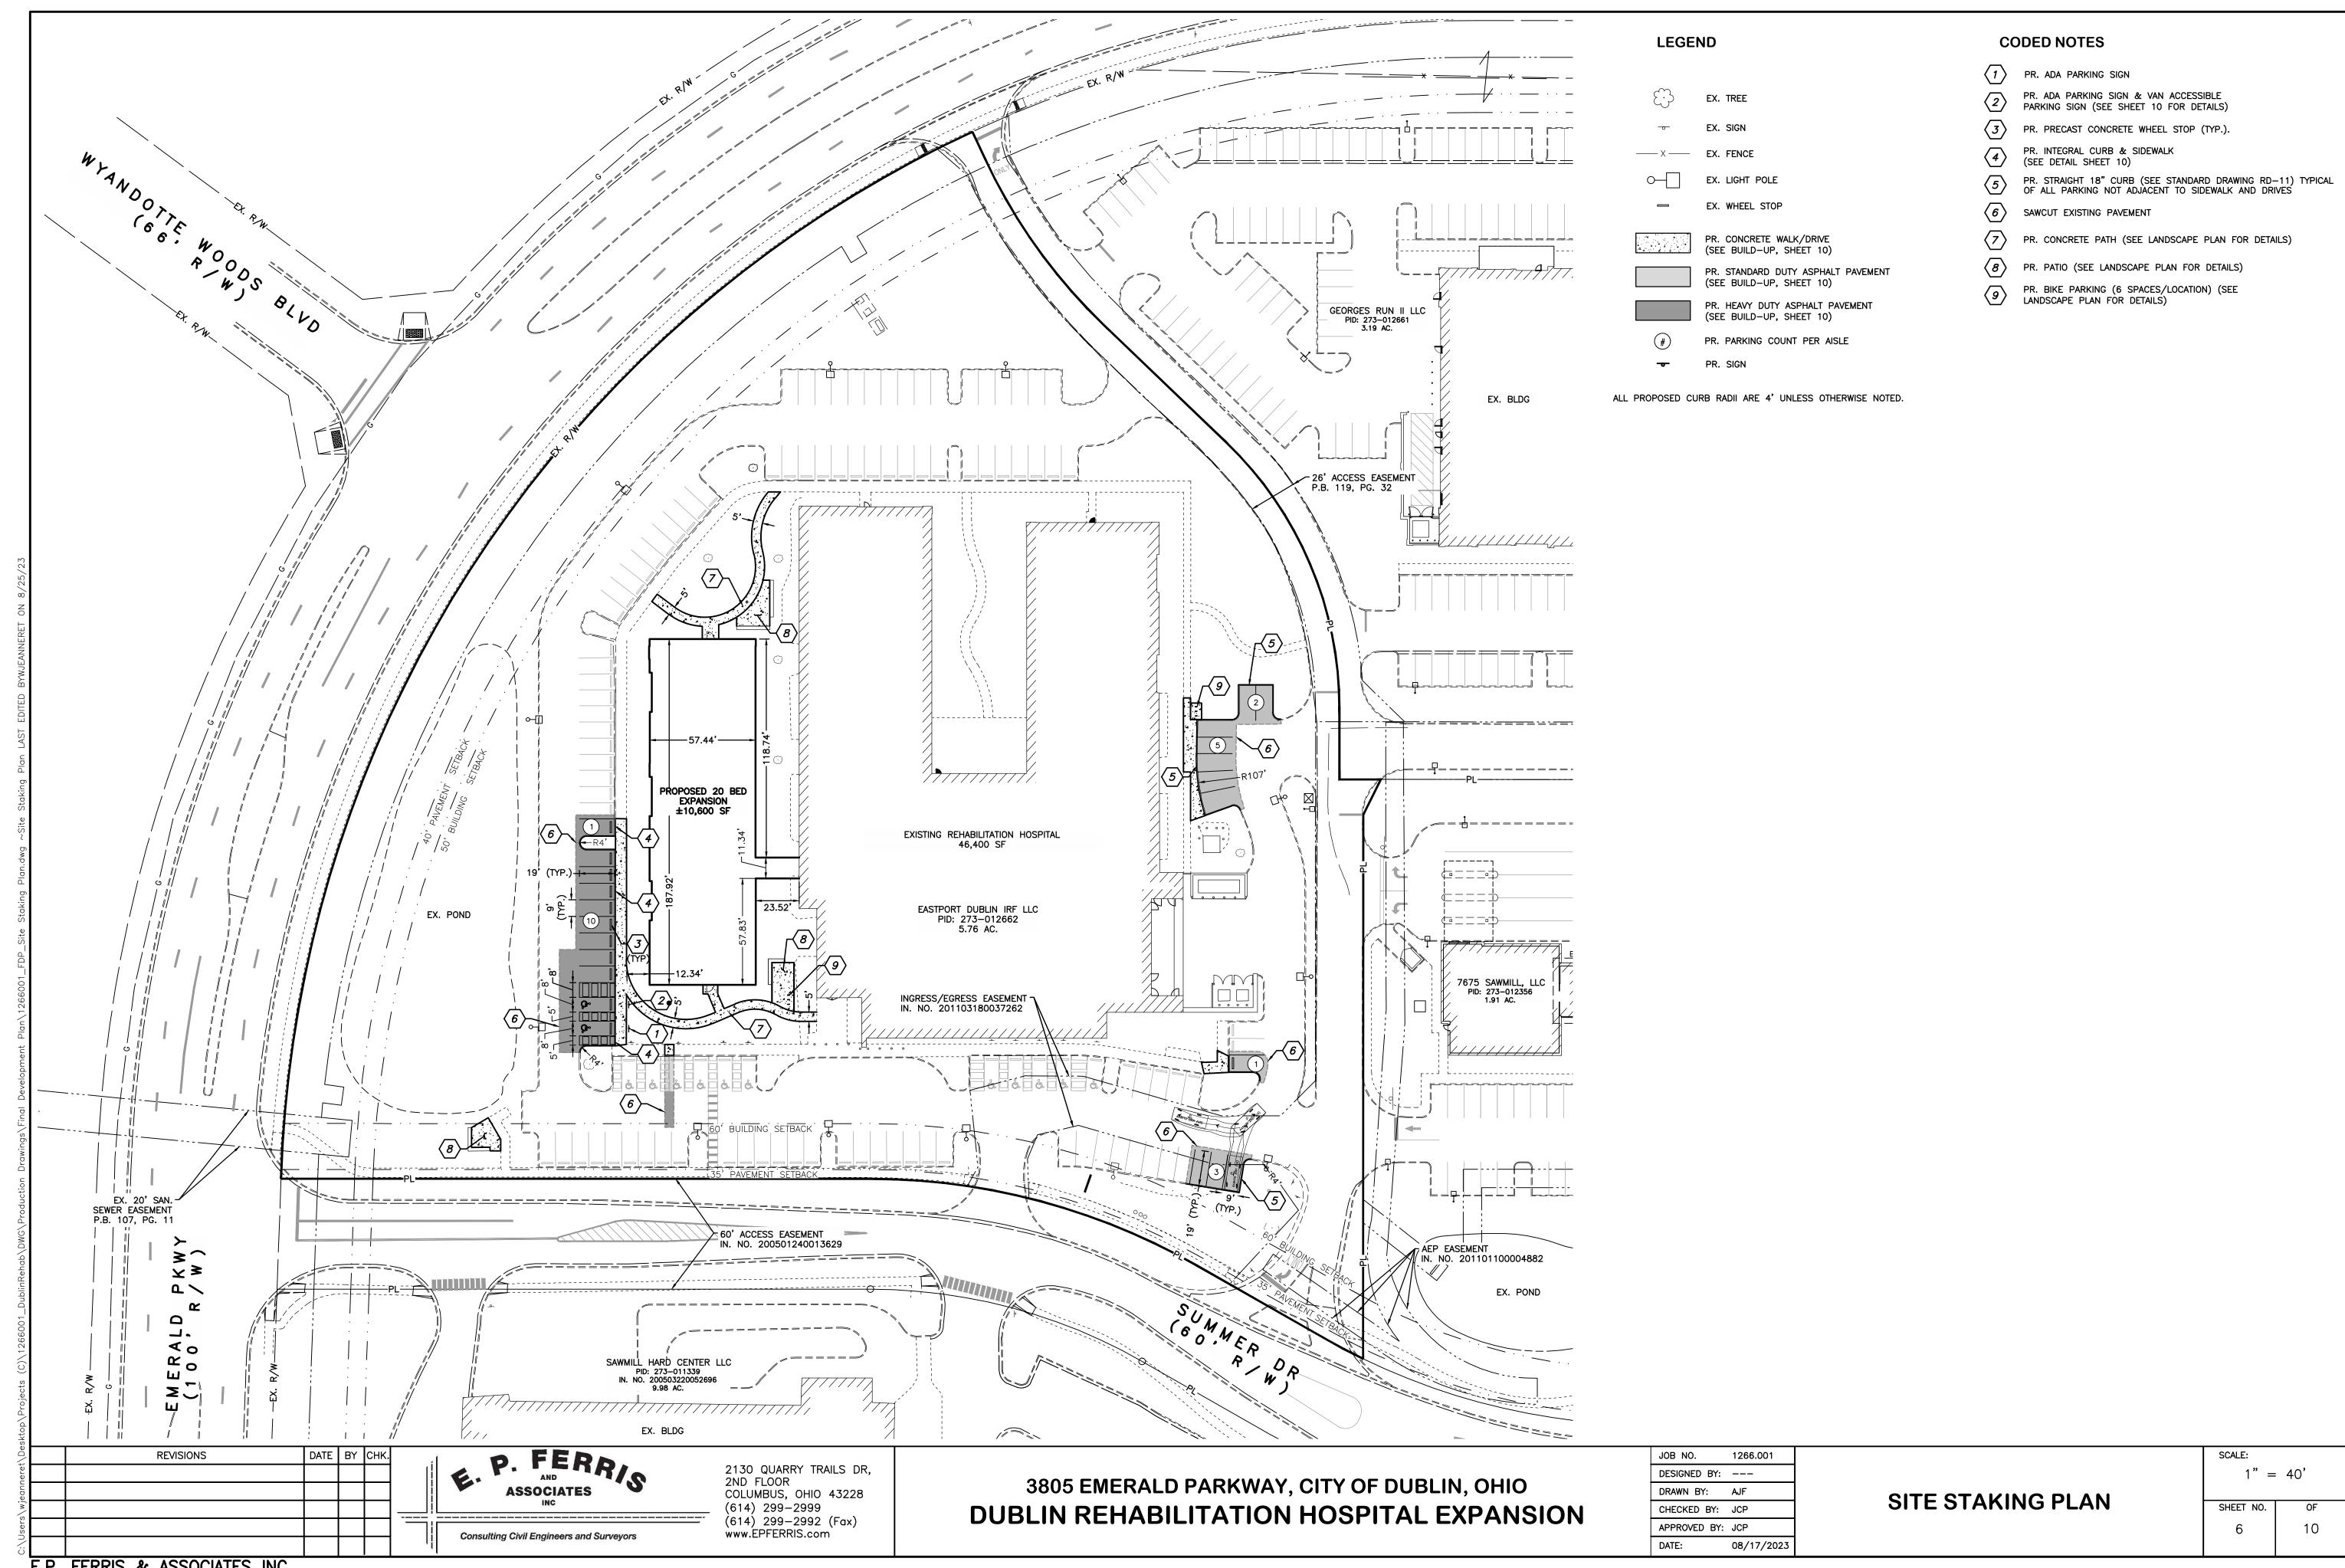

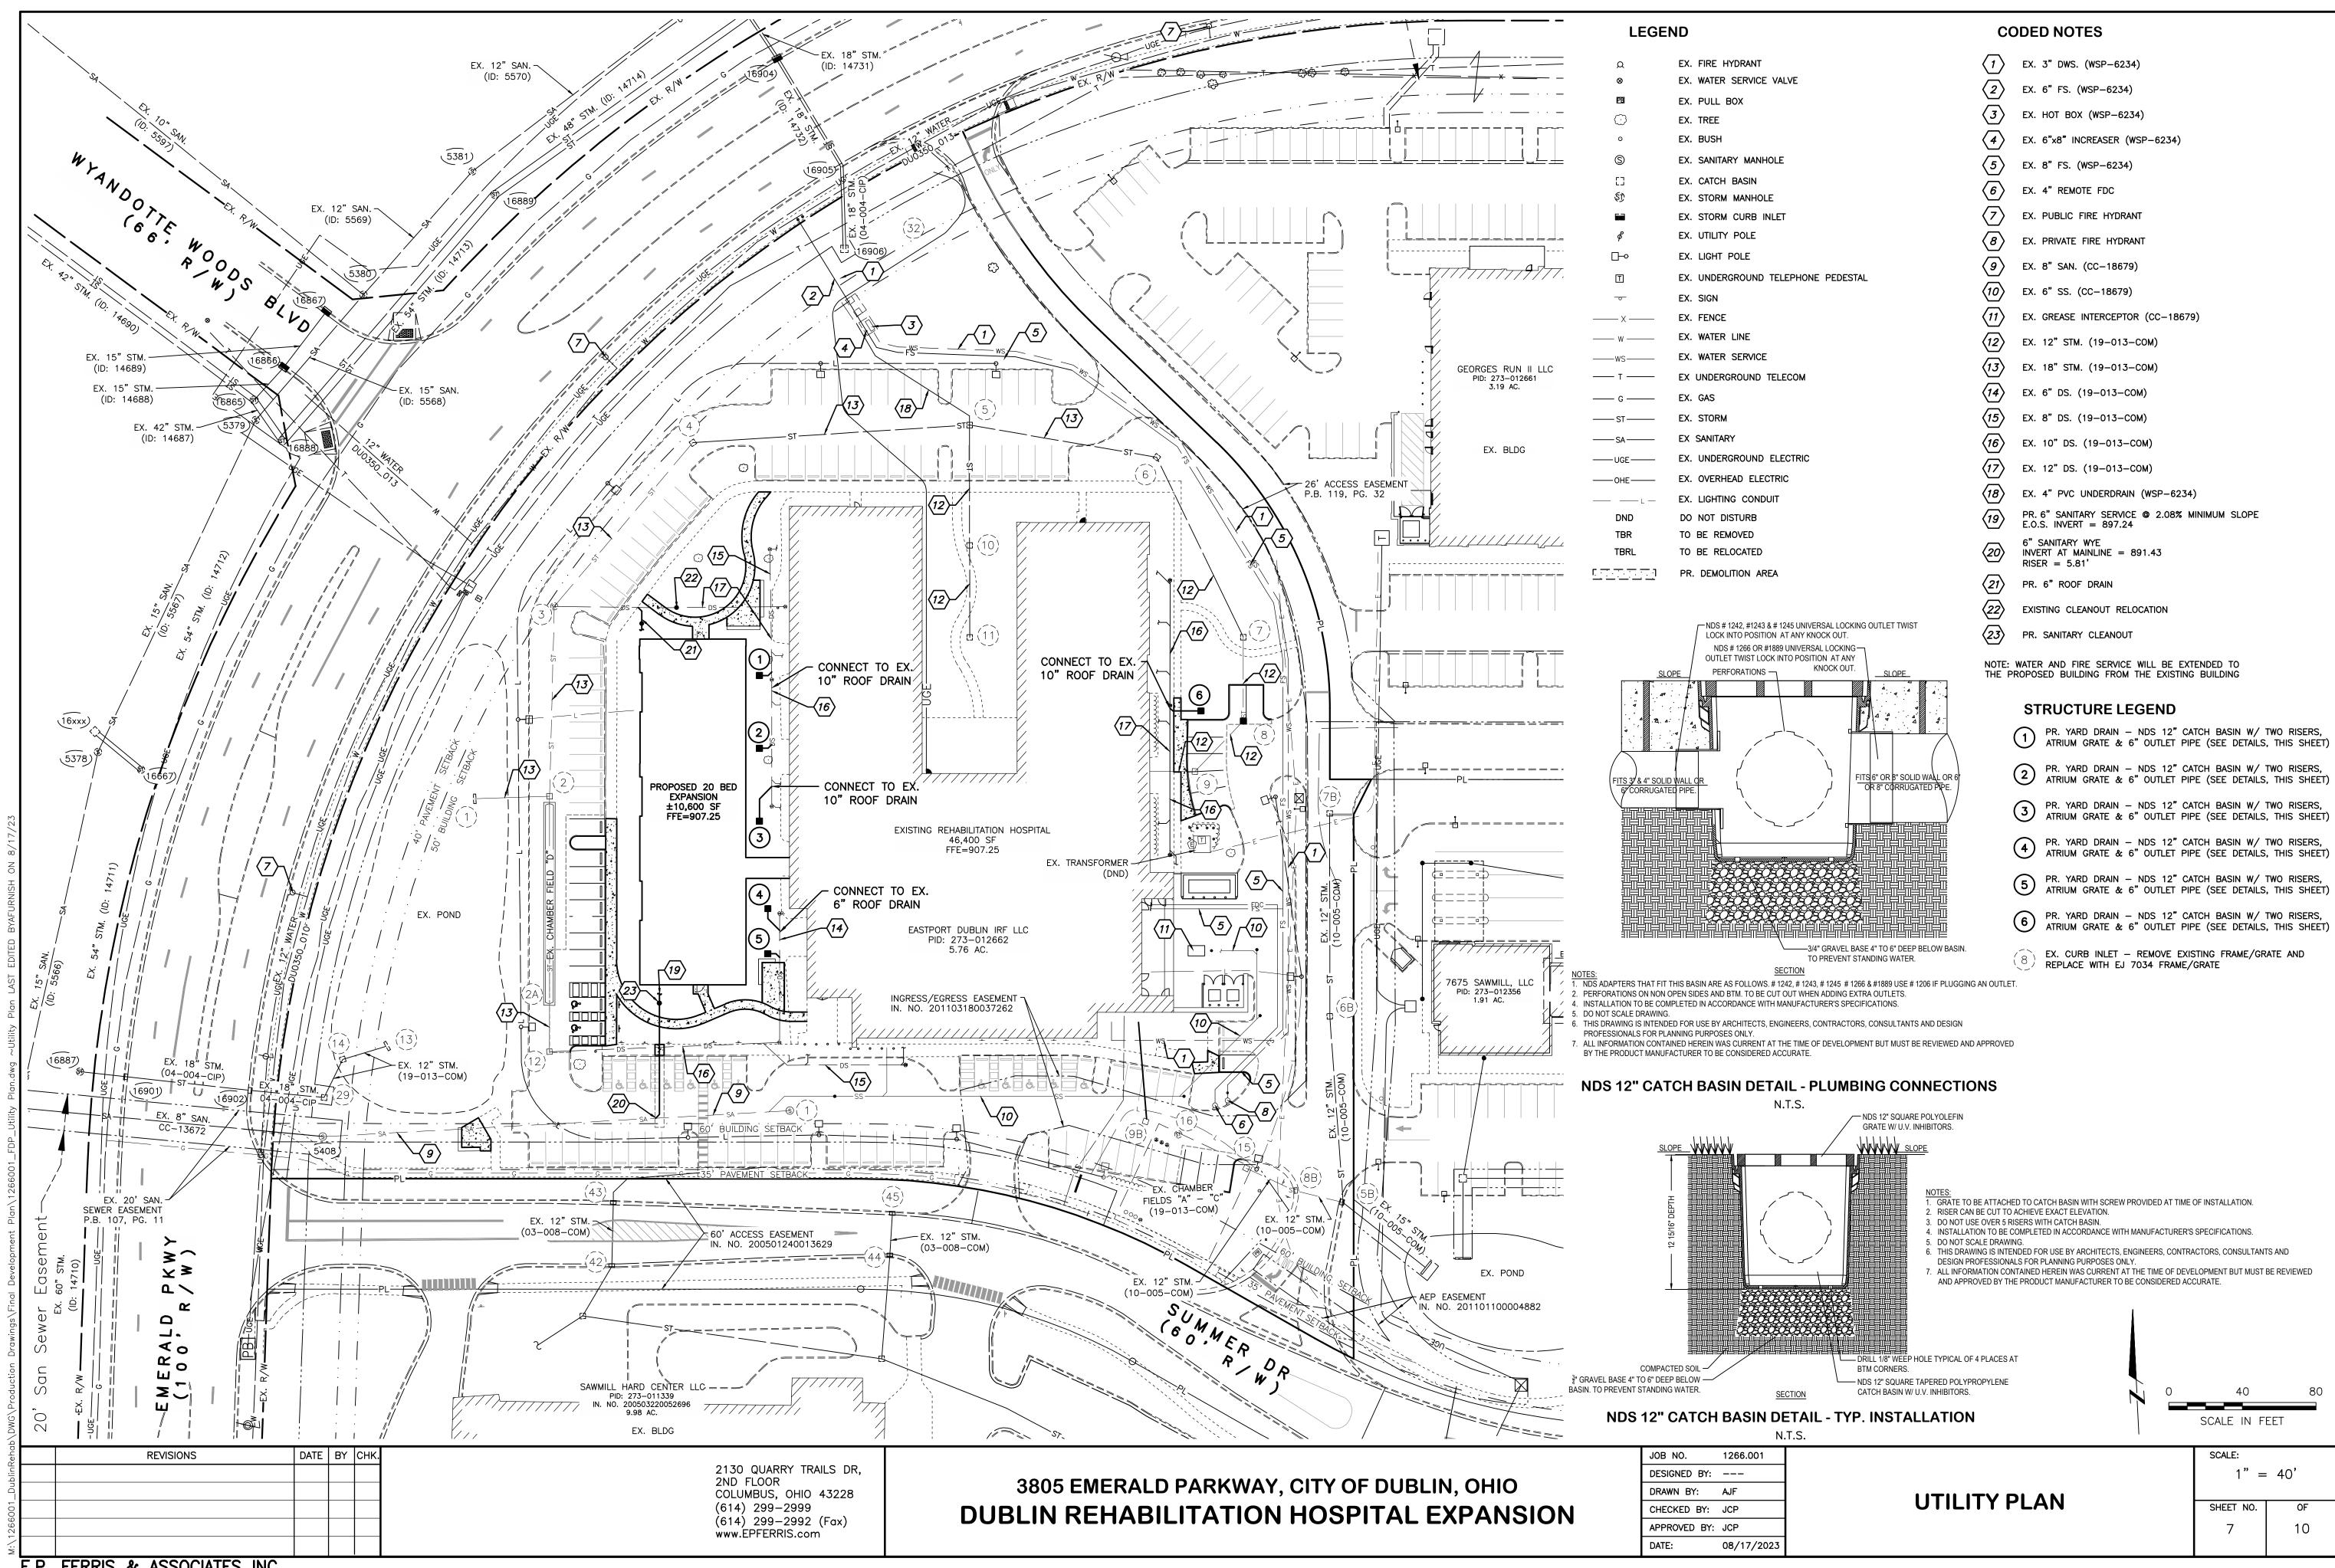


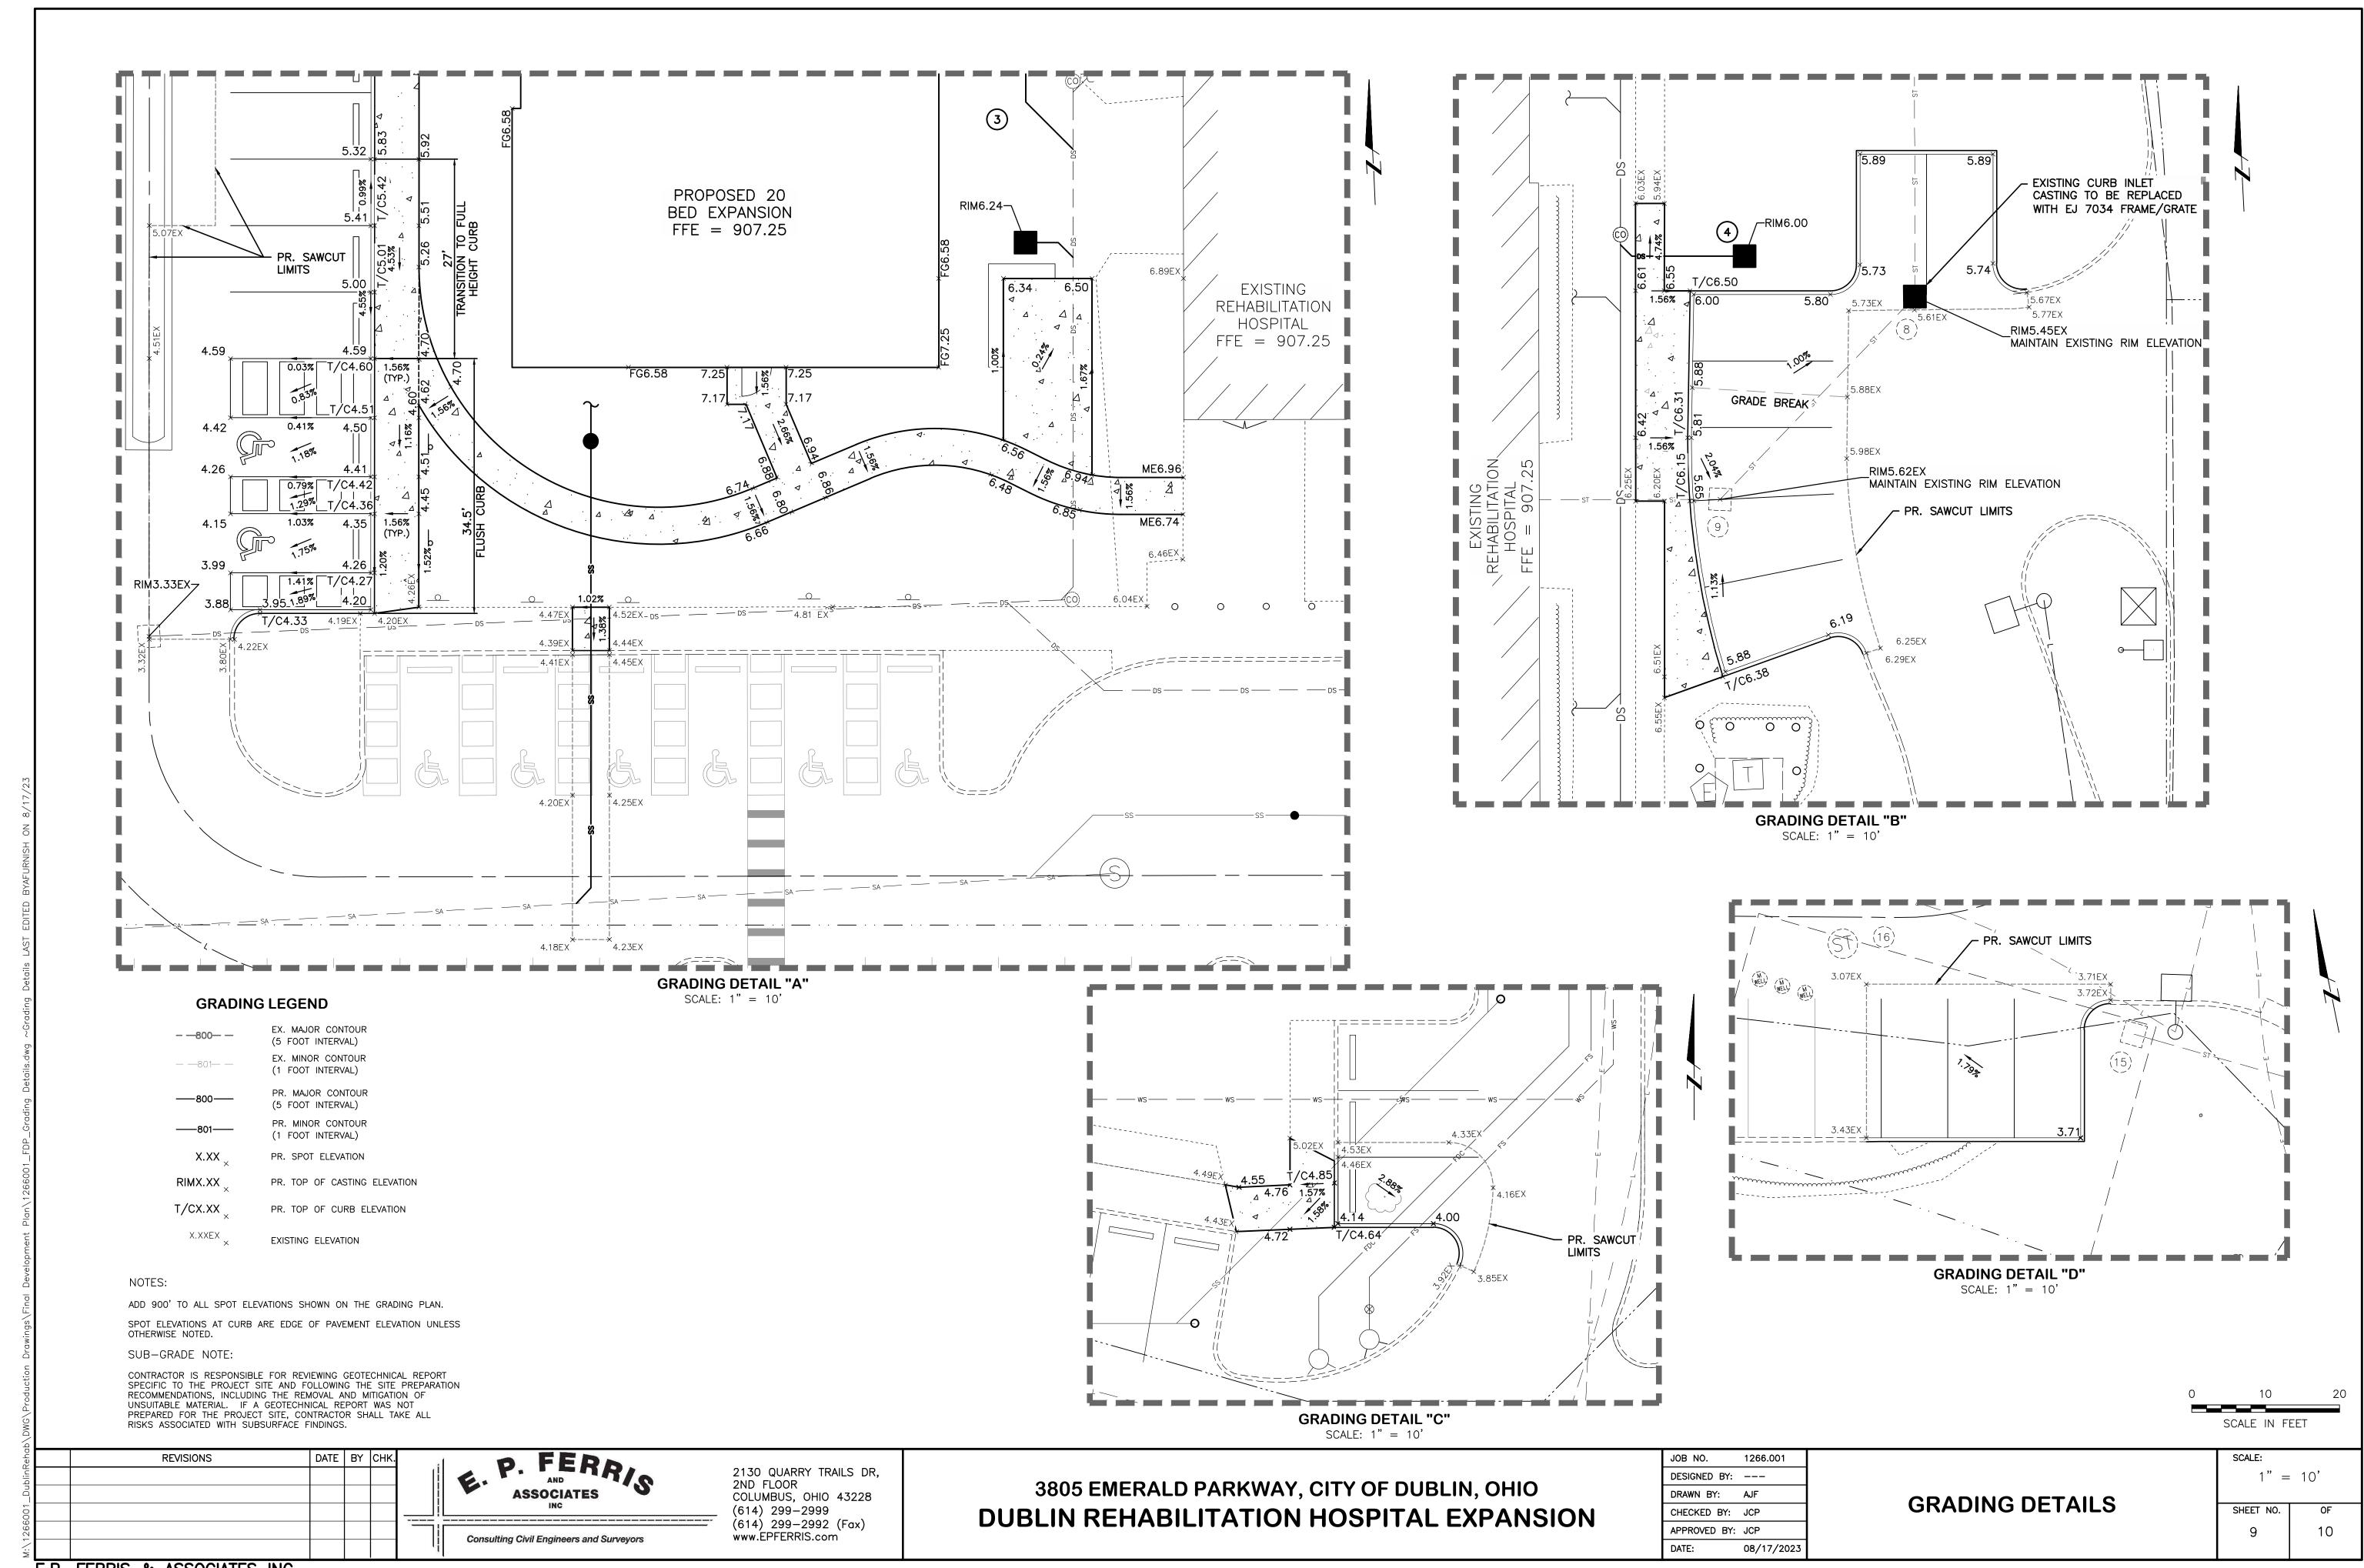

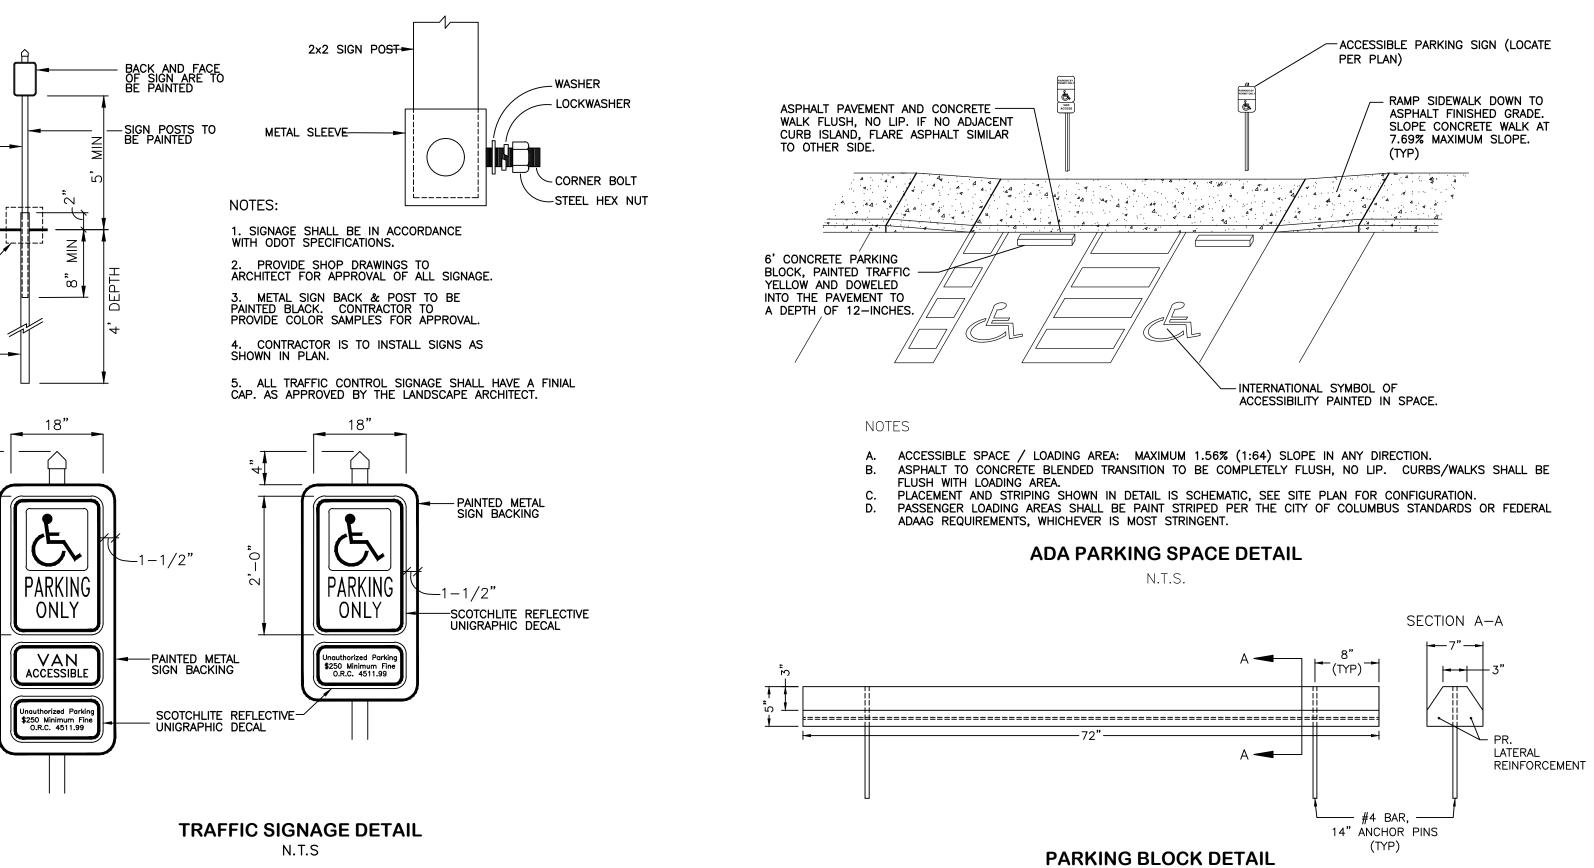

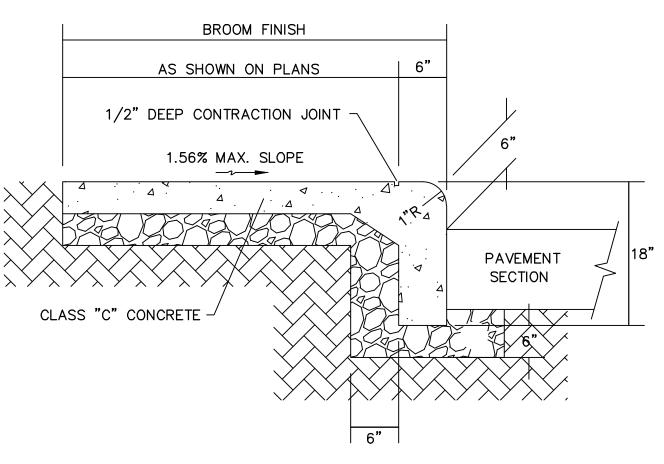


STANDARD COMBINED CURB AND WALK

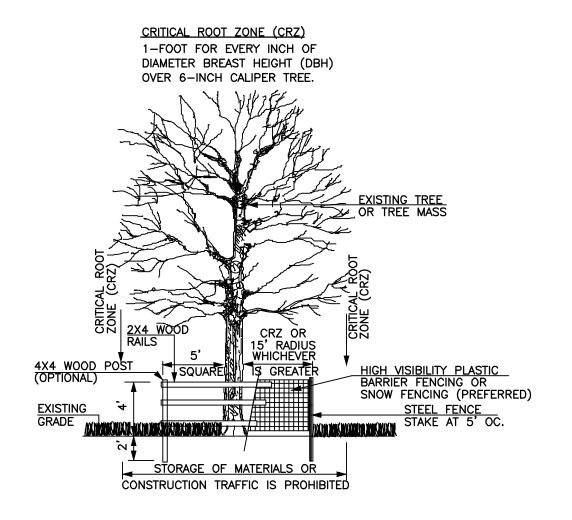

NOTES:
1. INSPECTION OF INSTALLATION IS REQUIRED. CALL (614) 410-4701.

2. THE CITY IS TO BE CONTACTED IF FENCE LOCATION NEEDS TO BE ADJUSTED OR PRIOR TO ANY ENCROACHMENT OF PRESERVATION AREA.

TREE PROTECTION DETAIL N.T.S.

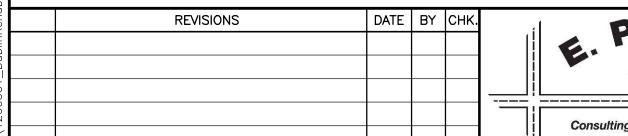



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3805 EMERALD PARKWAY, CITY OF DUBLIN, OHIO DUBLIN REHABILITATION HOSPITAL EXPANSION

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DESIGNED BY:		
DRAWN BY:	AJF	
CHECKED BY:	JCP	
APPROVED BY:	JCP	
DATE:	08/17/2023	

MISCELLANEOUS DETAILS

SCALE:

1" = 20'

SHEET NO. OF

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