OWNER/DEVELOPER/

APPLICANT: **CORWIN PROPERTIES** 30 S HIGH ST.

**DUBLIN, OH 43017** KWITT@BSDARCHITECTS.COM 614-735-2592

PLAN DESIGNER: OSBORN ENGINEERING 130 EAST CHESTNUT ST, SUITE 401

> COLUMBUS, OH 43215 PHONE: 614-556-4272 EMAIL: WDAVIS@OSBORN-ENG.COM

PID NO: 273-000008-00 ADDRESS: 30 SOUTH HIGH STREET

DEVELOPMENT: NEW WINE AND BOURBON BAR SITE GROUND COVER: CONCRETE SIDEWALK AND GRASS

DUBLIN, OHIO 43017

SITE GENERALLY SHEET FLOWS FROM

THE WEST TO THE EAST

ADJACENT AREAS: COMMERCIAL, RESIDENTIAL

#### **ZONING INFORMATION:**

BSC-HC: BRIDGE STREET DISTRICT -ZONING DISTRICT:

HISTORIC CORE

MAX. BUILDING HEIGHT 30'-0" MAX. LOT COVERAGE: 85% MAX. BUILDING FOOTPRINT:

30 S. HIGH BUILDING AREA: EXISTING = 338 SF

PROPOSED = 1147 SF ADDITION. 422 SF PAVILLION TOTAL = 1907 SF

32 S. HIGH BUILDING AREA: EXISTING = 1656 SF PROPOSED = 25 SF

TOTAL = 1681 SF GROSS BUILDING AREA: 3588 SF

FRONT BUILDING SETBACK: 0 FT SIDE BUILDING SETBACK: 5 FT REAR BUILDING SETBACK:

#### **ZONING CALCULATIONS:**

1. ONSITE PARKING CALCULATIONS

• REQUIRED: 30 S. HIGH: 1907 \* (10 SPACE / 1,000 SF) = 20 SPACES 32 S. HIGH: 1681 \* (10 SPACE / 1,000 SF) = 17 SPACES

TOTAL = 37 SPACES PROPOSED: 0 PARKING SPACES

2. BICYCLE PARKING CALCULATIONS

REQUIRED PARKING \* (1 BIKE / 10 SPACES) \* (1 RACK / 2 BIKES) = 10 SPACES \* (1 BIKE / 10 SPACES) \* (1 RACK / 2 BIKES) = 1 RACK

PROPOSED:

4. MINIMUM LOT SIZE

0.12, 0.13 ACRES PROPOSED: 0.12, 0.13 ACRES

5. MAXIMUM LOT COVERAGE

 MAXIMUM: 85% MAX (0.21 ACRES) PROPOSED: 40% (0.10 ACRES)

#### **REFUSE:**

65 GALLON LANDFILL AND RECYCLING TOTES WILL BE UTILIZED FOR REFUSE OWNER TO COORDINATE WITH SCHEDULED PICKUP

#### STANDARD DRAWINGS:

THE STANDARD DRAWINGS LISTED ON THIS PLAN SHALL BE CONSIDERED A PART THEREOF:

#### CITY OF DUBLIN

1. RD-01: TYPICAL STREET SECTION

2. RD-05: CONCRETE SIDEWALK AND SHARED-USED PATH


3. RD-11: STRAIGHT 18" CONCRETE CURB

4. RD-12: BRICK PAVER SIDEWALK

UNDERGROUND UTILITIES 2 WORKING DAYS BEFORE YOU DIG CALL 800-362-2764 (TOLL FREE) OHIO UTILITIES


PROTECTION SERVICE

MUST BE CALLED DIRECTLY

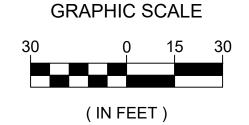

1 inch = 30 ft.

NORTH

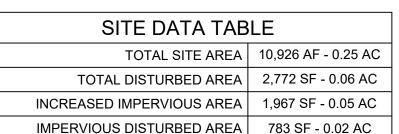

EAST BRIDGE STREET

## AMENDED FINAL DEVELOPMENT PLANS FOR

# CORWIN PROPERTIES LLC

THE APOTHECARY AND UNCORKED 30 SOUTH HIGH STREET CITY OF DUBLIN, FRANKLIN COUNTY, OHIO 43017

JENKINS DUBLIN LLC

6-12 S. HIGH ST.



1" = 1000'

#### **SURVEY NOTE:**

A TOPOGRAPHIC SURVEY PROVIDED BY LANDMARK SURVEY GROUP INCORPORATED DATED 11-2017.

#### **BENCHMARK:**

BENCHMARK #1 ~ TOP OF IRON PIN AT SOUTH WEST CORNER OF SITE N = 765037.78 E=1796861.74 ELEV=827.80

BENCHMARK #2 ~ RIM OF SANITARY SEWER 100 +/-NORTH OF SITE N =765229.15 E=1797007.86 ELEV=813.52

#### **BASIS OF BEARINGS:**

THE BEARINGS SHOWN HEREON ARE BASED ON THE OHIO STATE PLANE COORDINATE SYSTEM, SOUTH ZONE NAD 83 DATUM (2011), TAKEN FROM GPS OBSERVATION

#### **VERTICAL DATUM:**

ELEVATIONS ARE BASED ON NORTH AMERICAN VERTICAL DATUM 1988 (NAVD88). DATUMS WERE ESTABLISHED USING GPS REFERENCING ODOT VRS

#### FLOOD DESIGNATION

ACCORDING TO F.E.M.A. FLOOD INSURANCE RATE MAP #39049C0151K, DATED JUNE 17, 2008 FOR COMMUNITY NUMBER 390673, THIS PROPERTY IS IN ZONE X, AREA OF MINIMAL FLOOD HAZARD.

## CORWIN **PROPERTIES** LLC

**OSBORN** 

ENGINEERING

614-556-4272

0 East Chestnut St - Suite 401 | Columbus, OH 43212

THE **APOTHECARY** AND **UNCORKED** 

PROJECT LOCATION: 30 SOUTH HIGH STREET CITY OF DUBLIN, FRANKLIN COUNTY, OHIO 43017

1	ARB - REVISION	10/30/2023			
Unless otherwise stated in Contract, The Osborn Engineering Company					

TAG ISSUED

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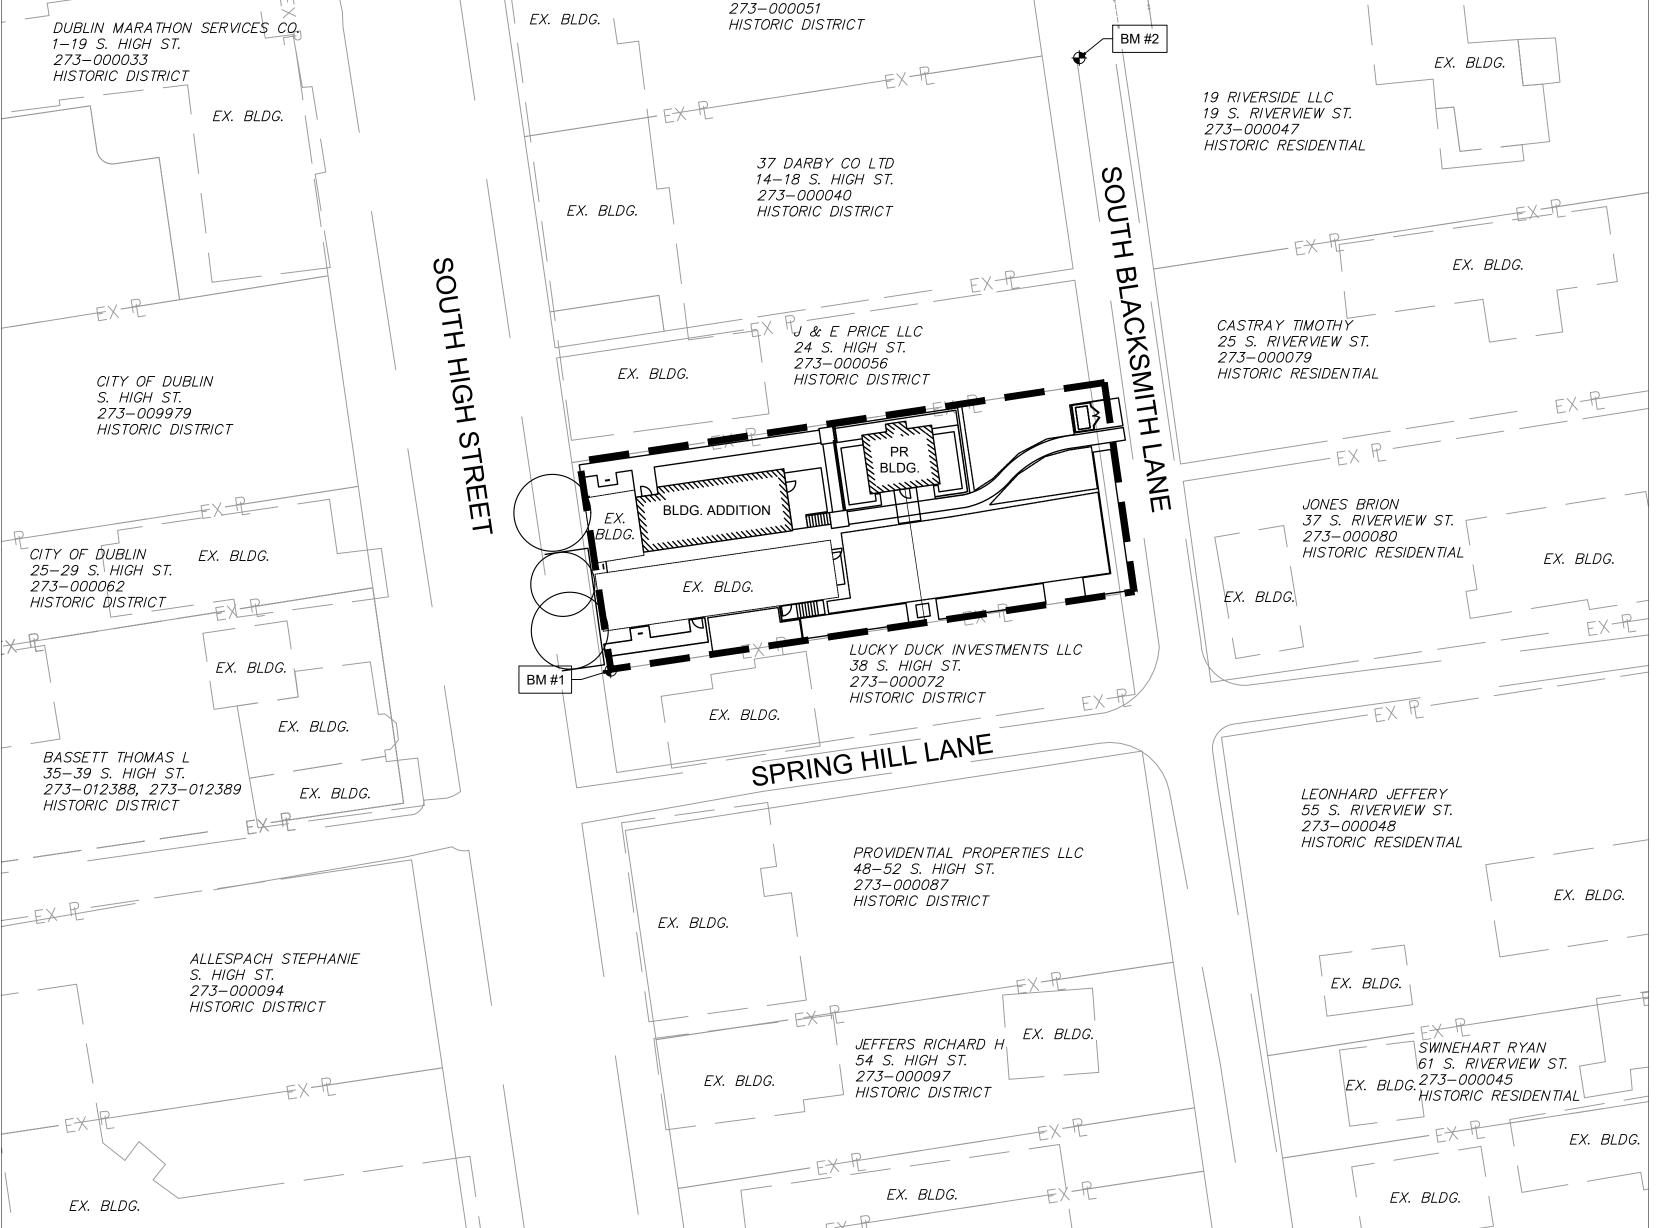
DRAWN BY WD CHECKED BY CLIENT PROJ. NO.

OSBORN PROJ. NO. J20211064.000

TITLE SHEET

DRAWING NO.

C-001



**INDEX MAP** 

SCALE - 1"=30'

Sheet Number Sheet Title C-001 TITLE SHEET C-001A **GENERAL NOTES EXISTING CONDITIONS** C-002 C-002A SURVEY C-003 DEMOLITION PLAN SITE PLAN C-100 C-101 CONSTRUCTION DETAILS C-102 CONSTRUCTION DETAILS C-200 **GRADING PLAN** C-201 RETAINING WALL PLAN C-300 UTILITY PLAN EROSION CONTROL PLAN

| EROSION CONTROL DETAILS

**INDEX OF SHEETS** 

CITY OF DUBLIN PROJECT NUMBER: 23-017-COM

2. THE CITY ENGINEER WILL NOT BE RESPONSIBLE FOR MEANS, METHODS, PROCEDURES CONTRACTOR TO PERFORM WORK ACCORDING TO CONTRACT DOCUMENTS.

PERMITS INCLUDING BUT NOT LIMITED TO OHIO EPA PERMITS TO INSTALL (PTI) AND NOTICES OF PROVIDED ACCORDING TO THE APPROVED CONSTRUCTION DRAWINGS AND CITY OF DUBLIN CONSISTENT WITH EROSION CONTROL PRACTICES. INTENT (NOI), BUILDING PERMITS, ETC.

AT LEAST 3 WORKING DAYS PRIOR TO BEGINNING CONSTRUCTION.

5. THE CONTRACTOR SHALL BE SOLELY RESPONSIBLE FOR COMPLYING WITH ALL FEDERA ACT OF 1970. THE CONTRACTOR SHALL EXERCISE PRECAUTION ALWAYS FOR THE PROTECTION OF APPROVAL BY THE CITY ENGINEER, CITY OF DUBLIN. PERSONS (INCLUDING EMPLOYEES) AND PROPERTY. IT SHALL ALSO BE THE SOLE RESPONSIBILITY OF THE CONTRACTOR TO INITIATE, MAINTAIN AND SUPERVISE ALL SAFETY REQUIREMENTS, 25.ALL INLETS SHALL BE CHANNELIZED. PRECAUTIONS AND PROGRAMS IN CONNECTION WITH THE WORK, INCLUDING THE REQUIREMENTS FOR CONFINED SPACES PER 29 CFR 1910.146.

6. FOLLOWING COMPLETION OF CONSTRUCTION OF THE SITE IMPROVEMENTS AND BEFORE REQUESTING OCCUPANCY, A PROOF SURVEY SHALL BE PROVIDED TO THE DIVISION OF ENGINEERING THAT DOCUMENTS "AS BUILT" ELEVATIONS, DIMENSIONS, SLOPES AND ALIGNMENTS OF ALL ELEMENTS OF THIS PROJECT. THE PROOF SURVEY SHALL BE PREPARED, SIGNED AND SUBMITTED BY THE PROFESSIONAL ENGINEER WHO SEALED THE CONSTRUCTIONS DRAWINGS.

AREAS DEFINED AS PERMANENT AND/OR TEMPORARY CONSTRUCTION EASEMENTS, UNLESS CITY OF DUBLIN SPECIFICATIONS. OTHERWISE AUTHORIZED BY THE CITY ENGINEER.

CASES OF WILLFUL OR CARELESS DESTRUCTION, THE CONTRACTOR SHALL BE RESPONSIBLE FOR REQUIREMENTS OF ODOT TC-41.20. RESTORATIONS. RESETTING OF MARKERS SHALL BE PERFORMED BY AN OHIO PROFESSIONAL SURVEYOR AS APPROVED BY THE CITY ENGINEER.

9. NON RUBBER TIRED VEHICLES SHALL NOT BE MOVED ON OR ACROSS PUBLIC STREETS OR 1. THE FOLLOWING UTILITIES ARE KNOWN TO BE LOCATED WITHIN THE LIMITS OF THIS PROJECT HIGHWAYS WITHOUT THE WRITTEN PERMISSION OF THE CITY ENGINEER.

10. THE CONTRACTOR SHALL RESTORE ALL DISTURBED AREAS TO EQUAL OR BETTER CONDITION THAN EXISTED BEFORE CONSTRUCTION. DRAINAGE DITCHES OR WATERCOURSES THAT ARE DISTURBED BY CONSTRUCTION SHALL BE RESTORED TO THE GRADES AND CROSS\_SECTIONS THAT EXISTED BEFORE CONSTRUCTION.

11.TRACKING OR SPILLING MUD, DIRT OR DEBRIS UPON STREETS, RESIDENTIAL OR COMMERCIAL DRIVES, SIDEWALKS OR BIKE PATHS IS PROHIBITED ACCORDING TO SECTION 97.38 OF THE DUBLIN CODE OF ORDINANCES. ANY SUCH OCCURRENCE SHALL BE CLEANED UP IMMEDIATELY BY THE CONTRACTOR AT NO COST TO THE CITY. IF THE CONTRACTOR FAILS TO REMOVE SAID MUD, DIRT AFFECTED AREAS, THE COST OF WHICH SHALL BE THE RESPONSIBILITY OF THE CONTRACTOR.

12.DISPOSAL OF EXCESS EXCAVATION WITHIN SPECIAL FLOOD HAZARD AREAS (100-YEAR FLOODPLAIN) IS NOT PERMITTED.

OF THE CONTRACTOR.

REPAIRED AND CONNECTED TO THE PUBLIC STORM SEWER SYSTEM AS DIRECTED BY THE CITY CONTINGENT DAMAGE. ENGINEER. THE COST OF THIS WORK SHALL BE THE RESPONSIBILITY OF THE CONTRACTOR.

MANUFACTURE. APPROVED PRECAST CONCRETE PRODUCTS WILL BE STAMPED OR HAVE SUCH DRAWINGS, SHALL BE THE RESPONSIBILITY OF THE CONTRACTOR. IDENTIFICATION NOTING THAT INSPECTION HAS BEEN CONDUCTED BY THE CITY OF COLUMBUS. PRECAST CONCRETE PRODUCTS WITHOUT PROOF OF INSPECTION SHALL NOT BE APPROVED FOR 5. WHEN UNKNOWN OR INCORRECTLY LOCATED UNDERGROUND UTILITIES ARE ENCOUNTERED INSTALLATION.

16.BACKFILL WITHIN A 1:1 INFLUENCE LINE OF EXISTING STRUCTURES (HOUSES, GARAGES, ETC.) OR PUBLIC INFRASTRUCTURE (PAVEMENT, CURBS, SIDEWALKS, BIKE PATHS, ETC.) SHALL BE 6. PUBLIC STREET LIGHTING MAY BE IN THE VICINITY OF THIS PROJECT. CONTACT THE CITY OF COMPACTED GRANULAR BACKFILL ACCORDING TO ITEM 912 OF THE STANDARD SPECIFICATIONS DUBLIN, DIVISION OF ENGINEERING AT 410-4637, TWO DAYS PRIOR TO BEGINNING WORK. OR FLOWABLE CDF, TYPE II ACCORDING TO ITEM 613. ITEM 911 OF THE STANDARD SPECIFICATIONS SHALL BE USED ELSEWHERE.

A LIST OF PROPOSED PRECAST CONCRETE PRODUCT MANUFACTURERS TO THE CITY OF CONTRACTOR ACCORDING TO OHIO MANUAL OF UNIFORM TRAFFIC CONTROL DEVICES (OMUTCD), COLUMBUS CONSTRUCTION INSPECTION DIVISION BEFORE COMMENCING CONSTRUCTION.

SEND THE INFORMATION TO THE FOLLOWING ADDRESS

CONSTRUCTION INSPECTION DIVISION CITY OF COLUMBUS 1800 EAST 17TH AVENUE

SEND A COPY OF THE TRANSMITTAL LETTER TO THE FOLLOWING ADDRESS

DIVISION OF ENGINEERING CITY OF DUBLIN 6555 SHIER RINGS ROAD

COLUMBUS, OHIO 43219

DUBLIN, OHIO 43016 18.ALL TRENCHES WITHIN PUBLIC RIGHT-OF-WAY SHALL BE BACKFILLED ACCORDING TO THE APPROVED CONSTRUCTION DRAWINGS OR SECURELY PLATED DURING NONWORKING HOURS. TRENCHES OUTSIDE THESE AREAS SHALL BE BACKFILLED OR SHALL BE PROTECTED BY APPROVED TEMPORARY FENCING OR BARRICADES DURING NONWORKING HOURS. CLEAN UP SHALL FOLLOW CLOSELY BEHIND THE TRENCHING OPERATION.

19. ALL TREES WITHIN THE CONSTRUCTION AREA NOT SPECIFICALLY DESIGNATED FOR REMOVAL SHALL BE PRESERVED, WHETHER SHOWN OR NOT SHOWN ON THE APPROVED CONSTRUCTION DRAWINGS. TREES TO BE PRESERVED SHALL BE PROTECTED WITH HIGH VISIBILITY FENCING PLACED A MINIMUM 15 FEET FROM THE TREE TRUNK. TREES 6 - INCHES OR GREATER AT DBH (DIAMETER BREAST HEIGHT) MUST BE PROTECTED WITH FENCING PLACED AT THE CRITICAL ROOT ZONE OR 15 FEET, WHICHEVER IS GREATER. TREES NOT INDICATED ON THE APPROVED EROSION AND SEDIMENT CONTROL CONSTRUCTION DRAWINGS FOR REMOVAL MAY NOT BE REMOVED WITHOUT PRIOR APPROVAL OF THE DIVISION OF ENGINEERING.

20. CONDUIT MUST BE DIRECTIONALLY BORED ACROSS STREETS INSTEAD OF OPEN CUT, UNLESS SPECIFICALLY APPROVED BY THE CITY ENGINEER. USE OF PNEUMATIC AIR RAM DEVICES IS NOT PERMITTED. PERMITS TO CONSTRUCT IN THE RIGHT-OF-WAY OF EXISTING STREETS MUST BE

UNLESS OTHERWISE NOTED. IF A CONFLICT BETWEEN SPECIFICATIONS IS FOUND, THE MORE 21.THE CONTRACTOR SHALL BE RESPONSIBLE FOR THE CONDITION OF TRENCHES WITHIN THE PERMIT MAY BE REQUIRED. THE CONTRACTOR SHALL BE CONSIDERED THE PERMITTEE.

CONDUCTED ACCORDING TO CITY OF COLUMBUS STANDARD DRAWING 1441 DR. A AND GROUND COVER. HAY OR STRAW BALES ARE NOT PERMITTED. APPLICABLE CITY OF DUBLIN STANDARD DRAWINGS. THE REPLACEMENT OF DRIVEWAYS, STANDARD CONSTRUCTION DRAWINGS.

ARBORIST. AT THE COMPLETION OF THE PROJECT, THE ARBORIST IS TO RETURN AND TRIM ANY BROKEN BRANCHES AS NEEDED.

STATE AND LOCAL SAFETY REQUIREMENTS INCLUDING THE OCCUPATIONAL SAFETY AND HEALTH 24.ANY MODIFICATION TO THE WORK SHOWN ON DRAWINGS MUST HAVE PRIOR WRITTEN GROWTH OF PERMANENT GROUND COVER.

26.PARK AREAS SHALL BE FINE\_GRADED AND SEEDED WITH THE FOLLOWING MIXTURE:

IMPROVED KENTUCKY BLUEGRASS: 40% OF WEIGHT (2 VARIETIES IN EQUAL PARTS) IMPROVED PERENNIAL RYE: 60% OF WEIGHT (2 VARIETIES IN EQUAL PARTS) GERMINATION RATE: 85%

APPLICATION RATE: 7 LBS PER 1000 SQ FT OR AS DIRECTED BY THE DIVISION OF PARKS AND SANITARY SEWERS RECREATION, CITY OF DUBLIN, OHIO.

7. THE CONTRACTOR SHALL RESTRICT CONSTRUCTION ACTIVITY TO PUBLIC RIGHT\_OF\_WAY AND ANCHOR BASE INSTALLATION AND MEET ALL REQUIREMENTS OF ODOT TC-41.20 AND APPLICABLE TYPE II OF THE STANDARD SPECIFICATIONS AS DIRECTED BY THE CITY ENGINEER.

8. THE CONTRACTOR SHALL CAREFULLY PRESERVE BENCHMARKS, PROPERTY CORNERS, COLORED IN WHITE DISPLAYED OVER A BROWN BACKGROUND. SIGN TUBING SHALL BE BROWN IN TO ITEM 901.21 OF THE STANDARD SPECIFICATIONS. REFERENCE POINTS, STAKES AND OTHER SURVEY REFERENCE MONUMENTS OR MARKERS. IN COLOR AND CONFORM WITH THE TYPE S, SQUARE POST ANCHOR BASE INSTALLATION

PH (614) 818-2104

COLUMBIA GAS OF OHIO

COLUMBUS DIVISON OF WATER PH: (330) 253-8267

PH (740) 348-5322

CITY OF DUBLIN STREETS & UTILITIES TELEPHONE:

PH: (614) 410-4750 PH (614) 223-7276 AMERICAN ELECTRIC POWER

PROTECTION SERVICE (TELEPHONE NUMBER 614\_587\_0486), AND TO OWNERS OF UNDERGROUND DUBLIN CODE OF ORDINANCES. UTILITIES THAT ARE NOT MEMBERS OF A REGISTERED UNDERGROUND PROTECTION SERVICE. NOTICE SHALL BE GIVEN AT LEAST 2 WORKING DAYS BEFORE START OF CONSTRUCTION.

13. ALL SIGNS, LANDSCAPING, STRUCTURES OR OTHER APPURTENANCES WITHIN RIGHT-OF-WAY 3. THE IDENTITY AND LOCATIONS OF EXISTING UNDERGROUND UTILITIES IN THE CONSTRUCTION PRACTICABLE. WHERE SANITARY SEWERS CROSS WATER MAINS OR OTHER SEWERS OR OTHER ENGINEER. THIS INCLUDES APPLICATIONS INSIDE THE RIGHT-OF-WAY. DISTURBED OR DAMAGED DURING CONSTRUCTION SHALL BE REPLACED OR REPAIRED TO THE AREA HAVE BEEN SHOWN ON THE APPROVED CONSTRUCTION DRAWINGS AS ACCURATELY AS UTILITIES, TRENCH BACKFILL SHALL BE PLACED BETWEEN THE PIPES CROSSING AND SHALL BE SATISFACTION OF THE CITY ENGINEER. THE COST OF THIS WORK SHALL BE THE RESPONSIBILITY PROVIDED BY THE OWNER OF THE UNDERGROUND UTILITY. THE CITY OF COLUMBUS STANDARD FACILITIES SHOWN ON THE APPROVED CONSTRUCTION DRAWINGS. IF DAMAGE IS CAUSED, THE SANITARY SEWER SHALL BE CONCRETE ENCASED OR CONSIST OF DUCTILE IRON PIPE MATERIAL. 14. ALL FIELD TILE BROKEN OR ENCOUNTERED DURING EXCAVATION SHALL BE REPLACED OR CONTRACTOR SHALL BE RESPONSIBLE FOR REPAIR OF THE SAME AND FOR ANY RESULTING

4. LOCATION, SUPPORT, PROTECTION AND RESTORATION OF ALL EXISTING UTILITIES AND PROPOSED GROUND ELEVATION IF BASEMENT SERVICE IS INTENDED. 15. ALL PRECAST CONCRETE PRODUCTS SHALL BE INSPECTED AT THE LOCATION OF APPURTENANCES, WHETHER SHOWN OR NOT SHOWN ON THE APPROVED CONSTRUCTION

DURING CONSTRUCTION, THE CONTRACTOR SHALL IMMEDIATELY NOTIFY THE OWNER AND THE

17. THE CONTRACTOR SHALL SUBMIT A COPY OF THE APPROVED CONSTRUCTION DRAWINGS AND 1. TRAFFIC CONTROL SHALL BE FURNISHED, ERECTED, MAINTAINED, AND REMOVED BY THE ITEMS. CURRENT EDITION.

> 2. ALL TRAFFIC LANES OF PUBLIC ROADWAYS SHALL BE FULLY OPEN TO TRAFFIC FROM 7:00 AM TO 9:00 AM AND FROM 4:00 PM TO 6:00 PM UNLESS AUTHORIZED DIFFERENTLY BY THE CITY 1. ALL WATER LINE MATERIALS SHALL BE PROVIDED AND INSTALLED ACCORDING TO CURRENT USE OF FIRE HYDRANTS ENGINEER. AT ALL OTHER HOURS THE CONTRACTOR SHALL MAINTAIN MINIMUM ONE\_LANE SPECIFICATIONS OF THE CITY OF COLUMBUS DIVISION OF WATER. TWO WAY TRAFFIC. UNIFORMED, OFF-DUTY POLICE OFFICERS SHALL REPLACE FLAGMEN ENGINEER.

3. IF THE CITY ENGINEER DETERMINES THAT THE CONTRACTOR IS NOT PROVIDING PROPER DIVISION OF WATER PRIOR TO APPROVAL OF THE CONSTRUCTION DRAWINGS. PROVISIONS FOR TRAFFIC CONTROL, THE CITY ENGINEER SHALL ASSIGN UNIFORMED, OFF DUTY POLICE OFFICERS TO THE PROJECT AT NO COST TO THE CITY.

SIMILAR TRAFFIC CONTROL DEVICES IN USE AT NIGHT.

5. ACCESS FROM PUBLIC ROADWAYS TO ALL ADJOINING PROPERTIES FOR EXISTING RESIDENTS 4. ALL WATER LINES SHALL BE DISINFECTED ACCORDING TO ITEM 801.13 OF THE STANDARD OR BUSINESSES SHALL BE MAINTAINED THROUGHOUT THE DURATION OF THE PROJECT FOR MAIL, SPECIFICATIONS. SPECIAL ATTENTION IS DIRECTED TO APPLICABLE SECTIONS OF AMERICAN PUBLIC WATER AND SANITARY SEWER SERVICE, AND EMERGENCY VEHICLES. THE CONTRACTOR WATER WORKS ASSOCIATION SPECIFICATION C\_651, PARTICULARLY FOR FLUSHING (SECTION 5) SHALL PROVIDE A TRAFFIC CONTROL PLAN DETAILING THE PROPOSED MAINTENANCE OF TRAFFIC AND FOR CHLORINATING VALVES AND FIRE HYDRANTS (SECTION 7). PRESSURE TESTING SHALL BE PROCEDURES. THE TRAFFIC CONTROL PLAN MUST INCORPORATE ANY TRAFFIC CONTROL PERFORMED IN ACCORDANCE WITH SECTION 801.12 OF THE CITY OF COLUMBUS CONSTRUCTION DETAILS CONTAINED HEREIN. THE TRAFFIC CONTROL PLAN PROPOSED BY THE CONTRACTOR AND MATERIAL SPECIFICATIONS. WHEN WATER LINES ARE READY FOR DISINFECTION, THE CITY MUST BE APPROVED BY THE CITY ENGINEER PRIOR TO CONSTRUCTION.

(NOI) TO BE REVIEWED AND APPROVED BY THE OHIO EPA. THE NOI MUST BE SUBMITTED TO OEPA OF COLUMBUS CONSTRUCTION AND MATERIAL SPECIFICATIONS. 45 DAYS PRIOR TO THE START OF CONSTRUCTION AND MAY ENTITLE COVERAGE UNDER THE OHIO

OBTAINED FROM THE CITY OF DUBLIN DIVISION OF ENGINEERING BEFORE COMMENCING SEDIMENT AND EROSION CONTROL PLAN HAS NOT ALREADY BEEN INCLUDED WITH THE CITY ENGINEER. A TAP PERMIT FOR EACH WATER SERVICE MUST BE OBTAINED FROM THE CITY OF CONSTRUCTION. SHOULD OPEN CUTTING OF EXISTING PAVEMENT BE PERMITTED, CONTROLLED APPROVED CONSTRUCTION DRAWINGS. THIS PLAN MUST BE MADE AVAILABLE AT THE PROJECT DUBLIN AND THE CITY OF COLUMBUS DIVISION OF WATER BEFORE MAKING ANY TAPS INTO PUBLIC 1. CITY OF COLUMBUS AND OHIO DEPARTMENT OF TRANSPORTATION CONSTRUCTION AND DENSITY BACKFILL (TYPE II) SHALL BE USED IN PLACE OF COMPACTED GRANULAR BACKFILL, SITE AT ALL TIMES. THE DESIGN OF EROSION CONTROL SYSTEMS SHALL FOLLOW THE WATER LINES. REQUIREMENTS OF OHIO EPA, ITEM 207 OF OHIO DEPARTMENT OF TRANSPORTATION STANDARD SPECIFICATIONS, AND THE CITY ENGINEER. AN INDIVIDUAL NPDES STORMWATER DISCHARGE

ACCEPTANCE OF THE WORK, AND SHALL MAKE ANY NECESSARY REPAIRS AT NO COST TO THE RUNOFF LEAVES THE PROJECT, INCLUDING WATERWAYS, OVERLAND SHEET FLOW, AND STORM EXISTING WATER LINES.

TECHNIQUES, OR SEQUENCES OF CONSTRUCTION THAT ARE NOT SPECIFIED HEREIN. THE CITY 22.PAVEMENTS SHALL BE CUT IN NEAT, STRAIGHT LINES THE EXISTING 3. ACCEPTED METHODS OF PROVIDING EROSION/SEDIMENT CONTROL INCLUDE BUT ARE NOT OF COLUMBUS STANDARDS. ENGINEER WILL NOT BE RESPONSIBLE FOR SAFETY ON THE WORK SITE, OR FOR FAILURE BY THE PAVEMENT, OR AS REQUIRED BY THE CITY ENGINEER. PAVEMENT SHALL BE LIMITED TO: SEDIMENT BASINS, SILT FILTER FENCE, AGGREGATE CHECK DAMS, AND TEMPORARY

5. DISTURBED AREAS THAT WILL REMAIN UNWORKED FOR 30 DAYS OR MORE SHALL BE SEEDED 9. WATER METERS SHALL BE INSTALLED INSIDE PROPOSED STRUCTURES UNLESS A METER PIT 4. THE CONTRACTOR SHALL NOTIFY THE CITY OF DUBLIN DIVISION OF ENGINEERING IN WRITING 23.TREE TRIMMING WITHIN THE CONSTRUCTION ZONE IS TO BE COMPLETED BY A CERTIFIED OR PROTECTED WITHIN SEVEN CALENDAR DAYS OF THE DISTURBANCE. OTHER SEDIMENT INSTALLATION IS APPROVED BY THE CITY OF COLUMBUS DIVISION OF WATER. METER PITS MUST CONTROLS THAT ARE INSTALLED SHALL BE MAINTAINED UNTIL VEGETATIVE GROWTH HAS BEEN CONFORM TO STANDARD DRAWINGS L-7103, A&B FOR 5/8" THROUGH 1" METERS OR L-6317, A, B, ESTABLISHED. THE CONTRACTOR SHALL BE RESPONSIBLE FOR THE REMOVAL OF ALL C&D FOR 1-1/2" OR LARGER METERS. TEMPORARY SEDIMENT DEVICES AT THE CONCLUSION OF CONSTRUCTION BUT NOT BEFORE

#### BLASTING (IF PERMITTED)

DEPARTMENT PRIOR TO BLASTING FOR ROCK EXCAVATION. THE CONTRACTOR SHALL SUBMIT AT FINISHED GRADE. BLASTING REPORTS UPON COMPLETION OF BLASTING TO THE CITY ENGINEER, THE OWNER, AND THE OWNER'S ENGINEER. TOP OF ROCK ELEVATIONS SHALL BE SHOWN ON "AS\_BUILT" 12.IF THE TOP OF THE OPERATING NUT OF ANY VALVE IS GREATER THAN 36 INCHES BELOW CONSTRUCTION DRAWINGS.

27.TRAFFIC CONTROL AND OTHER REGULATORY SIGNS SHALL BE TYPE S WITH A SQUARE POST THE STANDARD SPECIFICATIONS OR CONTROLLED DENSITY BACKFILL ACCORDING TO ITEM 613, WHERE NECESSARY TO CLEAR EXISTING OR PROPOSED UTILITY LINES OR OTHER UNDERGROUND

2. ALL PVC SEWER PIPES SHALL BE DEFLECTION TESTED NO LESS THAN 60 DAYS AFTER 28. STREET SIGNS SHALL MEET ALL CITY OF DUBLIN SPECIFICATIONS WITH LETTERING COMPLETION OF BACKFILLING OPERATIONS. ALL OTHER REQUIREMENTS SHALL BE ACCORDING STORM SEWER

> 3. ALL SANITARY SEWERS INCLUDING SANITARY SEWER SERVICE LINES SHALL BE SUBJECTED TO PRIVATE STORM SEWER CONNECTING TO THE PUBLIC STORM SEWER SHALL BE REINFORCED AND PASS INFILTRATION OR EXFILTRATION TESTS ACCORDING TO ITEM 901 OF THE STANDARD CONCRETE PIPE CONFORMING TO ASTM DESIGNATION C76, WALL B, CLASS IV FOR PIPE SPECIFICATIONS AND MUST BE APPROVED FOR USE BY THE CITY ENGINEER BEFORE ANY SERVICE DIAMETERS 12 INCHES TO 15 INCHES, CLASS III FOR 18 INCHES TO 24 INCH PIPES, AND 27 INCHES CONNECTIONS ARE TAPPED INTO SEWERS.

4. FOR SANITARY SEWER INFILTRATION, LEAKAGE THROUGH JOINTS SHALL NOT EXCEED 100 ENGINEERING. GALLONS PER INCH OF TRIBUTARY SEWER DIAMETER PER 24 HOURS PER MILE OF LENGTH OR THE COMPUTED EQUIVALENT. ALL SANITARY SEWERS SHALL BE TESTED.

5. AT THE DETERMINATION OF THE CITY ENGINEER, THE CONTRACTOR MAY BE REQUIRED TO TYPE II OF THE STANDARD SPECIFICATIONS AS DIRECTED BY THE CITY ENGINEER. PERFORM A TV INSPECTION OF THE SANITARY SEWER SYSTEM PRIOR TO FINAL ACCEPTANCE BY THE CITY. THIS WORK SHALL BE COMPLETED BY THE CONTRACTOR AT HIS EXPENSE.

6. VISIBLE LEAKS OR OTHER DEFECTS OBSERVED OR DISCOVERED DURING TV INSPECTION SHALL BE REPAIRED TO THE SATISFACTION OF THE ENGINEER.

DEBRIS, OR SPILLAGE, THE CITY RESERVES THE RIGHT TO REMOVE THESE MATERIALS AND CLEAN 2. THE CONTRACTOR SHALL GIVE NOTICE OF INTENT TO CONSTRUCT TO OHIO UTILITIES 7. ROOF DRAINS, FOUNDATION DRAINS, FIELD TILE OR OTHER CLEAN WATER CONNECTIONS TO 4. STORM INLETS OR CATCH BASINS SHALL BE CHANNELIZED AND HAVE BICYCLE SAFE GRATES. PROTECTION SERVICE (TELEPHONE NUMBER 800\_362\_2764), PRODUCER'S UNDERGROUND THE SANITARY SEWER SYSTEM ARE STRICTLY PROHIBITED ACCORDING TO SECTION 51.23 OF THE MANHOLE LIDS SHALL INCLUDE CITY OF DUBLIN LOGO AND ALL CURB INLET AND CATCH BASIN

> 8. ALL WATER LINES SHALL BE LOCATED AT LEAST 10 FEET HORIZONTALLY AND 18 INCHES 5. HP STORM AND HP SANITITE OR APPROVED EQUAL ARE APPROVED ALTERNATIVES TO ENGINEER ASSUMES NO RESPONSIBILITY FOR THE ACCURACY OR DEPTHS OF UNDERGROUND IN THE EVENT THAT A WATER LINE MUST CROSS WITHIN 18 INCHES OF A SANITARY SEWER, THE CONSTRUCTION DRAWING AA-S149.

> > 9. SERVICE RISERS SHALL BE INSTALLED WHERE THE DEPTH FROM WYES TO PROPOSED GROUND CITY OF COLUMBUS CONSTRUCTION MATERIAL SPECIFICATIONS (CMS). ELEVATION EXCEEDS 10 FEET. TOPS OF RISERS SHALL BE NO LESS THAN 9 FEET BELOW

10. WHERE SERVICE RISERS ARE NOT INSTALLED, A MINIMUM 5 FOOT LENGTH OF SANITARY SEWER SERVICE PIPE OF THE SAME SIZE AS THE WYE OPENING SHALL BE INSTALLED.

11. THE CONTRACTOR SHALL FURNISH AND PLACE, AS DIRECTED, APPROVED WYE POLES MADE OF ACCEPTANCE BY THE CITY. THE COST OF THESE POLES SHALL BE INCLUDED IN THE CONTRACT UNIT PRICE FOR THE VARIOUS SEWER ITEMS.

AND BYPASSING SHALL BE INCLUDED IN THE CONTRACTOR'S UNIT PRICE BID FOR THE RELATED

3. PUBLIC WATER LINES SHALL BE DISINFECTED BY THE CITY OF COLUMBUS DIVISION OF WATER REQUESTS FOR WATER LINE CHLORINATION SHALL BE MADE THROUGH THE CITY OF DUBLIN 2. BEFORE THE FINAL ESTIMATE IS PAID, THE CONTRACTOR SHALL SUBMIT A LETTER FROM THE CONTRACTOR

OF DUBLIN SHALL SUBMIT TWO (2) SETS OF "AS-BUILT" PLANS, AND A LETTER STATING THAT THE WATER LINES HAVE BEEN PRESSURE TESTED AND NEED TO BE DISINFECTED, TO THE CITY OF COLUMBUS, DIVISION OF WATER. THE CONTRACTOR SHALL BE RESPONSIBLE FOR ALL COSTS ASSOCIATED WITH THE DISINFECTION OF ALL WATER LINES CONSTRUCTION PER THIS PLAN. 1. THE CONTRACTOR OR DEVELOPER IS RESPONSIBLE FOR SUBMITTING A NOTICE OF INTENT PRESSURE TESTING SHALL BE PERFORMED IN ACCORDANCE WITH SECTION 801.12 OF THE CITY

EPA GENERAL PERMIT FOR STORMWATER DISCHARGES ASSOCIATED WITH CONSTRUCTION 5. NO WATER TAPS OR SERVICE CONNECTIONS (E.G., TO CURB STOPS OR METER PITS) MAY BE ACTIVITY. A PROJECT LOCATION MAP MUST BE SUBMITTED WITH THE NOI. A SEDIMENT AND ISSUED UNTIL ADJACENT PUBLIC WATER LINES SERVING THE CONSTRUCTION SITE HAVE BEEN EROSION CONTROL PLAN MUST BE SUBMITTED TO THE CITY ENGINEER FOR APPROVAL IF A DISINFECTED BY THE CITY OF COLUMBUS DIVISION OF WATER AND HAVE BEEN ACCEPTED BY THE

6. THE CONTRACTOR SHALL NOTIFY THE CITY OF COLUMBUS DIVISION OF WATER AT 645\_7788 STRICT SPECIFICATION WILL APPLY AS DECIDED BY THE CITY ENGINEER. ITEM NUMBERS LISTED RIGHT-OF-WAY AND PUBLIC EASEMENTS FOR A PERIOD OF ONE YEAR FROM THE CITY ENGINEER TAPPING INTO

7. ALL BENDS, JOINT DEFLECTIONS AND FITTINGS SHALL BE BACKED WITH CONCRETE PER CITY

8. THE CONTRACTOR SHALL GIVE WRITTEN NOTICE TO ALL AFFECTED PROPERTY OWNERS AT LEAST 1 WORKING DAY BUT NOT MORE THAN 3 WORKING DAYS PRIOR TO ANY TEMPORARY 3. THE DEVELOPER OR CONTRACTOR SHALL BE RESPONSIBLE TO OBTAIN ALL NECESSARY HANDICAPPED RAMPS, SIDEWALKS, BIKE PATHS, PARKING LOT PAVEMENT, ETC. SHALL BE MINIMIZED AND MUST BE APPROVED BY THE CITY ENGINEER.

10. WATER LINES TO BE INSTALLED IN EMBANKMENT AREAS SHALL BE PLACED AFTER THE EMBANKMENT HAS BEEN PLACED AND COMPACTED ACCORDING TO THE STANDARD SPECIFICATIONS.

1. THE CONTRACTOR MUST OBTAIN A BLASTING PERMIT FROM WASHINGTON TOWNSHIP FIRE 11. CURB STOP BOXES SHALL BE LOCATED AT LEAST 1 FOOT INSIDE THE RIGHT\_OF\_WAY AND SET

FINISHED GRADE, AN EXTENSION STEM SHALL BE FURNISHED TO BRING THE TOP OF THE OPERATING NUT TO WITHIN 24 INCHES OF FINISHED GRADE ELEVATION.

13. ALL WATER LINES SHALL BE PLACED AT A MINIMUM DEPTH OF 4 FEET MEASURED FROM TOP OF 1. GRANULAR BACKFILL SHALL BE COMPACTED GRANULAR MATERIAL ACCORDING TO ITEM 912 OF FINISHED GRADE TO TOP OF WATER LINE. WATER LINES SHALL BE SET DEEPER AT ALL POINTS RESTRICTIONS BY A MINIMUM OF 18 INCHES.

1. WHERE PRIVATE STORM SEWERS CONNECT TO PUBLIC STORM SEWERS, THE LAST RUN OF AND LARGER PIPE SHALL BE CLASS II, UNLESS OTHERWISE SHOWN ON THE APPROVED CONSTRUCTION DRAWINGS. INSPECTION IS REQUIRED BY THE CITY OF DUBLIN'S DIVISION OF

2. GRANULAR BACKFILL SHALL BE COMPACTED GRANULAR MATERIAL ACCORDING TO ITEM 912 OF THE STANDARD SPECIFICATIONS OR CONTROLLED DENSITY BACKFILL ACCORDING TO ITEM 613,

3. ALL STORM SEWERS SHALL BE REINFORCED CONCRETE PIPE CONFORMING TO ASTM DESIGNATION C76, WALL B, CLASS IV FOR PIPE DIAMETERS 12 INCHES TO 15 INCHES, CLASS III FOR 18 INCHES TO 24 INCH PIPES, AND 27 INCHES AND LARGER PIPE SHALL BE CLASS II, UNLESS OTHERWISE SHOWN ON THE APPROVED CONSTRUCTION DRAWINGS.

GRATES SHALL INDLUCE ENGRAVED LETTERING: "DUMP NO WASTE; DRAINS TO RIVER."

VERTICALLY, FROM SANITARY SEWERS AND STORM SEWERS, TO THE GREATEST EXTENT REINFORCED CONCRETE PIPE IN PAVED AND NON PAVED AREAS AS APPROVED BY THE CITY

7. BACKFILL MATERIAL SHALL BE PLACED IN ACCORDANCE WITH ITEM 911 OR ITEM 912 OF THE

8. BACKFILL MATERIAL IN AREAS LOCATED OUTSIDE THE PUBLIC RIGHT-OF-WAY SHALL BE PLACED IN ACCORDANCE WITH ITEM 901 OF THE CITY OF COLUMBUS (CMS).

2 INCHES X 2 INCHES LUMBER AT ALL WYE LOCATIONS, ENDS OF EXTENDED SERVICES, OR AT THE 1. THE CONTRACTOR SHALL BE RESPONSIBLE TO ENSURE THAT US MAIL DELIVERY WITHIN THE END OF EACH RISER WHERE RISERS ARE REQUIRED. WYE POLES SHALL BE VISIBLE BEFORE PROJECT LIMITS IS NOT DISRUPTED BY CONSTRUCTION OPERATIONS. THIS RESPONSIBILITY IS LIMITED TO RELOCATION OF MAILBOXES TO A TEMPORARY LOCATION THAT WILL ALLOW THE COMPLETION OF THE WORK AND SHALL ALSO INCLUDE THE RESTORATION OF MAILBOXES TO THEIR ORIGINAL LOCATION OR APPROVED NEW LOCATION. ANY RELOCATION OF MAILBOX 12.EXISTING SANITARY SEWER FLOWS SHALL BE MAINTAINED AT ALL TIMES. COSTS FOR PUMPING SERVICES MUST BE FIRST COORDINATED WITH THE US POSTAL SERVICE AND THE HOMEOWNER.

> 2. BEFORE RELOCATING ANY MAILBOXES, THE CONTRACTOR SHALL CONTACT THE U.S. POSTAL SERVICE AND RELOCATE MAILBOXES ACCORDING TO THE REQUIREMENTS OF THE POSTAL SERVICE.

1. THE CONTRACTOR SHALL MAKE PROPER ARRANGEMENTS WITH THE DUBLIN SERVICE DESIGNATED BY THE OMUTCD, AND SHALL BE PRESENT WHENEVER ONE\_LANE, TWO\_WAY 2. ALL PUBLIC WATER PIPE WITH A DIAMETER 3 INCHES TO 8 INCHES SHALL BE DUCTILE IRON, DEPARTMENT AND THE COLUMBUS DIVISION OF WATER FOR THE USE OF FIRE HYDRANTS WHEN TRAFFIC CONTROL IS IN EFFECT. POLICE CRUISERS MAY BE REQUIRED AS DIRECTED BY THE CITY CLASS 53. PUBLIC WATER PIPE 12 INCHES IN DIAMETER OR LARGER SHALL BE DUCTILE IRON, USED FOR WORK PERFORMED UNDER THIS CONTRACT AND PROVIDE THE CITY OF DUBLIN A COPY CLASS 54. PUBLIC WATER PIPE 20 INCHES IN DIAMETER OR LARGER MAY BE PRESTRESSED OF THE HYDRANT USAGE PERMIT OBTAINED FROM THE CITY OF COLUMBUS. THE CONTRACTOR CONCRETE PIPE. PRIVATE WATER PIPE SHALL MEET THE APPROVAL OF THE CITY OF COLUMBUS SHALL ALSO SEND A COPIES OF PERMITS OBTAINED FROM DUBLIN AND COLUMBUS TO THE WASHINGTON AND/OR PERRY TOWNSHIP FIRE DEPARTMENT. PERMITS SHALL BE KEPT AT THE CONSTRUCTION SITE AT ALL TIMES.

4. STEADY\_BURNING, TYPE "C" LIGHTS SHALL BE REQUIRED ON ALL BARRICADES, DRUMS, AND DIVISION OF ENGINEERING. THE COST FOR CHLORINATION SHALL BE PAID FOR BY THE CITY OF COLUMBUS DIVISION OF WATER TO THE CITY ENGINEER STATING THAT THE CONTRACTOR HAS RETURNED THE SIAMESE VALVE TO THE CITY OF COLUMBUS AND HAS PAID ALL COSTS ARISING FROM THE USE OF THE FIRE HYDRANTS.

OSBORN ENGINEERING 130 East Chestnut St - Suite 401 | Columbus, OH 4321:

614-556-4272

**CORWIN PROPERTIES** 

THE **APOTHECARY UNCORKED** 

PROJECT LOCATION: 30 SOUTH HIGH STREET CITY OF DUBLIN, FRANKLIN COUNTY, OHIO 43017

ISSUED DATE ARB - REVISION 10/30/2023


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OSBORN PROJ. NO. J20211064.000

GENERAL NOTES

DRAWING NO.



130 East Chestnut St - Suite 401 | Columbus, OH 43212

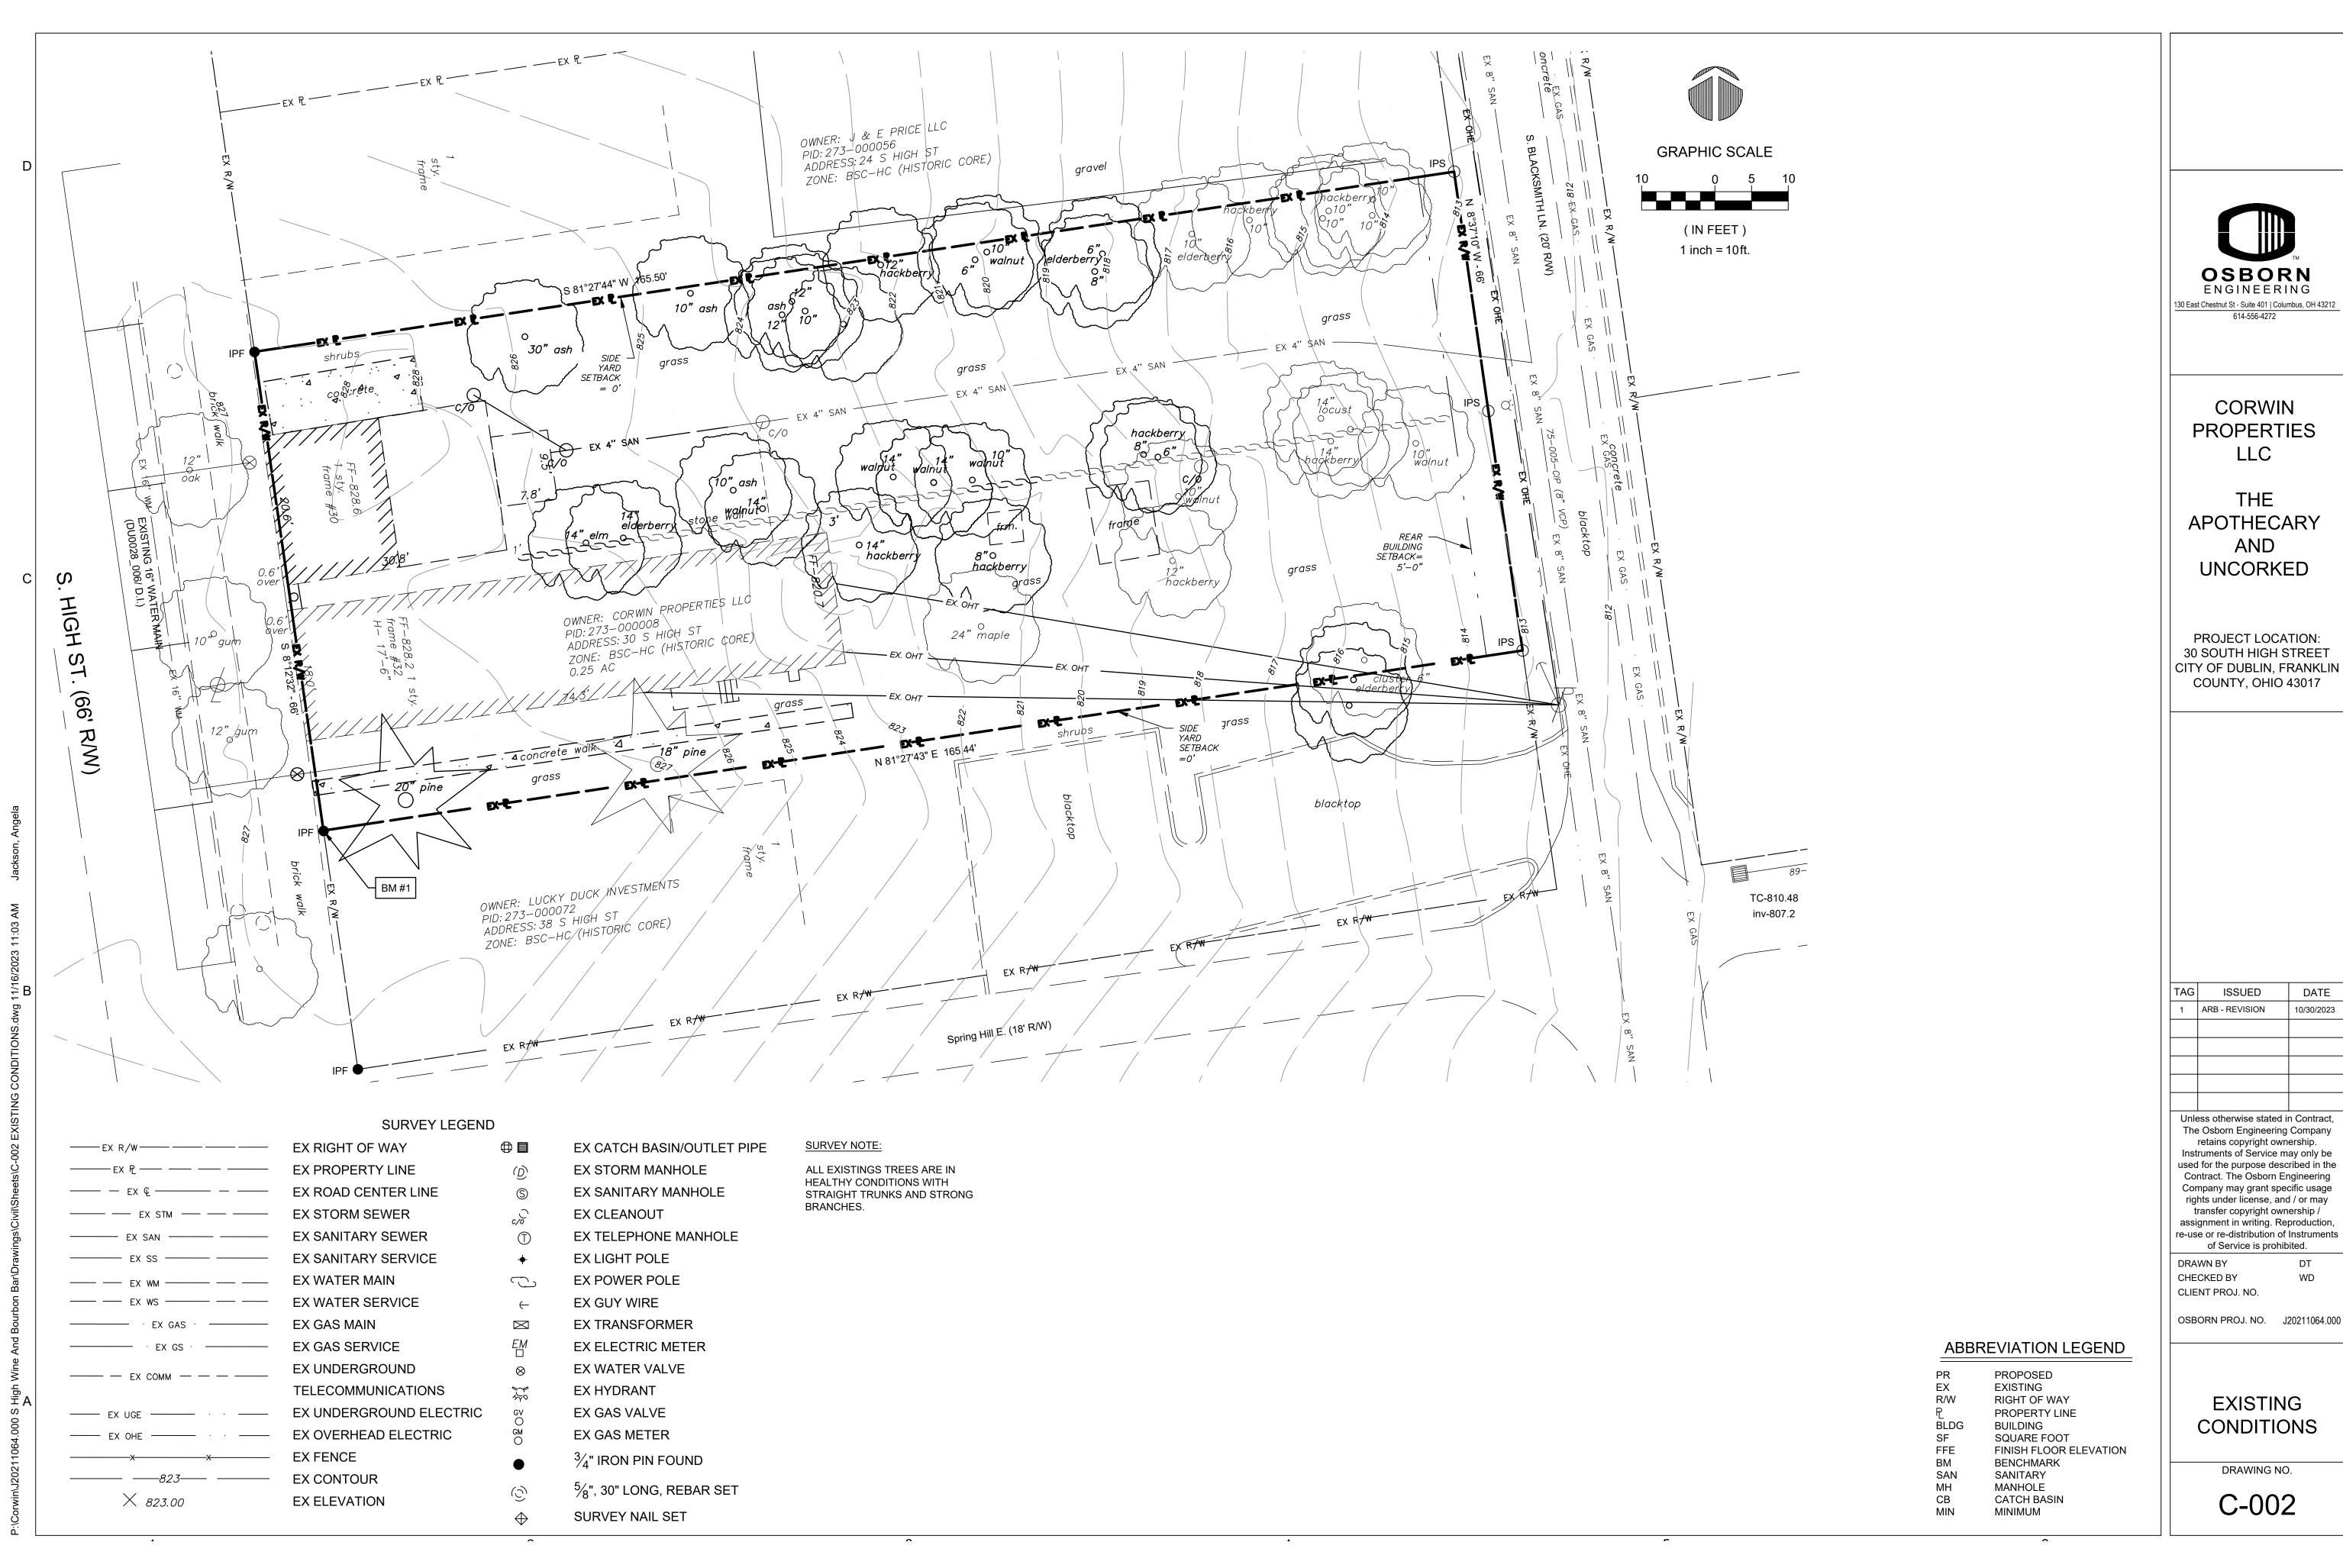30 SOUTH HIGH STREET COUNTY, OHIO 43017

IAG	ISSUED	DATE
1	ARB - REVISION	10/30/2023

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1 foot contour interval shown.
Horizontal Datum - Ohio SPC South Zone
Vertical Datum - NAVD 88
Unable to determine sanitary service.
Present Zoning HC - Historic Core

SURVEY & TOPOGRAPHY

Being the north half of Lot 122 & south half of Lot 123 Town Plat of Dublin (P.B. 1, Pg. 193) City of Dublin, Franklin County, Ohio

LEGEND

IPS O Iron Pin Set
IPF • Iron Pipe Found

W Water Main

Gas Line

SAN Sanitary Sewer

STM Overhead Lines

Manhole

Storm Inlet

Cleanout

Utility Pole

Guy Wire

Fence

Water Valve

Deciduous Tree

Pine Tree

Pine Tree

Sign

108 BENCHMARK: Elev.—813.52
Rim of sanitary sewer, 100'± north of site in Blacksmith Lane. 124 107 137 CL 826.88 High 106 St. 66; blacktop BENCHMARK: Elev.—827.8 Spring Hill E.

PATRIDGE SURVEYING L.L.C. 9464 DUBLIN ROAD POWELL, OHIO 43065 TEL. (614)-799-0031 FAX (614)-300-5076

1 foot contour interval shown. Horizontal Datum — Ohio SPC South Zone Vertical Datum — NAVD 88 Unable to determine sanitary service. Present Zoning HC — Historic Core



CORWIN PROPERTIES LLC

THE APOTHECARY AND UNCORKED

PROJECT LOCATION: 30 SOUTH HIGH STREET CITY OF DUBLIN, FRANKLIN COUNTY, OHIO 43017

	TAG	ISSUED	DATE						
	1	ARB - REVISION	10/30/2023						
1		•							

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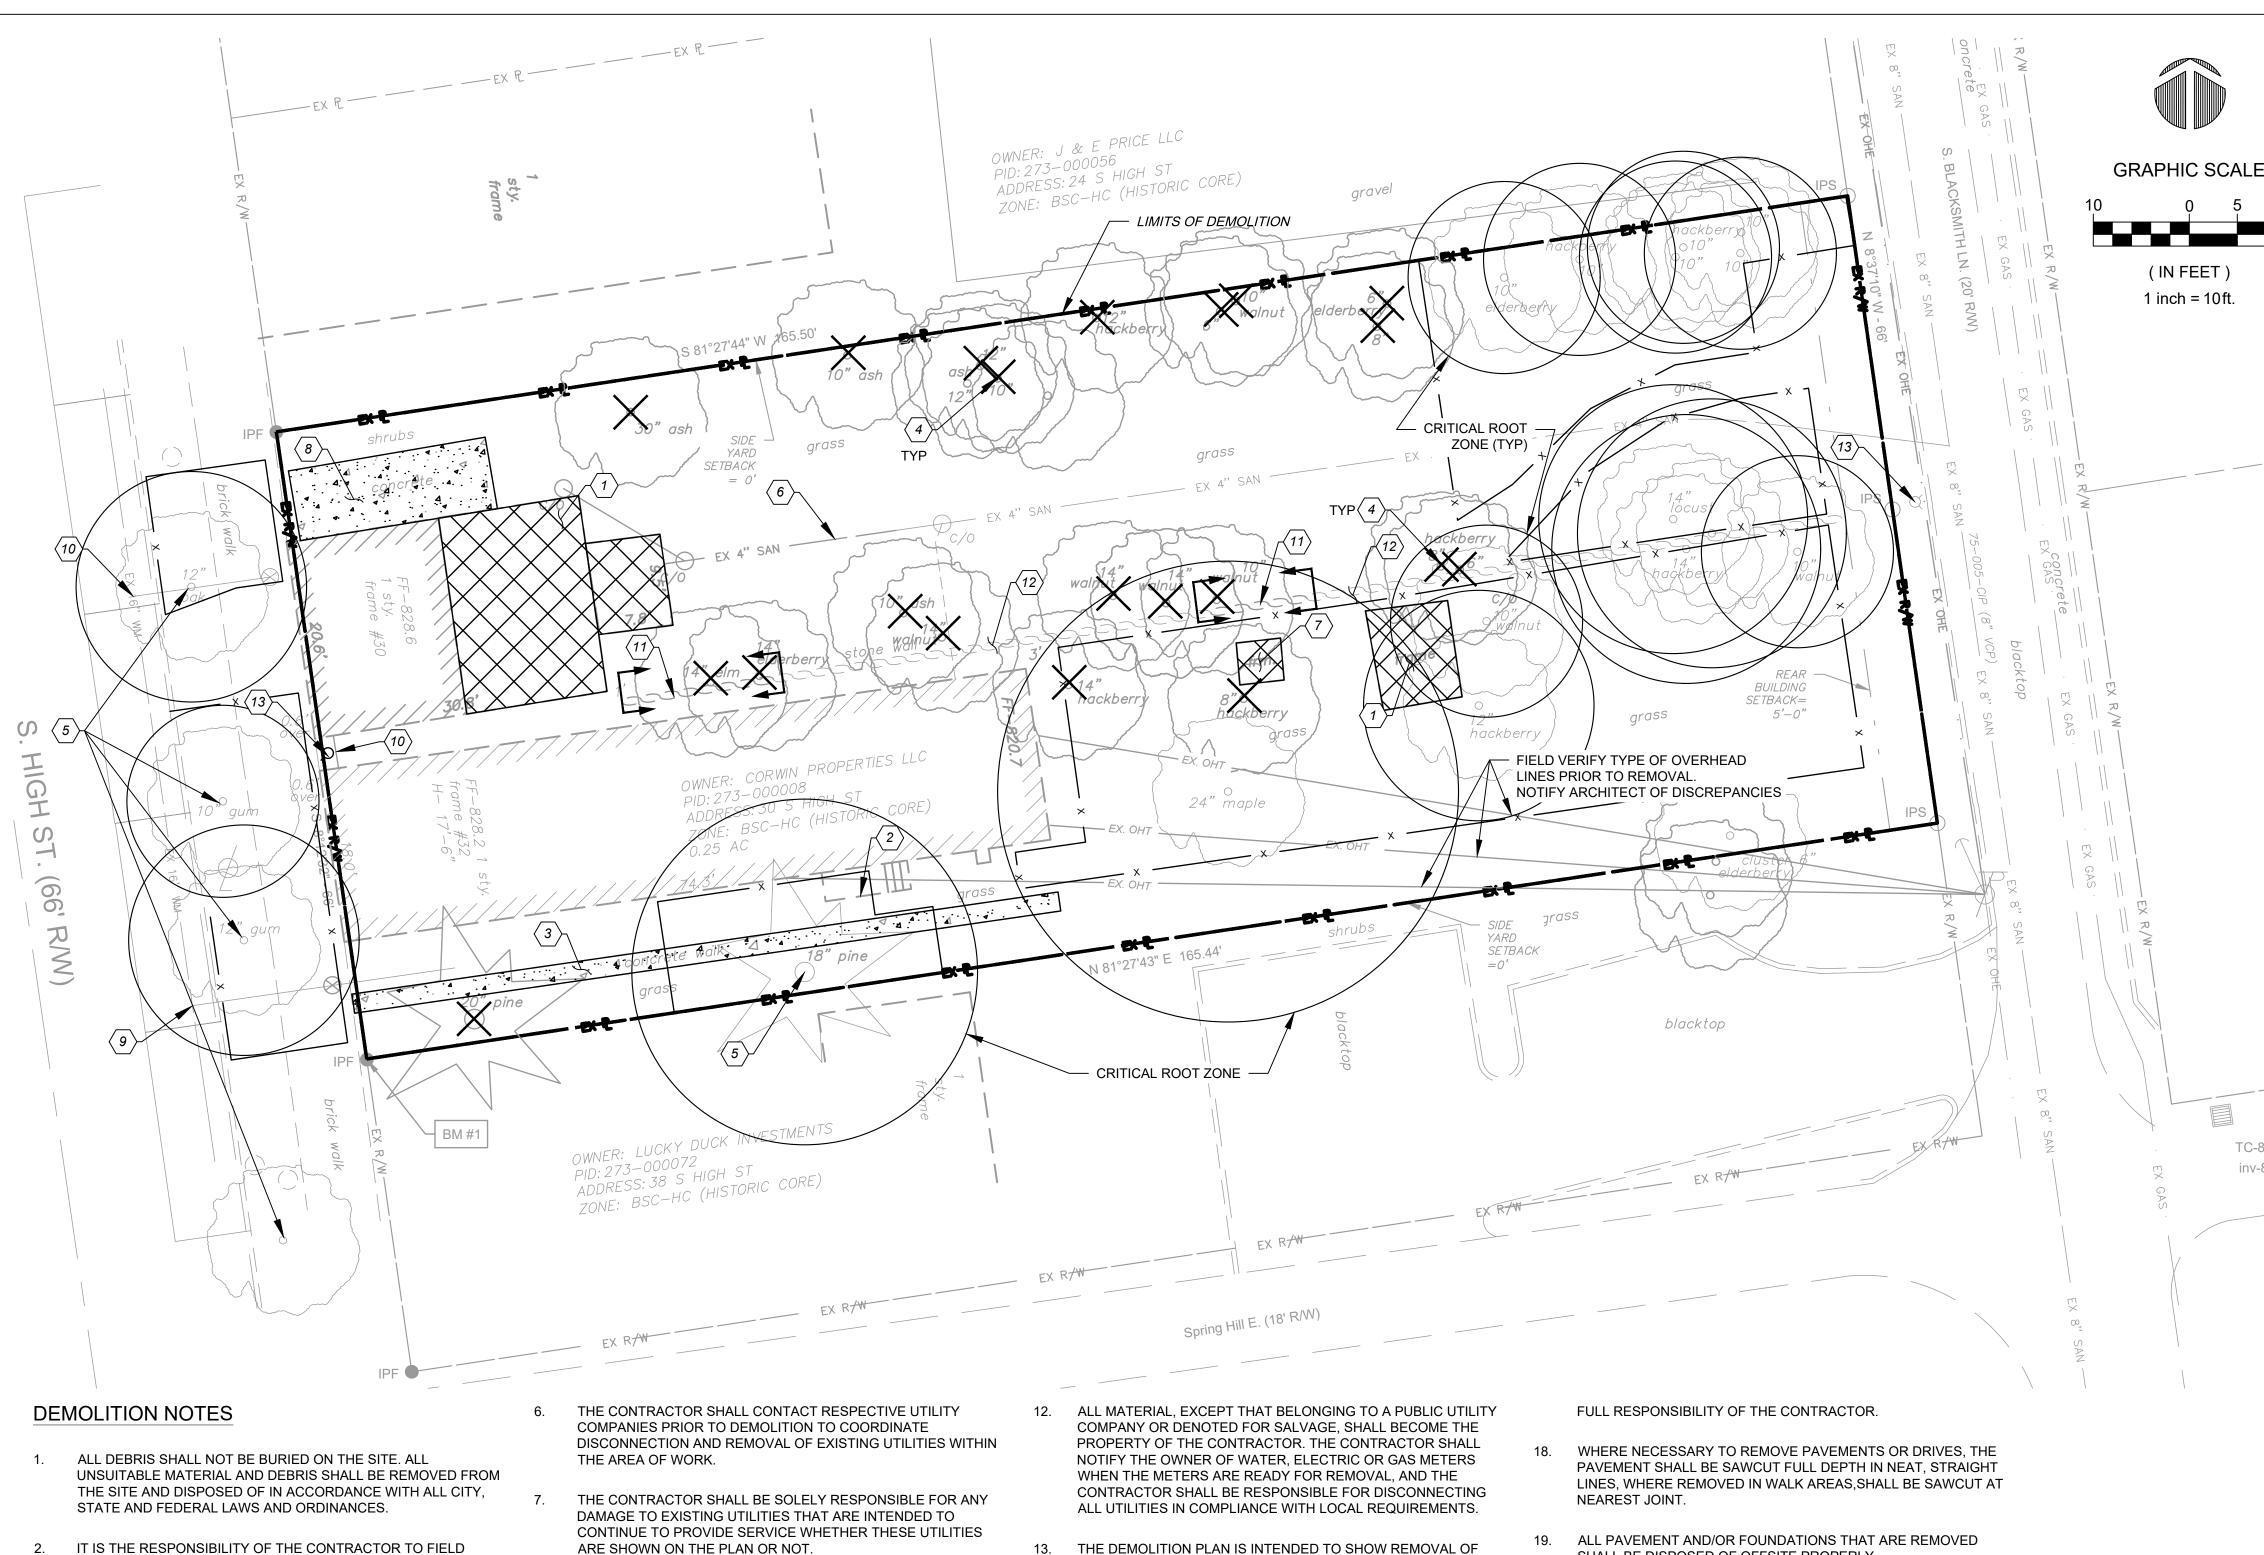
DRAWN BY DT
CHECKED BY WD
CLIENT PROJ. NO.

OSBORN PROJ. NO. J20211064.000

SURVEY

DRAWING NO.

C-002A



- LOCATE ANY AND ALL UTILITIES PRIOR TO PERFORMING ANY WORK. CONTACT THE APPLICABLE UTILITIES PROTECTION SERVICE AT A MINIMUM OF 48 HOURS IN ADVANCE OF WORK TO BE DONE NEAR ANY EXISTING UTILITY MAIN.
- CONTRACTOR SHALL NOT DISTURB EXISTING PAVEMENT OUTSIDE OF DEMOLITION AREA.
- ITEMS DESIGNATED FOR DEMOLITION SHALL NOT BE DISTURBED BY THE CONTRACTOR UNTIL THEY ARE FURNISHED WITH NOTICE TO PROCEED BY THE OWNER. AS SOON AS SUCH NOTICE HAS BEEN GIVEN, THE CONTRACTOR SHALL PERFORM THE DEMOLITION UNDER THE DIRECTION OF THE OWNER'S REPRESENTATIVE.
- THE SIZE AND LOCATION OF UNDERGROUND UTILITIES HAVE BEEN OBTAINED BY A SEARCH OF AVAILABLE RECORDS. VERIFICATION BY FIELD OBSERVATION HAS BEEN CONDUCTED WHERE POSSIBLE. THE CONTRACTOR IS RESPONSIBLE FOR VERIFYING THE LOCATIONS AND DEPTHS OF ALL EXISTING UTILITIES PRIOR TO CONSTRUCTION. IMMEDIATELY NOTIFY THE ENGINEER OF ANY DISCREPANCIES.

- ARE SHOWN ON THE PLAN OR NOT.
- UPON DISCOVERY OF UNDERGROUND TANKS OR CONTAMINATED SOILS, THE CONTRACTOR SHALL IMMEDIATELY NOTIFY THE OWNER'S REPRESENTATIVE. NO REMOVAL OF TANKS OR CONTAMINATED SOILS SHALL OCCUR UNTIL AUTHORIZED BY THE OWNER AND PROPER AUTHORITIES.
- ALL EARTHWORK, SUBGRADE PREPARATION AND BACKFILL REQUIREMENTS SHALL BE PER THE LATEST CITY OF DUBLIN STANDARD DETAILS AND SPECIFICATIONS.
- 10. THE USE OF EXPLOSIVES SHALL NOT BE PERMITTED.
- 11. EXISTING ABANDONED UTILITIES WITHIN THE PROPOSED WORK LIMITS SHALL BE REMOVED IF POSSIBLE. IF SUCH UTILITIES ARE PRESENT, THEY SHOULD BE REMOVED AND RELOCATED OR ABANDONED IN PLACE. IF ABANDONED IN PLACE, IT IS RECOMMENDED THAT THE UTILITIES PIPE BE FILLED WITH LOW STRENGTH MORTAR GROUT TO AVOID POTENTIAL COLLAPSE IN THE FUTURE. SHOULD THE UTILITIES LINES BE REMOVED FROM THE SITE, THE RESULTANT TRENCH EXCAVATIONS SHOULD BE BACKFILLED AND COMPACTED IN ACCORDANCE WITH THE CITY OF DUBLIN STANDARD DETAILS AND SPECIFICATIONS.
- THE DEMOLITION PLAN IS INTENDED TO SHOW REMOVAL OF KNOWN SITE FEATURES AND UTILITES AS SHOWN ON THE SURVEY. THERE MAY BE OTHER SITE FEATURES, UTILITIES, STRUCTURES AND MISCELLANEOUS ITEMS BOTH BURIED AND ABOVE GROUND THAT ARE WITHIN THE LIMITS OF WORK THAT MAY NEED TO BE REMOVED FOR THE PROPOSED PROJECT THAT ARE NOT SHOWING HEREON.
- 14. EXISTING WATER SERVICE CONNECTIONS NOTED SHALL BE ABANDONED IN ACCORDANCE WITH THE CITY OF DUBLIN AND THE CITY OF COLUMBUS WATER STANDARDS.
- 15. ALL EXISTING CONDITIONS WITHIN THE RIGHT-OF-WAY DISTURBED BY THE CONSTRUCTION OF THIS PROJECT SHALL BE IMMEDIATELY RESTORED TO THE PRE-CONSTRUCTION CONDITION OR BETTER.
- THE CONTRACTOR SHALL CAREFULLY PRESERVE BENCHMARKS, PROPERTY CORNERS, REFERENCE POINTS AND STAKES.
- ANY DAMAGE CAUSED TO THE PAVEMENT, DRIVE, DRAINAGE SYSTEMS, UNDERGROUND OR OVERHEAD UTILITIES, PIPE LINES OR LANDSCAPING, EITHER WITHIN THE RIGHT-OF-WAY OR ON ADJACENT PROPERTIES, SHALL BE FULLY RESTORED PROMPTLY BY THE CONTRACTOR WITH ALL RELATED COSTS BEING THE

- SHALL BE DISPOSED OF OFFSITE PROPERLY.
- 20. EROSION & SEDIMENT CONTROL MEASURES SHALL BE IN PLACE AND MAINTAINED DURING DEMOLITION ACTIVITIES.
- 21. THE PURPOSE OF THIS DRAWING IS TO CONVEY THE OVERALL SCOPE OF WORK AND IT IS NOT INTENDED TO COVER ALL DETAILS OR SPECIFICATIONS REQUIRED TO COMPLY WITH GENERALLY ACCEPTED DEMOLITION PRACTICES. THE CONTRACTOR SHALL THOROUGHLY FAMILIARIZE THEMSELVES WITH THE SITE, SCOPE OF WORK AND ALL EXISTING CONDITIONS AT THE SITE PRIOR TO BIDDING AND COMMENCING THE WORK. THE DEMOLITION CONTRACTOR SHALL BE SOLELY RESPONSIBLE FOR MEANS, METHODS, TECHNIQUES, OR PROCEDURES USED TO COMPLETE THE WORK IN ACCORDANCE WITH THE CONSTRUCTION DOCUMENTS AND IS LIABLE FOR THE SAFETY OF THE PUBLIC OR CONTRACTOR'S EMPLOYEES DURING THE COURSE OF THE PROJECT.

#### ⟨#⟩ SITE DEMOLITION PLAN CODED NOTES:

- 1. EXISTING BUILDING TO BE DEMOLISHED
- 2. EXISTING STEPS TO BE REMOVED
- 3. EXISTING WALK TO BE REMOVED
- 4. EXISTING TREE TO BE REMOVED (TYPICAL)
- 5. EXISTING TREES TO BE PROTECTED IN PLACE PER CITY STANDARDS. SEE SHEET C-400 FOR TREE PROTECTION FENCING DETAIL.
- 6. EXISTING SANITARY SERVICE LINE. LOCATION SHOWN PER RECORD PLANS. CONTRACTOR TO FIELD VERIFY LOCATION BEFORE CONSTRUCTION.
- 7. EXISTING PRIVY STRUCTURE TO BE RELOCATED. REFER TO LANDSCAPE PLANS
- 8. EXISTING CONCRETE STOOP TO BE REMOVED
- 9. EXISTING WATER SERVICE TO BE ABANDONED AT THE TAP PER COC 808.06. REFER TO WSP7185.
- 10. EXISTING FENCE TO BE REMOVED.
- 11. EXISTING HISTORIC STACKED STONE WALL TO BE REMOVED, STACKED SAFELY AND RE-USED TO RE-CONSTRUCT DRYSTACKED WALL, REFER TO ARCHITECTURAL PLANS FOR DETAILS.
- 12. EXISTING HISTORIC STACKED STONE WALL TO BE PRESERVED DURING CONSTRUCTION, COORDINATE WITH LANDSCAPING PLAN.
- 13. HISTORIC HYDRANT TO BE REMOVED AND SALVAGED TO BE RETAINED BY OWNER AS AN ARTIFACT, REFER TO ARCHITECTURAL SUBMISSION DOCUMENTS. (DO NOT DISCARD).

#### SITE DEMOLITION PLAN NOTES:

- 1. ALL ITEMS TO BE TRANSPORTED TO A LEGAL DUMPSITE
- 2. CONTRACTOR TO FIELD VERIFY EXISTING UTILITY LOCATIONS PRIOR TO CONSTRUCTION.
- 3. CONTRACTOR TO REMOVE CONCRETE TO NEAREST JOINT, WHERE APPLICABLE.
- 4. CONTRACTOR TO STRIP EXISTING VEGETATION AND TOP SOIL TO ACCOMMODATE BUILDING ADDITION AND SITE IMPROVEMENTS

1. NO WORK SHOULD BE STARTED UNTIL THE TREE PROTECTION FENCING HAS BEEN INSTALLED AND INSPECTED BY THE CITY, CALL 614 410-4660 FOR INSPECTION. REFER TO THE TREE PROTECTION DETAILS ON SHEET C-400.

## SITE DEMOLITION LEGEND

EXISTING CONCRETE TO BE REMOVED




EXISTING STRUCTURE TO BE REMOVED



\_\_\_ \_\_ LIMITS OF DEMOLITION

ITEMS TO BE REMOVED

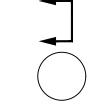

LIMITS OF HISTORIC WALL TO BE REMOVED

ABBREVIATION LEGEND

RIGHT OF WAY

SQUARE FOOT

BENCHMARK

CATCH BASIN

SANITARY

**MANHOLE** 

MINIMUM

BUILDING

PROPERTY LINE

FINISH FLOOR ELEVATION



x — PROTECTIVE TREE FENCE

R/W

BLDG

Unless otherwise stated in Contract,

DATE

10/30/2023

TAG ISSUED

ARB - REVISION

**OSBORN** ENGINEERING

130 East Chestnut St - Suite 401 | Columbus, OH 43212 614-556-4272

CORWIN

**PROPERTIES** 

LLC

THE

**APOTHECARY** 

AND

**UNCORKED** 

PROJECT LOCATION: 30 SOUTH HIGH STREET

CITY OF DUBLIN, FRANKLIN

COUNTY, OHIO 43017

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OSBORN PROJ. NO. J20211064.000

#### PROPOSED **EXISTING**

DRAWING NO.


DEMOLITION

**PLAN** 

TC-810.48 inv-807.2

(IN FEET)

1 inch = 10 ft.

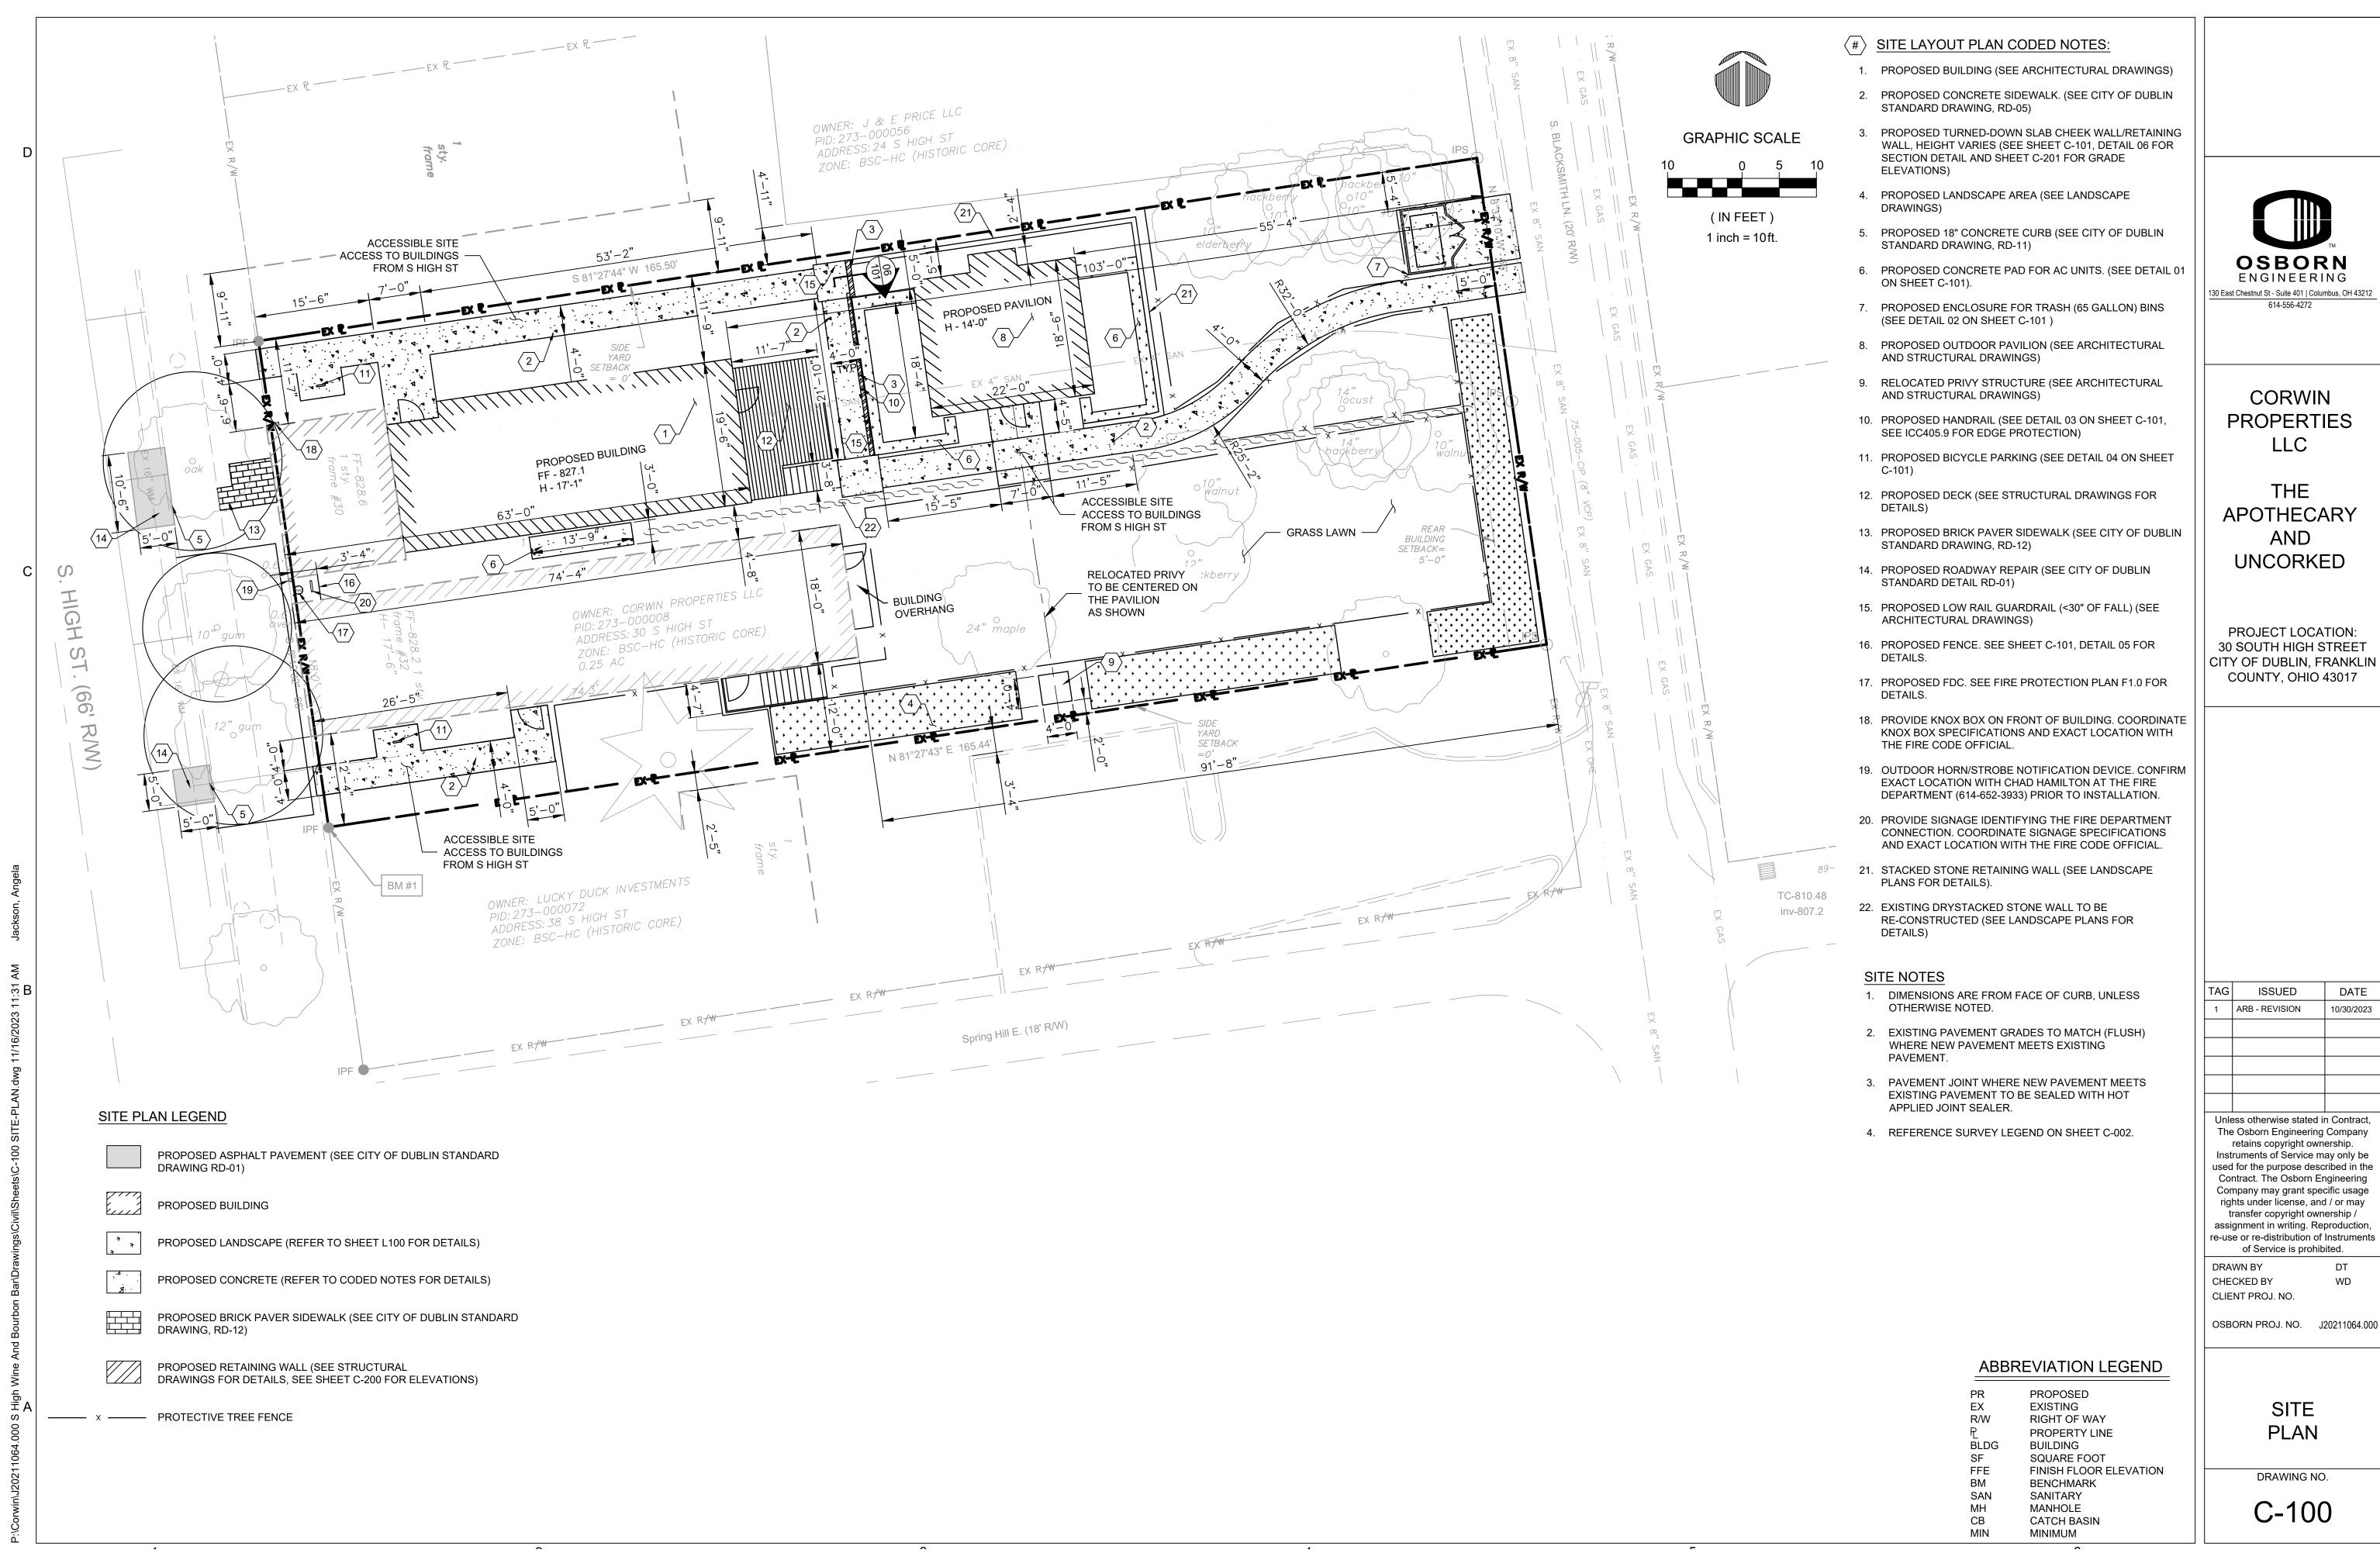

130 East Chestnut St - Suite 401 | Columbus, OH 43212

30 SOUTH HIGH STREET

DATE 10/30/2023

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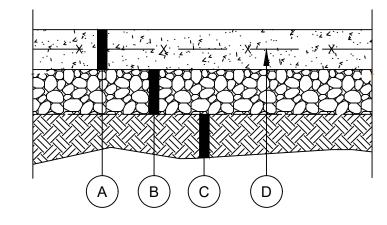


#### PAVEMENT LEGEND

- A 4" REINFORCED CONCRETE (ODOT CMS 451)
- (B) 8" AGGREGATE BASE (ODOT CMS 304)
- (C) SUBGRADE COMPACTION (ODOT CMS 204)
- © WELDED WIRE FABRIC MAT REINFORCEMENT (ODOT ITEM 509)


PAVEMENT NOTES:

PAVEMENT SECTION TO BE VERIFIED WITH GEOTECHNICAL ENGINEER AND APPROVED BY OWNER PRIOR TO INSTALLATION.



1.) USE 6X6 W4.0X W4.0 MAT REINFORCEMENT



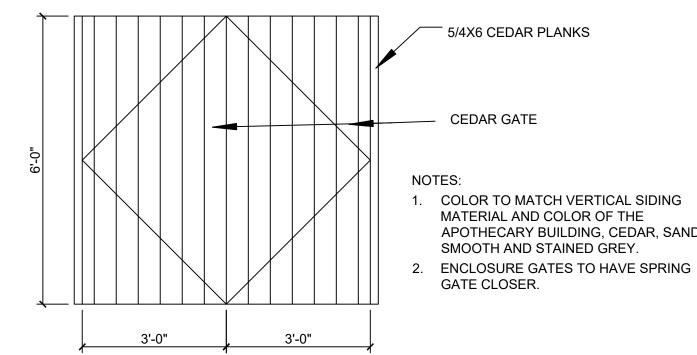

DUMPSTER ENCLOSURE NOT TO SCALE

5/4X6 CEDAR PLANKS


MATERIAL AND COLOR OF THE


SMOOTH AND STAINED GREY.

APOTHECARY BUILDING, CEDAR, SANDED

CEDAR GATE

GATE CLOSER.

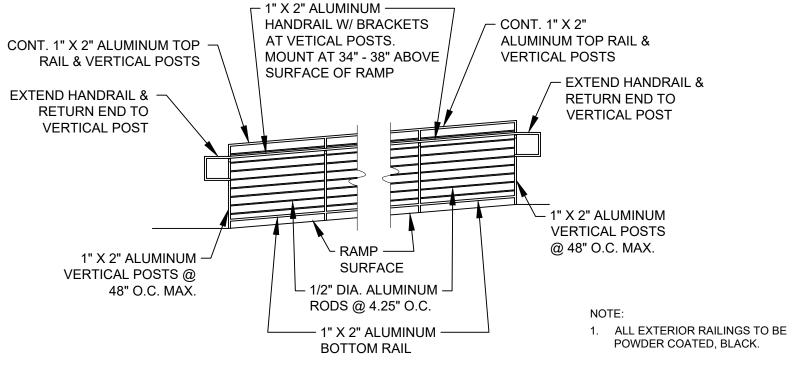


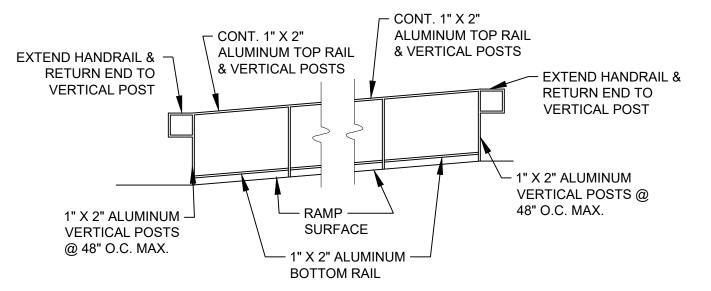


ADA HANDRAIL HEIGHT 505.4 STANDARD NOT TO SCALE

INVERTED "U" BICYCLE RACK NOTES:


- 1. BICYCLE PARKING SHALL BE LOCATED IN HIGHLY VISIBLE AREAS NEAR THE INTENDED USE. 2. BICYCLE PARKING RACKS SHALL BE POSITIONED OUT OF WALKWAY CLEAR ZONES AND NOT POSE A TRIPPING HAZARD FOR VISUALLY IMPAIRED PEDESTRIANS.
- 3. BICYCLE PARKING RACKS SHALL BE LOCATED TO AVOID POTENTIAL CONFLICT WITH PARKING AND CIRCULATION OF MOTOR VEHICLES.
- 4. BICYCLE PARKING RACKS SHALL BE OF THE INVERTED "U" TYPE DESIGN, UNLESS AN ALTERNATIVE
- DESIGN HAS BEEN APPROVED BY THE LOCAL PUBLIC SERVICE DEPARTMENT. 5. BICYCLE PARKING RACKS SHALL SUPPORT A BICYCLE UPRIGHT IN TWO PLACES.
- 6. BICYCLE PARKING RACKS SHALL ENABLE THE BICYCLE FRAME AND ONE OR BOTH WHEELS TO BE
- SECURED THROUGH THE USE OF A "U" TYPE LOCK. 7. BICYCLE PARKING RACKS SHALL BE SECURELY ANCHORED TO AN APPROVED HARD SURFACE.
- 8. A TWO FOOT BY SIX FOOT SPACE IS REQUIRED TO ACCOMMODATE TWO BICYCLES. 9. PARALLEL BIKE RACKS SHALL BE A MINIMUM ON-CENTER SPACING OF 30 INCHES. SPACING OF 48
- INCHES IS OPTIMAL. 10. BICYCLE RACK COLOR TO BE GREY.

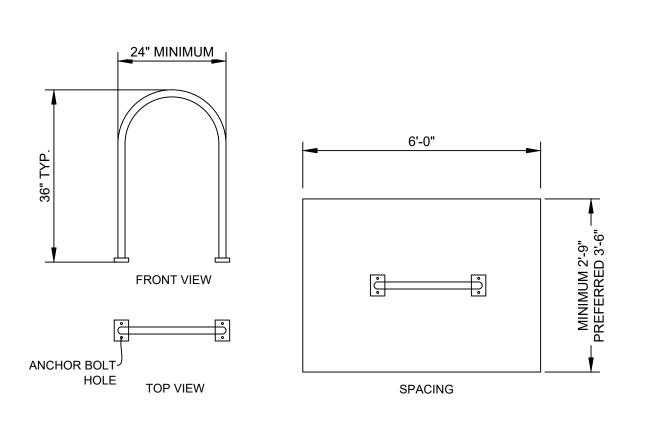



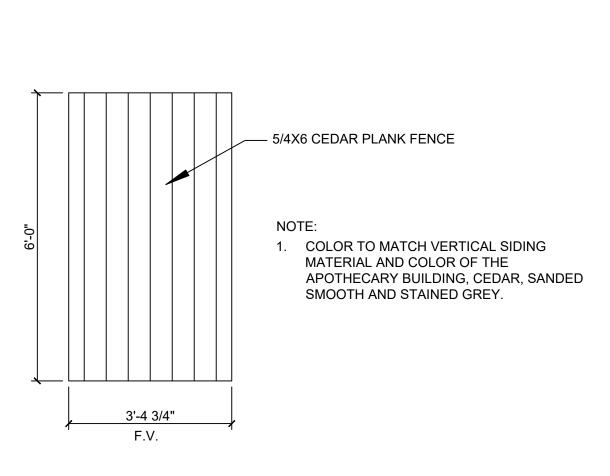



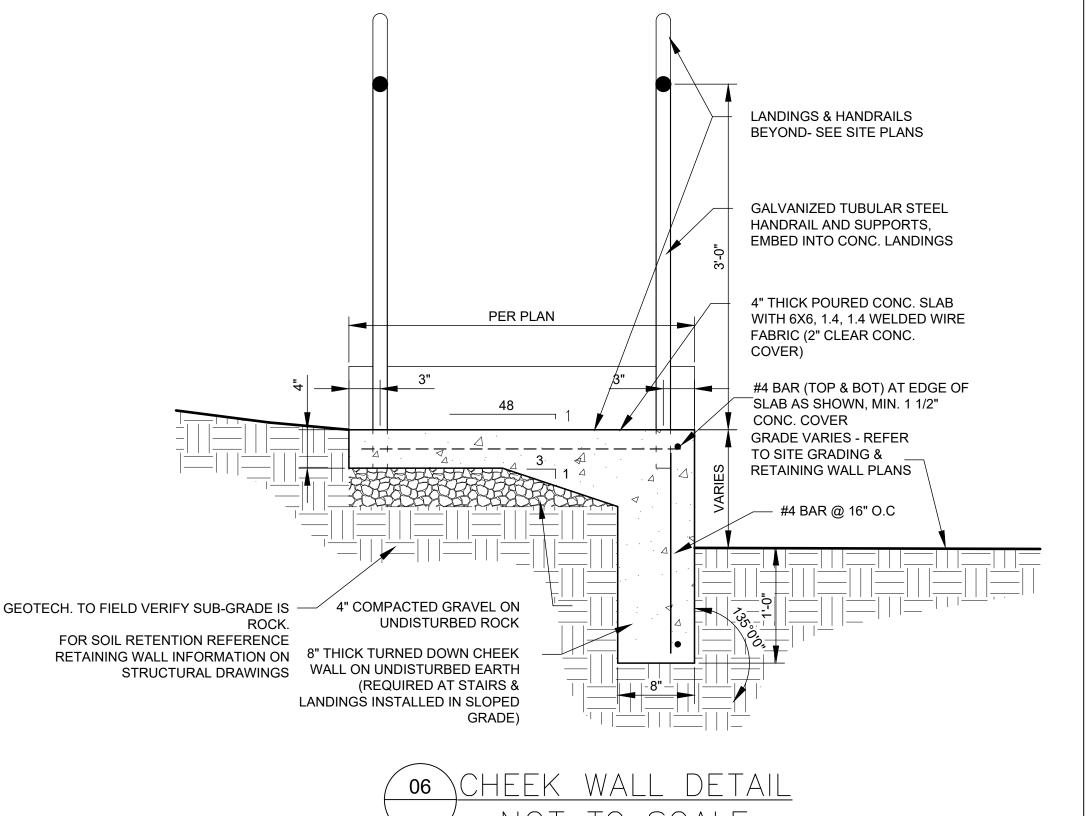

**OSBORN** ENGINEERING 130 East Chestnut St - Suite 401 | Columbus, OH 43212 614-556-4272

CORWIN **PROPERTIES** LLC

THE **APOTHECARY** AND **UNCORKED** 

PROJECT LOCATION: 30 SOUTH HIGH STREET CITY OF DUBLIN, FRANKLIN COUNTY, OHIO 43017

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OSBORN PROJ. NO. J20211064.000

CONSTRUCTION **DETAILS** 

DRAWING NO.

C-101

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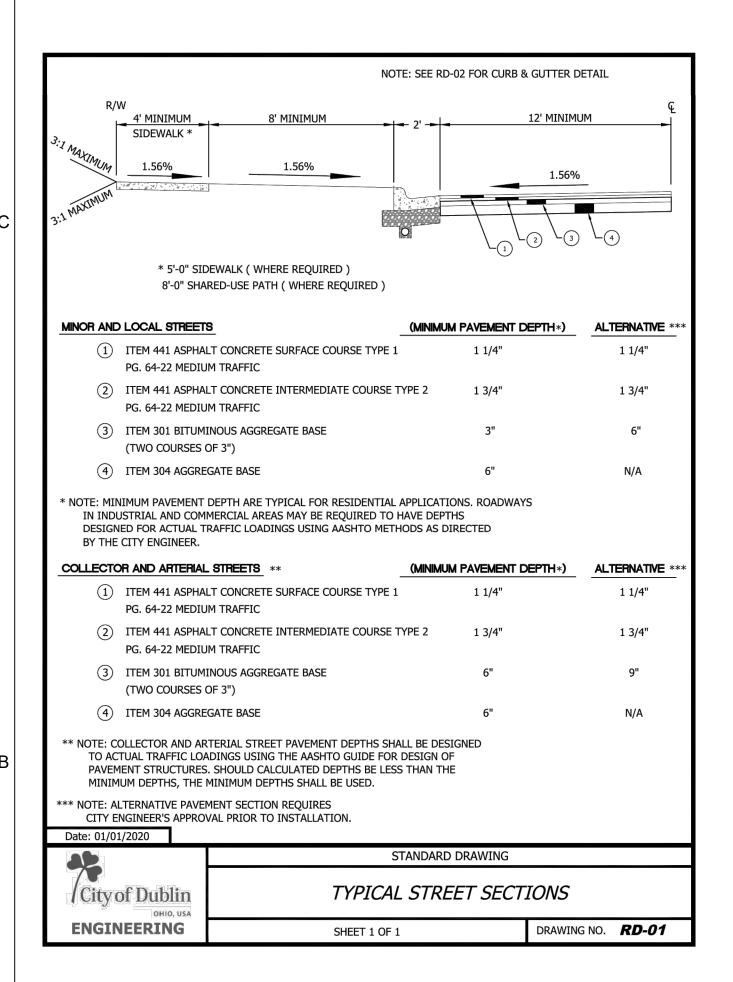
OSBORN PROJ. NO. J20211064.000


WD

CONSTRUCTION **DETAILS** 

DRAWING NO.

C-102




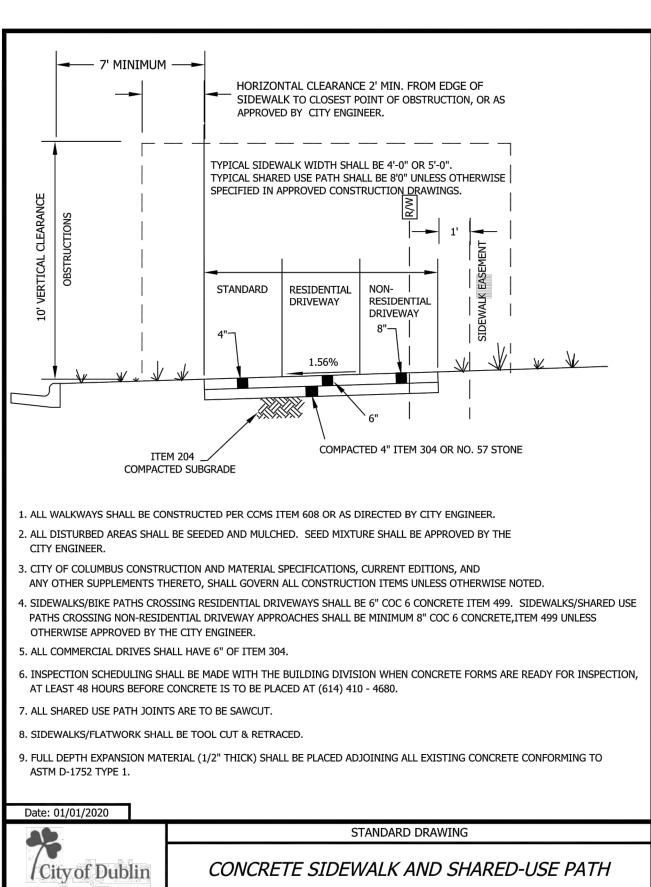


SHEET 1 OF 1

DRAWING NO. **RD-05** 

**ENGINEERING** 

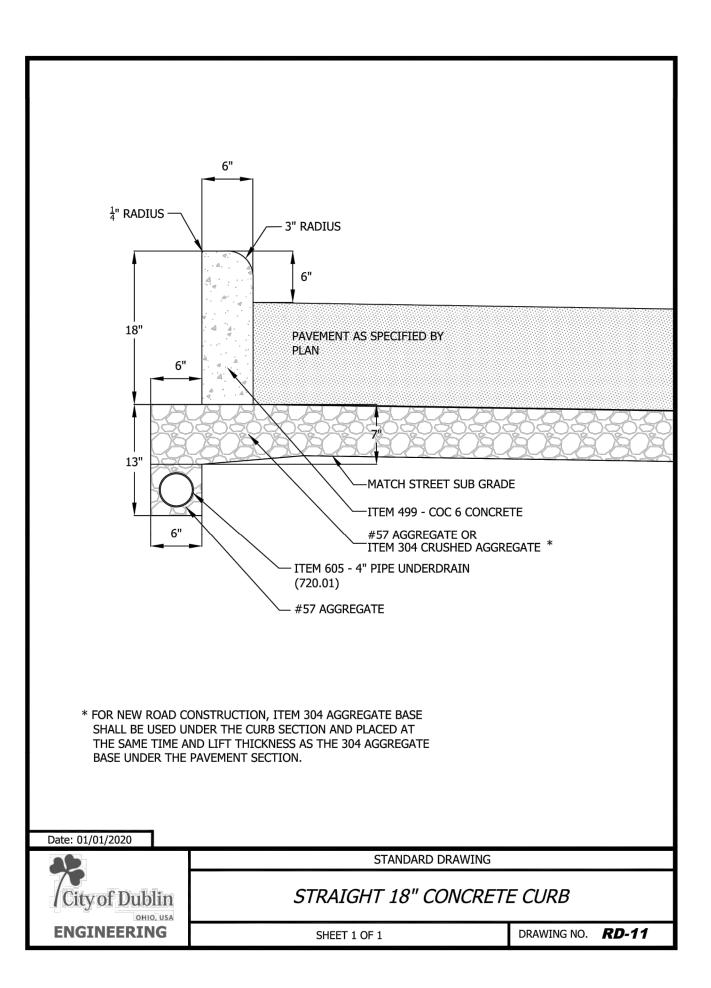

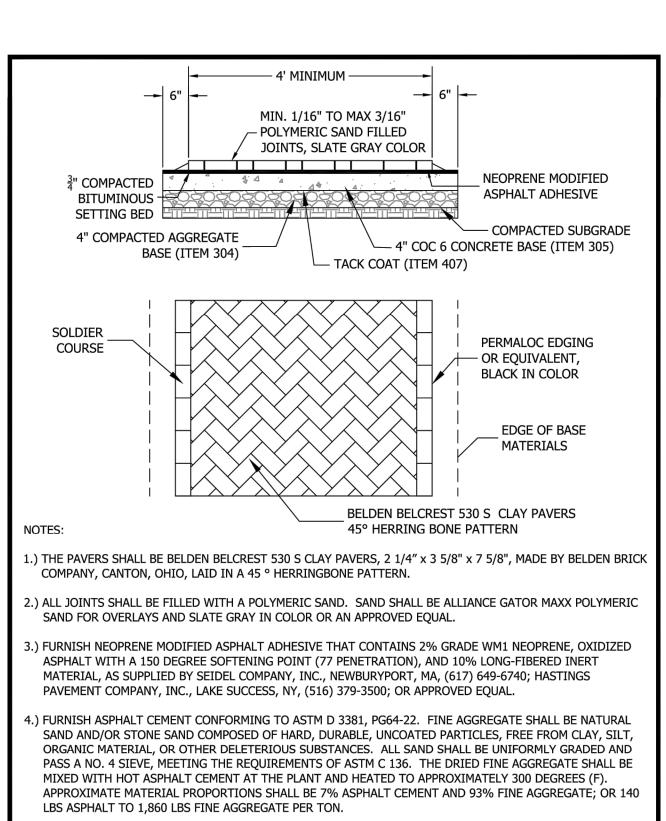

STANDARD DRAWING

HISTORIC DISTRICT BRICK PAVER SIDEWALK


SHEET 1 OF 1


DRAWING NO. **RD-12** 

Date: 01/01/2020

/City of Dublin

**ENGINEERING** 

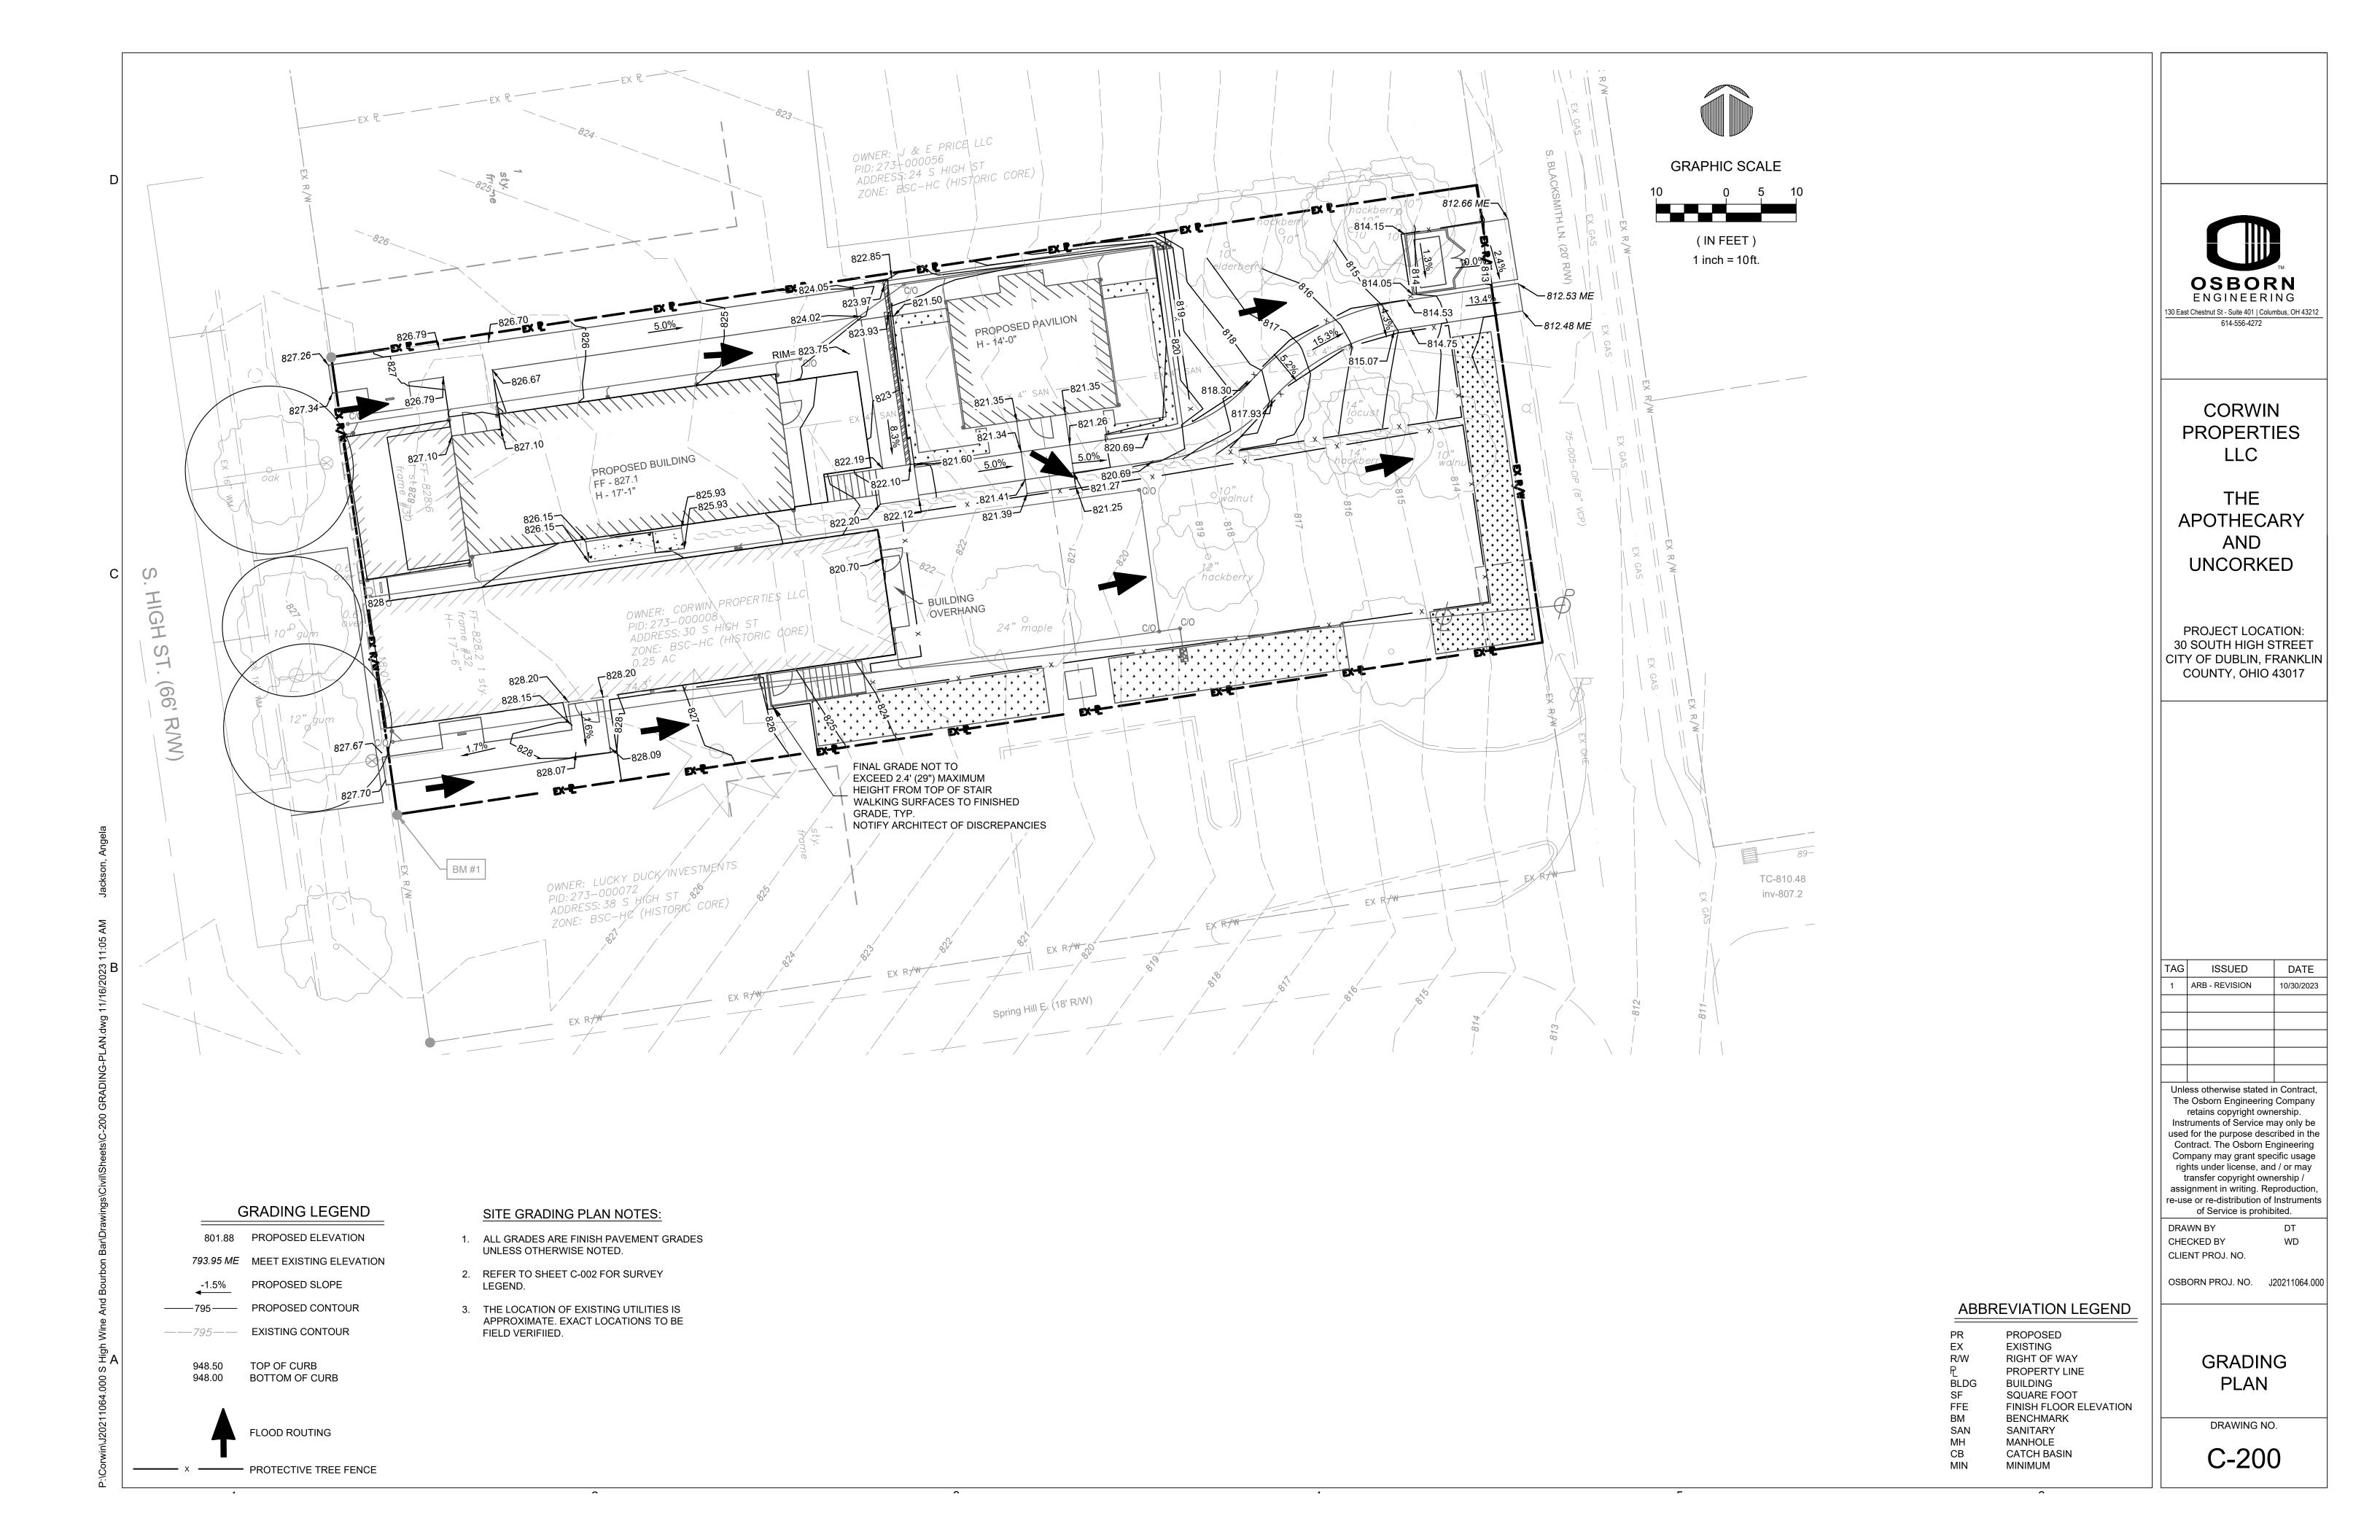

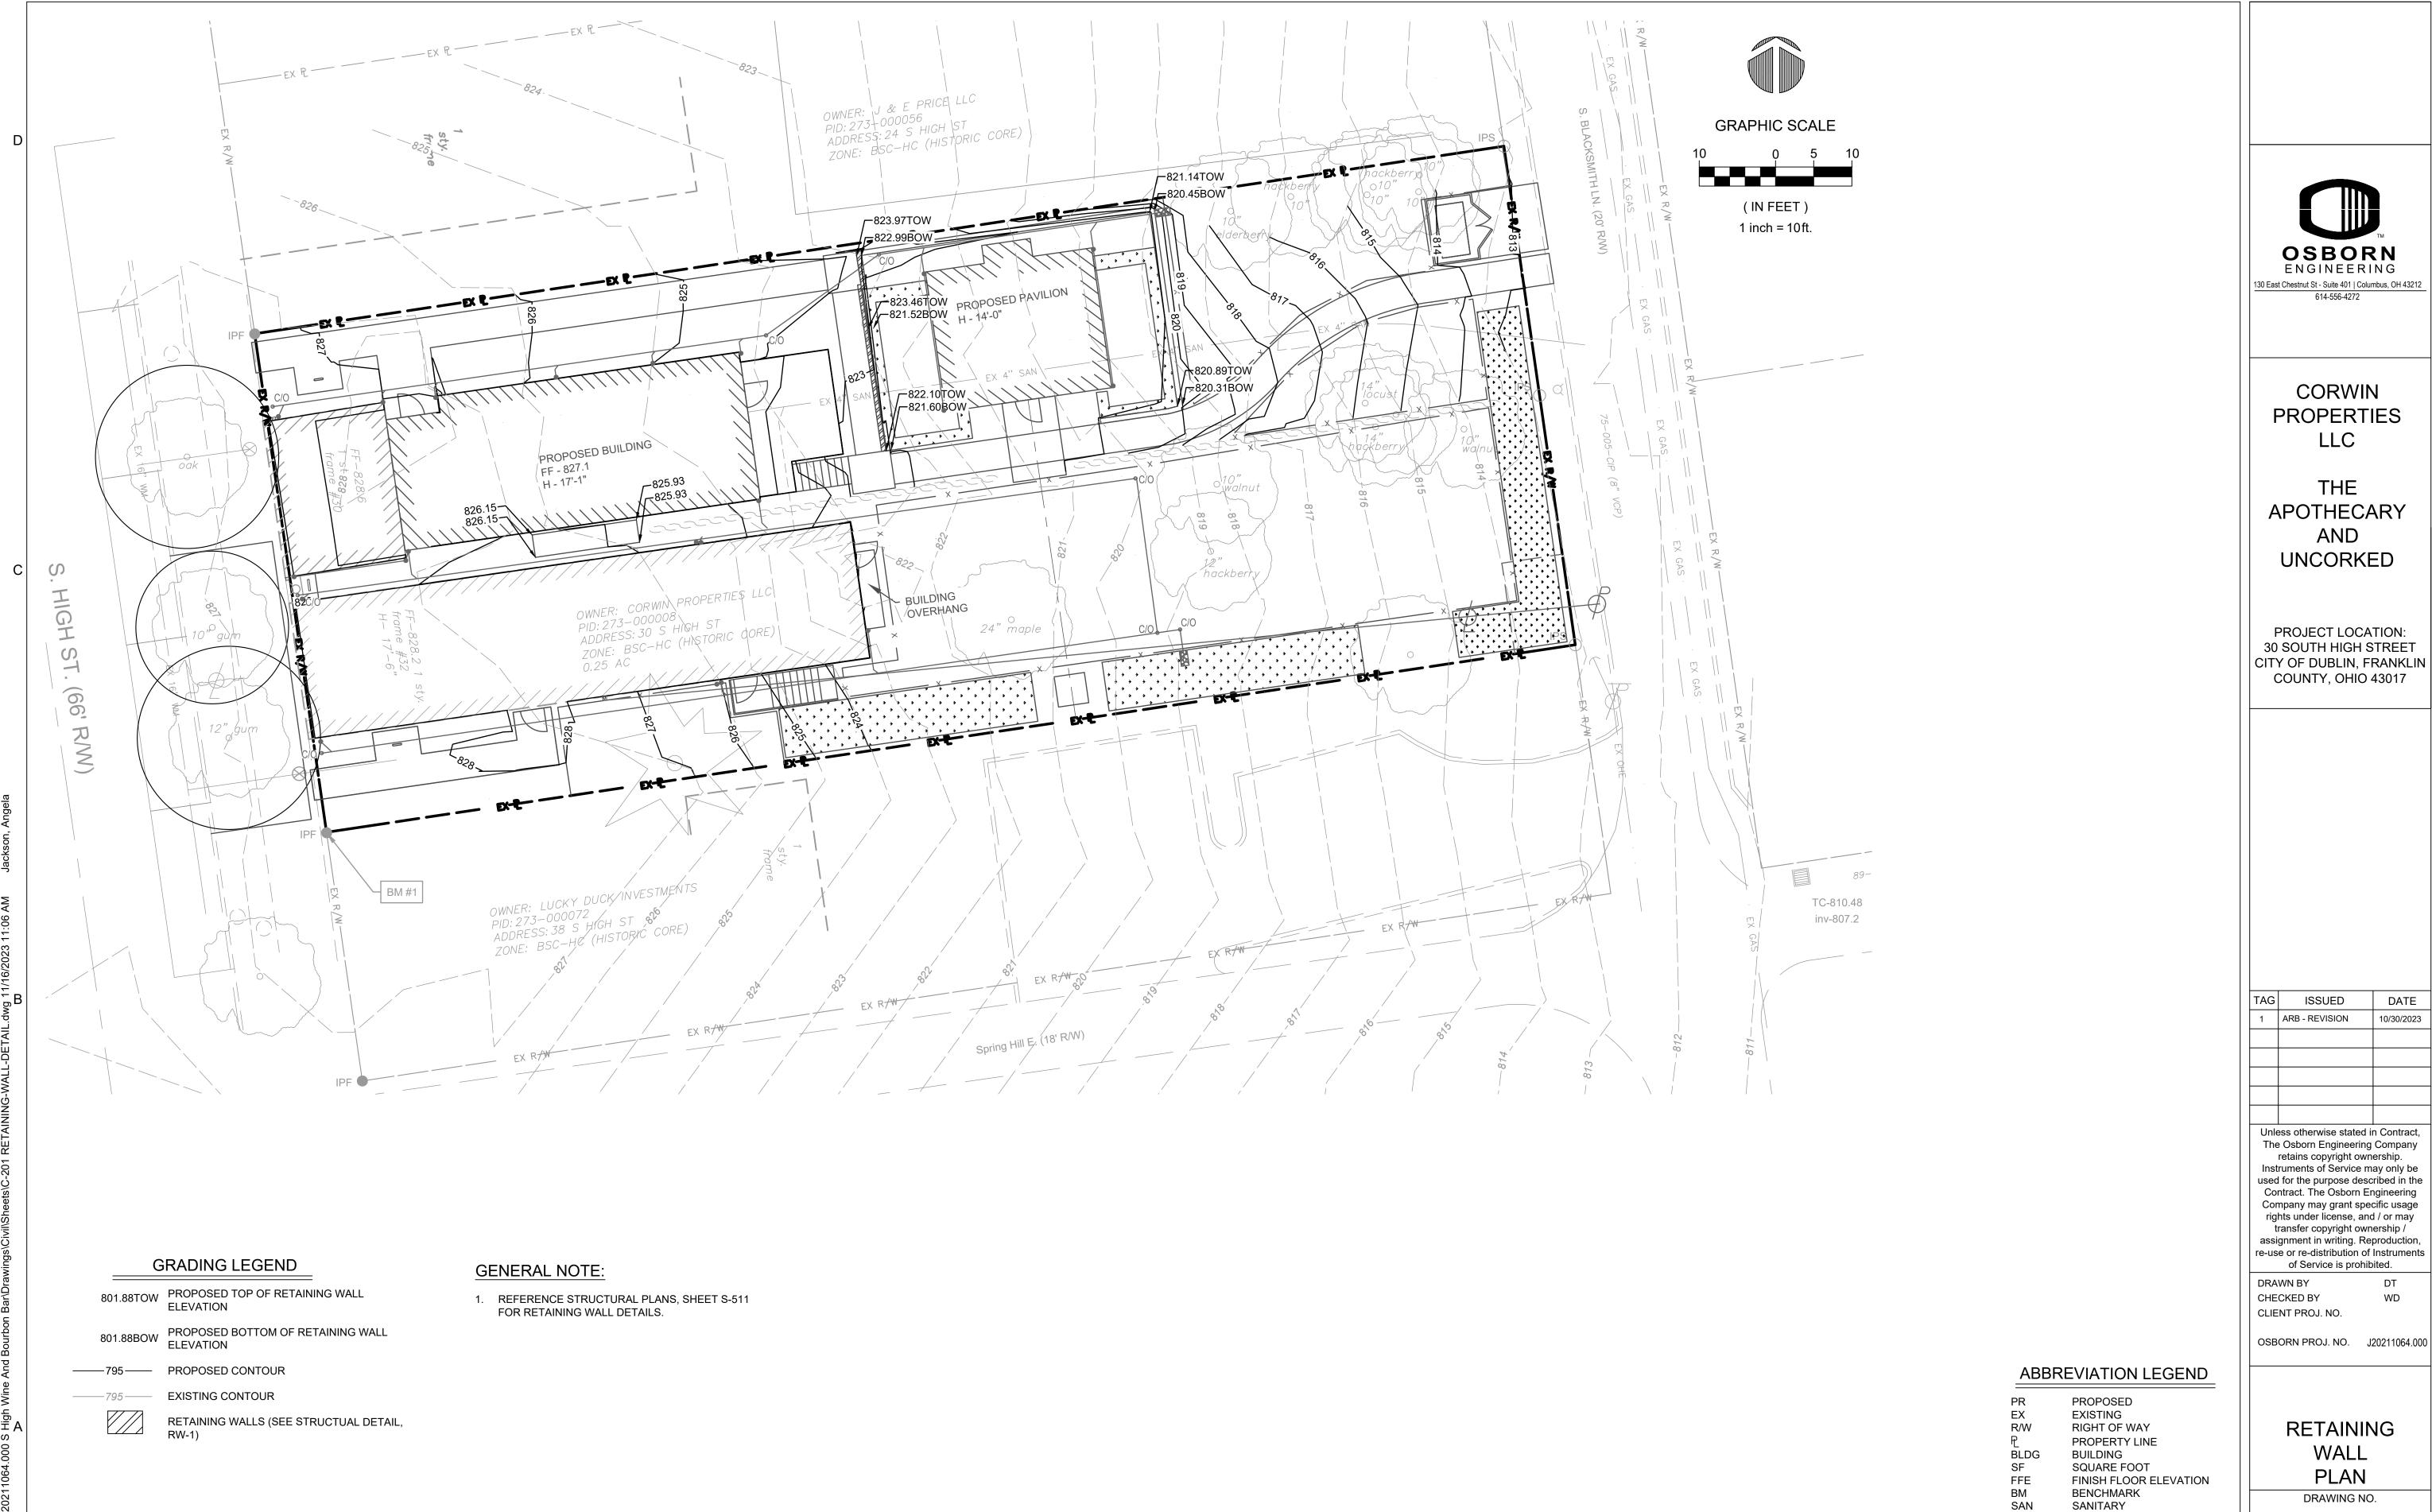

OSBORN ENGINEERING 130 East Chestnut St - Suite 401 | Columbus, OH 43212

**PROPERTIES** 

APOTHECARY UNCORKED

30 SOUTH HIGH STREET CITY OF DUBLIN, FRANKLIN COUNTY, OHIO 43017

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DT WD

RETAINING


C-201

MANHOLE

MINIMUM

CB

CATCH BASIN

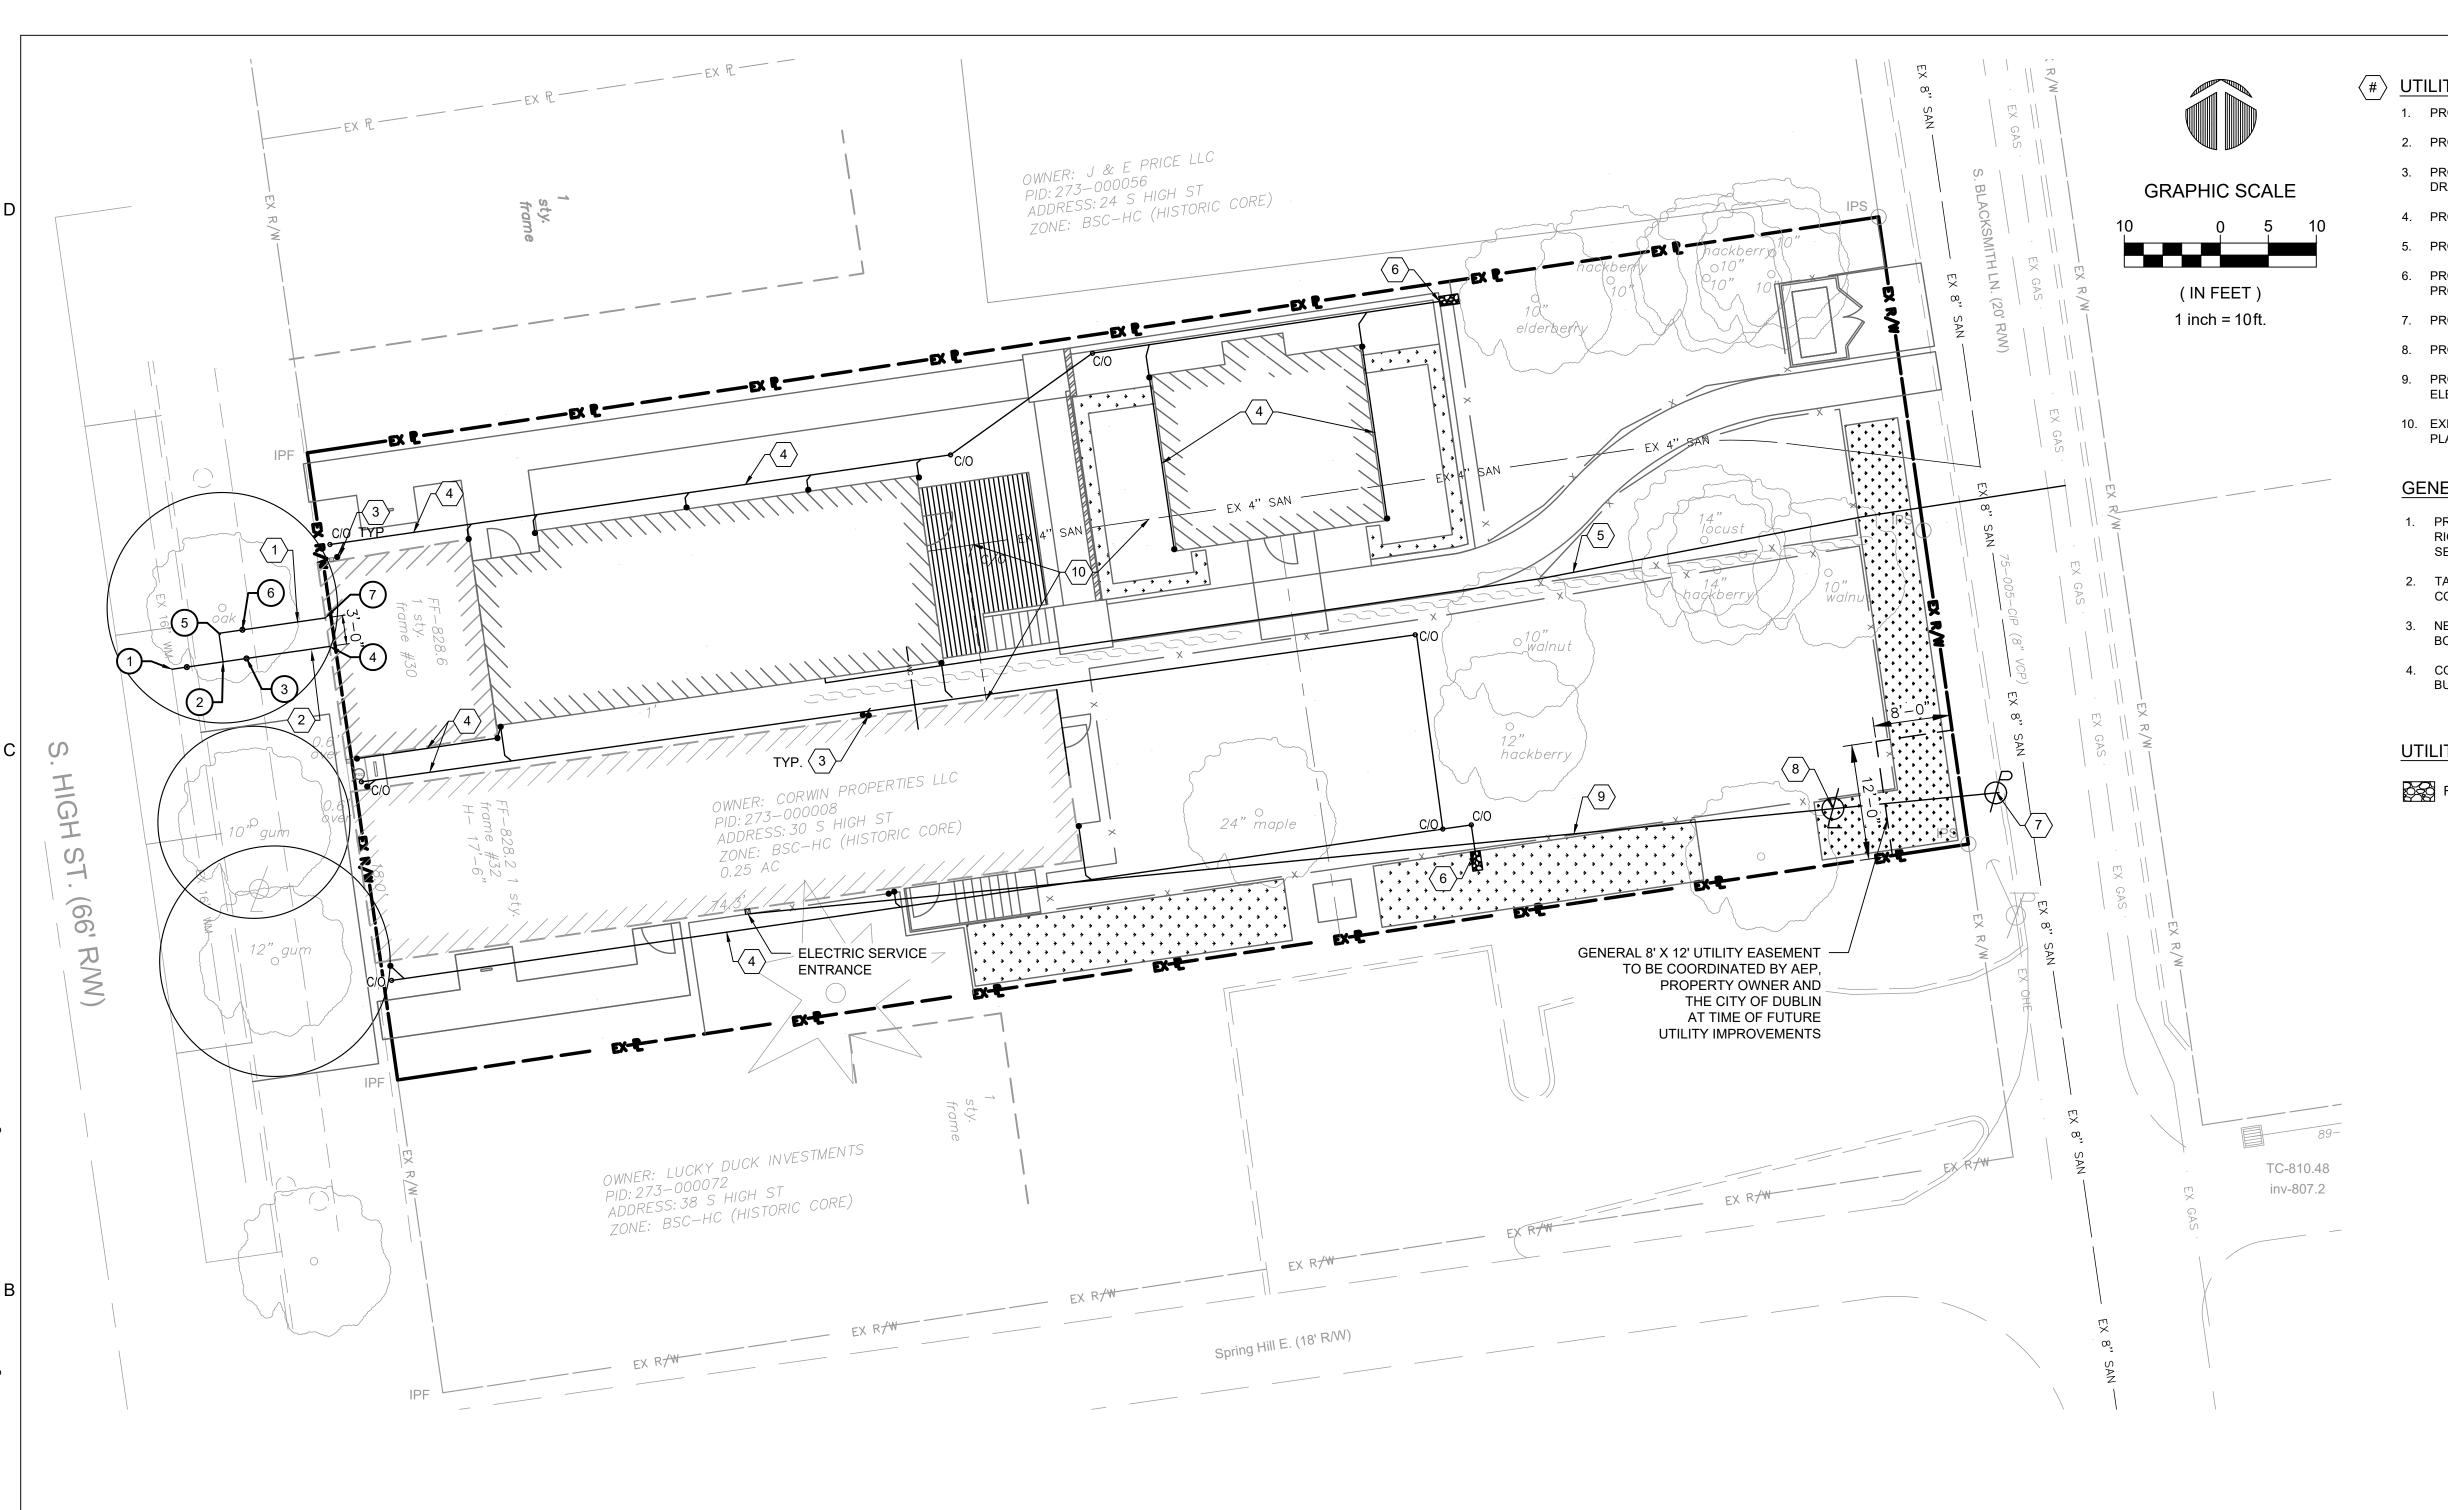

- 1. PROPOSED 1.5" DOMESTIC WATER SERVICE.
- 2. PROPOSED 4" FIRE PROTECTION SERVICE.
- 3. PROPOSED 4" ROOF DOWNSPOUT (SEE ARCHITECTURAL DRAWINGS)
- 4. PROPOSED 4" ROOF DRAIN.
- 5. PROPOSED GAS LINE.
- 6. PROPOSED DAYLIGHT PIPE WITH ROCK CHANNEL PROTECTION.
- 7. PROPOSED AEP UTILITY POLE.
- 8. PROPOSED PRIVATE UTILITY POLE.
- 9. PROPOSED OVERHEAD ELECTRICAL SERVICE (SEE ELECTRICAL PLANS FOR DETAILS).
- 10. EXISTING CLAY TILE SANITARY TO REMAIN (SEE PLUMBING PLANS FOR DETAILS).

#### **GENERAL NOTES:**

- 1. PRIVATE UTILITY WORK (GAS, ELECTRIC, ETC.) WITHIN RIGHT-OF-WAY AND/OR PUBLIC EASEMENT REQUIRE SEPARATE RIGHT-OF-WAY PERMIT(S).
- 2. TAPS INTO EXISTING SEWER SYSTEMS ARE TO BE CORE DRILLED AND CITY OF DUBLIN INSPECTED.
- 3. NEW SANITARY TAP IS TO PROVIDE SERVICE FOR BOTH BUILDINGS.
- 4. COORDINATE BUILDING UTILITY SERVICES WITH MEP BUILDING DRAWINGS

ABBREVIATION LEGEND

PROPOSED

RIGHT OF WAY PROPERTY LINE

FINISH FLOOR ELEVATION

**EXISTING** 

BUILDING SQUARE FOOT

BENCHMARK

SANITARY

MANHOLE CATCH BASIN MINIMUM

**CLEAN OUT** 

STORY

EX

R/W

BLDG

FFE

SAN

C/O

STY.

#### UTILITY LEGEND

ROCK CHANNEL PROTECTION

	TM TM
OSB ENGINE	
130 East Chestnut St - Suite	401   Columbus, OH 43212

614-556-4272

## CORWIN PROPERTIES LLC

# THE APOTHECARY AND UNCORKED

PROJECT LOCATION: 30 SOUTH HIGH STREET CITY OF DUBLIN, FRANKLIN COUNTY, OHIO 43017

TAG	ISSUED	DATE
1	ARB - REVISION	10/30/2023

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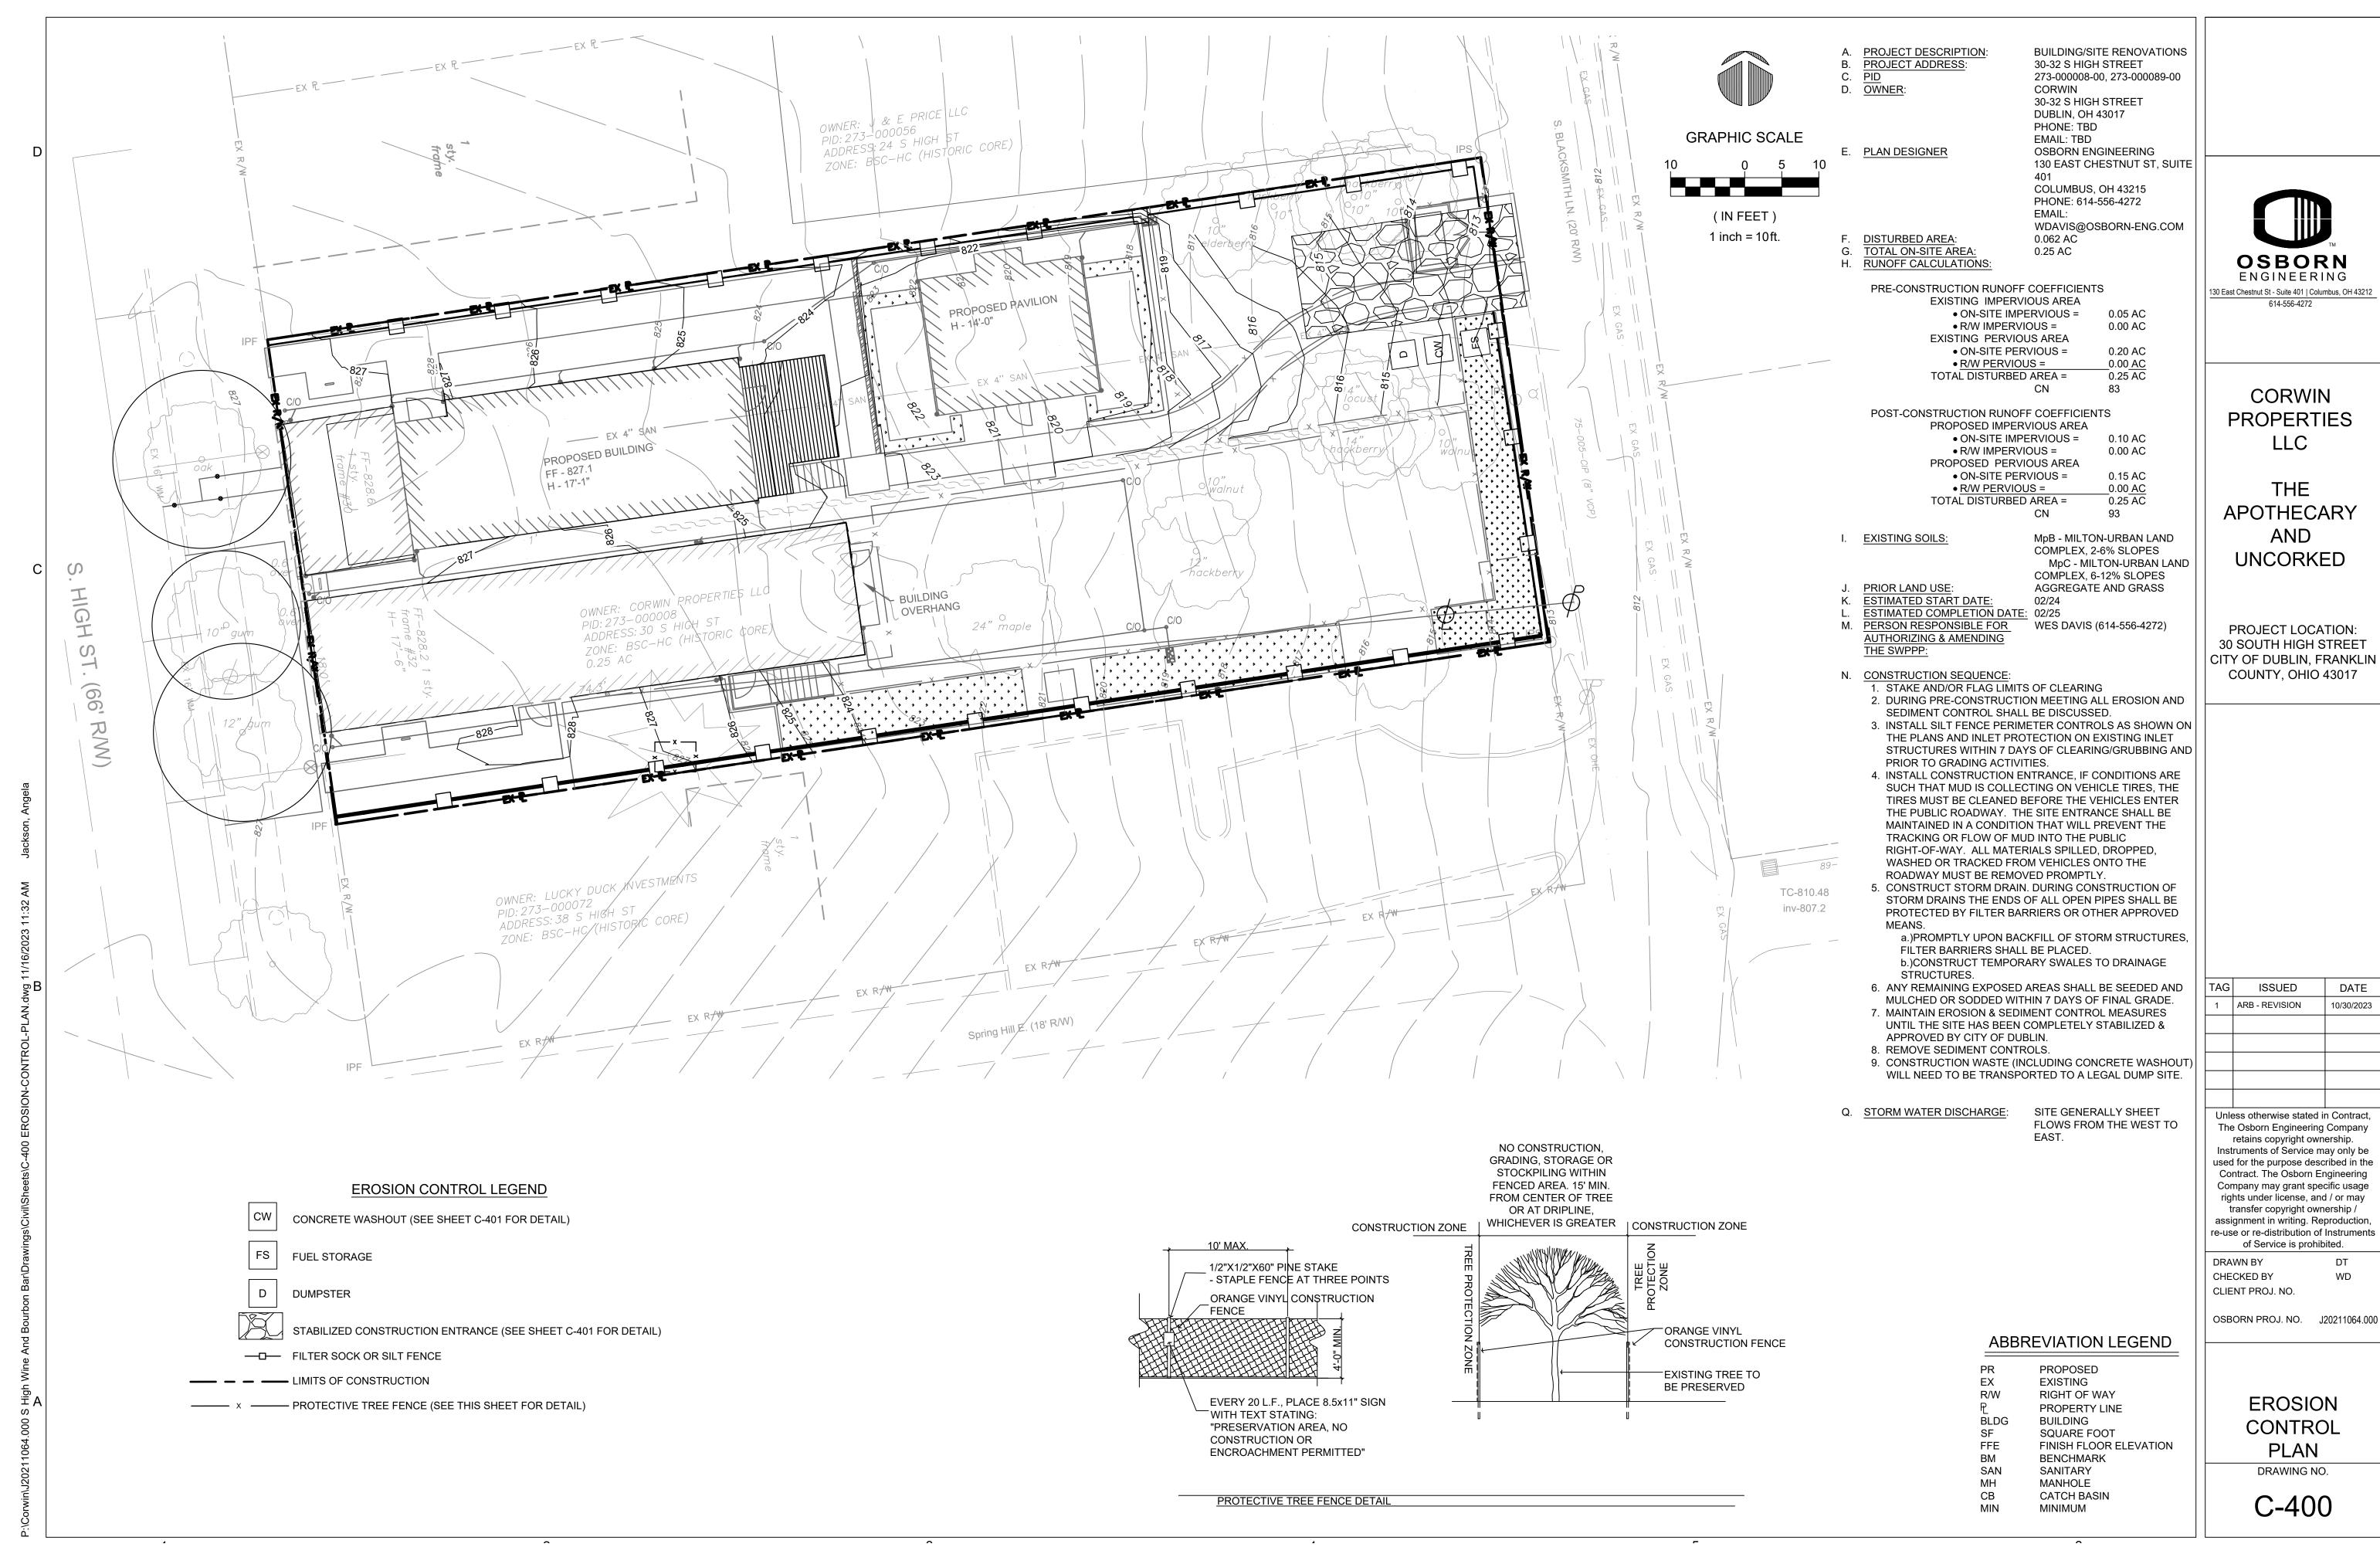
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UTILITY PLAN

DRAWING NO.

C-300

WATER SERVICE COORDINATE TABLE						
Point	Northing	Easting	Description			
1	765080.62	1796837.92	16" X 4" TAPPING SLEEVE & VALVE W/ COLUMBUS HDVB			
2	765081.39	1796843.25	1.5" TAP (CORP.)			
3	765081.76	1796845.69	4" WATER SERVICE VALVE & COLS. STD. VB			
4	765082.99	1796854.33	4" FWS BUILDING ENTRANCE			
5	765084.26	1796842.95	1.5" 90° HORIZ. DEFLECTION			
6	765084.74	1796845.26	1.5" CURB STOP & BOX			
7	765085.96	1796853.90	1.5" DWS BUILDING ENTRANCE			



10/30/2023

#### QUALITY CONTROL

- 1. LAND-DISTURBING ACTIVITIES MUST COMPLY WITH ALL APPLICABLE LOCAL CODES, REGULATIONS AND ORDINANCES. ALL LAND-DISTURBING ACTIVITIES SHALL BE SUBJECT TO INSPECTION AND SITE INVESTIGATION BY THE LOCAL JURISDICTIONAL AUTHORITY AND/OR THE STATE EPA. FAILURE TO COMPLY WITH LOCAL CODES, REGULATIONS AND/OR ORDINANCES IS SUBJECT TO LEGAL ENFORCEMENT ACTION. IN ADDITION, DUMPING OF MATERIALS INTO THE STORM SEWERS WILL NOT BE PERMITTED.
- ALL EROSION AND SEDIMENT CONTROL PRACTICES ARE SUBJECT TO FIELD MODIFICATION AT THE DISCRETION OF THE LOCAL JURISDICTIONAL AUTHORITY AND/OR THE STATE EPA.
- 3. ALL EROSION AND SEDIMENTATION CONTROL MEASURES ARE TO BE INSPECTED AT LEAST ONCE EVERY 7 DAYS AND WITHIN 24 HOURS AFTER ANY STORM EVENT GREATER THAN 0.5 INCHES PER 24 HOUR PERIOD. IF THE INSPECTION REVEALS THAT A CONTROL PRACTICE IS IN NEED OF REPAIR OR MAINTENANCE, WITH THE EXCEPTION OF A SEDIMENT SETTLING POND, IT MUST BE REPAIRED OR MAINTAINED WITHIN 3 DAYS OF THE INSPECTION. SEDIMENT SETTLING PONDS MUST BE REPAIRED WITHIN 10 DAYS OF THE INSPECTION.

#### GENERAL

- ALL DEWATERING FLOWS SHALL BE SILT-FREE PRIOR TO DISCHARGE, AND DISCHARGE SHALL BE DIRECTED TO STABILIZED SITES SUCH AS STREAMS, PONDS, STORM SEWERS OR EXISTING GRASSED DRAINAGE WAYS ACCEPTABLE TO THE OWNER. NOT ONTO EXPOSED SOILS OR ANY OTHER SITE WHERE FLOWS COULD CAUSE EROSION.
- 2. THE CONTRACTOR SHALL INITIATE APPROPRIATE VEGETATIVE PRACTICES ON ALL DISTURBED AREAS WITHIN SEVEN (7) DAYS IF THEY ARE TO REMAIN DORMANT (UNDISTURBED) FOR MORE THAN TWENTY-ONE (21) DAYS. FOR AREAS WITHIN FIFTY (50) FEET OF ANY STREAM, FIRST ORDER OR LARGER (CREEK IS FIRST ORDER), SOIL STABILIZATION PRACTICES SHALL BE INITIATED WITHIN TWO (2) DAYS ON ALL INACTIVE, DISTURBED AREAS AND WITHIN SEVEN (7) DAYS AFTER FINAL GRADE IS REACHED ON ANY PORTION OF THE SITE. IF DUE TO WEATHER, FINAL GRADING CANNOT BE ACCOMPLISHED IMMEDIATELY, MULCHING AND TEMPORARY SEEDING IF FEASIBLE, OR SOME OTHER TYPE OF TEMPORARY EROSION CONTROL MEASURES MUST BE USED WITHIN SEVEN (7) DAYS UNTIL LONG-TERM RESTORATION CAN OCCUR. WHEN SEASONAL CONDITIONS PROHIBIT THE APPLICATION OF TEMPORARY OR PERMANENT SEEDING, NON-VEGETATIVE SOIL STABILIZATION PRACTICES SUCH AS MULCHING AND MATTING SHALL BE USED. ANY AREAS AT FINAL GRADE OR THAT WILL LIE DORMANT FOR ONE YEAR OR MORE REQUIRE PERMANENT SEEDING WITHIN SEVEN DAYS OF THE MOST RECENT DISTURBANCE.
- 3. ANY AREAS AT FINAL GRADE OR THAT WILL LIE DORMANT FOR MORE THAN ONE YEAR OR MORE SHALL BE PERMANENTLY SEEDED WITHIN SEVEN DAYS OF THE MOST RECENT DISTURBANCE. THE SEEDED ARE WILL BE CONSIDERED STABILIZED WHEN THERE IS A 70% VEGETATIVE DENSITY.
- 4. PRESERVATION SHALL TAKE PRECEDENCE OVER REMOVAL WITHIN THE TEMPORARY WORK LIMITS. REMOVE ONLY THOSE TREES. SHRUBS AND STRUCTURES NECESSARY TO COMPLETE CONSTRUCTION AND MAINTAIN THE NEW FACILITIES. REPLACEMENT "IN-KIND" OF REMOVED ITEMS SHOULD OCCUR WHEREVER POSSIBLE
- 5. STOCKPILED TOPSOIL AND MATERIALS SHALL BE PROTECTED WITH EROSION CONTROL BARRIERS OR
- 6. EXCESS SOIL THAT IS STOCKPILED MUST BE EITHER REMOVED OR REGRADED WITHIN 15 DAYS OF THE COMPLETION OF THE CONSTRUCTION.
- 7. NO FILL, TOPSOIL OR HEAVY EQUIPMENT SHALL BE STORED WITHIN 200 FEET OF A STREAM BANK OR WITHIN THE DRIPLINE OF TREE AREAS.
- 8. ALL DISTURBED VEGETATION IS TO BE RESEEDED AS PART OF RESTORATION UNLESS THE AREAS WILL BE PAVED OR OCCUPIED.
- 9. ONLY WATER OR CALCIUM CHLORIDE WILL BE USED AS A DUST PALLIATIVE.
- 10. CONTRACTOR SHALL INSPECT ALL INSTALLATIONS OF SOIL EROSION AND SEDIMENTATION CONTROL METHODS DAILY, ANY DAMAGED OR NON FUNCTIONAL AREAS SHALL BE REPAIRED IMMEDIATELY AND MAINTAINED THROUGH THE DURATION OF THE PROJECT OR UNTIL STABILIZED VEGETATION IS ESTABLISHED.
- 11. SEDIMENT CONTROL STRUCTURES SHALL BE FUNCTIONAL THROUGHOUT EARTH DISTURBING ACTIVITY. SEDIMENT PONDS AND PERIMETER SEDIMENT BARRIERS SHALL BE IMPLEMENTED AS THE FIRST STEP OF GRADING AND WITHIN SEVEN DAYS FROM THE START OF GRUBBING. THEY SHALL CONTINUE TO FUNCTION UNTIL THE UPSLOPE DEVELOPMENT AREA IS RESTABILIZED.
- 12. IN THE EVENT OF CONFLICT BETWEEN THESE REQUIREMENTS AND POLLUTION CONTROL LAWS, RULES OR REGULATIONS OF OTHER FEDERAL, STATE, OR LOCAL AGENCIES, THE MORE RESTRICTIVE LAWS, RULES OR REGULATIONS SHALL APPLY.

#### SILT FENCE

- FILTER FABRIC MATERIAL FOR SILT FENCE SHALL BE PURCHASED IN A CONTINUOUS ROLL. CUT TO THE LENGTH OF THE BARRIER TO AVOID THE USE OF JOINTS.
- 2. THE HEIGHT OF A SILT FENCE SHALL NOT EXCEED 36 INCHES (HIGHER FENCES MAY IMPOUND VOLUMES OF WATER SUFFICIENT TO CAUSE FAILURE OF THE STRUCTURE).
- 3. POSTS SHALL BE SPACED A MAXIMUM OF 10 FEET APART AT THE BARRIER LOCATION AND DRIVEN SECURELY INTO THE GROUND (MINIMUM 18 INCHES).
- 4. A TRENCH SHALL BE EXCAVATED APPROXIMATELY 4 INCHES WIDE AND 4 INCHES DEEP FOR THE SILT FENCE ALONG THE LINE OF POSTS, UPSLOPE FROM THE BARRIER.
- 5. THE TRENCH SHALL BE BACKFILLED AND THE SOIL COMPACTED OVER THE FILTER MATERIAL.
- 6. THE SILT FENCES SHALL BE REMOVED WHEN THEY HAVE SERVED THEIR USEFUL PURPOSE, BUT NOT BEFORE THE UPSLOPE AREA HAS BEEN PERMANENTLY STABILIZED.
- 7. THE CONTRACTOR SHALL MAINTAIN SILT FENCE UNTIL UPSLOPE AREA HAS BEEN PERMANENTLY

#### SILT FENCE MAINTENANCE

- SILT FENCES SHALL BE INSPECTED IMMEDIATELY AFTER EACH RAINFALL AND AT LEAST DAILY DURING PROLONGED RAINFALL. ANY REQUIRED REPAIRS SHALL BE MADE IMMEDIATELY. EXTRA CARE SHALL BE TAKEN TO MAINTAIN SILT FENCE NEAR POND.
- 2. SHOULD THE FABRIC ON THE SILT FENCE DECOMPOSE OR BECOME INEFFECTIVE PRIOR TO THE END OF THE EXPECTED USABLE LIFE AND THE BARRIER IS STILL NECESSARY, THE FABRIC SHALL BE REPLACED
- SEDIMENT DEPOSITS SHOULD BE REMOVED AFTER EACH STORM EVENT. THEY MUST BE REMOVED WHEN DEPOSITS REACH APPROXIMATELY ONE-HALF THE HEIGHT OF THE BARRIER.
- 4. ANY SEDIMENT DEPOSITS REMAINING IN PLACE AFTER THE SILT FENCE IS NO LONGER REQUIRED SHALL BE DRESSED TO CONFORM WITH THE EXISTING GRADE, PREPARED AND SEEDED.

#### **GENERAL NOTES**

- 5. ALL GRADES SHOWN ARE FINAL FINISH GRADES.
- 6. MEET ALL EXISTING GRADES FLUSH, INCLUDING EXISTING CURBS.
- 7. ALL LAWN AREAS TO MEET PAVEMENT EDGES FLUSH, UNLESS NOTED OTHERWISE ON THE PLAN.
- 8. ALL LAWN AREAS TO HAVE 2% MIN. SLOPE.
- 9. ALL PROPOSED CURBS ARE 6" HIGH, UNLESS NOTED OTHERWISE ON PLAN.
- 10. ALL SPOT ELEVATIONS AT CURBS ARE AT BOTTOM OF CURB, UNLESS NOTED OTHERWISE ON PLAN.
- 11. FOR ALL CURBS THAT DO NOT TERMINATE INTO A WALL OR ANOTHER CURB, TAPER FROM A 6" REVEAL TO 0"

#### OVER 2'-0," AT CURB TERMINATION.

- 12. OWNER TO PROVIDE GEOTECHNICAL REPORT.
- 13. REMOVE UNSUITABLE MATERIALS TO A DEPTH OF AT LEAST 18" BELOW PAVEMENT SUBGRADE ELEVATIONS AND REPLACE W/ ENGINEERED FILL, PER THE PROJECT GEOTECHNICAL REPORT, AND AS DIRECTED ON SITE, BY THE GEOTECHNICAL ENGINEER.
- 14. REFER TO UTILITY PLAN FOR HORIZONTAL LOCATIONS OF DRAINAGE STRUCTURES.
- 15. ALL SITE UTILITIES, INCLUDING SITE DRAINAGE, ARE SHOWN FOR REFERENCE ONLY. SEE SITE ELECTRICAL
- 16. REFER TO SURVEY DRAWING FOR BENCHMARK INFORMATION.

#### SPECIFICATIONS FOR MULCH

- MULCH AND/OR OTHER APPROPRIATE VEGETATIVE PRACTICES SHALL BE APPLIED TO DISTURBED AREAS WITHIN 7 DAYS OF GRADING IF THE AREA IS TO REMAIN DORMANT (UNDISTURBED) FOR MORE THAN 14 DAYS OR ON AREAS AND PORTIONS OF THE SITE WHICH CAN BE BROUGHT TO FINAL GRADE.
- 2. MULCH SHALL CONSIST OF ONE OF THE FOLLOWING:
- A. STRAW STRAW SHALL BE UNROTTED SMALL GRAIN STRAW APPLIED AT THE RATE OF 2 TONS/AC. OR 90LBS/1,000 SQ. FT. (TWO TO THREE BALES). THE STRAW MULCH SHALL BE SPREAD UNIFORMLY BY HAND OR MECHANICALLY SO THE SOIL SURFACE IS HAND-SPEAD MULCH, DIVIDE AREA INTO APPROXIMATELY 1,000 SQ FT SECTIONS AND PLACE TWO 45-LB. BALES OF STRAW IN EACH SECTION.
- B. HYDROSEEDERS WOOD CELLULOSE FIBER SHOULD BE USED AT 2,000 LB/AC OR 46 LB/1,000 SQ. FT.
- C. OTHER OTHER ACCEPTABLE MULCHES INCLUDE MULCH MATTINGS APPLIED ACCORDING TO MANUFACTURE'S RECOMMENDATIONS OR WOOD CHIPS APPLIED AT 10-20 TONS/AC.
- MULCH ANCHORING MULCH SHALL BE ANCHORED IMMEDIATELY TO MINIMIZE LOSS BY WIND OR RUNOFF THE FOLLOWING ARE ACCEPTABLE METHODS FOR ANCHORING MULCH.
- MECHANICAL USE A DISK, CRIMPER, OR SIMILAR TYPE TOOL SET STRAIGHT TO PUNCH OR ANCHOR THE MULCH MATERIAL INTO THE SOIL. STRAW MECHANICALLY ANCHORED SHALL NOT BE FINELY CHOPPED BUT BE LEFT GENERALLY LONGER THAN 6 INCHES.
- MULCH NETTINGS USE ACCORDING TO THE MANUFACTURER'S RECOMMENDATIONS, FOLLOWING ALL PLACEMENT AND ANCHORING SUGGESTIONS. USE IN AREAS OF WATER CONCENTRATION AND STEEP SLOPES TO HOLD MULCH IN PLACE.
- C. ASPHALT EMULSION FOR STRAW MULCH, APPLY AT THE RATE OF 160 GAL/AC (0.1 GAL/SY) INTO THE MULCH AS IT IS BEING APPLIED OR AS RECOMMENDED BY THE MANUFACTURE.
- D. SYNTHETIC BINDERS FOR STRAW MULCH, SYNTHETIC BINDERS AS ACRYLIC DLR(AGRI-TAC), DCA-70, PETROSET, TERRA TACK OR EQUAL MAY BE USED AT RATES RECOMMENDED BY THE MANUFACTURER.
- E. WOOD CELLULOSE FIBER WOOD CELLULOSE FIBER MAY ME USED FOR ANCHORING STRAW. THE FIBER BINDER SHALL BE APPLIED AT A NET DRY WEIGHT OF 750 LB.AC. THE WOOD CELLULOSE FIBER SHALL BE MIXED WITH WATER AND THE MIXTURE SHALL CONTAIN A MAXIMUM OF 50 LB/100 GAL OF WOOD CELLULOSE FIBER.

#### SPECIFICATIONS FOR TEMPORARY SEEDING

#### TEMPORARY SEEDING SPECIES SELECTION

SEEDING DATES	SPECIES L	.B/1,000 SQ.FT.	PER ACRE
MARCH 1 TO AUGUST 15	OATS TALL FESCUE ANNUAL RYEGRASS PERENNIAL RYEGRAS TALL FESCUE ANNUAL RYEGRASS	3 1 1 S 1 1	4 BUSHEL 40 LB 40 LB 40 LB 40 LB 40 LB
AUGUST 16 TO NOVEMBER 1	RYE TALL FESCUE ANNUAL RYEGRASS	3 1 1	2 BUSHEL 40 LB 40 LB
	WHEAT TALL FESCUE ANNUAL RYEGRASS PERENNIAL RYEGRAS TALL FESCUE ANNUAL RYEGRAS	1	2 BUSHEL 40 LB 40 LB 40 LB 40 LB 40 LB

NOVEMBER 1 TO SPRING SEEDING USE MULCH ONLY, SODDING PRACTICES OR DORMANT SEEDING.

#### NOTE: OTHER APPROVED SEED SPECIES MAY BE SUBSTITUTED.

- 1. STRUCTURAL EROSION AND SEDIMENT CONTROL PRACTICES SUCH AS DIVERSIONS AND SEDIMENT TRAPS SHALL BE INSTALLED AND STABILIZED WITH TEMPORARY SEEDING PRIOR TO GRADING THE REST OF THE CONSTRUCTION SITE.
- TEMPORARY SEED SHALL BE APPLIED BETWEEN CONSTRUCTION OPERATIONS ON SOIL THAT WILL NOT BE GRADED OR REWORKED FOR 21 DAYS OR MORE. THESE IDLE AREAS SHOULD BE SEEDED AS SOON AS POSSIBLE AFTER GRADING OR SHALL BE SEEDED WITHIN 7 DAYS. SEVERAL APPLICATIONS OF TEMPORARY SEEDING ARE NECESSARY ON TYPICAL CONSTRUCTION PROJECTS.
- 3. THE SEEDBED SHOULD BE PULVERIZED AND LOOSE TO ENSURE THE SUCCESS OF ESTABLISHING VEGETATION. HOWEVER, TEMPORARY SEEDING SHALL NOT BE POSTPONED IF IDEAL SEEDBED PREPARATION IS NOT POSSIBLE.
- 4. SOIL AMENDMENTS APPLICATION OF TEMPORARY VEGETATION SHALL ESTABLISH ADEQUATE STANDS OF VEGETATION WHICH MAY REQUIRE THE USE OF SOIL AMENDMENTS. SOIL TESTS SHOULD BE TAKEN ON THE SITE TO PREDICT THE NEED FOR LIME AND FERTILIZER.
- SEEDING METHOD SEED SHALL BE APPLIED UNIFORMLY WITH A CYCLONE SEEDER, DRILL, CULTIPACKER SEEDER, OR HYDROSEEDER. WHEN FEASIBLE, SEED THAT HAS BEEN BROADCAST SHALL BE COVERED BY RAKING OR DRAGGING AND THEN LIGHTLY TAMPED INTO PLACE USING A ROLLER OR CULTIPACKER. IF HYDROSEEDING IS USED, THE SEED AND FERTILIZER WILL BE MIXED ON-SITE AND THE SEEDING SHALL BE DONE IMMEDIATELY AND WITHOUT INTERRUPTION.

#### SPECIFICATIONS FOR PERMANENT SEEDING

PLANTING TIME: PROCEED WITH - AND COMPLETE - LAWN WORK AS RAPIDLY A PORTIONS OF THE SITE BECOME AVAILABLE, WORKING WITHIN SEASONAL LIMITATIONS FOR EACH KIND OF LANDSCAPE WORK REQUIRED. NORMAL SEEDING TIMES ARE AS FOLLOWS:

- MARCH 15 TO JUNE 10
- AUGUST 15 TO OCTOBER 1

SEEDING DURING OTHER THAN NORMAL SEEDING TIMES SHALL BE PERFORMED ONLY WITH THE PRIOR WRITTEN PERMISSION OF THE LANDSCAPE ARCHITECT WITH THE UNDERSTANDING THAT THE CONTRACT WILL THEREFOR BE ALTERED BY THE CHANGE ORDER.

GRASS SEED: PROVIDE FRESH, CLEAN, NEW CROP SEED COMPLYING WITH TOLERANCE FOR PURITY AND GERMINATION ESTABLISHED BY THE OFFICIAL SEED ANALYSTS OF MINIMUM PERCENTAGES OF PURITY, GERMINATION AND MAXIMUM PERCENTAGES OF WEED SEED, AS FOLLOWS:

BOTANICAL AND COMMON NAME SECOND MILLENNIUM		ENTAGE EIGHT MUM)	PERC PURIT (MINII	• •	PERCENTAGE GERMINATION (MINIMUM)	PERCENTAGE WEED SEED (MINIMUM)
TALL FESCUE		20%		85%	80%	1.00%
INFERNO TALL FESCUE		20%		85%	80%	1.00%
CROSSFIRE II TALL FESCUE	2	0%		85%	80%	1.00%
AVENGER TALL FESCUE		20%		85%	80%	1.00%
BRIGHTSTAR SLT PERENNIAL RYEGRASS		10%		85%	80%	1.00%
BROOKLAWN KENTUCKY BLUEGRASS		10%		85%	80%	1.00%


PERFORM ALL LIMING, FERTILIZING, RAKING, AND COMPACTING OPERATIONS ONLY AT TIMES WHEN LOCAL WEATHER AND OTHER CONDITIONS AFFECTING SUCH WORK ARE NORMAL AND FAVORABLE TO THE PROPER PROSECUTION OF THE PARTICULAR WORK WITHIN THE DATES SPECIFIED OR WITHIN AN EXTENDED PERIOD OF TIME APPROVED BY THE OWNER'S REPRESENTATIVE.

FERTILIZING AND LIMING: THE CONTRACTOR SHALL INTRODUCE A 10-20-10 FERTILIZER AT THE RATE OF 20 POUNDS PER 100 SQUARE FEET. LIME OR OTHER ADDITIVES AT THE RATE APPROVED BY THE ARCHITECT. THE ABOVE ITEMS SHALL BE WORKED INTO THE TOP 2 INCHES OF SOIL AND SMOOTHED TO GRADE TO PREPARE A PROPER BED FOR SEEDING.


SOW SEED AT THE RATE OF 5 POUNDS PER 1000 SQUARE FEET FOR EACH AREA, UNIFORMLY, AND BY BROADCAST, DRILL, OR HAND SEEDING METHOD. IMMEDIATELY AFTER SOWING, RAKE DRAG, OR OTHERWISE TREAT THE AREA SO AS TO COVER THE SEED TO A DEPTH OF OF APPROXIMATELY 1/4 INCH.

NO SEEDING SHALL BE DONE DURING WINDY WEATHER, OR WHEN THE GROUND SURFACE IS MUDDY, FROZEN OR OTHERWISE NON-TILLABLE.

WHEN LANDSCAPE WORK IS COMPLETED, INCLUDING MAINTENANCE, THE LANDSCAPE ARCHITECT WILL MAKE AN INSPECTION TO DETERMINE ACCEPTABILITY.

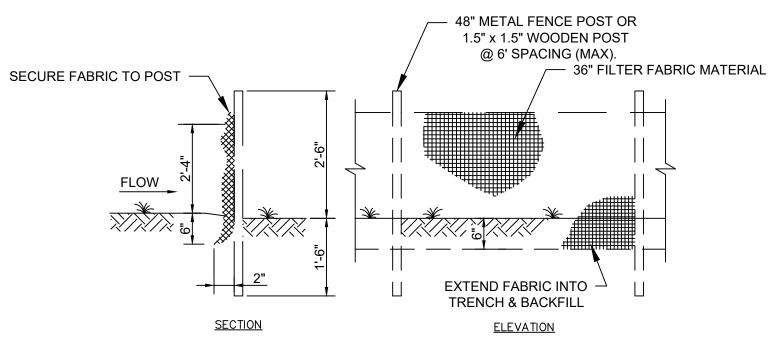


TYPE 1-SILT FENCE

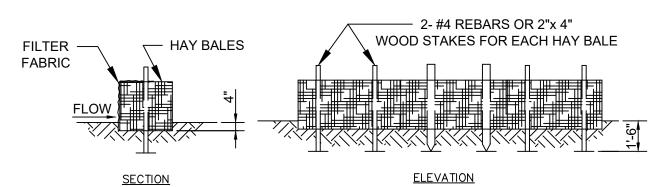


#### TYPE 2-HAY BALES

#### EROSION CONTROL DETAILS SEDIMENT BARRIRERS NOT TO SCALE

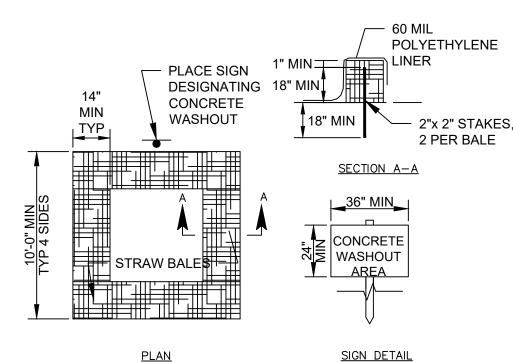

A CONCRETE WASHOUT AREASHALL BE DESIGNATED TO CLEAN CONCRETE TRUCKS AND TOOLS. AT NO TIME SHALL CONCRETE PRODUCTS BE ALLOWED TO ENTER STREAMS OR DRAINS.

> CONCRETE WASHOUT BASIN DETAIL NOT TO SCALE

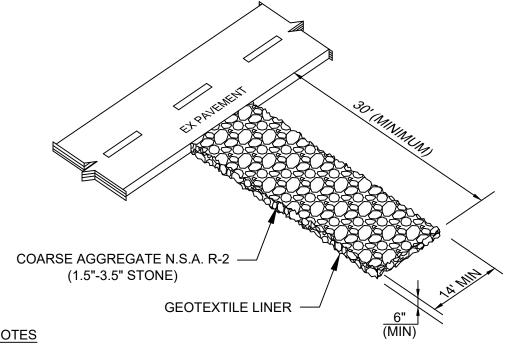

- 1. LOCATE STONE PAD AT ANY POINT WHERE VEHICULAR TRAFFIC WILL BE LEAVING THE SITE ONTO A PUBLIC RIGHT-OF-WAY STREET, ROADWAY, OR PARKING AREA.
- 2. PAD WIDTH 14-0" MINIMUM BUT NOT LESS THAN FULL WIDTH OF ALL POINTS OF VEHICULAR EGRESS. PAD LENGTH - 30'-0" MINIMUM.
- 3. MAINTAIN THE EXIT TO PREVENT TRACKING OR FLOW OF MUD ONTO PUBLIC RIGHT-OF-WAY. PROVIDE PERIODIC TOP DRESSING WITH 1.5-3.5" STONE, AS CONDITIONS DEMAND. IMMEDIATELY REMOVE ALL MATERIALS SPILLED, DROPPED, WASHED, OR TRACKED FROM VEHICLE OR SITE ONTO ROADWAY, INTO STORM DRAINS OR DITCHES.
- 4. CLEAN WHEELS TO REMOVE MUD PRIOR TO EXITING CONSTRUCTION SITE. WHEN WASHING IS REQUIRED, DO SO ON AREAS STABILIZED WITH CRUSHED STONE DRAINING INTO AN APPROVED SEDIMENT TRAP OR SEDIMENT BASIN.

**EROSION CONTROL DETAILS** CONSTRUCTION DRIVE STABILIZATION NOT TO SCALE



CORWIN **PROPERTIES** 

APOTHECARY UNCORKED

PROJECT LOCATION: 30 SOUTH HIGH STREET CITY OF DUBLIN, FRANKLIN COUNTY, OHIO 43017

ISSUED DATE ARB - REVISION 10/30/2023

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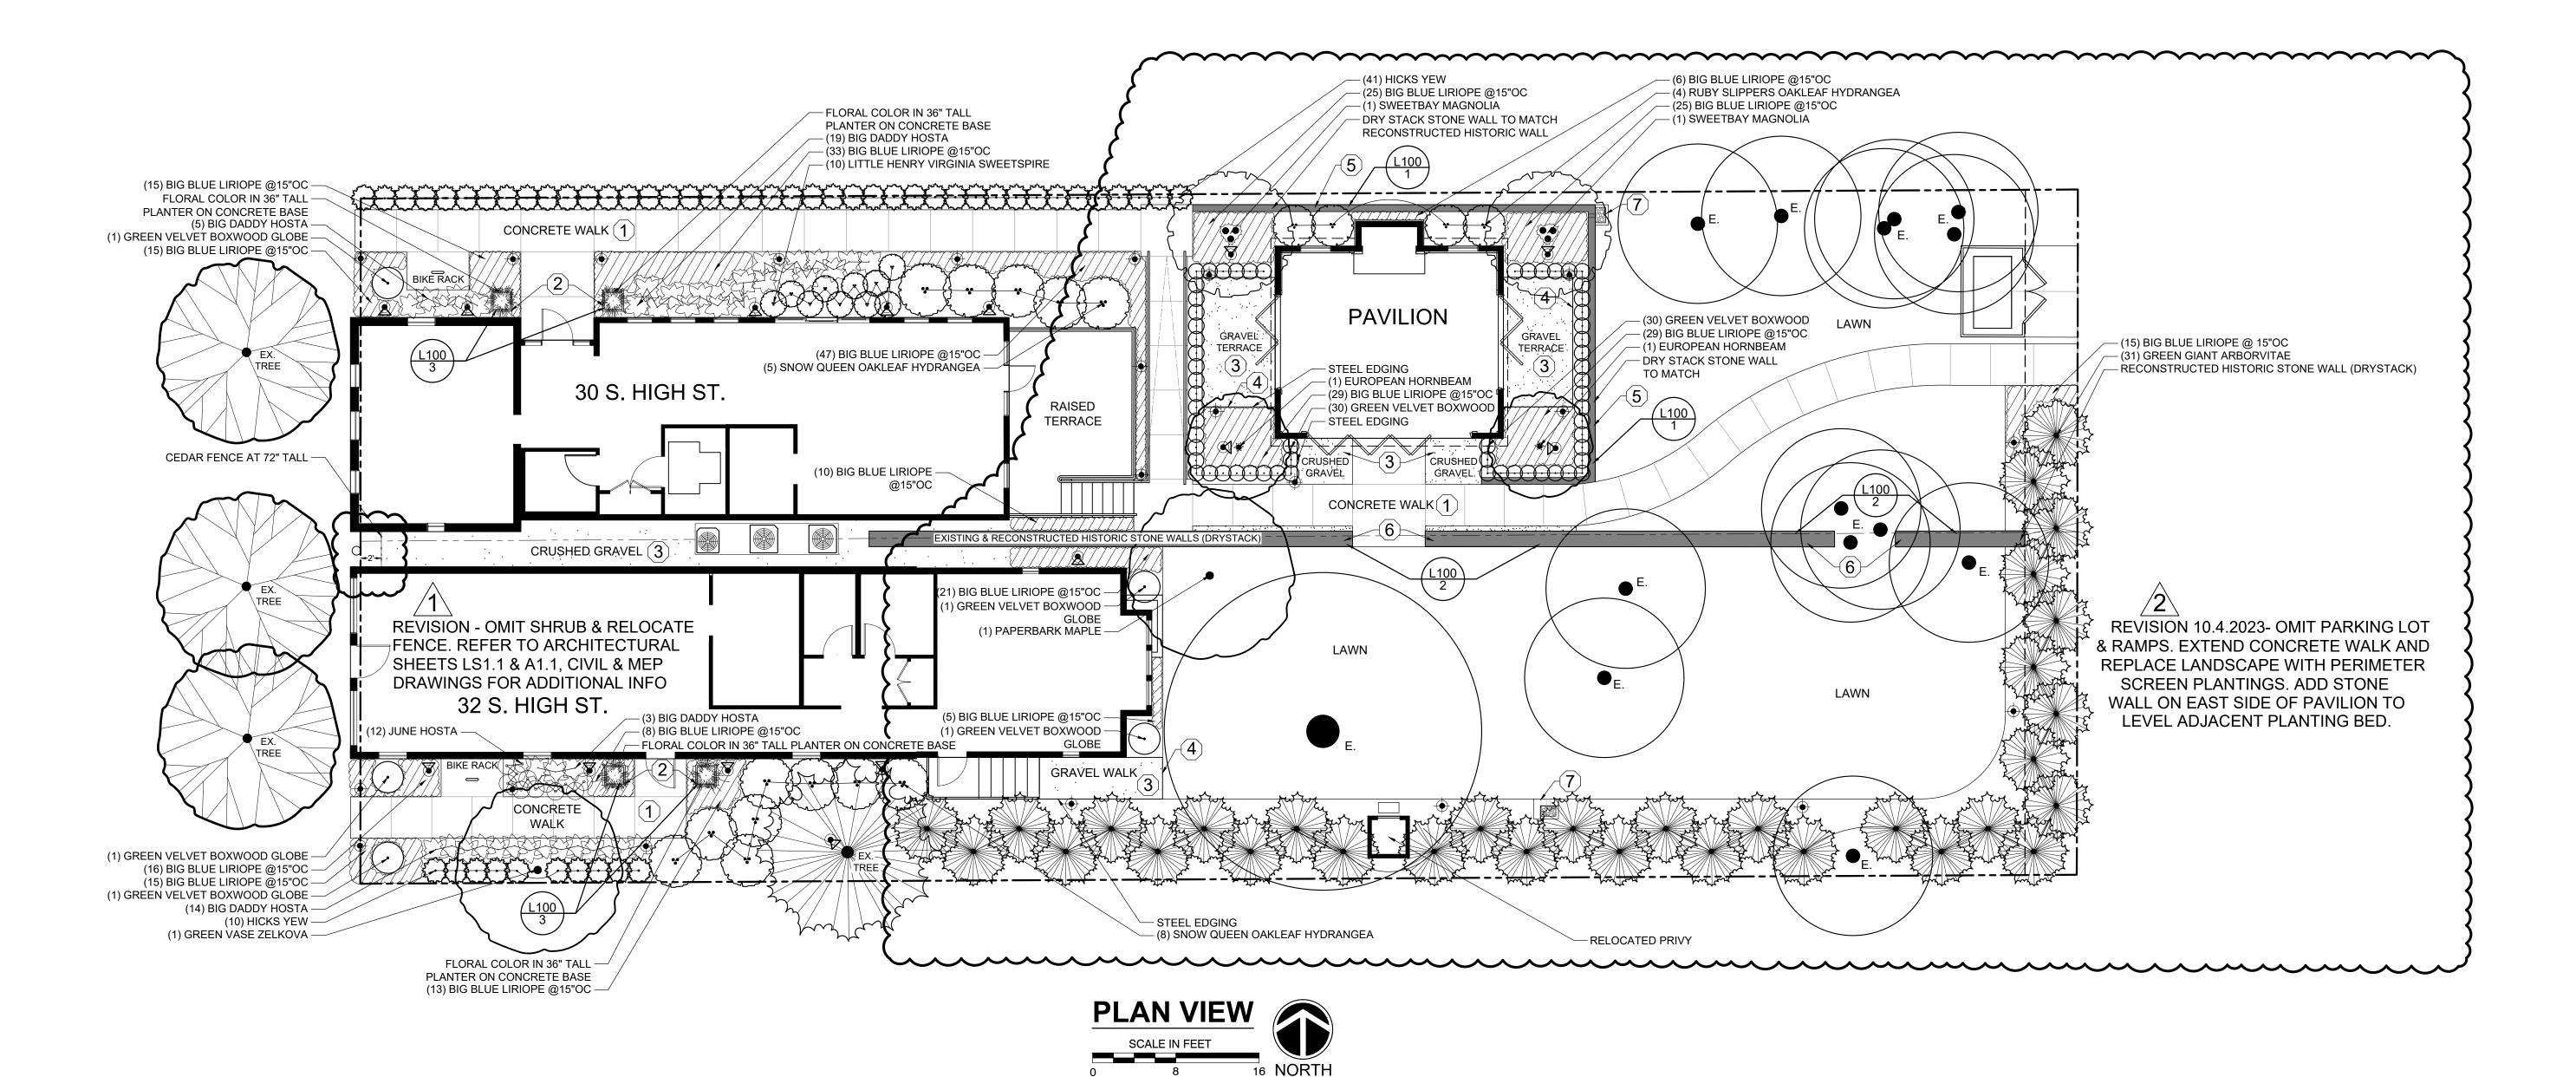
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OSBORN PROJ. NO. J20211064.000

**EROSION** CONTROL DETAILS

DRAWING NO.

C-40<sup>2</sup>



## **CODED NOTES**

- CONCRETE WALKS USE STANDARD CONCRETE WITH LIGHT BROOM FINISH AND NO VISIBLE TOOLING MARKS ALONG EDGES OR AT EXPANSION JOINTS. SAW CUT CONTROL JOINTS.
- (2) PLANTER BASE & PLANTER FORM & POUR IN PLACE 24"X24"X4" CONCRETE PLANTER BASE WITH LIGHT BROOM FINISH OVER 4" MIN. CRUSHED AGGREGATE. SEE SECTION DETAIL 3 THIS SHEET. USE CAMPANIA INTERNATIONAL STEEL TALL CUBE PLANTER. PLANTER CAN BE VIEWED AT CAMPANIAINTERNATIONAL.COM AND SEE ATTACHED CUT SHEET.
- GRAVEL TERRACE/CRUSHED GRAVEL USE GOLD DUST CRUSHED STONE OR EQUIVALENT AT 2"-3" MAX DEPTH ON 6" COMPACTED 411'S CRUSHED LIMESTONE BASE OVER GEOTEXTILE FABRIC. STONE CAN BE VIEWED AT LANGSTONE.COM AND SEE PHOTO THIS SHEET.
- (4) STEEL EDGING USE COL-MET 12 GAUGE STEEL EDGING (BROWN) OR EQUIVALENT INSTALLED PER MANUFACTURERS RECOMMENDATIONS TO FRAME GRAVEL TERRACES & CRUSHED GRAVEL AREAS.
- (5) RETAINING WALL USE NEW WALLSTONE TO MATCH HISTORIC STONE WALLS ON COMPACTED AGGREGATE BASE WITH MINIMUM OF ONE ROW OF STONE INSTALLED BELOW GRADE FOR STABILITY. SET BACK STONE FACE 1 /4" PER ROW AND/OR 1" FOR EVERY VERTICAL FOOT. UTILIZE MORTAR FOR LEVELING & STABILITY. BACKFILL WALL WITH GRAVEL & PERFORATED PIPE TO AID IN DRAINAGE. BUILD WALL TO HEIGHT NEEDED TO CREATE LEVEL PLANTING AREAS ABOVE AND BELOW THE WALL. SEE SECTION DETAIL 1 THIS SHEET.
- (6) HISTORIC WALLS PRESERVE EXISTING WALLS WHERE POSSIBLE. WHEN REBUILD/MODIFICATION OCCURS USE NEW MATCHING STONE TO SUPPLEMENT. FACE/SETBACK OF NEW WALLS TO MATCH EXISTING TO ENSURE SEAMLESS BLEND BETWEEN NEW & OLD. BUILD WALL ON COMPACTED AGGREGATE BASE WITH MINIMUM OF ONE ROW OF STONE INSTALLED BELOW GRADE FOR STABILITY. UTILIZE MORTAR FOR LEVELING & STABILITY AND FILL VOID BETWEEN WALLS WITH GRAVEL & MORTAR AS NEEDED. SECURE CAP ROW OF STONE WITH MORTAR. SEE SECTION DETAIL 2 THIS SHEET.
- 7 FRENCH DRAIN EXCAVATE PIT TO DEPTH OF 12", USE WOVEN FILTER FABRIC TO LINE THE PIT. USE WALLSTONE TO FRAME PIT AND TO COVER DRAIN TILE AT POINT OF DAYLIGHT, USE WASHED COBBLES TO FILL PIT AND CONTAIN

## **GENERAL NOTES**

1. ALL PLANTING BEDS ARE TO BE AMENDED WITH QUALITY PLANTING MEDIUM. TILL IN ENTIRE BED AREA. IF AN IRRIGATION SYSTEM IS REQUESTED, IT IS TO BE INSTALLED TO SERVE ALL PLANTING BEDS, PROPOSED PLANTER POTS AND LAWN AREAS. NO DRIP HOSE IS TO BE USED.

2. ALL PLANTING HOLES ARE TO BE DUG A MINIMUM OF 2 TIMES THE DIAMETER OF THE ROOT BALL OR CONTAINER AND BACK FILLED WITH QUALITY BLENDED SOIL, FERTILIZER AND ROOT STIMULATOR.

3. MULCH ALL BEDS WITH MULCH (CUSTOM HARDWOOD MULCH WITH LEAF COMPOST FROM KURTZ BROTHERS) MINIMUM OF 3" IN NEW BEDS.

4. APPLY PRE-EMERGENT HERBICIDE TO BED BEFORE MULCH APPLICATION IN ALL LANDSCAPE AREAS.

5. ALL LARGE TREES AND SHRUBS ARE TO BE APPROVED BY LANDSCAPE DESIGNER OR OWNER PRIOR TO INSTALLATION. POOR QUALITY PLANT MATERIAL WILL BE REJECTED. TOP QUALITY PLANT MATERIAL IS REQUIRED! SOIL BELOW PROPOSED LAWN IS TO BE AMENDED HEAVILY TO ALLOW DRAINAGE TO PERFORATED DRAINS. SOD IS TO BE TOP QUALITY.

6. SLEEVES ARE TO BE ADDED THROUGHOUT THE PROJECT TO ALLOW FOR IRRIGATION AND LIGHTING INSTALLATION. FLAG ALL SLEEVE ACCESS LOCATIONS.

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10. TAKE GREAT CARE TO NOT DAMAGE EXISTING PLANT MATERIAL TO REMAIN.

11. ALL GROUNDCOVER AND PERENNIAL MASSING TO BE TRIANGULAR SPACING. SEE PLANT LIST FOR SPACING.

12. COORDINATE PLACEMENT OF OUTDOOR SPEAKERS AND CONDUIT WITH AUDIO VISUAL CONTRACTOR TO AVOID CONFLICTS WITH PLANTING.

## **GENERAL CONTRACTOR NOTES**

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4. NO WORK SHALL BEGIN UNTIL THE UTILITY COMPANIES HAVE LOCATED AND MARKED ALL UNDERGROUND UTILITIES AND DISCONNECTED ANY UTILITIES THAT MAY BE POTENTIALLY BE A HAZARD.

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**SECTION: RETAINING WALL** 

SCALE 1/2" = 1'-0"

COARSE AGGREGATE FOR DRAINAGE

6" COMPACTED AGGREGATE W/DUST

UNDISTURBED CLAY & SOIL BACKFILL

- 4" PERFORATED DRAIN TILE

WOVEN FILTER FABRIC

MORTARED CAPSTONE

IRREGULAR WALLSTONE

TO MATCH STONE ON SITE


MORTAR FOR LEVELING ONLY

AND TUCK BACK AS NEEDED


COMMON NAME	BOTANICAL NAME	SIZE	QUANTITY
Pyramidal European Hornbeam	Carpinus betulus 'Fastigiata'	2.5" cal	2
'Green Vase' Zelkova	Zelkova serrata 'Green Vase'	2.5" cal	1
Paperbark Maple	Acer griseum	2.5 cal	1
Sweetbay Magnolia	Magnolia virginiana	8-10'	2
Green Giant Arborvitae	Thuja (standish x plicata)	7-8'	32
Hicks Yew	Taxus x media 'Hicksii'	30"	51
'Green Velvet' Boxwood Globe	Buxus x 'Green Velvet'	30"	5
'Green Velvet' Boxwood	Buxus x 'Green Velvet'	5 gal	60
'Snow Queen' Oakleaf Hydrangea	Hydrangea quercifolia 'Snow Queen'	5 gal	13
'Ruby Slippers' Oakleaf Hydrangea	Hydrangea quercifolia 'Ruby Slippers'	5 gal	4
'Little Henry' Dwarf Virginia Sweetspire	Itea virginica 'Sprich'	5 gal	10
Big Blue Liriope	Liriope muscari 'Big Blue'	1 gal	327
Big Daddy Hosta	Hosta x 'Big Daddy'	1 gal	41
June Hosta	Hosta x 'June'	1 gal	12



**PHOTO: GOLD DUST CRUSHED STONE** 

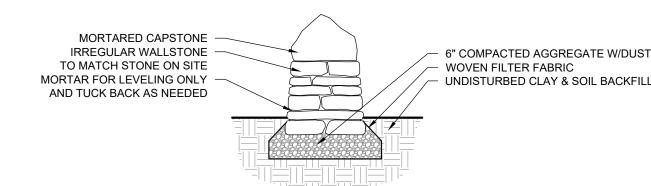



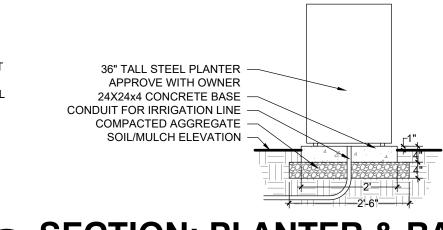



## **LIGHTING KEY**

- **W** UPLIGHT/SPLASH/ACCENT
- PATH LIGHT
- ♦ SCONCE LIGHT
- IN GROUND/WELL LIGHT





# DETAIL: TREE PLANTING & STAKING N.T.S.



— 2" MIN. MULCH LAYER

AS SPECIFIED

FINISH GRADE

\*LIMIT AMOUNT OF PRUNING TO REMOVE

DEAD OR INJURED LIMBS. RETAIN THE

THE MAIN LEADER.

NATURAL SHAPE OF TREE. DO NOT CUT


SET TOP OF ROOT -

MASS 1" ABOVE FINISH


SPADE EDGE —

REMOVE-

TOP 1/3 OF **BURLAP & CUT** 

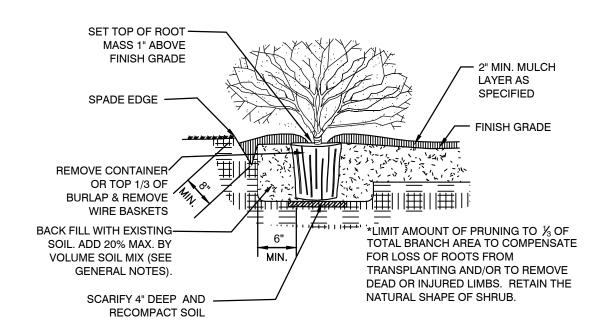



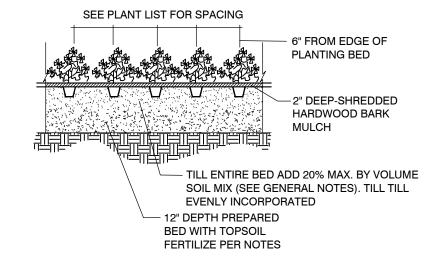

# DETAIL: GROUNDCOVER PLANTING

## **GENERAL NOTES**

1. ALL PLANTING BEDS ARE TO BE AMENDED WITH QUALITY PLANTING MEDIUM. TILL IN ENTIRE BED AREA. IF AN IRRIGATION SYSTEM IS REQUESTED, IT IS TO BE INSTALLED TO SERVE ALL PLANTING BEDS, PROPOSED PLANTER POTS AND LAWN AREAS. NO DRIP HOSE IS TO BE USED.

2. ALL PLANTING HOLES ARE TO BE DUG A MINIMUM OF 2 TIMES THE DIAMETER OF THE ROOT BALL OR CONTAINER AND BACK FILLED WITH QUALITY BLENDED SOIL, FERTILIZER AND ROOT STIMULATOR.

3. MULCH ALL BEDS WITH MULCH (CUSTOM HARDWOOD MULCH WITH LEAF COMPOST FROM KURTZ BROTHERS) MINIMUM OF 3" IN NEW BEDS.

4. APPLY PRE-EMERGENT HERBICIDE TO BED BEFORE MULCH APPLICATION IN ALL LANDSCAPE AREAS.

5. ALL LARGE TREES AND SHRUBS ARE TO BE APPROVED BY LANDSCAPE DESIGNER OR OWNER PRIOR TO INSTALLATION. POOR QUALITY PLANT MATERIAL WILL BE REJECTED. TOP QUALITY PLANT MATERIAL IS REQUIRED! SOIL BELOW PROPOSED LAWN IS TO BE AMENDED HEAVILY TO ALLOW DRAINAGE TO PERFORATED DRAINS. SOD IS TO BE TOP QUALITY.

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