J.Hilburn

DRAWING SHEET INDEX

Sheet name
GENERAL

Current Revision Revision Date

G001 Title SheetG002 General Notes & Code Info.G003 Accessibility Guidelines

ARCHITECTURAL

A100 Plans & ElevationsA201 Storefront CalculationsA300 Building Sections

G004 Accessibility Guidelines

OWNER

Libby Tonucci

6560 Longshore St. Dublin, OH 43017 (614) 783-1595

ARCHITECT

Astra Studios

470 W. Broad St.
Columbus, OH 43215
(614) 461-3126

GENERAL CONTRACTOR

Tenby Construction

Two Miranova Place, Suite 910 Columbus, OH 43215 (614) 800-4622



PROJECT STATUS


MINOR PROJECT REVIEW

CURRENT ISSUE DATE

FEBRUARY 16, 2024

PROJECT NO.

23005

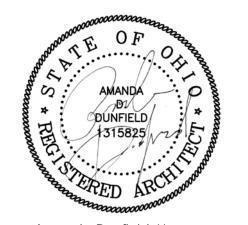

Amanda Dunfield, License # 1315825 Expiration Date: December 31, 2025

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PROJECT INFORMATION

J.Hilburn

6560 Longshore Street Dublin, OH 43017

SHEET NAME

Title Sheet

CHEET NIIIN/IDE

G001

PROJECT LOCATION MAP



PROJECT DESCRIPTION

Replacement of an existing retail storefront.

REFERENCED CODES

2017 Ohio Building Code 2017 Ohio Mechanical Code 2017 Ohio Plumbing Code 2017 National Electric Code 2012 IECC and ASHRAE 90.1 2015 International Fuel Gas Code 2017 Ohio Fire code (NFPA 13) 2009 ICC/ ANSI A117.1/ADAAG

GENERAL INFORMATION

Site Information: City of Dublin Jurisdiction: Parcel ID #: 273-012738-00 **Building Information:** No. Storeys: Use/Occupancy Classifications: Construction Type(s): Fire Suppression: Yes - not impacted by project scope Fire Alarm: Yes - not impacted by project scope Area Impacted by Project Scope:

CHAPTER 3 - USE AND OCCUPANCY CLASSIFICATION

USE GROUP: M - PER 309.1

Mercantile Group M occupancy includes, among others, the use of a building or structure or a portion thereof for the display and sale of merchandise, and involves stocks of goods, wares or merchandise incidental to such purposes and accessible to

CHAPTER 4 - SPECIAL DETAILED REQUIRMENTS

M - MERCANTILE PER 309.1

As applicable

CHAPTER 5 - GENERAL BUILDING HEIGHTS AND AREAS

TABLE 504.3 & 504.4: USE GROUP M (S), CONSTRUCTION TYPE 1B

| MAX. ALLOWABLE | ACTUAL/PROPOSED |
|----------------|-----------------|
| 12 STORIES | 1 |
| 180' | 18' |

TABLE 506.2: USE GROUP M (S), TYPE OF CONSTRUCTION 1B

| | (-7) |
|----------------|-----------------|
| MAX. ALLOWABLE | ACTUAL/PROPOSED |
| LII | 150sf |

CHAPTER 6 - TYPES OF CONSTRUCTION

TABLE 601: CONSTRUCTION TYPE 1B (NONCOMBUSTIBLE, UNPROTECTED)

| BUILDING ELEMENT: | REQUIRED RATIN |
|----------------------------------------------------|----------------|
| Primary structural frame: | 2 |
| Bearing walls | |
| Exterior: | 2 |
| Interior: | 2 |
| Nonbearing walls and partitions | |
| Exterior: | See Table 602 |
| Interior: | 0 |
| Floor construction and associated secondary member | s: 2 |
| Roof construction and associated secondary members | s: 1 |
| | |
| 603: FIRE RETARDANT TREATED WOOD REQUIRED: | YES |

CHAPTER 7 - FIRE AND SMOKE PROTECTION FEATURES

| 706: FIRE WALLS REQUIRED: | NO |
|---------------------------------|----|
| 707: FIRE BARRIERS REQUIRED: | NO |
| 708: FIRE PARTITIONS REQUIRED: | NO |
| 709: SMOKE BARRIERS REQUIRED: | NO |
| 710: SMOKE PARTITIONS REQUIRED: | NO |

CHAPTER 8 - INTERIOR FINISHES

TABLE 803.11: USE GROUP M, UNPROTECTED

| INTERIOR EXIT STAIRWAYS AND RAMPS AND EXIT PASSAGEWAYS | В |
|--------------------------------------------------------|---|
| CORRIDORS | С |
| ROOMS AND ENCLOSED SPACES | С |
| | |

Class A: flame spread index 0-25; smoke-developed index 0-450. Class B: flame spread index 26-75; smoke-developed index 0-450. Class C: flame spread index 76-200; smoke-developed index 0-450.

804.4 INTERIOR FLOOR FINISH REQUIREMENTS:

- Floors shall be class I in groups I-1, I-2 and I-3. They are permited to be reduced to
- class II if building is equiped throughout with an automatic sprinkler system. Floors shall be a minimum of class II in groups A, B, E, H, I-4, M, R-1, R-2 and S.
- All floor covering materials shall comply with the DOCFF-a 'Pill Test'
- Class I: 0.45 watts/cm² or greater. Class II: 0.22 watts/cm² or greater.

CHAPTER 9 - FIRE PROTECTION SYSTEMS

Existing fire protection systems are not impacted by project scope.

CHAPTER 10 - MEANS OF EGRESS

TABLE 1004.1.2: USE GROUP M

FUNCTION (PER 10041.2)

| Assembly (Dining, Tables & Chairs) | 15 | Net |
|----------------------------------------------|-----|-------|
| Assembly (Standing Space) | 5 | Net |
| Business Areas | 100 | Gross |
| Kitchens, Commercial | 200 | Gross |
| Mercantile | 30 | Gross |
| Mercantile (Storage, Stock, Shipping Areas) | 300 | Gross |
| Not Occupied, Circulation | 0 | Gross |
| Per section 1004.2 'Increased Occupant Load' | 9 | Net |
| Stages & Platforms | 15 | Net |
| Storage areas, Equipment Rooms | 300 | Gross |
| | | |
| | | |

FUNCTION (PER 1004.1.2)

SF/PERSON SF TYPE

AREA SF/PERSON OCCUPANTS

1005: MEANS OF EGRESS SIZING:

ROOM # ROOM NAME

RETAIL

| BUILDING ELEMENT | OCCUPANT LOAD | REQUIRED WIDTH | PROPOSED WIDTH |
|--------------------|---------------|----------------|----------------|
| DOORS (.2" x OCC.) | 25 | 5" | 174" |

Mercantile

CHAPTER 11 - ACCESSIBILITY

REFER TO ACCESSIBILITY GUIDELINES

CHAPTER 29 - PLUMBING SYSTEMS

Existing plumbing systems are not impacted by the project scope.

DEFERRED DRAWING SUBMITTALS

Deferred drawing submittals are not required within the scope of the project.

SPECIAL INSPECTIONS AND TESTING

Special inspections are not required within the scope of the project.

ASBESTOS DISCLAIMER

The Architect hereby states, and the Owner acknowledges, that the Architect has no professional liability (errors and omissions) or other insurance, and is unable to reasonably obtain such insurance, for claims arising out of the performance of or failure to perform professional services, including but not limited to the preparation of reports, designs, drawings and specifications, related to the investigation, detection, abatement, replacement or removal of products, materials, or processes containing asbestos.

Accordingly, the Owner hereby agrees to bring no claim for negligence, breach of contract, indemnity or otherwise against the Architect, his principals, employees, agents, and consultants if such claim in any way would involve the Architect's services for the investigation of or remedial work related to asbestos in the project.

The Owner further agrees to defend, indemnify and hold the Architect and his principals, employees, agents, and consultants harmless from any such asbestos related claims that may be brought by third parties as a result of the services provided by the Architect pursuant

COMMON ABBREVIATIONS

| Abv | Above | Jan | Janitor |
|------------|-------------------------------|------------|-----------------------------|
| Acoust | Acoustic(al) | JT | Joint |
| Adj | Adjustable | | |
| AFF | Above finish floor | KO | Knock-out |
| Alum | Aluminum | KP | Kick plate |
| D/C | Dottom of ourb | Lob | Laboratory |
| B/C | Bottom of curb | Lab | Laboratory |
| BD | Board | Lam Lav | Laminate Lavatory |
| Blkg | Blocking | Lav Lkr | Lavatory |
| Cab | Cabinet | | Laminated plastic covered |
| | | Lpc Lat | |
| Cpt Cem | Carpet Cement | Lgt LP | Light Low Point |
| CG | | LF | LOW FOIR |
| Cl | Corner guard Control joint | Max | Maximum |
| CL | Centerline | MDO | Medium density overlay |
| Clg | Ceiling | Mech | Mechanical |
| Cly | Clear | Mfr | Manufacturer |
| Cmu | Concrete masonry unit | Min | Minimum |
| Col | Column | Misc | Miscellaneous |
| Const | Construction | Mldg | Moulding |
| Cont | Continuous | Mrgwb | Moisture resistant GWB |
| Ctr | Center | Migwb | Wostare resistant GWD |
| Cti | Center | N | North |
| Dbl | Double | N/A | Not applicable |
| Demo | Demolish/ Demolition | NIC | Not in contract |
| Dept | Department Department | No | Number |
| Dia | Diameter | Nom | Nominal |
| Diag | Diagonal | NRC | Noise reduction Coefficient |
| Diag | Dimension | | t to Scale |
| Disp | Dispenser | 1110 | 110 00010 |
| DN | Down | O/C | On center |
| Dwg | Drawing | OD | Outside diameter |
| _ | - | | |
| EA | Each | Plwd | Plywood |
| EL | Elevation | _ | |
| Elec | Electric(al) | R | Radius/Riser |
| EQ | Equal | Ref | Refer/ Reference |
| Equip | Equipment | Reinf | Reinforced |
| Exist | Existing | Rm | Room |
| Ext | Exterior | RO | Rough Opening |
| FD | Floor drain | S | South |
| Fin | Finish | Sched | Schedule(d) |
| FL | Floor | Sect | Section |
| Fluor | Fluorescent | Sim | Similar |
| FT | Foot/ Feet | SF | Square Foot/Feet |
| | Fire resistant treated | Spec(s) | Specification(s) |
| | | SS | Stainless steel |
| GA | Gauge | Std | Standard |
| Galv | Galvanized | Sym | Symmetrical |
| GB | Grab Bars | , | 3 |
| GL | Glass, Glazed | T&G | Tongue and groove |
| GR | Grade | Temp | Tempered/ Temporary |
| GWB | Gypsum wall board | Тур | Typical |
| Gyp | Gypsum | UNO | Unless noted otherwise |
| | | | |
| HB | Hose Bibb | VCT | Vinyl composition tile |
| НС | Handicapped/ Hollow core | Vert | Vertical |
| Hdwd | Hardwood | VIF | Verify in field |
| Hdwr | Hardware | VWC | Vinyl wall covering |
| HM | Hollow metal | 147 | Most |
| Horiz | Horizontal | W | West |
| HR | Hour/ Handrail | W/ | Without |
| Hgt HP | Height | W/O | Without |
| ПГ | High point | YD | Yard, Yard drain |
| ID | Inside diameter | 10 | . ara, rara aram |
| Insul | Insulation | & | And |
| Int | Interior | @ | At |
| | | -11 | Dound(a) or Noval |

SUPPLY/INSTALLATION

All items contained within these drawings are assumed to be supplied and installed by the General Contractor unless noted otherwise. It is the responsibility of the GC to coordinate delivery and install as applicable within the scope of work.

Pound(s) or Number

GENERAL CONSTRUCTION NOTES

- 1. All work will comply with any and all fire and safety codes, or with any federal, state, county or municipal codes having jurisdiction. All applicable requirements in these regulations will apply to the work shown herein, whether specifically indicated as such or not. Conflicts between work set forth herein and any codes, laws or regulations shall be brought to the attention of the Architect prior to proceeding with any work.
- 2. Any reference made in these documents to the "Contractor" shall apply equally to the general Contractor or construction manager, and any Subcontractors or vendors to the Contractor. Similarly, any reference made to a "Subcontractor" or "Vendor" shall be interpreted as meaning the General Contractor or Construction Manager, and does not imply the Architect's involvement in the Contractor's means or methods of executing the work.
- 3. The organization or arrangement of these drawings and/or accompanying specifications is for convenience only, and shall not relieve the Contractor for responsibility of delivering a complete functioning project, of supervising and coordinating the work of all trades, or of dividing the work among his Subcontractors or in establishing the extent of work to be performed by any trade.
- 4. All work shall be in strict conformance with the requirements of these documents and the requirements of the Owner (especially regarding scheduling, areas of work and temporary controls). It is the Contractor's responsibility to acquaint himself with these requirements. Contractor is to investigate any special requirements and conditions of the site. Contractor's bid will be assumed to include the cost of fulfilling these requirements.
- 5. Design and selection of supports, braces, anchors, attachments and related fasteners, unless shown on the drawings or in the specifications, are the responsibility of the installing contractor utilizing industry standard materials and methods suitable to the condition.
- 6. The Owner is responsible to pay for, and the Contractor is responsible to obtain, all permits required by federal, state, county or municipal authorities; the Contractor shall include in the contract the cost of such permits.
- 7. The Contractor is to arrange for elevator or other hoisting facilities for materials and equipment. Arrangements shall be made through the building management. Costs for delivery, storage, and/or handling of materials shall be included in the bid. The Contractor shall become familiar with and work within the Owners or building management's guidelines and procedures for security, registration, delivery, allowable working times, access to adjoining Tenants, noise, etc.; costs of complying with these requirements will not be justification for additional charges.
- 8. The Contractor shall verify building opening sizes and clearances (doors, elevators, docks, corridors, etc.) To allow for the delivery of all required materials and project components.
- 9. The Contractor will post material safety data (MSD) sheets on the jobsite for any hazardous materials in compliance with federal, state and local authorities.
- 10. Install manufactured materials and equipment in strict accordance with the manufacturer's written instructions and guidelines. The Contractor is to inform the Architect of items specified which may not be readily available or which have long lead times.
- 11. The Contractor shall provide barriers, temporary partitions or other measures for the protection of occupants, workers or occupied or finished areas and surfaces. This is to include noise barriers, vapor barriers, dust barriers or other protection as requested by the Owner. An allowance for these materials shall be included in the contract and costs for the materials above the allowance shall be approved by the Owner.
- 12. The Contractor is to remove all debris and leave all areas broom clean at the end of each work day, and protect any portion of existing work to remain or work previously installed.
- 13. The Contractor shall investigate ceiling plenums and report extent of interference of overhead construction (ie duct work, pipes, plumbing, etc.), to Architect prior to start of work so as to accommodate the specified ceiling, lighting and mechanical systems. If requested by the Architect, the Contractor shall prepare a coordination drawing indicating the interface of all trades.
- 14. The Contractor will perform all work for the contract sum without adjustment in the event of labor disputes and/or work stoppages.
- 15. Items specified in these drawings are for reference, and are not intended to be proprietary. The Contractor may submit a written request along with his bid for Architect's approval of equal
- 16. There will be no substitutions for specified products, equipment or systems other than those approved prior to signing the contract, unless the substitution can be shown to be of significant benefit to the Owner and place no additional expense on the Architect to process. The Owner and Architect mus approve all substitutions.
- 17. Level of drywall finishes (as specified in ASTM C840):
- A. Level 1 areas above opaque ceiling
- B. Level 2 as substrate for ceramic tile
- C. Level 4 all areas not indicated to receive levels 1,2 or 5. All wall areas above open cell ceilings. D. Level 5 - only where specifically indicated on plans.

NOTICE TO BIDDERS

Drawings contained within are a visual representation of the Scope of Work. It is the responsibility of the Bidding Contractors to perform a site visit to familiarize themselves with the unique characteristics of the project. Contact the Construction Manager or Owner to arrange a site visit.

The Contractor is to provide written notification to the Construction Manager or Owner of any discrepancies discovered between site conditions and these Documents. Submission of a bid is confirmation that the existing conditions have been accepted and fully accounted for in the costs

Ad Astra Design, LLC (Architect) does not handle the bidding process. Direct all bidding related questions to the Construction Manager or Owner.

CONSTRUCTION SUBMITTALS

- 1. Provide all submittals in advance of installation for proper review by Architect & Owner
- 2. Allow at least 10 working days for Architect review time.
- 3. The Contractor shall review and approve all submittals prior to their submission to the Architect. Any submittal not signed, dated and stamped approved by the Contractor will be rejected.
- 4. The Contractor shall submit three samples of all finish materials, of a size appropriate to view the material being submitted, to the Architect for review prior to initiating installation of the material. Email submissions are acceptable & preferred.
- 5. The Contractor is to submit product data sheets for any catalog items including any and all building standard items called for on the drawings.
- 6. <u>Prior to fabrication</u> The Contractor shall submit shop drawings for all off-site fabricated items to the Architect for reveiw. Any work fabricated prior to review not complying with the Contract Documents will be rejected.
- 7. Substitutions to items specified in these Contract Documents should be made only prior to bidding. If the Owner authorizes the Architect to review a substitution after bidding, the item must be submitted spearately and clearly indentified as a substitution and <u>not</u> included within another submission or it will be rejected.



PROJECT STATUS


MINOR PROJECT REVIEW

CURRENT ISSUE DATE

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23005

PROJECT NO.

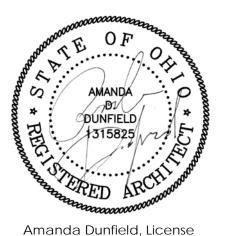

1315825 Expiration Date: December 31, 2025

REVISIONS


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PROJECT INFORMATION

J.Hilburn

6560 Longshore Street **Dublin**, OH 43017

General Notes & Code Info

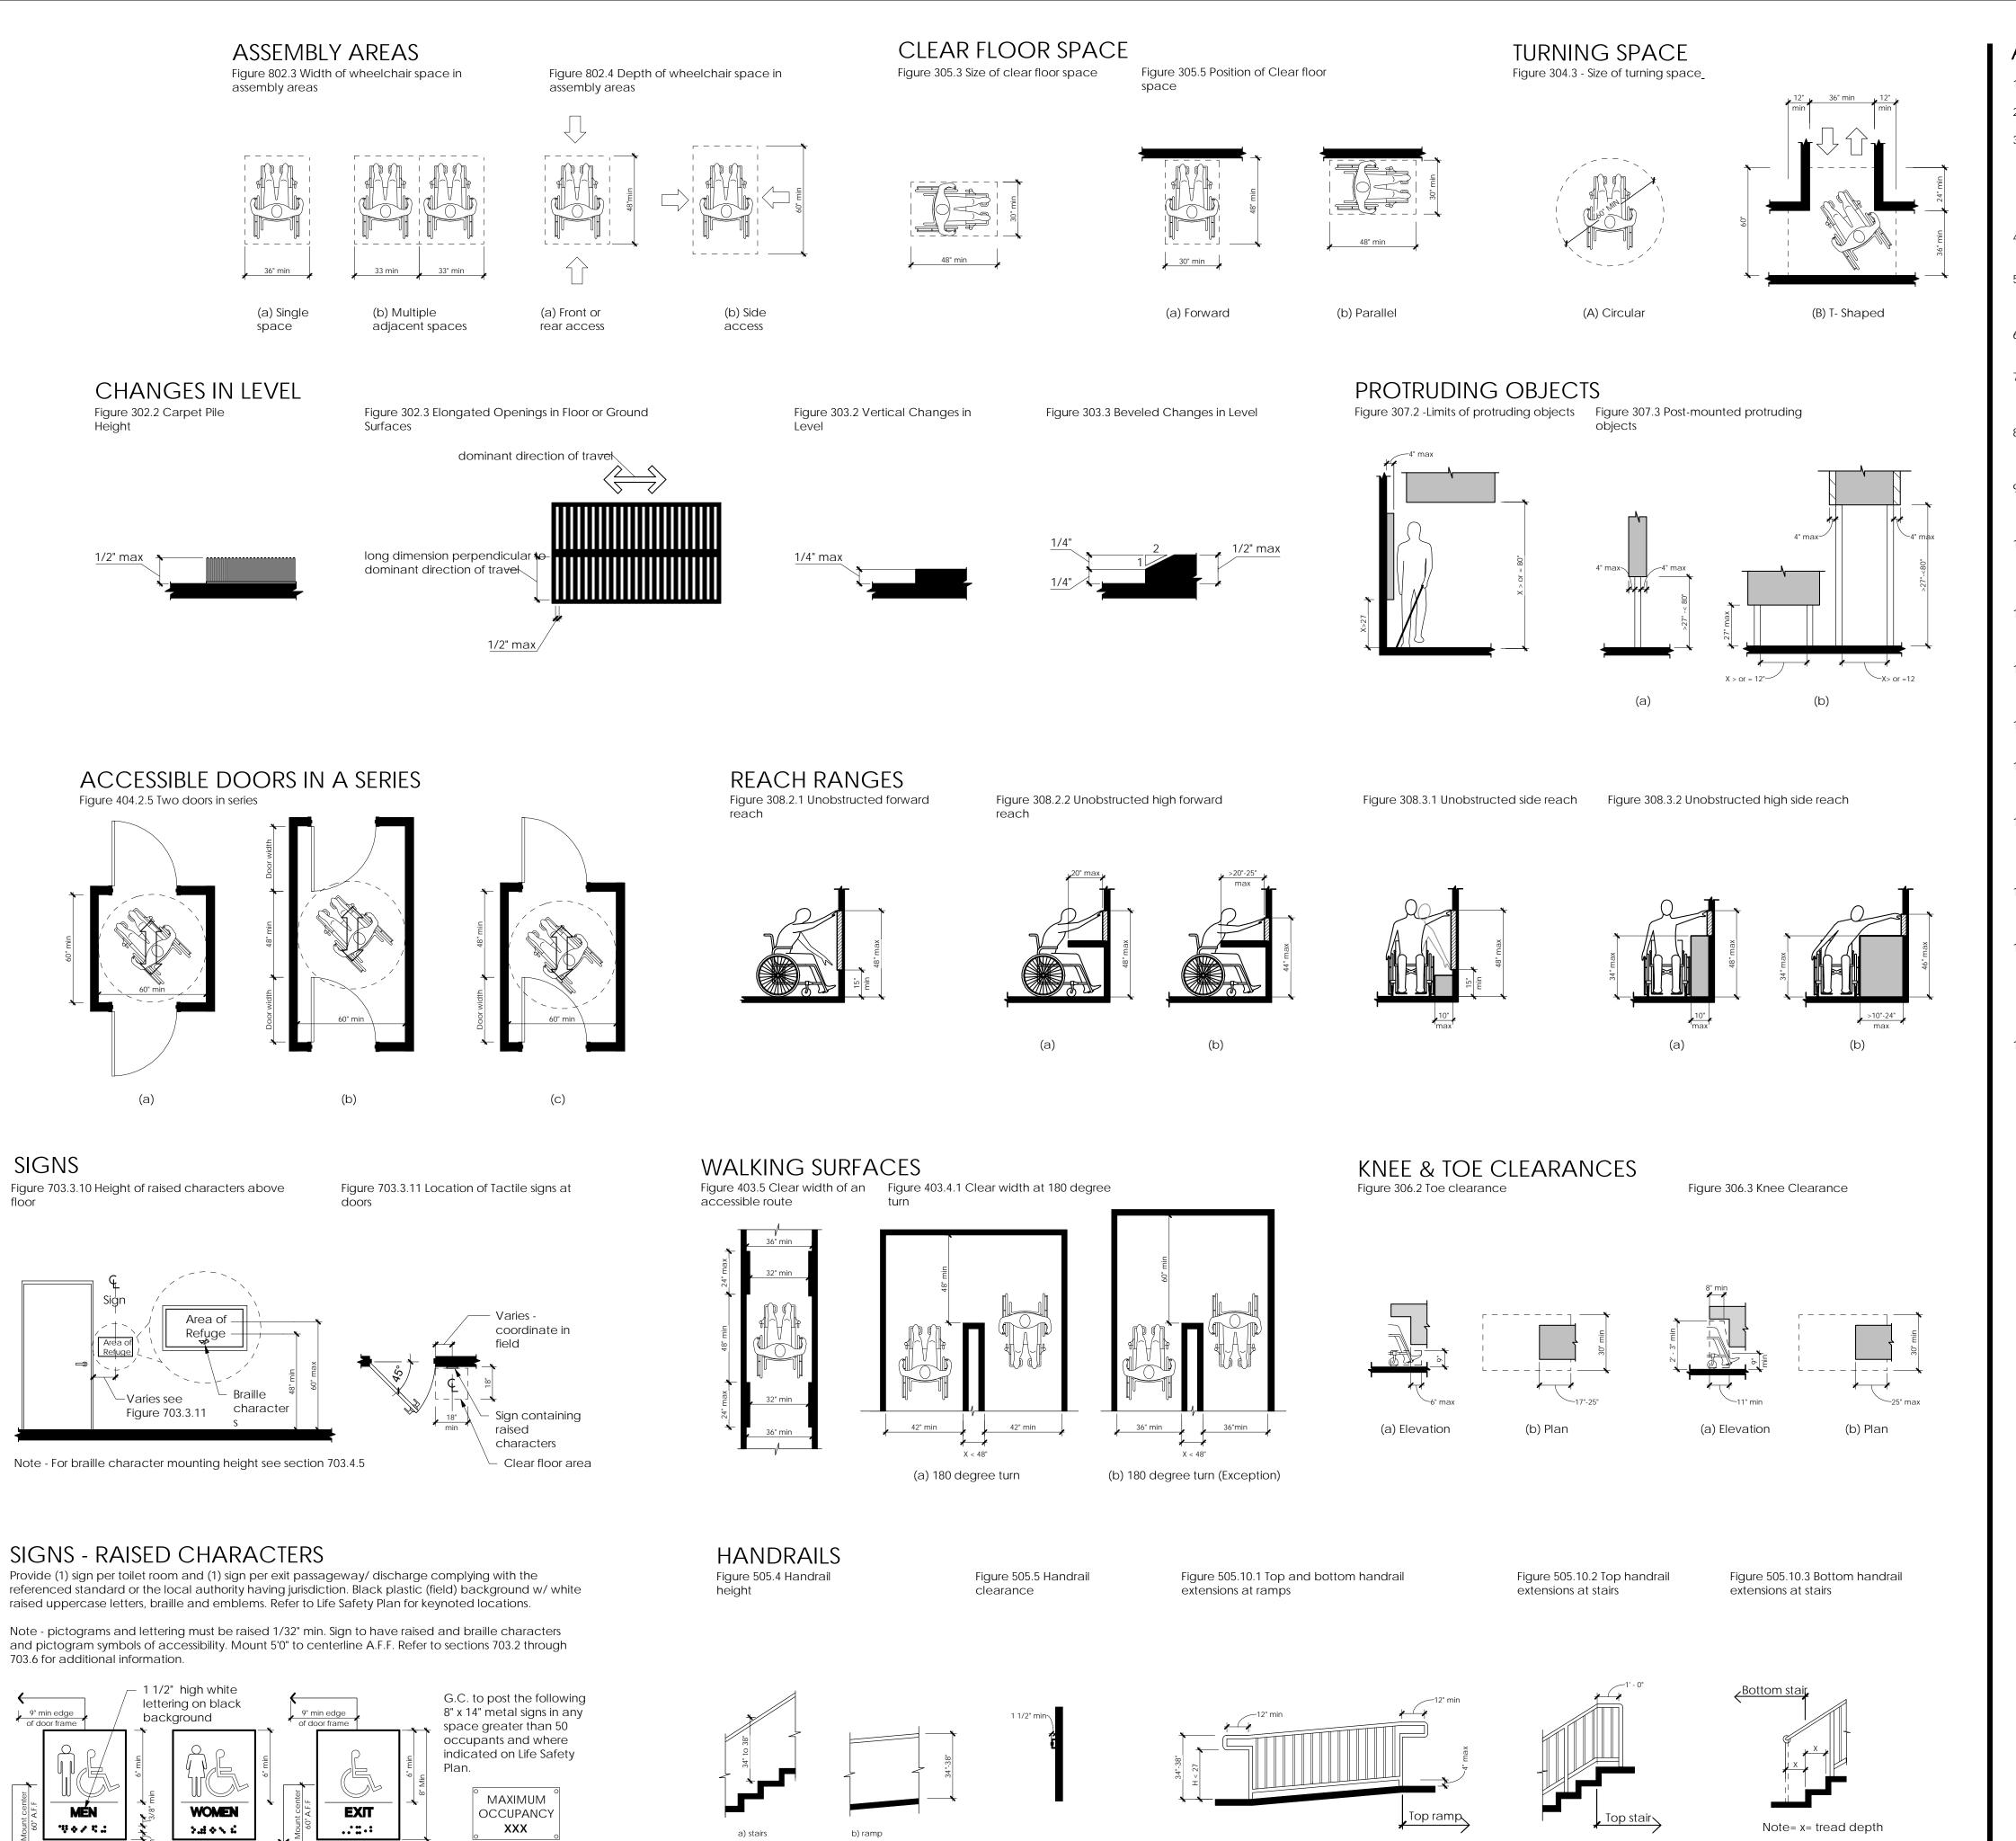

ACCESSIBILITY GENERAL NOTES

- 1. All indicated dimensions are <u>clear/finish</u> values.
- 2. Referenced standard as indicated on title sheet.
- The "General Accessibility Notes" and "Figures" on this sheet are provided as a general reference to illustrate common conditions addressed within the referenced standard. Some figures have been modified from those published in the standard to provide greater clarity. General contractor should reference the complete publication for any clarifications or questions.
- <u>Protruding objects</u>
 Protruding objects on circulation paths shall comply with section 307.
- Operable parts on accessible elements, accessible routes, and in
- accessible rooms and spaces shall comply sections 309 and 404.2.6.
- Accessible routes Accessible routes shall comply with section 304 and chapter 4.
- Parking spaces Where parking spaces are provided, parking spaces shall be provided in accordance with sections 406 and 502.
- 8. <u>Passenger loading zones and bus stops</u> Where provided, passenger loading zones shall comply with sections
- Where provided, interior and exterior stairs that are part of a means of egress shall comply with sections 504 and 505.
- 0. <u>Drinking fountains</u> Where drinking fountains are provided at an exterior site, on a floor, or
- within a secure area, they shall be provided in accordance with sections 305, 306, and 602. 1. <u>Kitchens, kitchenettes, and sinks</u>
- Where provided, kitchens, kitchenettes, and sinks shall comply with sections 308, 606, and 804.
- 12. Toilet facilities and plumbing elements Where toilet facilities are provided, they shall comply with section 305 and chapter 6.
- Signs shall be provided in accordance with section 703
- Assembly areas shall provide wheelchair spaces, companion seats, and designated aisle seats complying with sections 802 and 902.
- 15. <u>Dressing, fitting, and locker rooms</u> Where dressing, fitting, and locker rooms are provided, at least 5 %, but no fewer than one of each type of use is each cluster provided
- shall comply with sections 803 and 903.
- Where storage is provided in accessible spaces, at least one of each type shall comply with sections 305 and 905
- 17. <u>Dining surfaces and work surfaces</u>
 Where dining surfaces are provided for the consumption of food or drink, at least 5 percent of the seating spaces and standing spaces at the dining surfaces shall comply with sections 305 and 902. In addition, where work surfaces are provided for use by other than employees, at least 5 % shall comply with sections 305 and 902.
- Where provided, check-out aisles, sales counters, service counters, food service lines, queues, and waiting lines shall comply with sections 305, 403, and 904.



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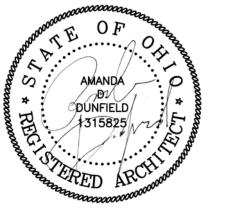
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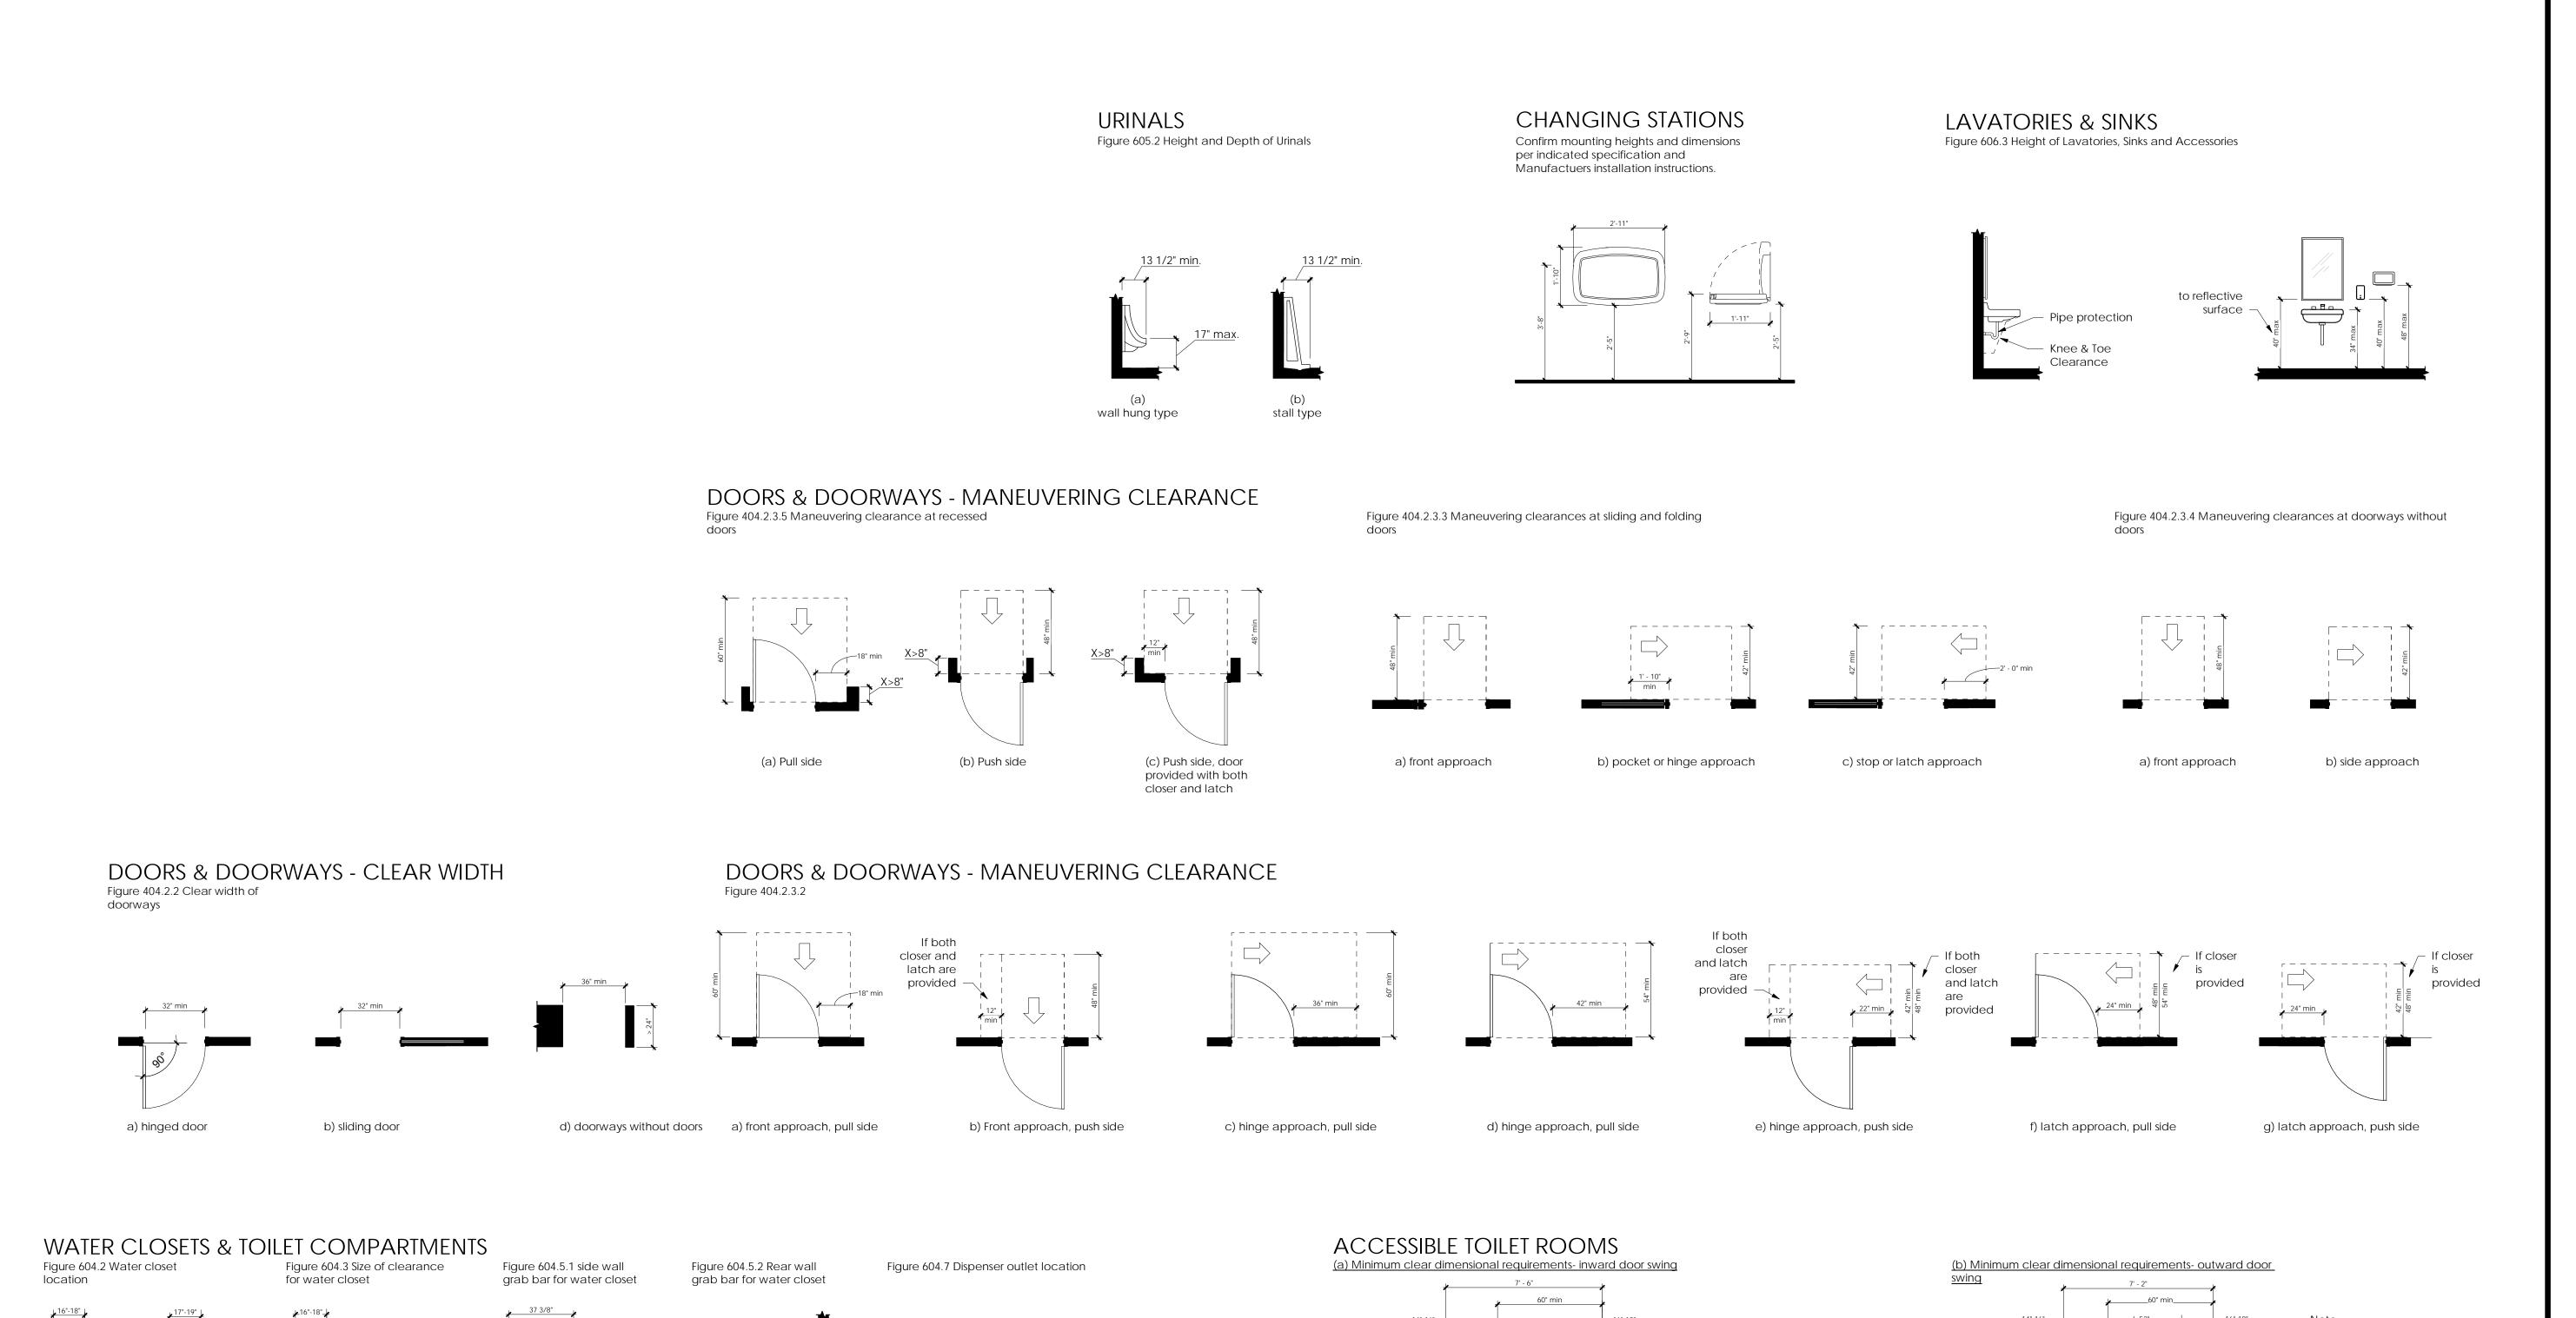
J.Hilburn

6560 Longshore Street Dublin, OH 43017

SHEET NAME

SHEET NUMBER

Accessibility Guidelines



Wall hung

Floor mounted

lavatory -

tank-type

water closet

30" x 48" min

clear space -

Note:

for any

wheelchair

fixture.

30"x 48" of clear floor space is required

in every restroom. When 30" x 48" clear

space is provided beyond the arc of the

swing, the door is permitted to swing into

clear floor space or clearance required

Door may swing into a required

turning space. Per section 603.2.2,

toilet room door to swing into the

required clear fixture floor or ground

space when another clear floor or ground space is provided outside the

radius of the door swing.

exception #2 allows a single occupancy

Wall hung

lavatory

mounted

water closet

30" min x 48"

min clear

space

Floor



PROJECT STATUS


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PROJECT INFORMATION

J.Hilburn

6560 Longshore Street Dublin, OH 43017

for accessible plumbing fixtures must be operable with one hand and must not require tight grasping, pinching, or twisting of the wrists.

Door hardware and controls

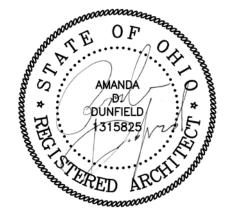Hot water and drainpipes under accessible lavatories must be insulated or otherwise configured to protect against contact. There must be no sharp or abrasive surfaces beneath them.

Accessibility
Guidelines

SHEET NUMBER

G004

b) ambulatory

closets

accessible water

a) accessible

water closets

60" min

other fixtures

not allowed

within this

area

54" min


42" max

(a,b) Protruding dispenser


below and above grab bar

42" max

c) Recessed dispenser

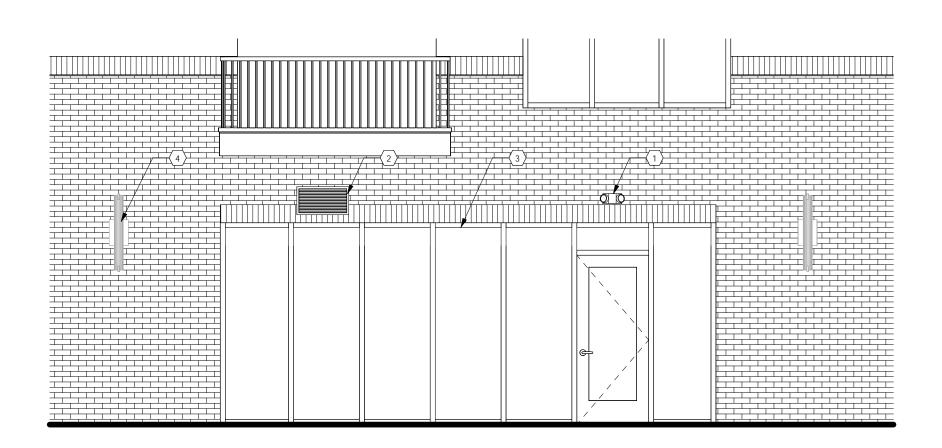


1 Demolition Elevation Scale: 1/4" = 1'-0"

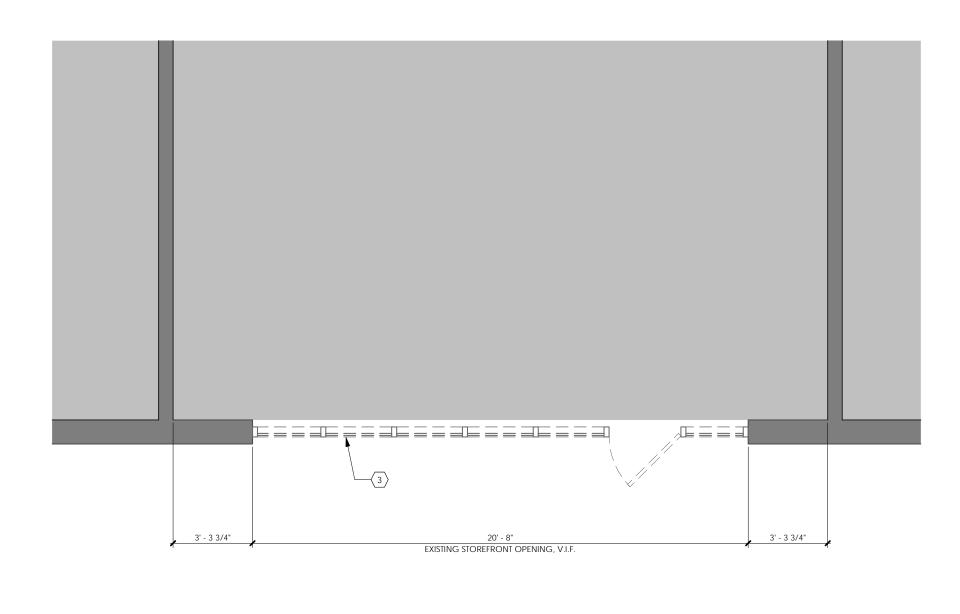







J.HILBURN STYLIST STUDIO - 60% Transparent Req'd Zone: 124.3 SF Total Actual Transparent Area: 81.1 SF 2 New Work Elevation Scale: 1/4" = 1'-0" New Storefront Transparent Area: 65.2%

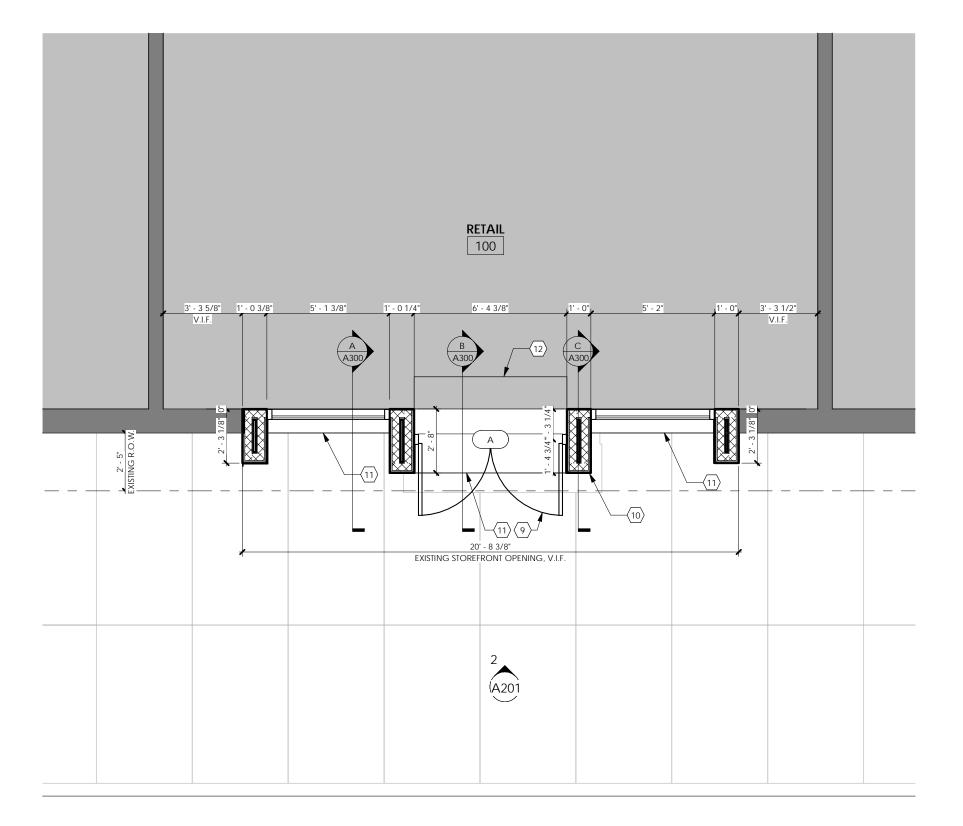




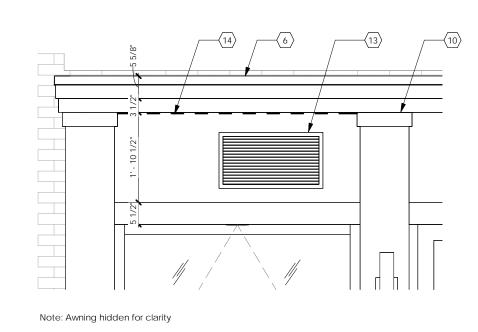

3 Louver Detail
Scale: 1/2" = 1'-0"

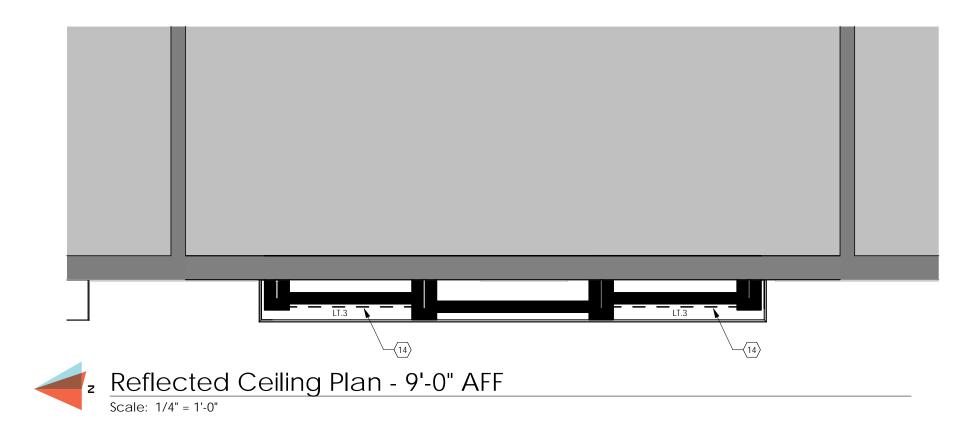

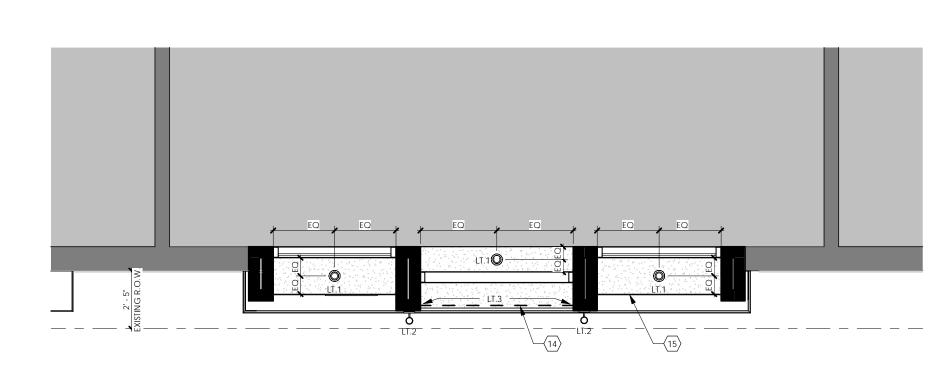

z Reflected Ceiling Plan 7'-0" AFF
Scale: 1/4" = 1'-0"

GENERAL NOTES


- A. Do not scale drawings. If dimensions are in question, the contractor shall be responsible for seeking clarification from Architect prior to construction.
- B. All dimensions are from finished surface to finished surface, unless noted

KEYNOTES

- 1 Existing EM lighting to be removed. Relocate circuit for new EM lighting as
- 2 Existing louver to remain. Extend to new location as indicated. 3 Existing storefront to be removed. Verify extents in field.
- 4 Existing sconce fixture to remain, typ.
- 5 NOT USED 6 Preformed metal coping to match paint finish.
- 7 Awning by others. 8 Signage by others.
- 9 New doors as indicated. Refer to door schedule.
- 10 New framing as indicated. Provide painted cement fiber board finish. Refer
- 11 Replace sidewalk and substrate as required this area. Provide epoxy dowel connection to existing slab.
- 12 Patch/repair interior concrete slab and LVT flooring as required.
- 13 Extend existing louver to new location as indicated.
- 14 Recessed LED tape light fixture at overhang. Refer to details.
- 15 Painted, exterior rated gypsum ceiling, typ.

LEGEND

Indicates existing to remain.

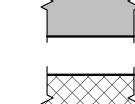

Indicates new construction



Indicates batt insulation within wall. Batt thickness based on stud size. Provide sound selant continuous at all joints at interior locations. Refer to specifications sheet for additional information.

LIGHT FIXTURE SCHEDULE

| Type | Description | Manufacturer | Model | Comments |
|------|--------------------------------|----------------|-----------------------|---------------------------------------------------|
| LT.1 | Recessed Can | Sistemalux | Nannoled S3321W-19 | 3000K; Stainless steel finish |
| LT.2 | Up/Down Sconce (Exterior 2) | Alcon Lighting | Alcon 11240-2-BK | 3000K; 4" Cylinder LED uplight & downlight |
| LT.3 | LED Tape (Black) | Kelvix | Orex RX Series RX-24K | 2400K; Flat aluminum channel mount #RX-CH-TL-2-FL |

DOOR SCHEDULE

| | | Slab | | | |
|-------|------------------------------------|---------|---------|-----------------------------------------------|---------------------------------------|
| Door# | Description | Height | Width | Hardware | Comments |
| | Jeld-Wen Epic-Custom Collection | 8' - 0" | 6' - 0" | Omnia OMN-BTB-9031P Pulls; ORB finish typ. | Brickmould Trim; Tricorn Black finish |



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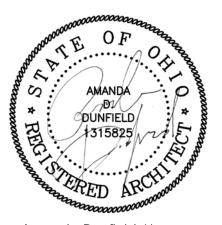
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PROJECT INFORMATION


J.Hilburn


6560 Longshore Street Dublin, OH 43017

SHEET NAME

Plans & Elevations

SHEET NUMBER

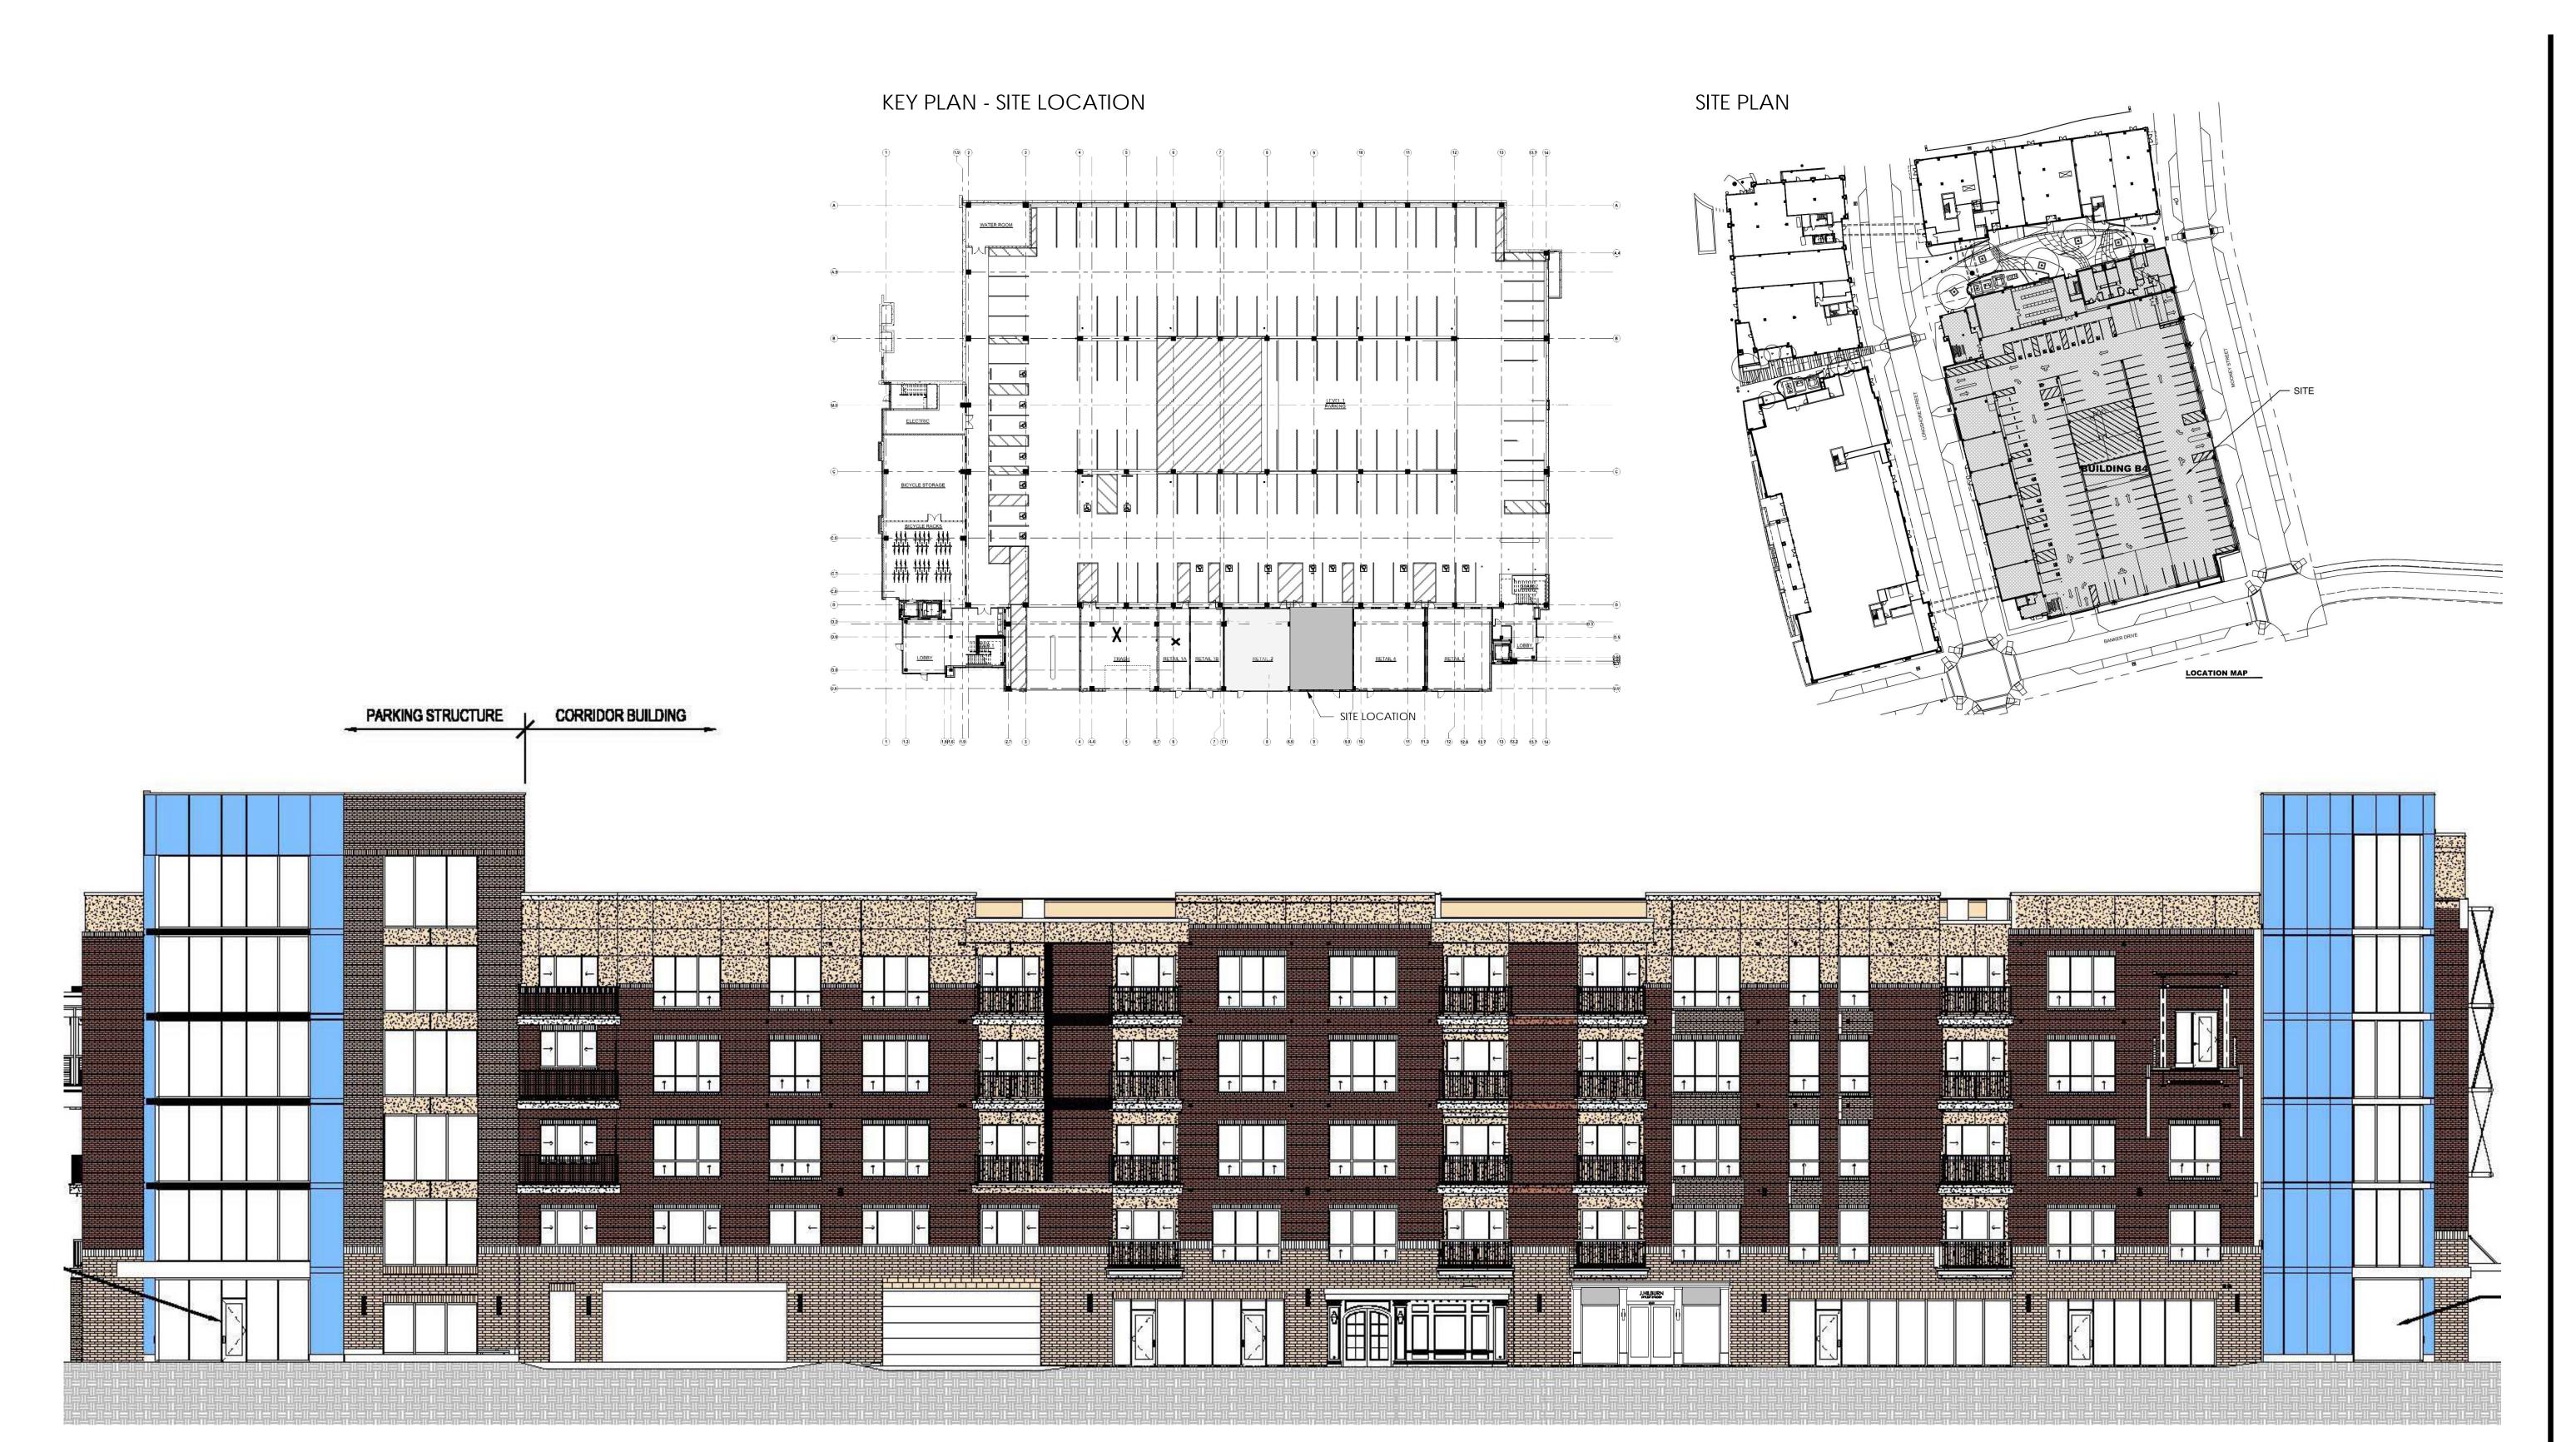

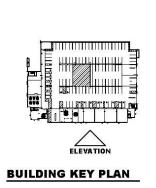

FAÇADE MATERIALS - CORRIDOR BUILDING

OVERALL AREA OF ELEVATION: 17,249 S.F.

AREA OF WINDOWS/DOORS: 3,080 S.F. - a decrease of 26 S.F.

NET AREA OF ELEVATION: 14,169 S.F.

| | Ĭ | Í | | Î |
|-------------------|----------------------------------|--------------------------------------------------------------------------------------------------------------------|------------------------------------------------------------------------------------------------------------------------------------------|------------------------------------------------------------------------------------------------------------------------------------------|
| PRIMARY/SECONDARY | AREA (S.F.) | PERCENTAGE | REQUIRED | ME |
| PRIMARY | 7,673 S.F. | 54% | | |
| PRIMARY | 1,986 S.F. | 14% | | |
| PRIMARY | 809 S.F. | 6% | | |
| | 10,468 S.F. | 74% | 80% | |
| SECONDAY | 3,539 S.F. | 25% | | |
| PERMITTED AS TRIM | 162 S.F. | 1% | | |
| | 3,701 S.F. | 26% | <20% | |
| | PRIMARY PRIMARY PRIMARY SECONDAY | PRIMARY 7,673 S.F. PRIMARY 1,986 S.F. PRIMARY 809 S.F. 10,468 S.F. SECONDAY 3,539 S.F. PERMITTED AS TRIM 162 S.F. | PRIMARY 7,673 S.F. 54% PRIMARY 1,986 S.F. 14% PRIMARY 809 S.F. 6% 10,468 S.F. 74% SECONDAY 3,539 S.F. 25% PERMITTED AS TRIM 162 S.F. 1% | PRIMARY 7,673 S.F. 54% PRIMARY 1,986 S.F. 14% PRIMARY 809 S.F. 6% 10,468 S.F. 74% SECONDAY 3,539 S.F. 25% PERMITTED AS TRIM 162 S.F. 1% |

FAÇADE MATERIALS - PARKING STRUCTURE

OVERALL AREA OF ELEVATION: 2,997 S.F.

| PRIMARY/SECONDARY | AREA (S.F.) | PERCENTAGE | REQUIRE |
|-------------------|-------------------------------|--------------------------------------------------------------------------------------------|--------------------------------------------------------------------------------------------------------------|
| PRIMARY | 747 S.F. | 25% | |
| PRIMARY | 1,746 S.F | 58% | |
| PRIMARY | 378 S.F | 13% | |
| | 2,493 S.F. | 96% | 80% |
| PERMITTED AS TRIM | 126 S.F. | 4% | |
| | 126 S.F. | 4% | <20% |
| | PRIMARY PRIMARY PRIMARY | PRIMARY 747 S.F. PRIMARY 1,746 S.F. PRIMARY 378 S.F. 2,493 S.F. PERMITTED AS TRIM 126 S.F. | PRIMARY 747 S.F. 25% PRIMARY 1,746 S.F 58% PRIMARY 378 S.F 13% 2,493 S.F. 96% PERMITTED AS TRIM 126 S.F. 4% |

| | | | | | | STREET FAÇADE TRANSPARENCY - PARKING STRUCTURE | | | | | |
|---------------|-------------|---------------|------------|---------------|------------------|------------------------------------------------|-----------|---------------|-----------|---------------|-----------|
| | 1ST STORY | | 2ND STORY | | 3RD STORY | | 1ST STORY | | 2ND STORY | | 3RD STORY |
| STORY AREA: | 1799 S.F. | STORY AREA: | 3,229 S.F. | STORY AREA: | 3,352 S.F. | STORY AREA: | 504 S.F. | STORY AREA: | 506 S.F. | STORY AREA: | 506 S.F. |
| TRANSPARENCY: | 1 ,051 S.F. | TRANSPARENCY: | 1,017 S.F. | TRANSPARENCY: | 1,110 S.F. | TRANSPARENCY: | 196 S.F. | TRANSPARENCY: | 333 S.F. | TRANSPARENCY: | 333 S.F. |
| REQUIRED: | 60% | REQUIRED: | 30% | REQUIRED: | 30% | REQUIRED: | 65% | REQUIRED: | N/A% | REQUIRED: | N/A% |
| PROVIDED: | 58 % | PROVIDED: | 31% | PROVIDED: | 33% | PROVIDED: | 39% | PROVIDED: | 66% | PROVIDED: | 66% |
| | | | | | | | | | | | |
| | 4TH STORY | | 5TH STORY | | 6TH STORY | | 4TH STORY | | 5TH STORY | | 6TH STORY |
| STORY AREA: | 3,352 S.F. | STORY AREA: | 3,352 S.F. | STORY AREA: | 327 S.F. | STORY AREA: | 506 S.F. | STORY AREA: | 506 S.F. | STORY AREA: | 570 S.F. |
| TRANSPARENCY: | 1,110 S.F. | TRANSPARENCY: | 1,110 S.F. | TRANSPARENCY: | 170 S.F. | TRANSPARENCY: | 333 S.F. | TRANSPARENCY: | 333 S.F. | TRANSPARENCY: | 316 S.F. |
| REQUIRED: | 30% | REQUIRED: | 30% | REQUIRED: | 30% | REQUIRED: | N/A% | REQUIRED: | N/A% | REQUIRED: | N/A% |
| PROVIDED: | 33% | PROVIDED: | 33% | PROVIDED: | 52% | PROVIDED: | 66% | PROVIDED: | 66% | PROVIDED: | 55% |
| | | | | | | | | | | | |



PROJECT STATUS


MINOR PROJECT REVIEW

CURRENT ISSUE DATE

FEBRUARY 16, 2024

PROJECT NO.

23005

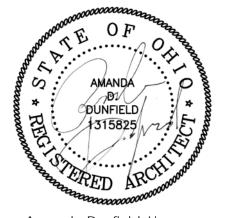

Amanda Dunfield, License # 1315825 Expiration Date: December 31, 2025

REVISIONS

| # | Description | Date |
|---|-------------|------|
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PROJECT INFORMATION

J.Hilburn


6560 Longshore Street Dublin, OH 43017

SHEET NAME

Storefront Calculations

SHEET NUMBER

A201

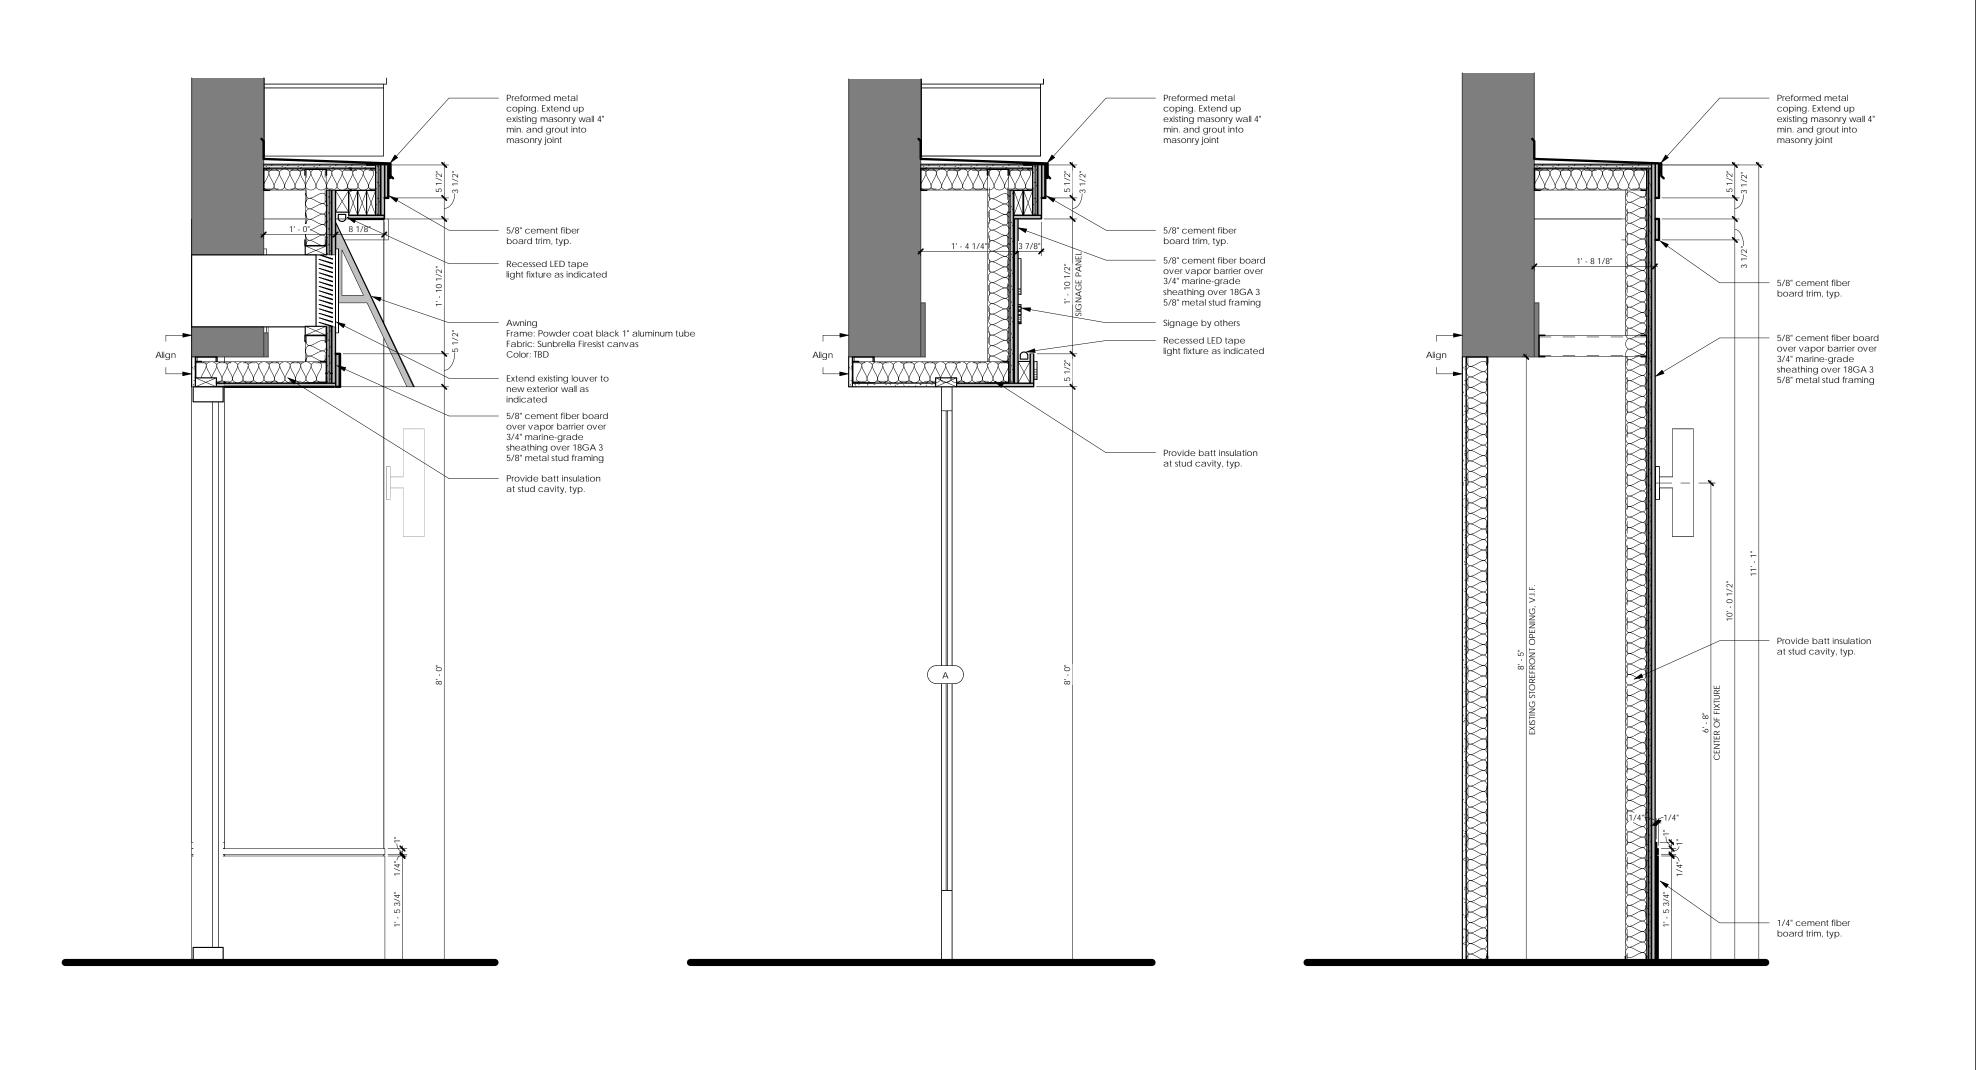

Section

Scale: 3/4" = 1'-0"

B Section
Scale: 3/4" = 1'-0"

ASTRA STUDIOS

PROJECT STATUS


MINOR PROJECT REVIEW

CURRENT ISSUE DATE

FEBRUARY 16, 2024

PROJECT NO.

23005

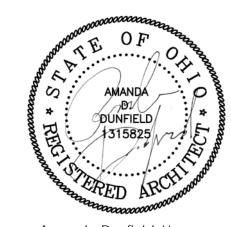

Amanda Dunfield, License # 1315825 Expiration Date: December 31, 2025

EVISIONS

| 2110.0110 | | | | | | |
|-----------|-------------|------|--|--|--|--|
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| | Description | Date | | | | |
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PROJECT INFORMATION

J.Hilburn

6560 Longshore Street Dublin, OH 43017

Building Sections

SHEET NUMBER

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A Section
Scale: 3/4" = 1'-0"