

Franklin County Auditor's Office Auditor Michael Stinziano

Map Produced April 25, 2024

Planimetric Legend
Source: 2021 Aerial Photography
Edge of Pavement

Roadway Centerlines

Railroad Centerlines

Building Footprints

Building Under Construction

Creeks, Streams, Ditches

Rivers & Ponds

Topographic Legend Source: OSIP - 2019 LiDAR Collection

Index Contour

Intermediate Contour

Appraisal Legend
Source: Franklin County Auditor & Engineer

xxxxxxxxx Parcel IDs

100 Parcel Dimensions

100 Lot Numbers

123 Main St Site Address

Parcel Boundary

Subdivision Boundary

Condominium Boundary

County Boundary

City or Village Boundary

Tax District Boundary

School District Boundary

Zip Code Boundary

The information on this web site is prepared from the real property inventory maintained by the Franklin County Auditor's Office. Users of this data are notified that the primary information source should be consulted for verification of the information contained

on this site. The county and vendors assume no legal responsibilities for the information contained on this site. Please notify the Franklin County Auditor's Real Estate Division of any discrepancies.

For scaled maps, please visit the parcel viewer at https://gis.franklincountyohio.gov/parcelviewer



AS-BUILT PLOT PLAN


FOR: Marc Frient (AS-BUILT) LOT/SUBDIVISION: NA

ADDRESS: 110 S. Riverview St, Dublin, OH SCALE 1"= 30'

BUILDER: Arcaro & LaRussa


CITY OF: Dublin

DRN: TDW CK: DMW CO. OF: Franklin

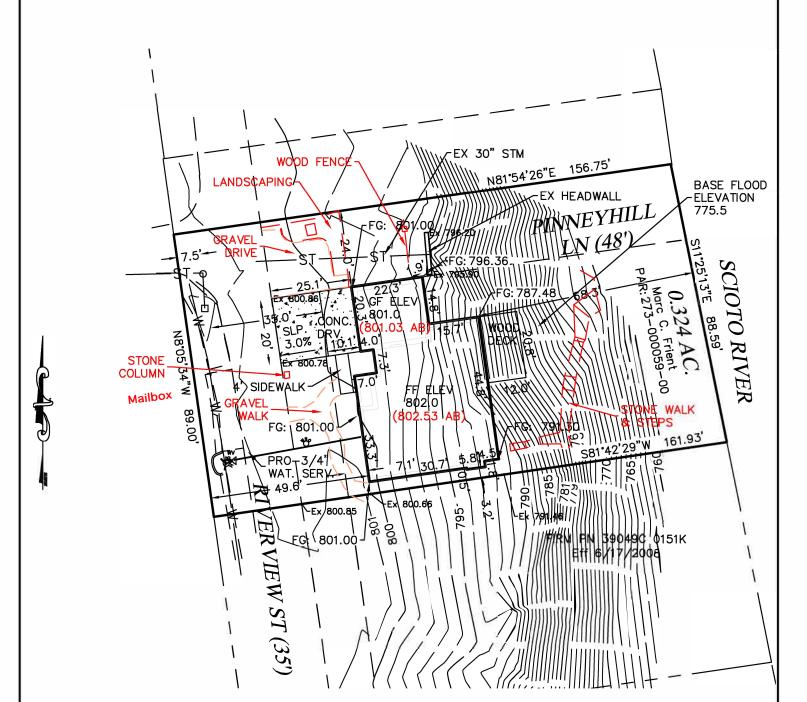

ZONING FRONT YARD-0' SIDE YARD-3' (12' TOTAL)
REAR YARD-20% LOT DEPTH/MAX 50'=31' ATTACHED GARAGE-20' (WAIVER)

LOT COVERAGE MAX LOT COVERAGE-21 % (45% ALLOW.) MAX BLDG FOOTPRINT-17.8% (25% ALLOW.)

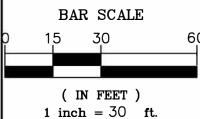

NOTE: BUILDER TO PROVIDE AND MAINTAIN
EROSION AND SEDIMENT
60 CONTROL DURING ALL
PHASES OF CONSTRUCTION

FIELD MODIFICATION TO THE EROSION AND SEDIMENT CONTROL MAY BE **NECESSARY**

PLOT PLAN

I hereby certify that the foregoing PLOT PLAN was prepared from information provided by the Client and data obtained from Engineered Subdivision Plan. This Plot Plan is to be used by the Client for the sole purpose of obtaining a Building Permit. The use of the Plot Plan for any other purpose is strictly prohibited.

Willis Engineering & Surveying

Date: 3-22-24



Todd D. Willis, PS Reg. No. S-7996 740-739-4030

<u>Code Compliance:</u>
It is the builders responsibility to assure that the building compiles with all governing codes, this includes but not limited to the 2019 R.C.O. Refer to notes on Floor Plans that reference Section R308 Glazing.

It is the builder's responsibility to assure that the final windows selected for all sleeping areas meet the criteria listed in Section 310.1 Emergency escape and rescue required. Window shown on this plan are labeled as Pella Casement.

General Notes:

1. A 1/2" plywood backer is to be installed behind all trim boards used in conjunction with stucco and wood sided walls.

2. It is the Builder's responsibility to determine the final method and quantity of roof ventilation.

3. It is the Mason's responsibility to determine the final method and quantity of roof ventilation.

3. It is the Mason's responsibility to ensure that any masonry fireplaces draft properly and that chimneys are built to the standards of the local building code.

4. In addition to these notes, refer to the notes on sheet 1.

5. It is the builders responsibility to assure all structural loads are transferred to the foundation.

6. The house is to be water tight when completed. It is the general contractors responsibility to provide all waterproofing, flashing, weep holes and caulking required to prevent moisture penetration. to provide all waterproofing, flability, weep flores and causing required to penetration.

7. It is the builders responsibility to assure all finish materials used are to be installed per manufacturer's recommendations or per industry standards. This includes, but is not limited to flashing. Melaragno Design Company, LLC is not responsible for defects in materials used or installation of materials.

8. It is the builder's responsibility to determine gutter size and down spout size, quantity and

Wood trusses:
The following notes only apply if wood trusses are used.

1. Use truss clips to fasten all trusses to the top plate of walls. Do not nail trusses to top plate directly.

2. For interior wall connections, use Simpson model STC.

3. For scissors truss connections, use Simpson TC-24 or TC-25.

4. When applying drywall to the bottom chord of the roof truss, use Simpson DS drywall stops at interior wall intersection. Hold screws and nails back 15" from wall.

5. It is the Builder's and/or the Truss Manufacturer's responsibility to take any measurements used for truss manufacturing from only the actual field conditions. Do not build trusses from the dimensions on this plan for actual field conditions may vary from the information given in this plan set. Melaragno Design Company, LLC is not responsible for any error in truss orders or manufacturing. or manufacturing.
6. The truss manufacturer is to adjust heel heights as needed to align fascia boards and any other trim material to match the elevation drawings in this plan set.

Please Note:
Any discrepancies, errors and/or omissions in the notes, dimensions, and/or drawings contained on these documents shall be brought to the attention of Melaragno Design Company, LLC, the designer, immediately after the said discrepancies are discovered. Proceeding with construction constitutes the acceptance of these documents and any discrepancies, errors and/or omissions become the responsibility of the building contractor.

NOTE:
IT IS THE RESPONSIBILITY OF THE GENERAL
CONTRACTOR, ROOFING CONTRACTOR,
EXTERIOR TRIM CONTRACTOR AND/OR
MASONRY CONTRACTOR TO DETERMINE THE BEST ROOFING AND FLASHING PRACTICES AT EACH INSTANCE.


NOTE:
CAULK ALL JOINTS WITH ASTM C-920
CAULK AND PROVIDE METAL FLASHING AS
REQUIRED TO PREVENT MOISTURE
PENETRATION.

NOTE:
ALL BUILDING MATERIALS, FINISH AND
STRUCTURAL, TO BE INSTALLED IN
ACCORDANCE WITH MANUFACTURER'S WRITTEN INSTRUCTIONS and / or RECOMMENDATIONS.

NOTE: ALL EXTERIOR TRIM TO BE SMOOTH CEDAR OR SIMILAR PRIMED ON ALL SIDES.



SOUTH-WEST PERSPECTIVE

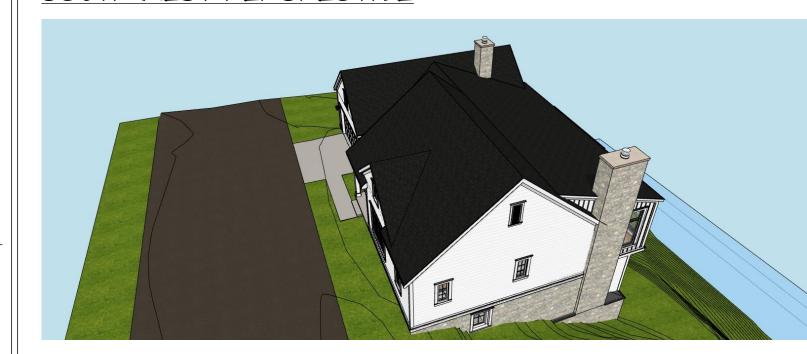

SOUTH-WEST BIRD'S EYE PERSPECTIVE



MEST PERSPECTIVE







MEST ELEVATION

SCALE:1/4" = 1'-0"

MEMBER

B D

AMERICAN INSTITUTE of BUILDING DESIGN

Elevations

Residenc


Revisions

1\1/12/2022 Revise plans per items on the City of Dublin "Listing of Items of Non-Compliance" notice dated 1/4/2022. A 6/7/2022 Revise plans and foundation design to adapt to discovered site conditions. Change foundation from standard wall and footing foundation to caisson, grade beam and footing foundation. △ 2/17/24 Revise handrail material and

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Date 2/17/2024 Job Name MHFrient_112 Rivervieu File Name MDG 2024-2-17 MHFrient, 112 Riverview Site Model REV11.pln Sheet No.

NORTH-WEST PERSPECTIVE

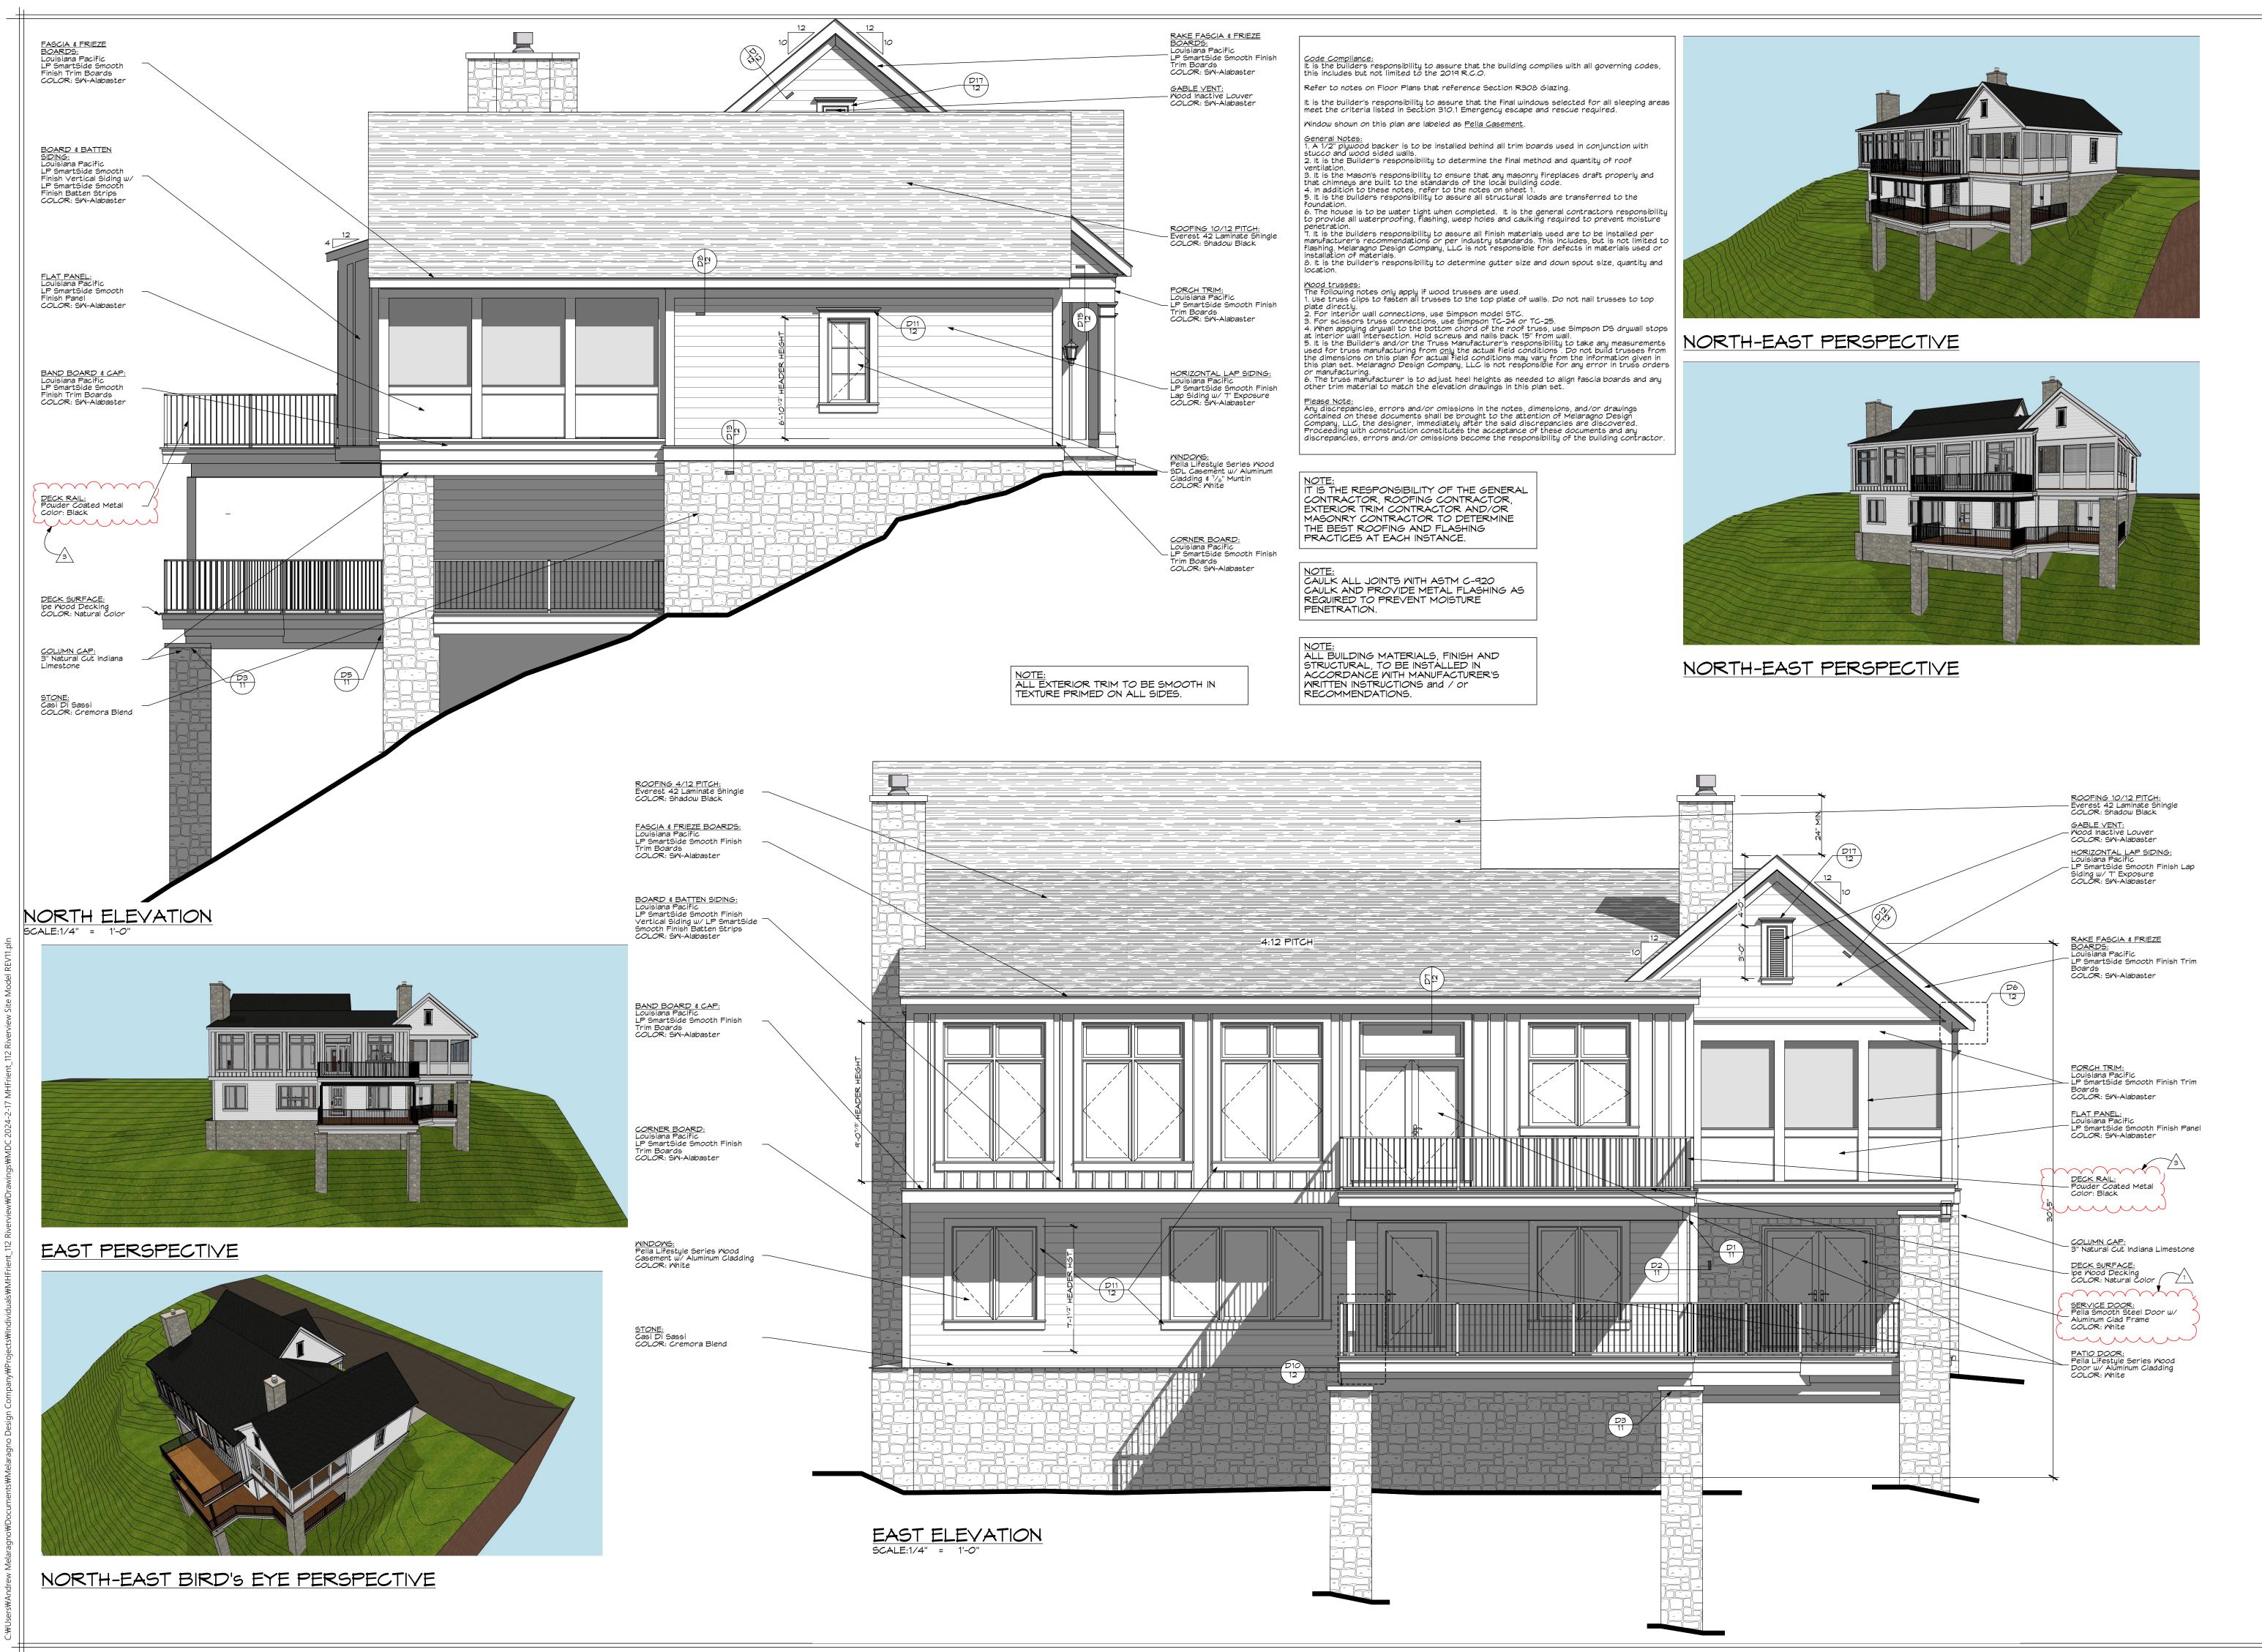

MEMBER B D AMERICAN INSTITUTE of BUILDING DESIGN

Residenc

Elevations xterior


Revisions


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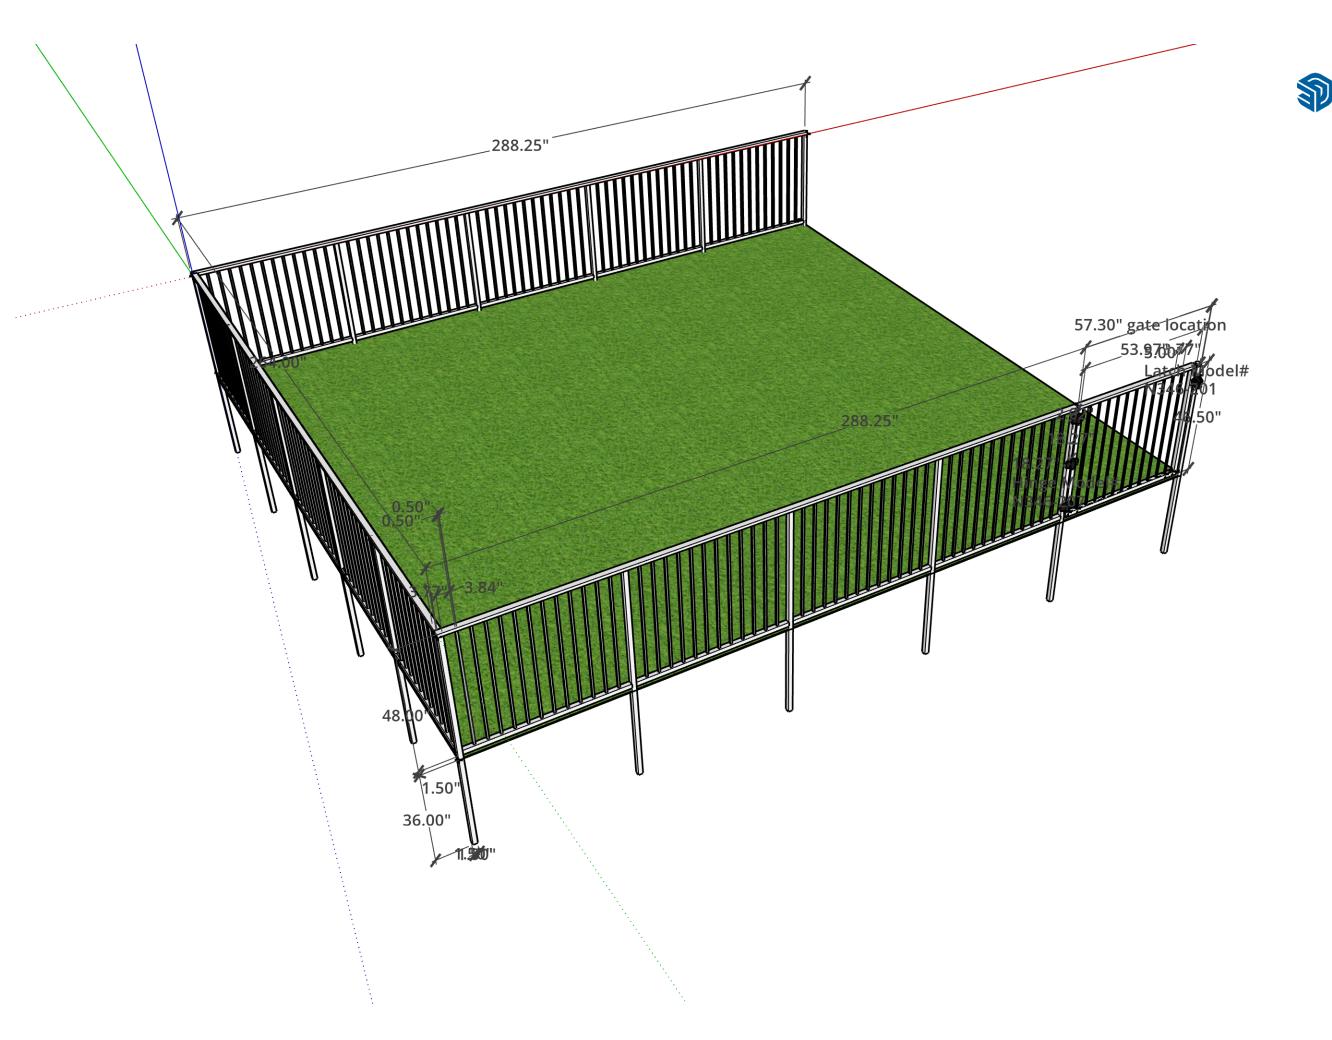
2/17/2024 Job Name MHFrient_112 Rivervieu File Name MDC 2024-2-17 MHFrient, 112 Riverview Site Model REV11,pln Sheet No.






Front Landscape Plan 110 South Riverview Street, Dublin, Ohio

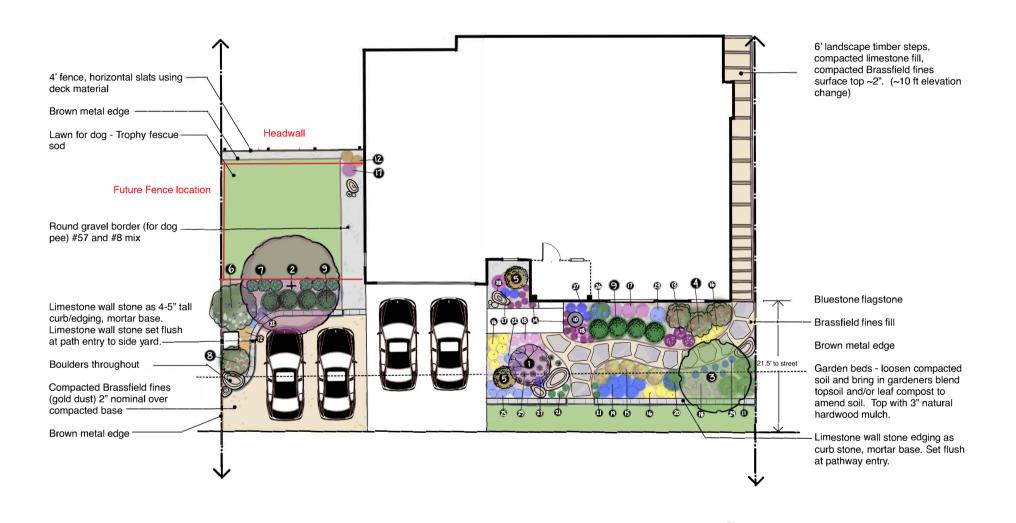


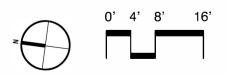






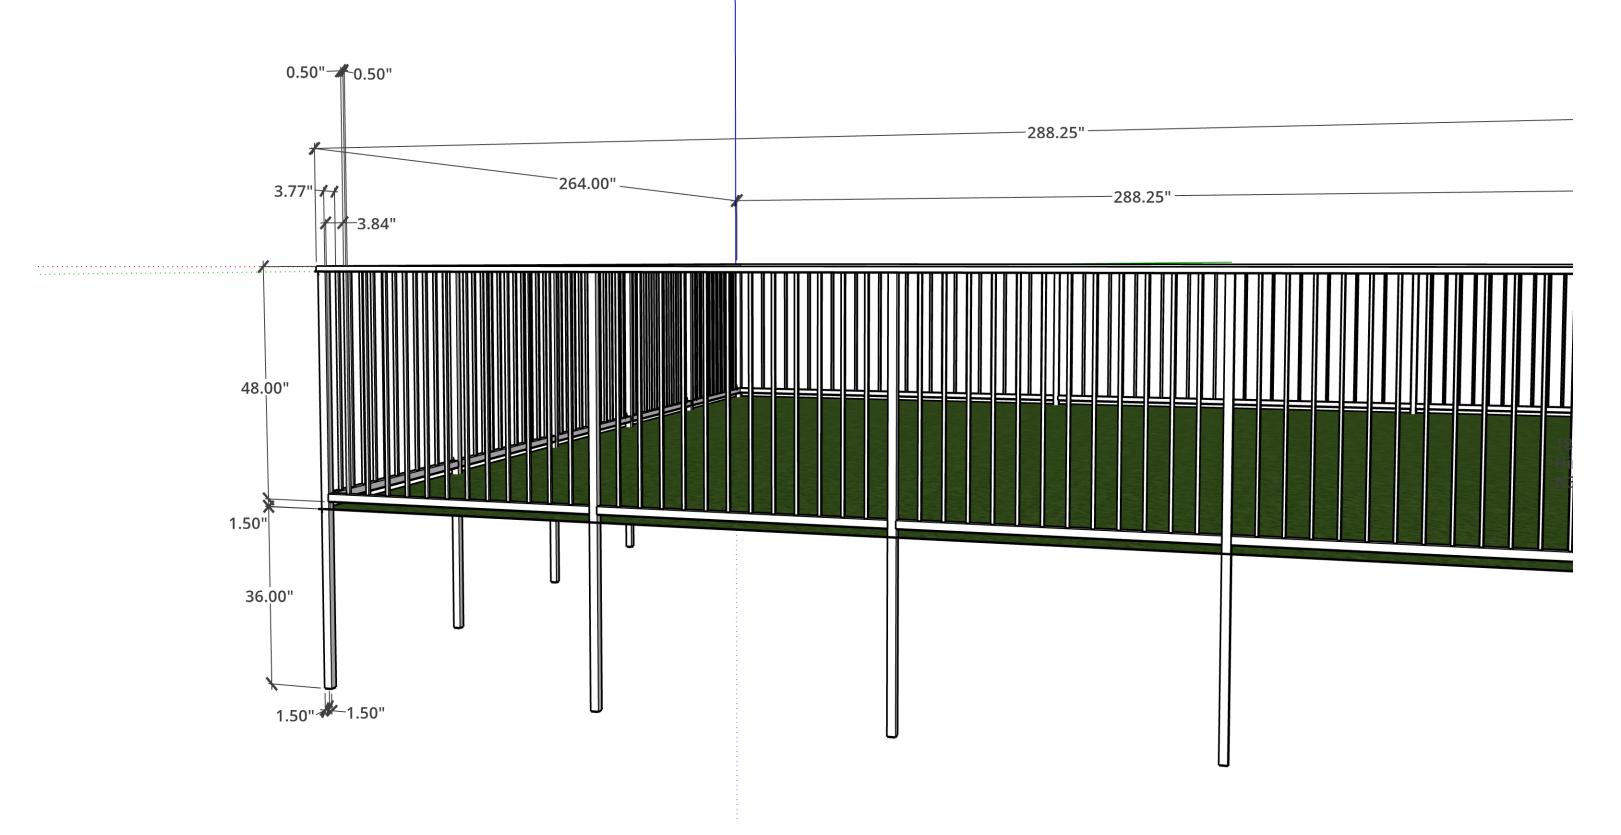

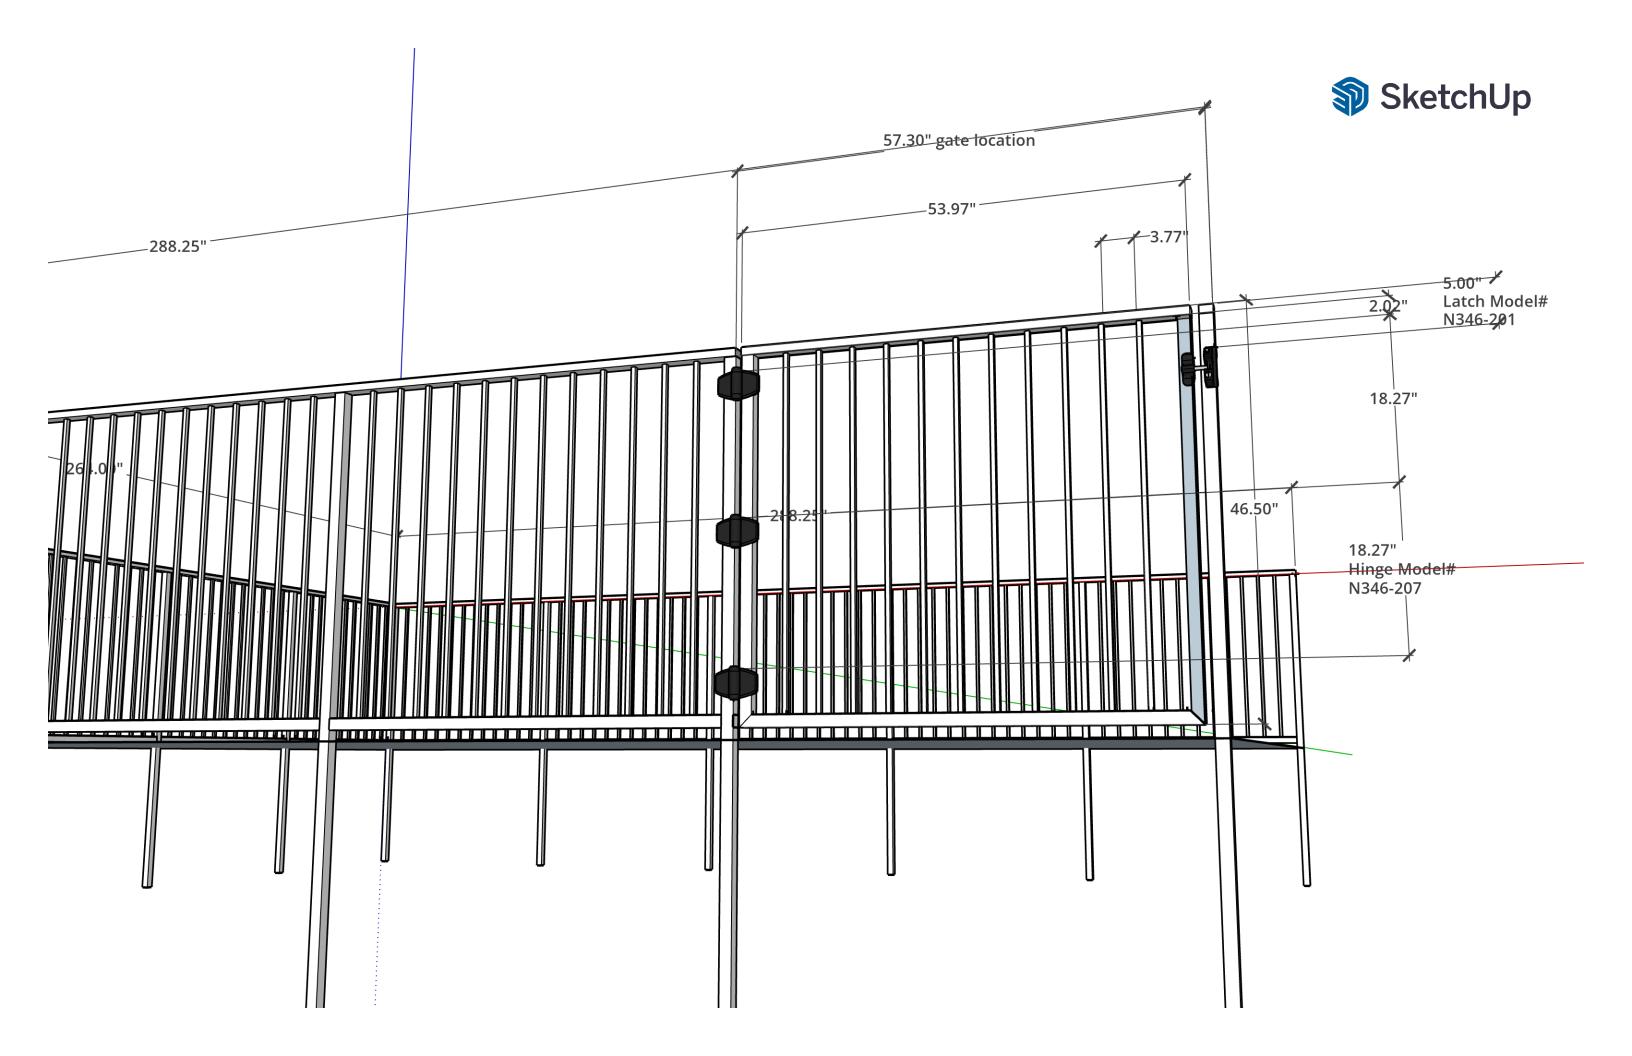

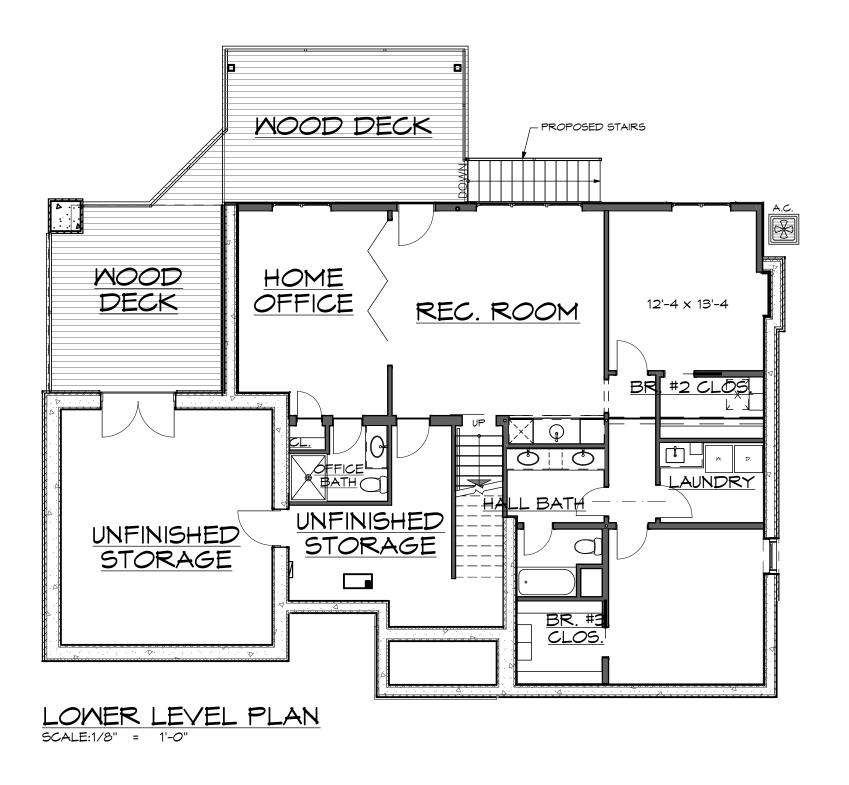

The Frient Residence

110 S. Riverview Street Dublin, Ohio 43017 4/18/2024





SOUTH-EAST PERSPECTIVE



EAST PERSPECTIVE





EAST ELEVATION SCALE:1/8" = 1'-0"

The Frient Residence

110 S. Riverview Street Dublin, Ohio 43017 4/18/2024

