

archall

Crown INEOS Amended Final
Development Plan
Submission


MAY 14, 2025





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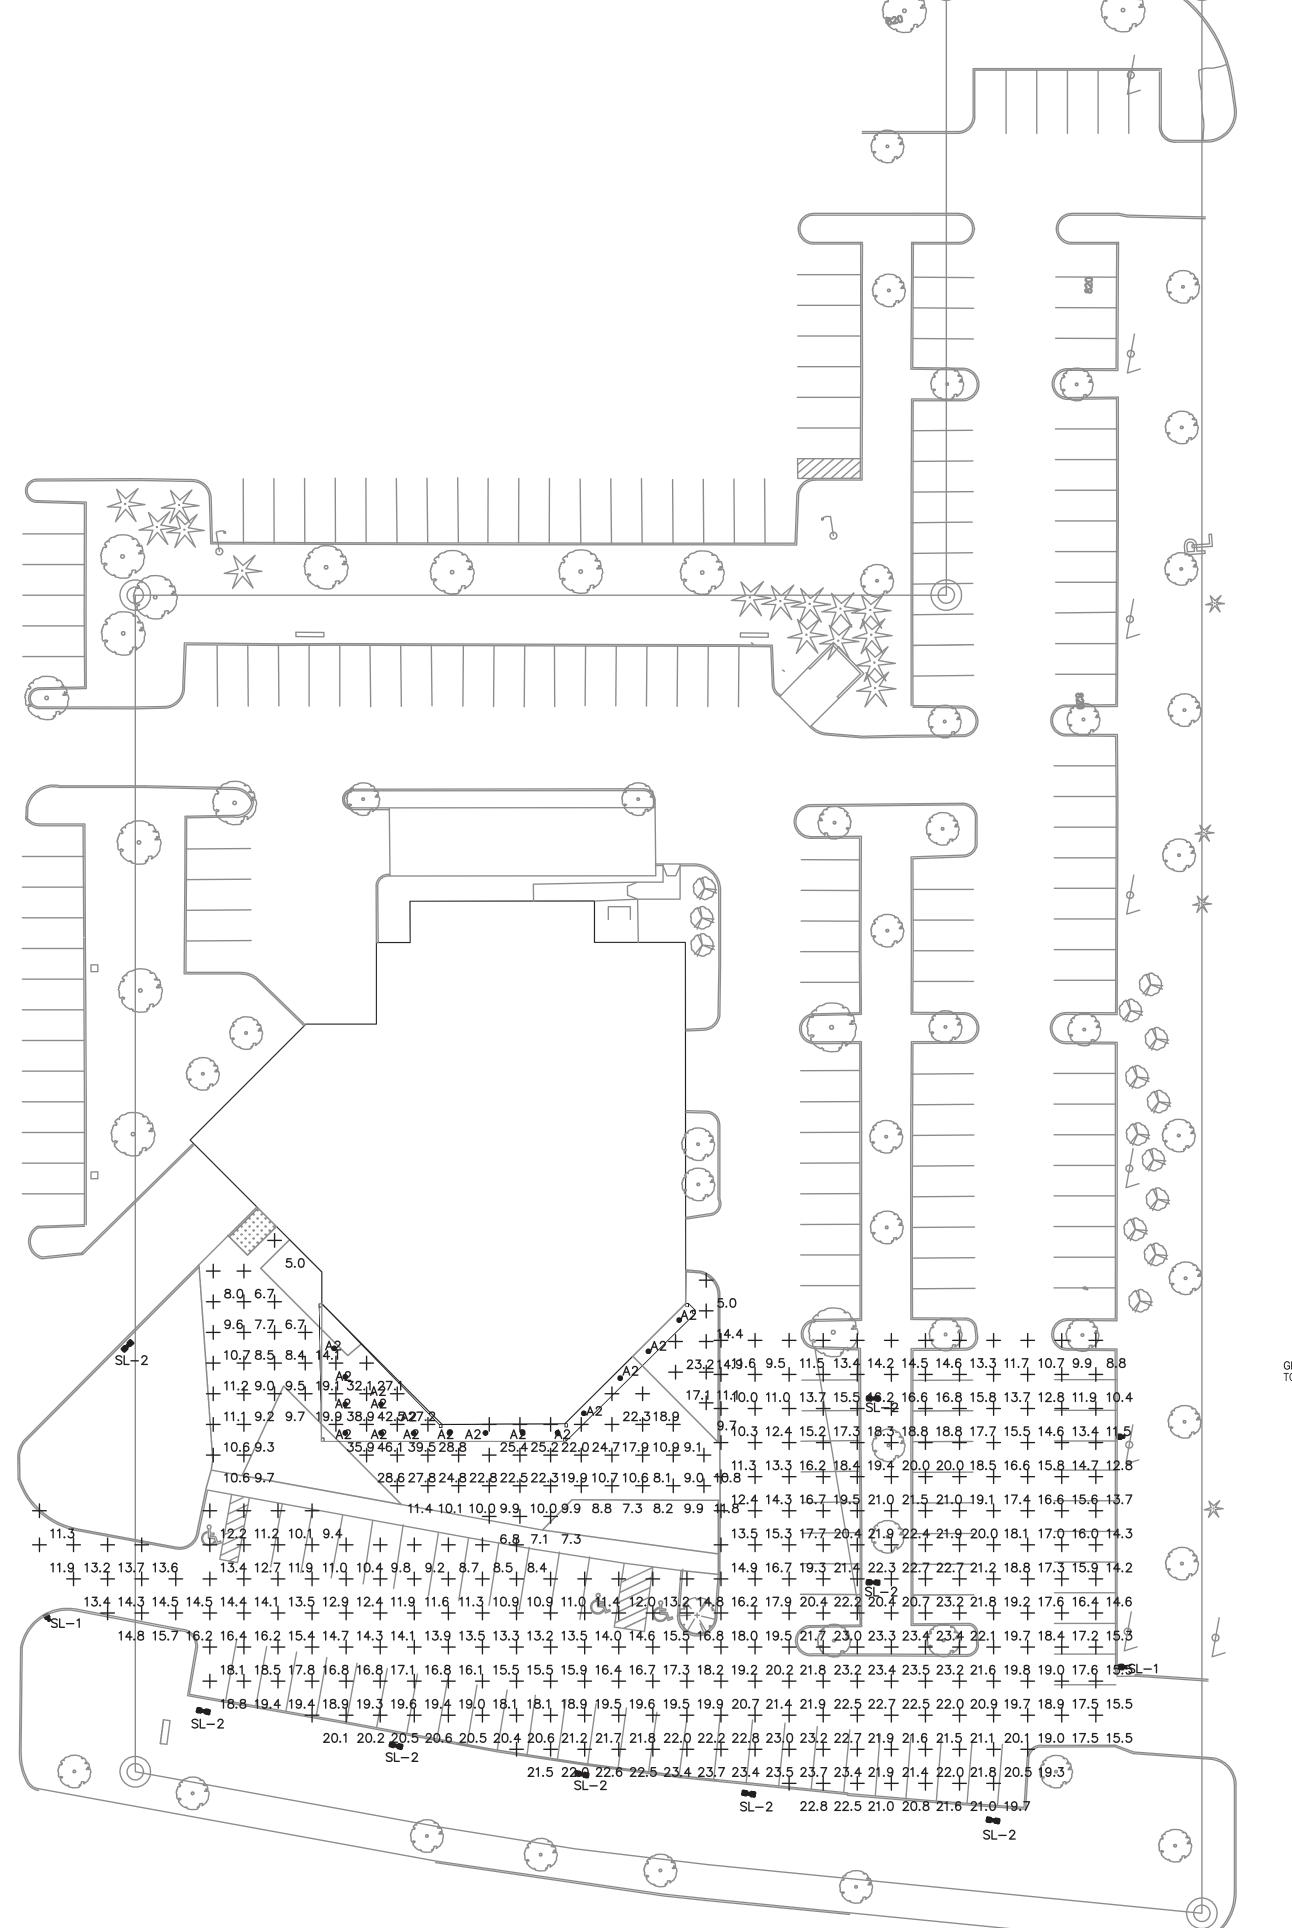


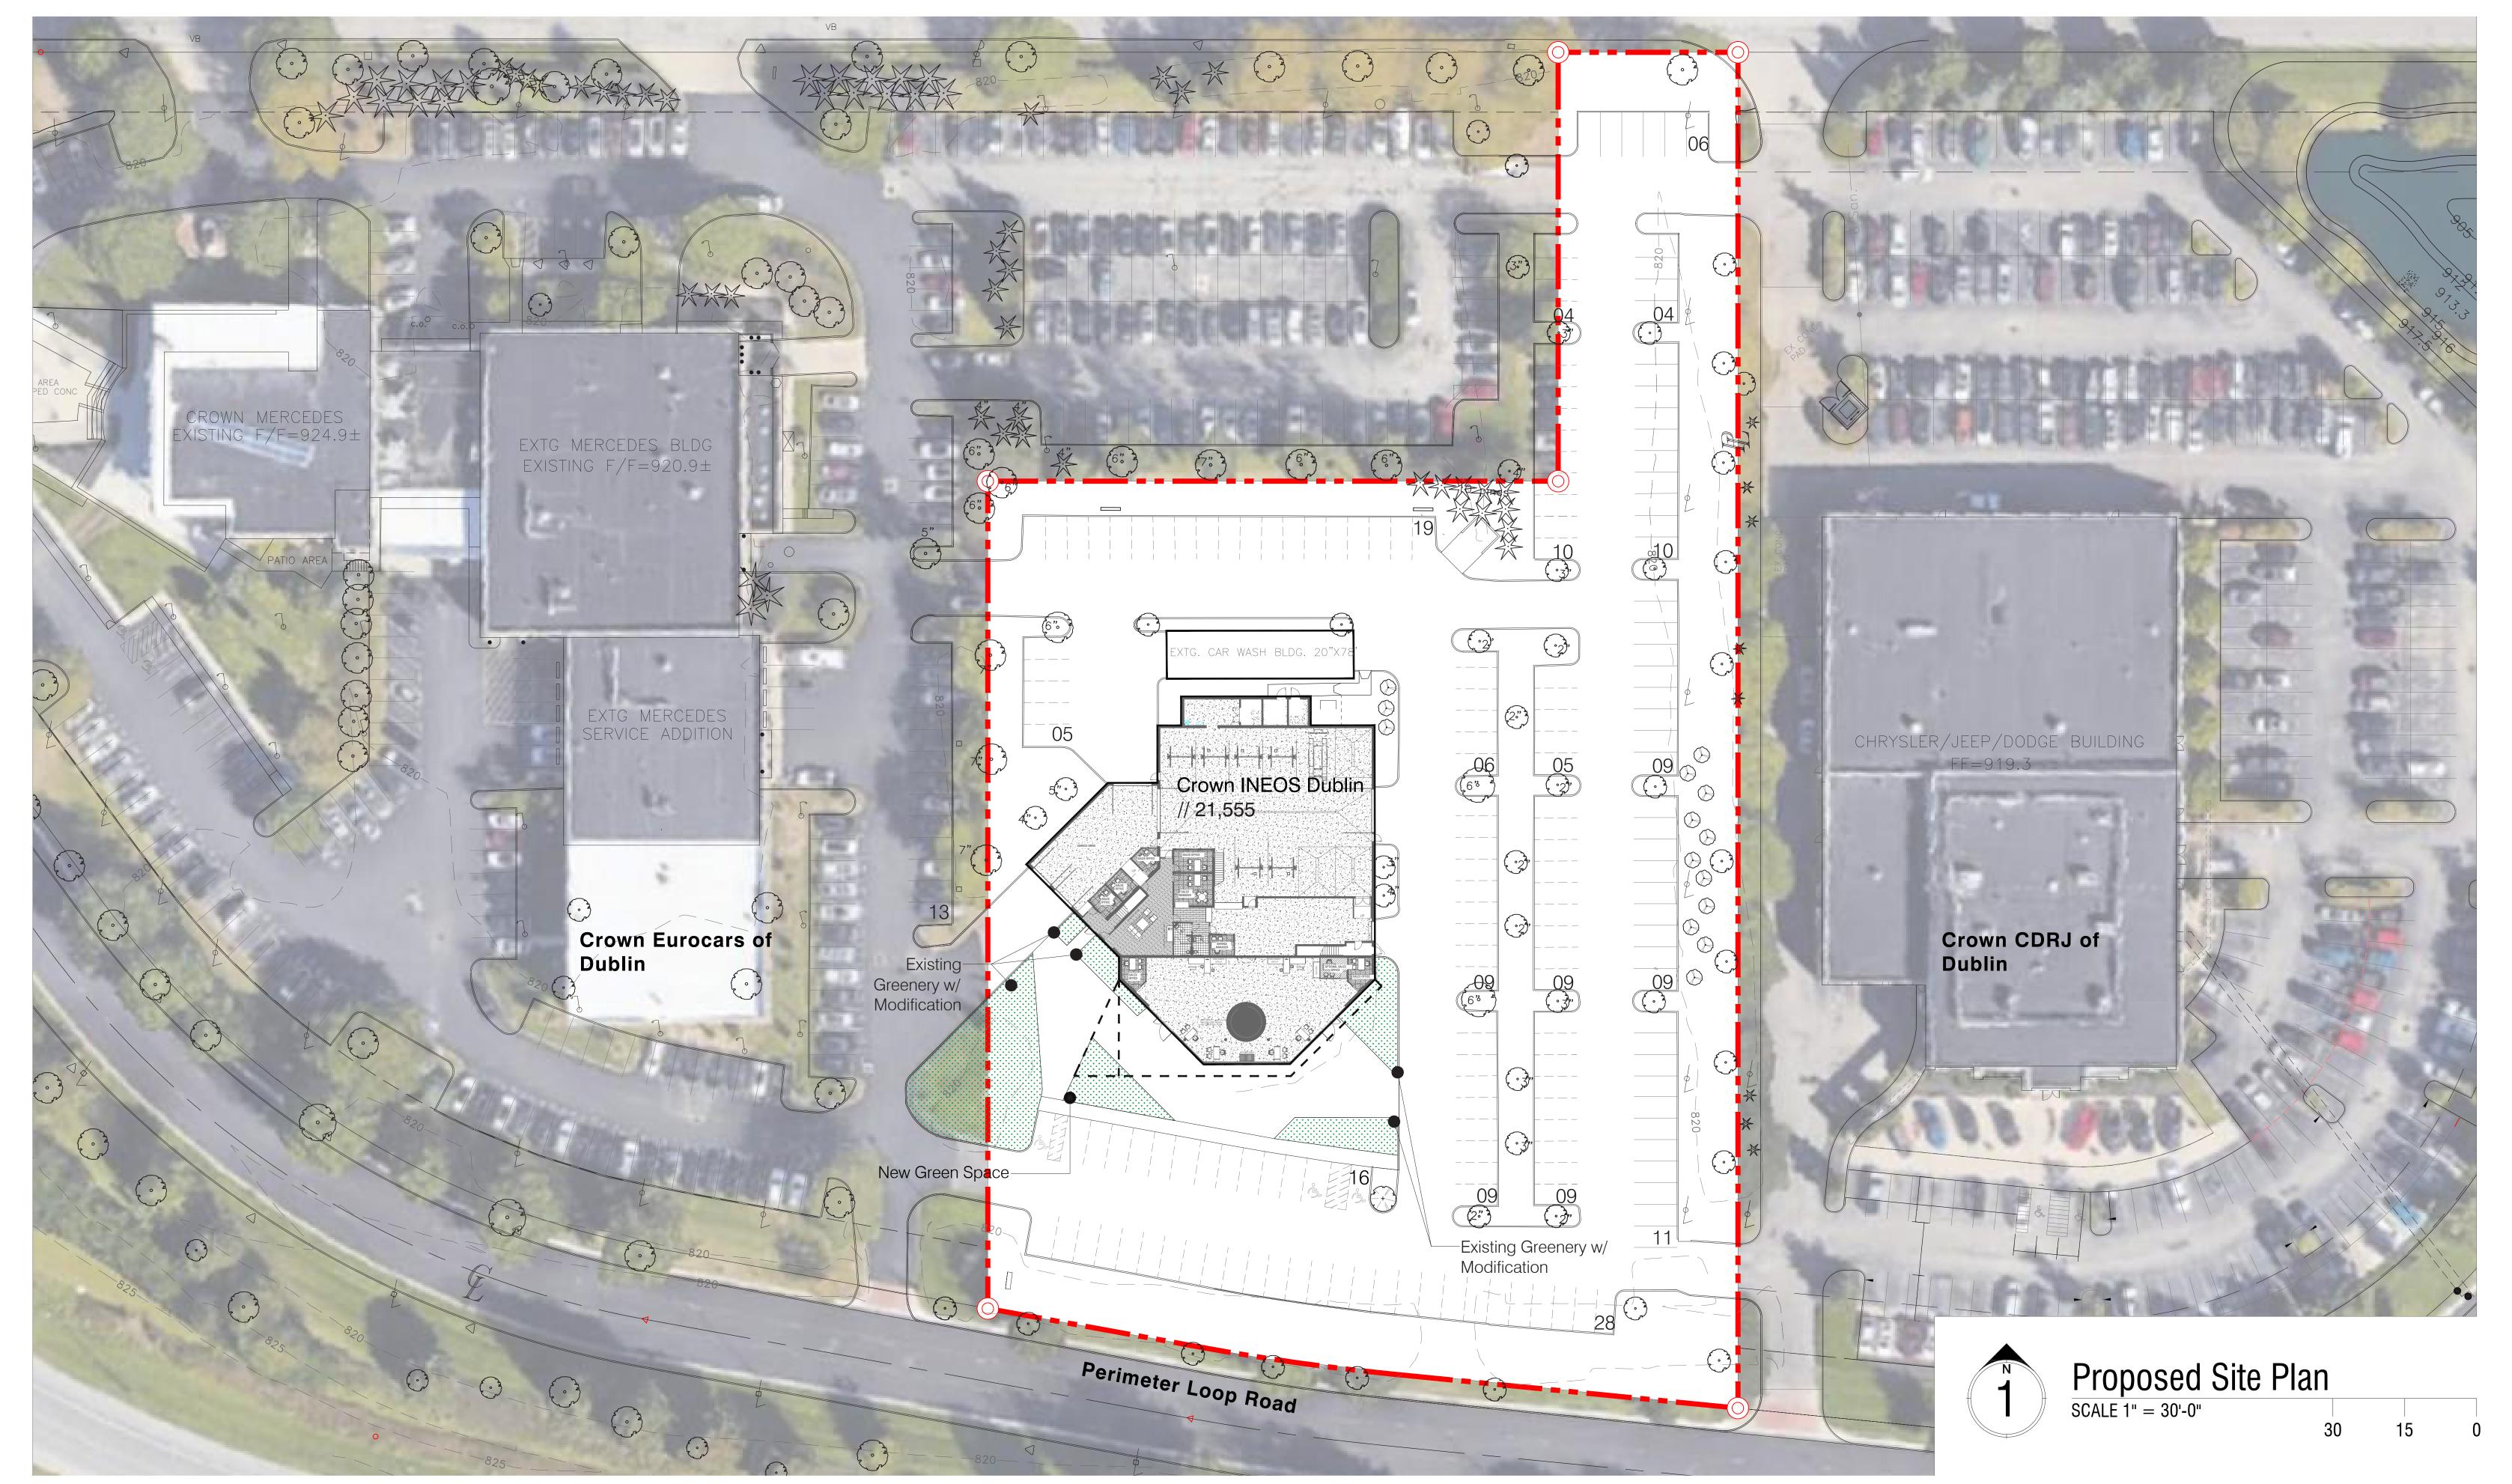

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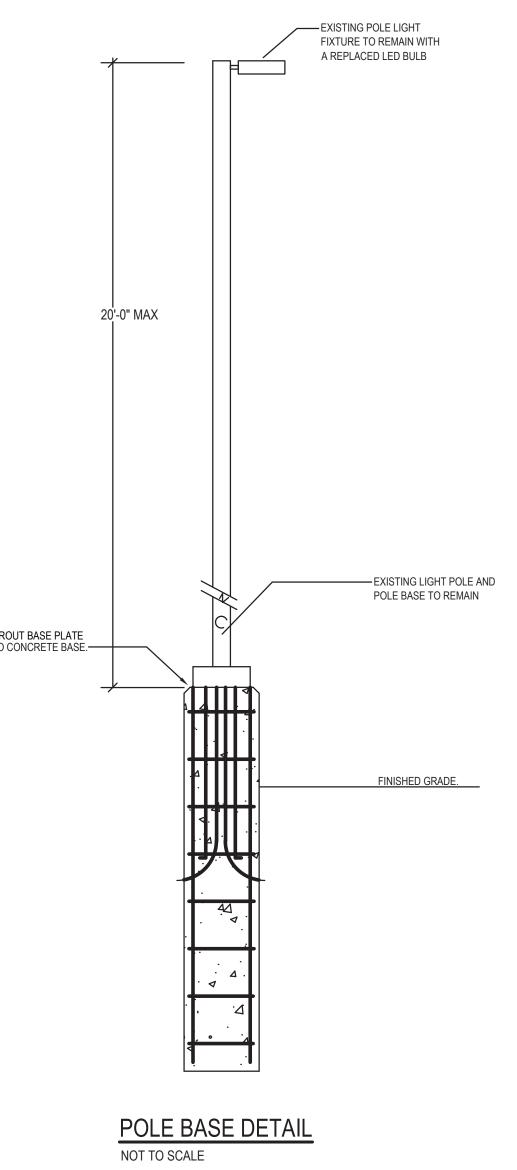
CROWN
AUTOMOTIVE GROUP







Statistics						
Description	Symbol	Avg	Max	Min	Max/Min	Avg/Min
CANOPY LOT		15.9 fc	46.1 fc	5.0 fc	9.2:1	3.2:1
MAIN PARKING	+	17.3 fc	23.7 fc	8.4 fc	2.8:1	2.1:1


Schedule	9								
Symbol	Label	QTY	Manufacturer	Catalog	Description	Number Lamps	Lamp Output	LLF	Input Power
	SL-1	3	Lithonia Lighting	RSX4 LED P5 50K R5	RSX Area Luminaire Size 4 P5 Lumen Package 5000K CCT Type R5 Distribution	1	63291	1	483.4963
	SL-2	8	Lithonia Lighting	RSX4 LED P5 50K R5	RSX Area Luminaire Size 4 P5 Lumen Package 5000K CCT Type R5 Distribution	1	63291	1	966.9926
	A	15	Lithonia Lighting	LDN8 27/60 LO8AR LSS	8IN LDN, 2700K, 6000LM, CLEAR, SEMI- SPECULAR REFLECTOR	1	5564	1	72.96



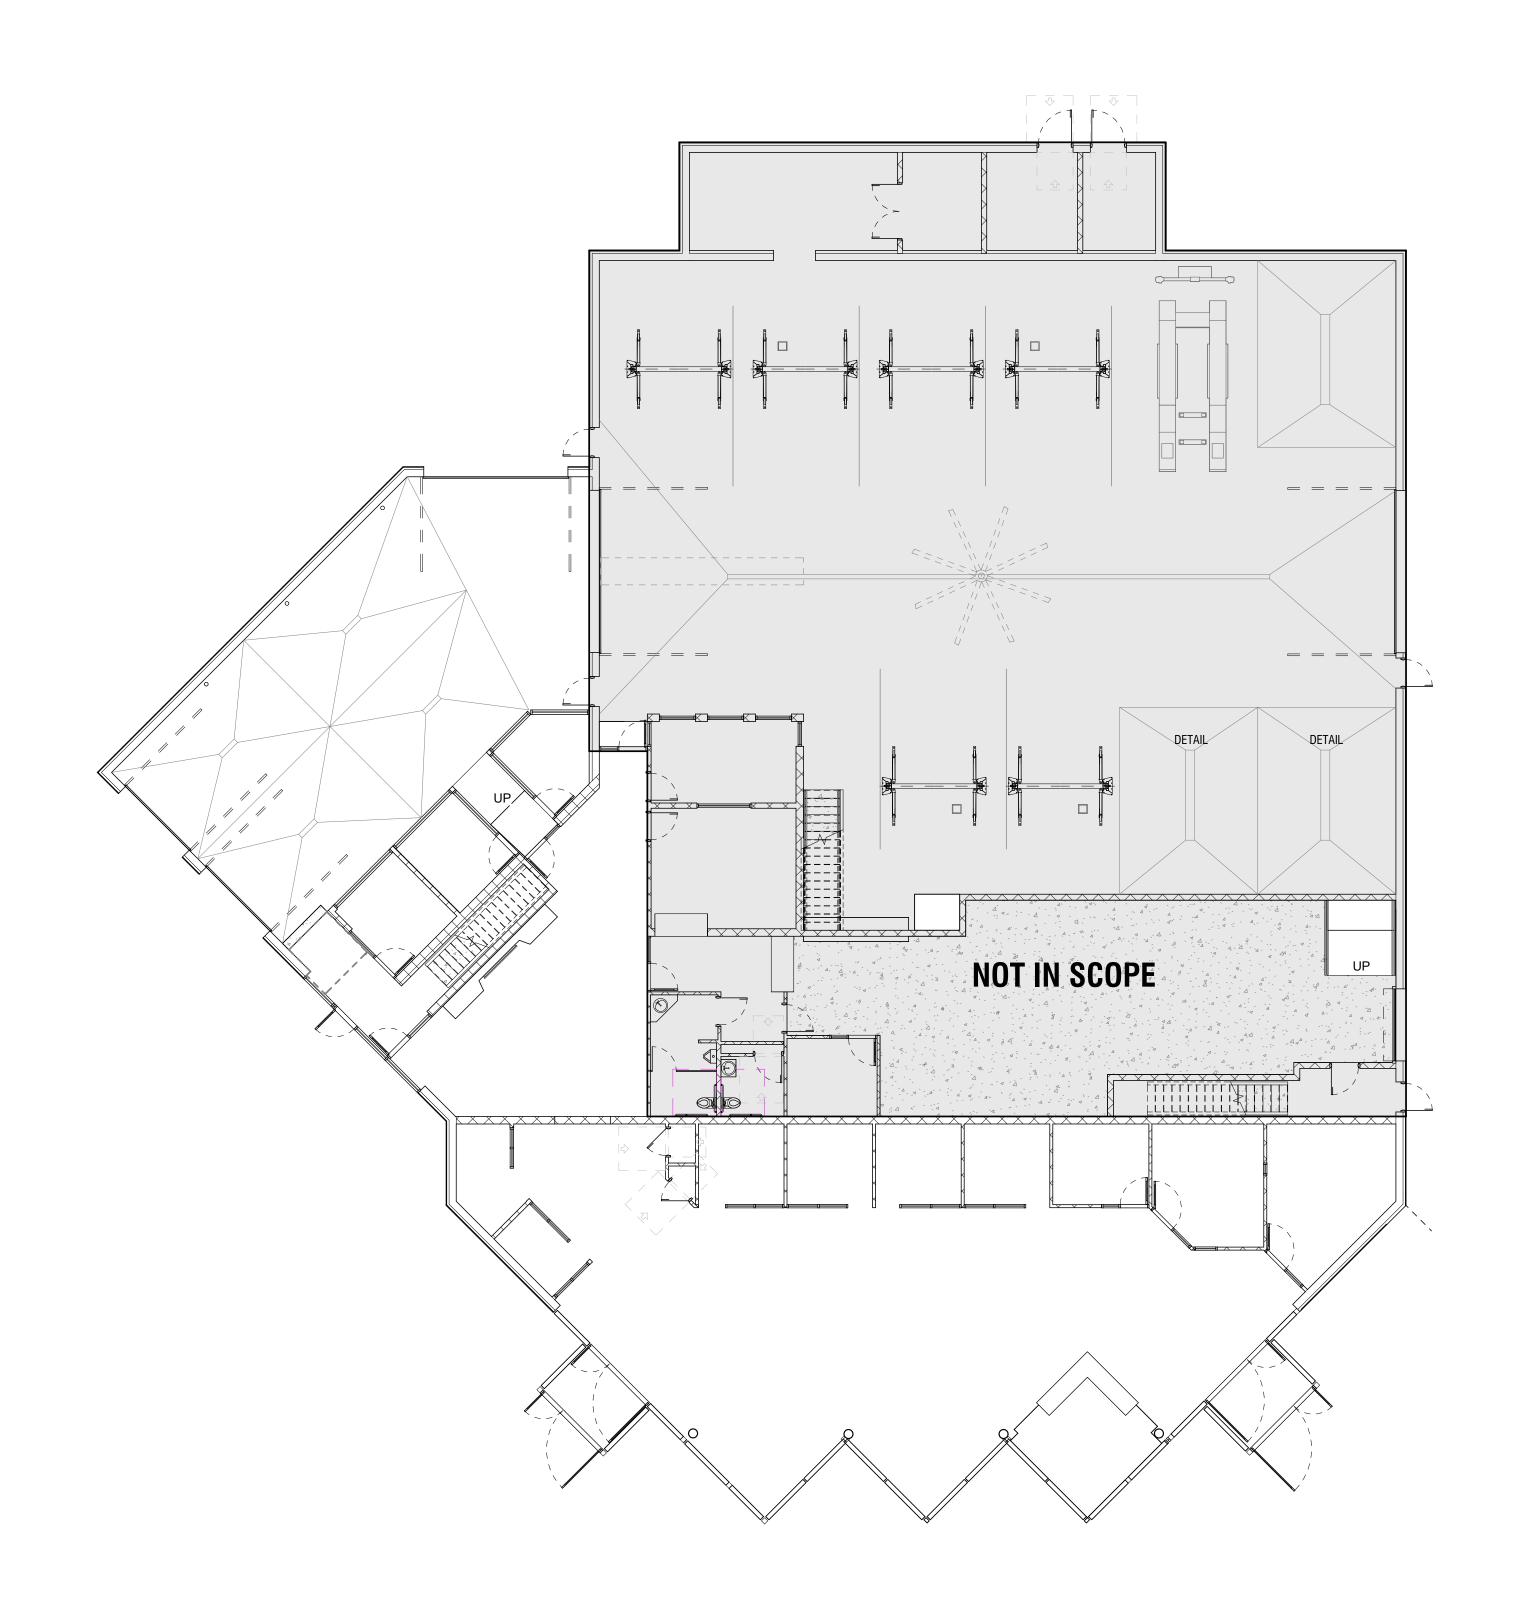


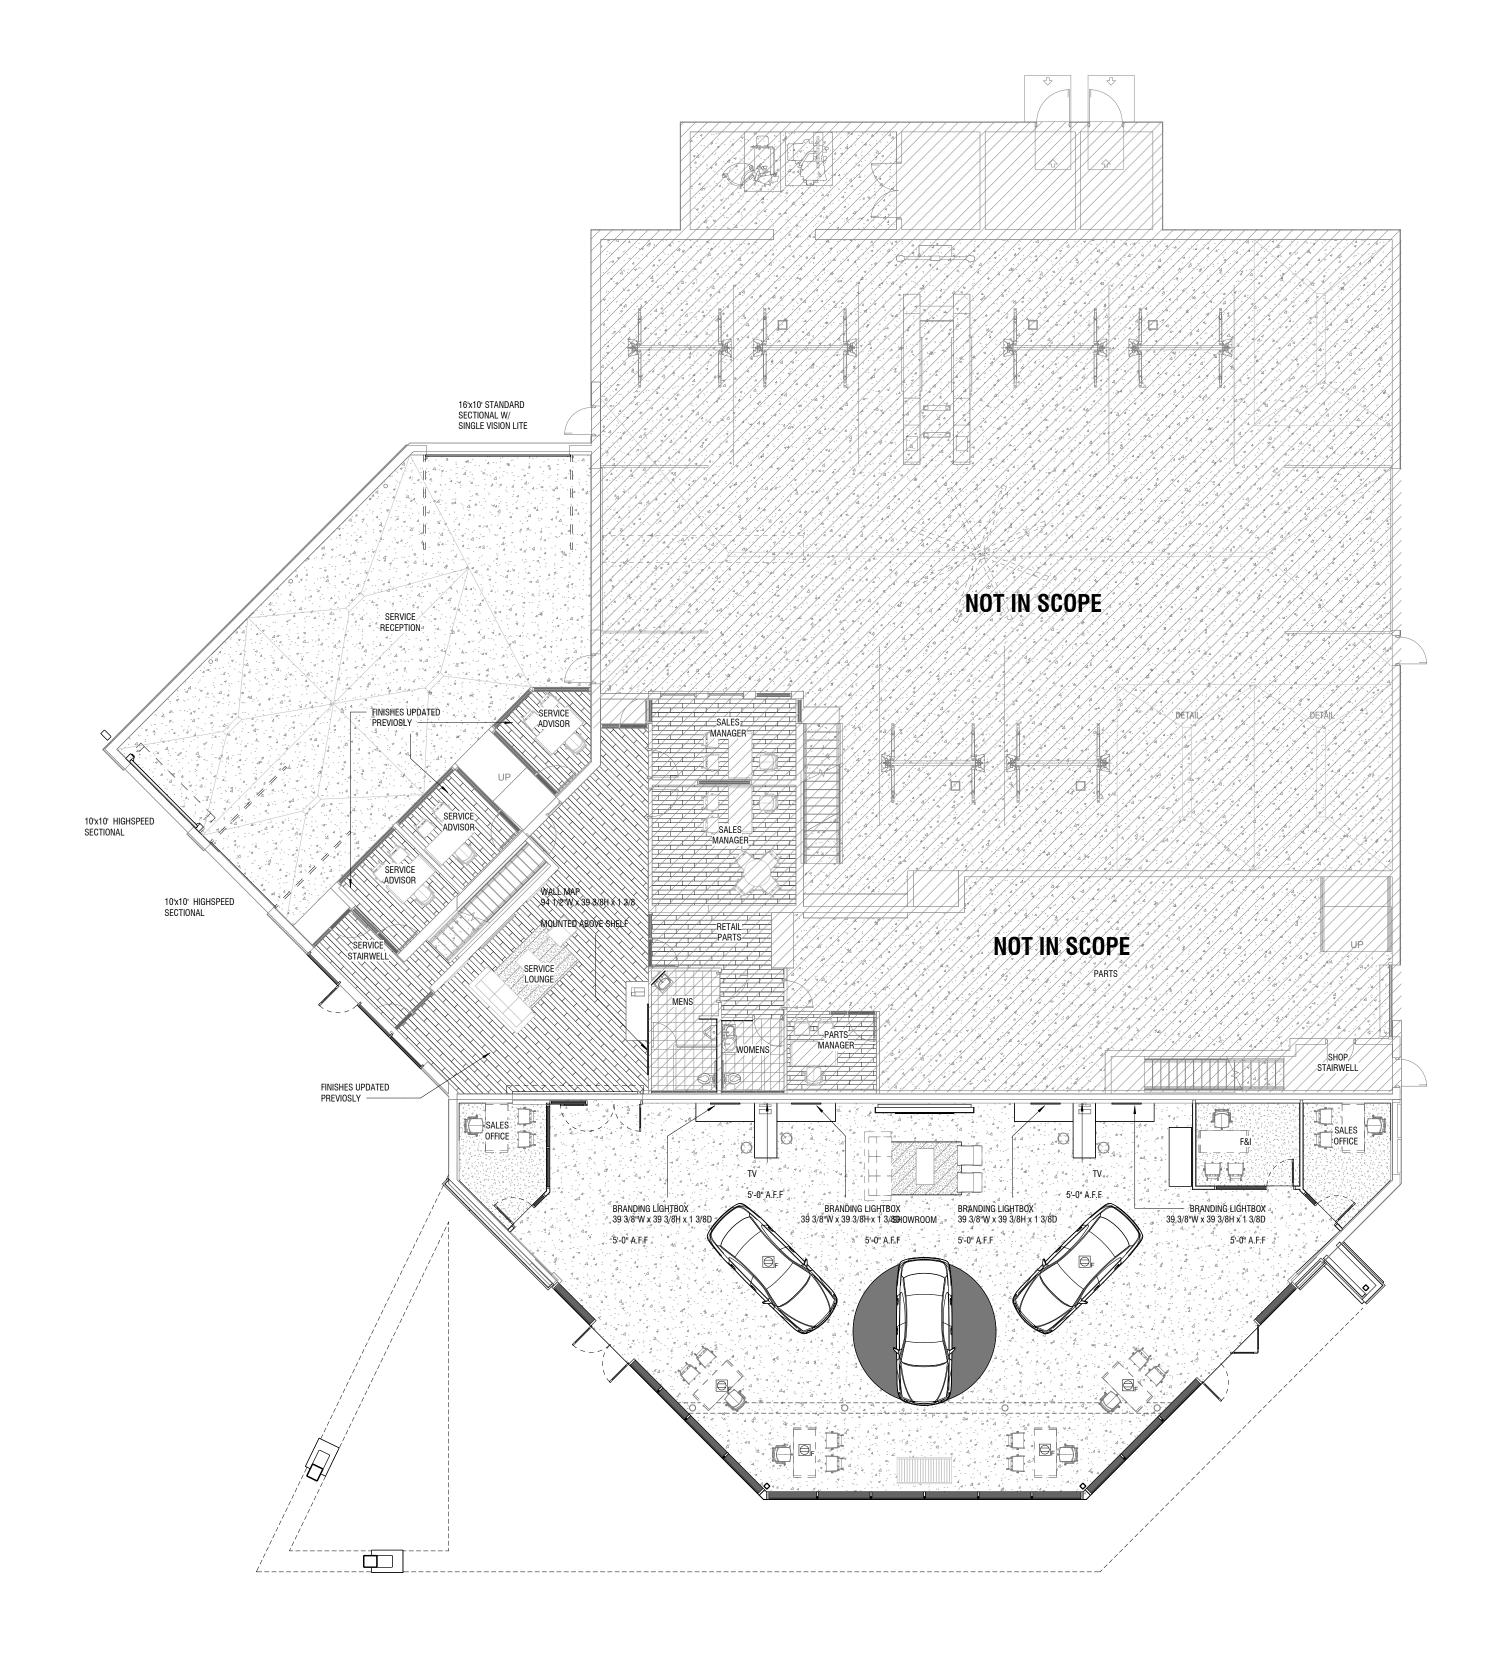





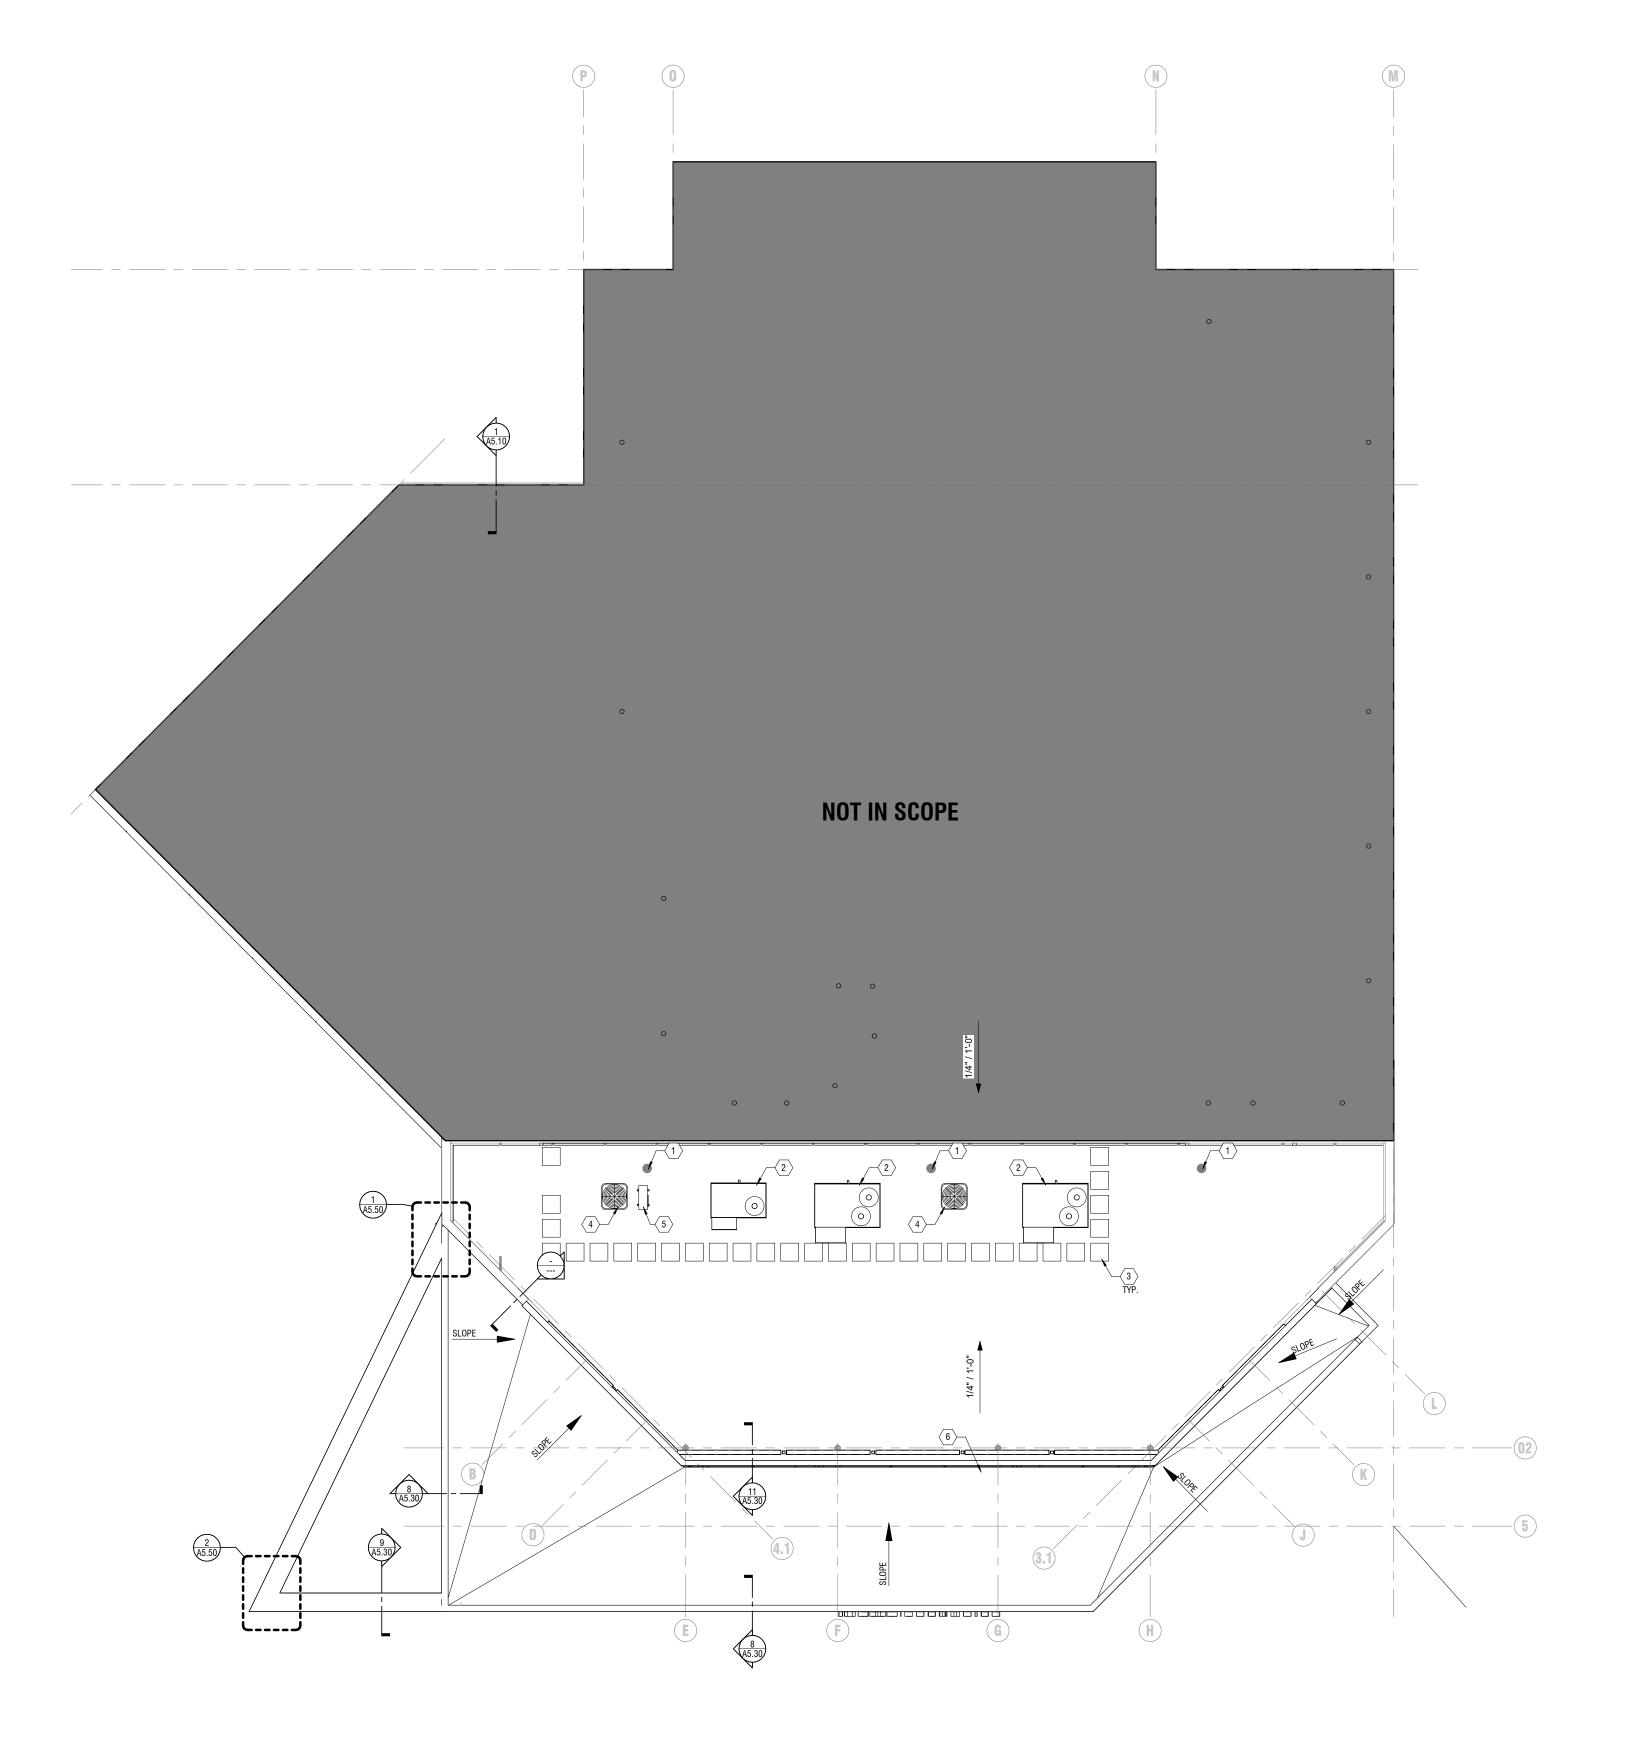



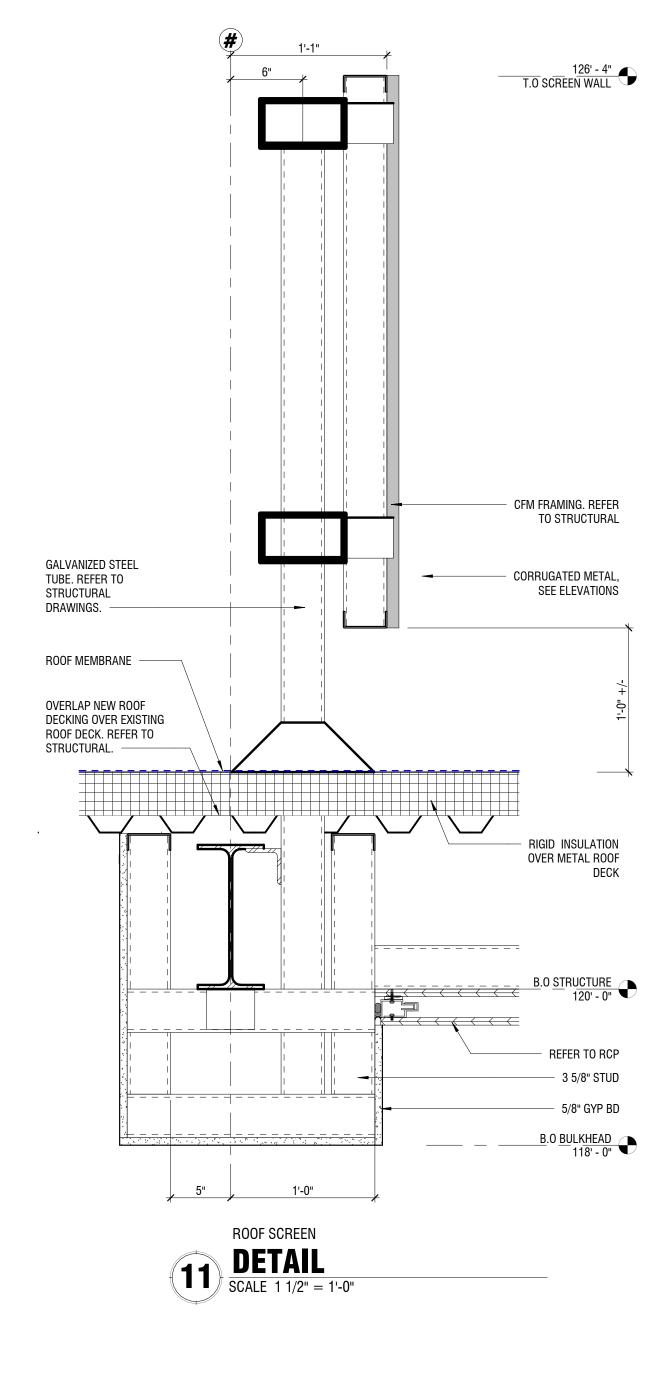

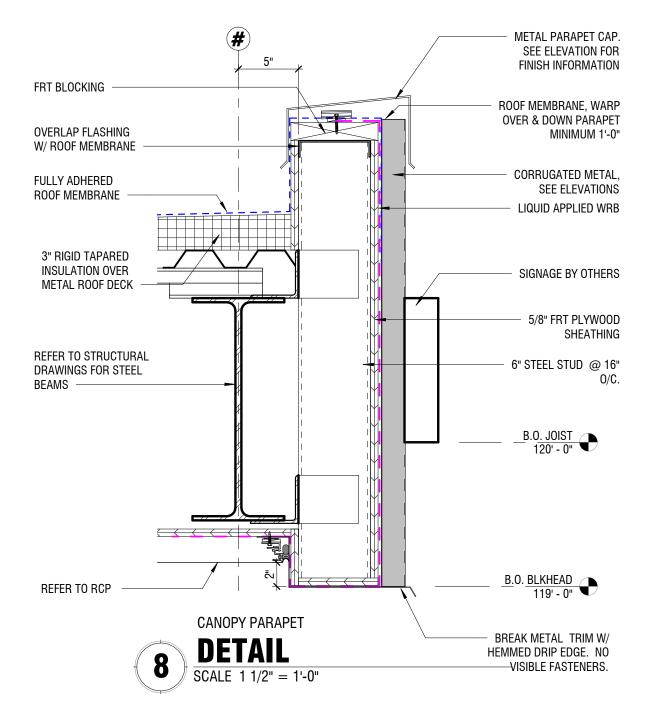

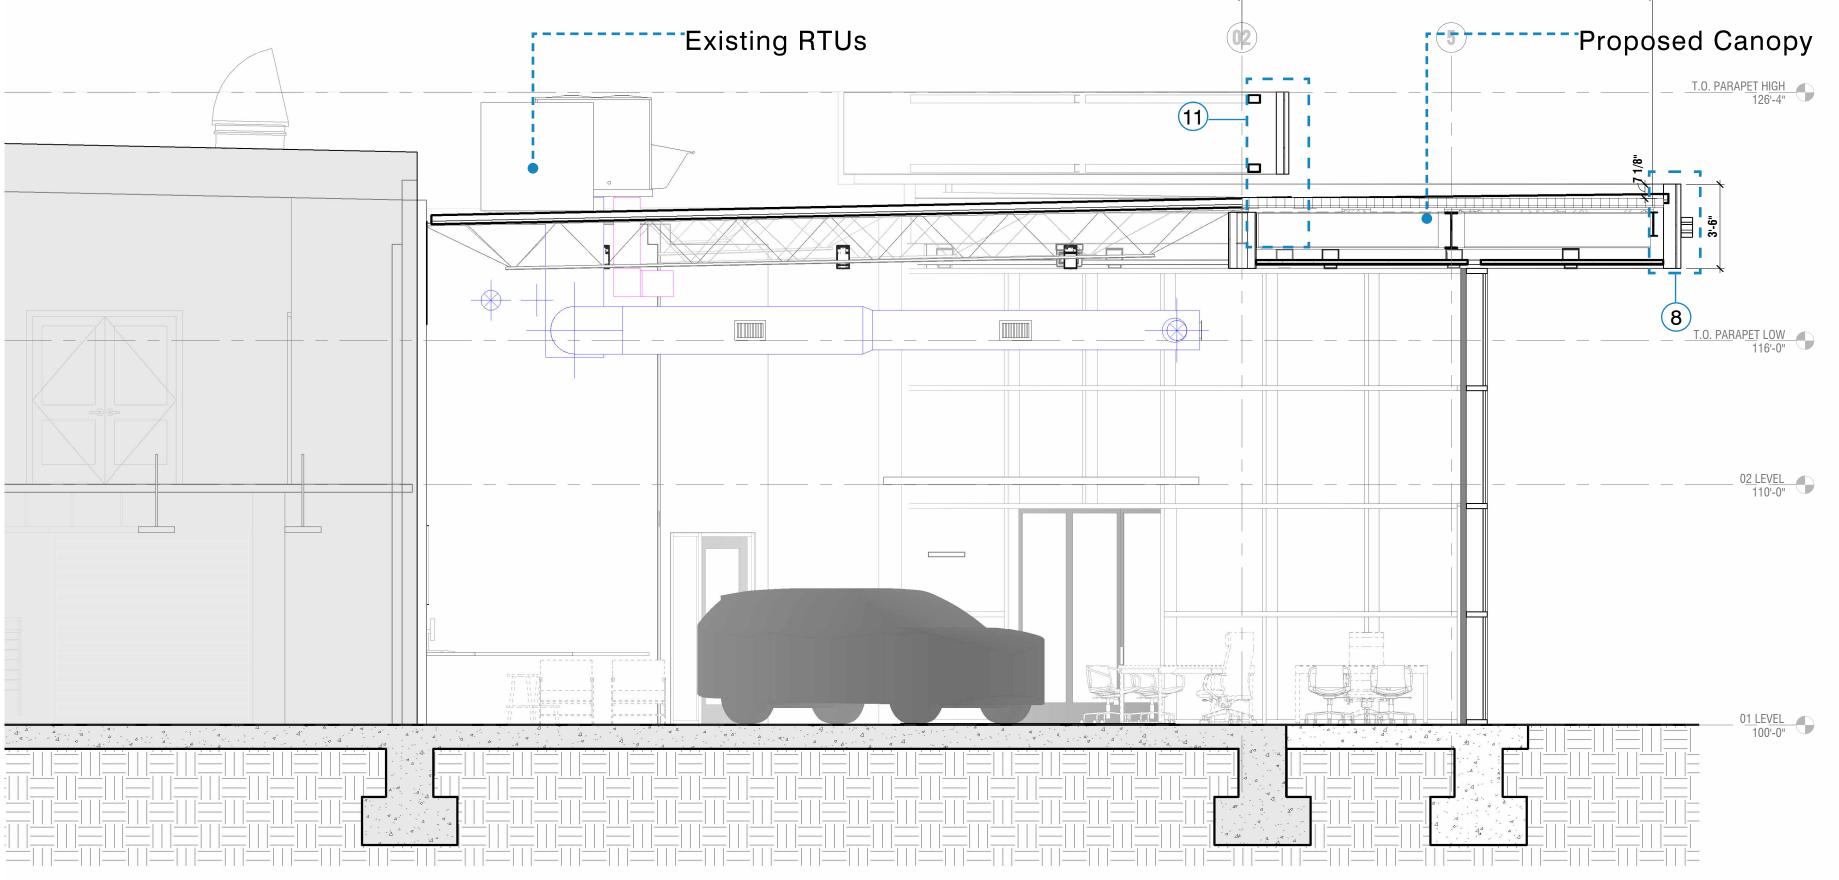



17'-1 1/4"





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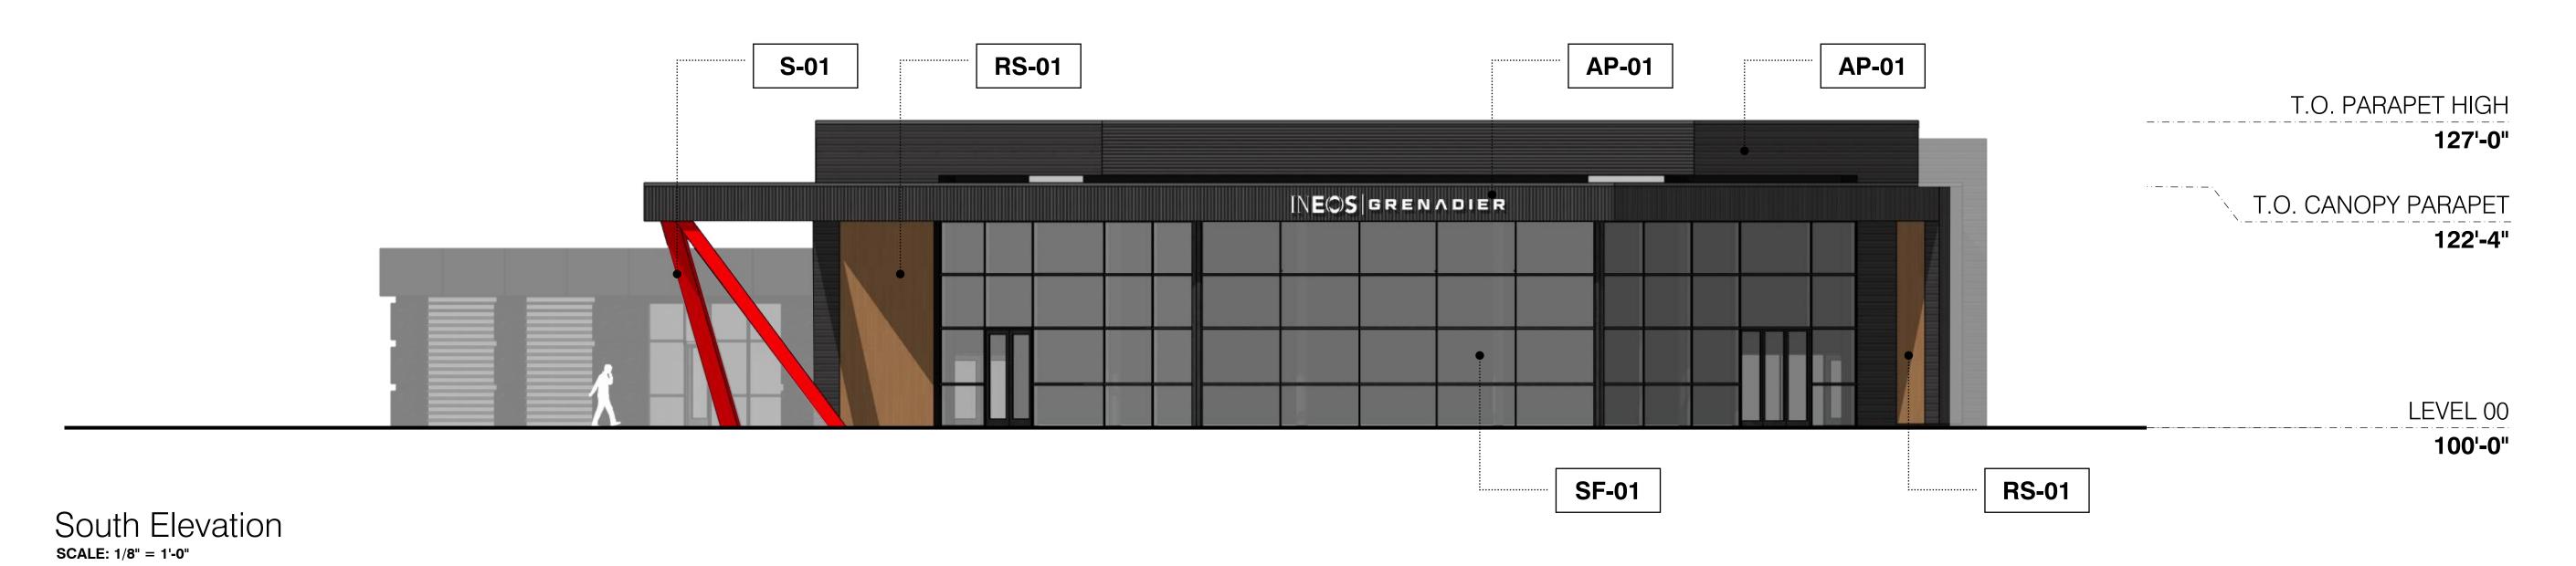



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SCOPE IS ONLY THE FACADE OF SHOWROOM AND FACADE OF RECEPTION. THE REST OF THE BUILDING TO REMAIN





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SCALE: 1/8" = 1'-0"

NOTE:

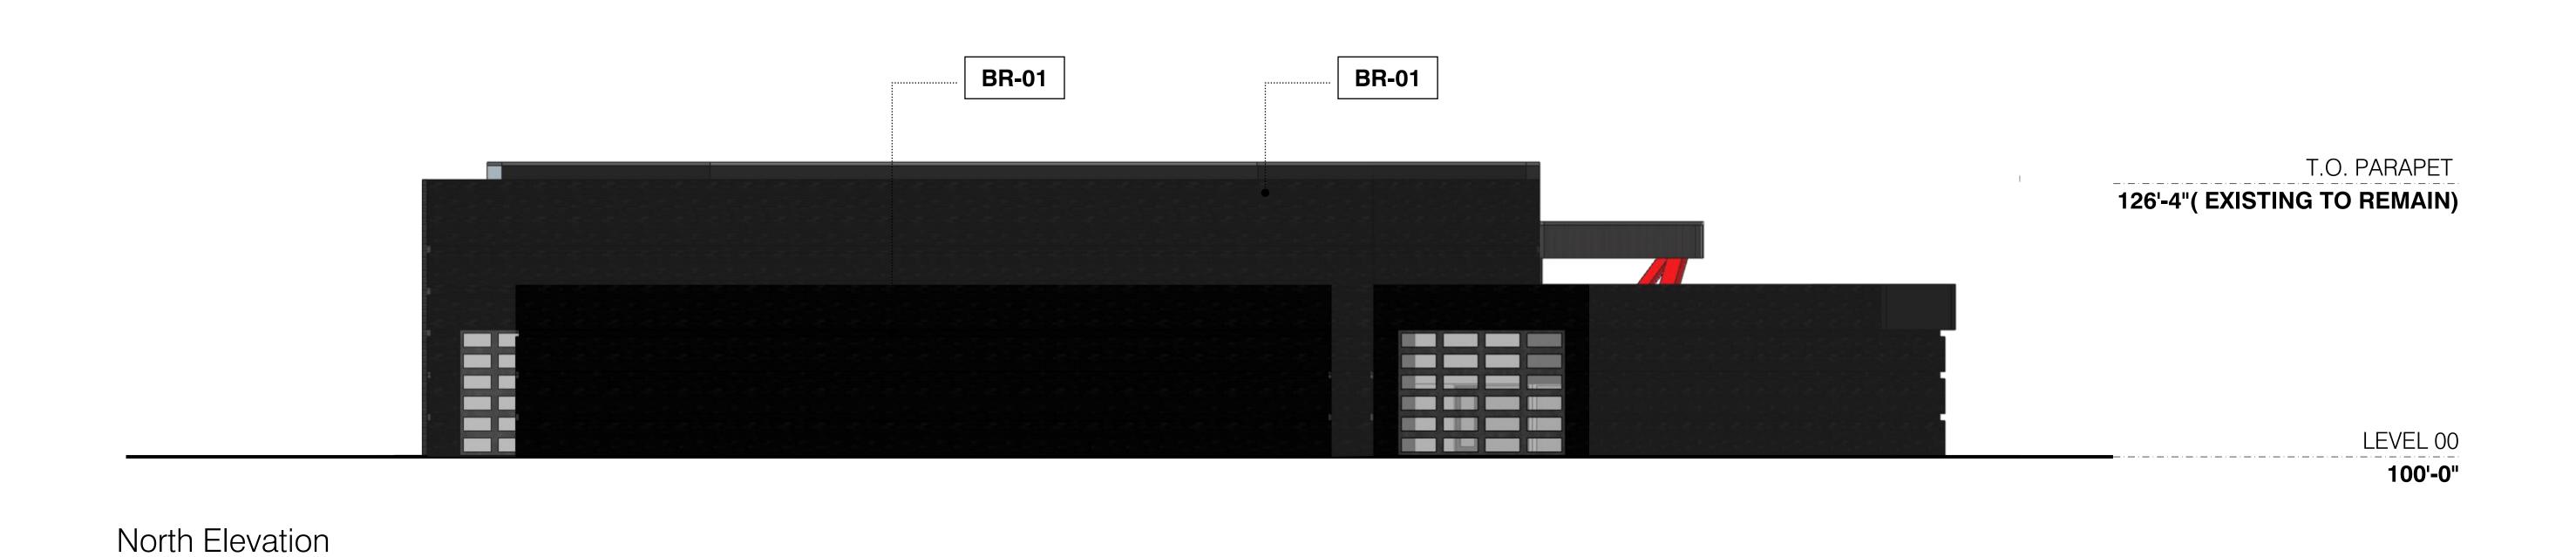SCOPE IS ONLY THE FACADE OF SHOWROOM AND FACADE OF RECEPTION. THE REST OF THE BUILDING TO REMAIN











SCALE: 1/8" = 1'-0"

SCOPE IS ONLY THE FACADE OF SHOWROOM AND FACADE OF RECEPTION. THE REST OF THE BUILDING TO REMAIN

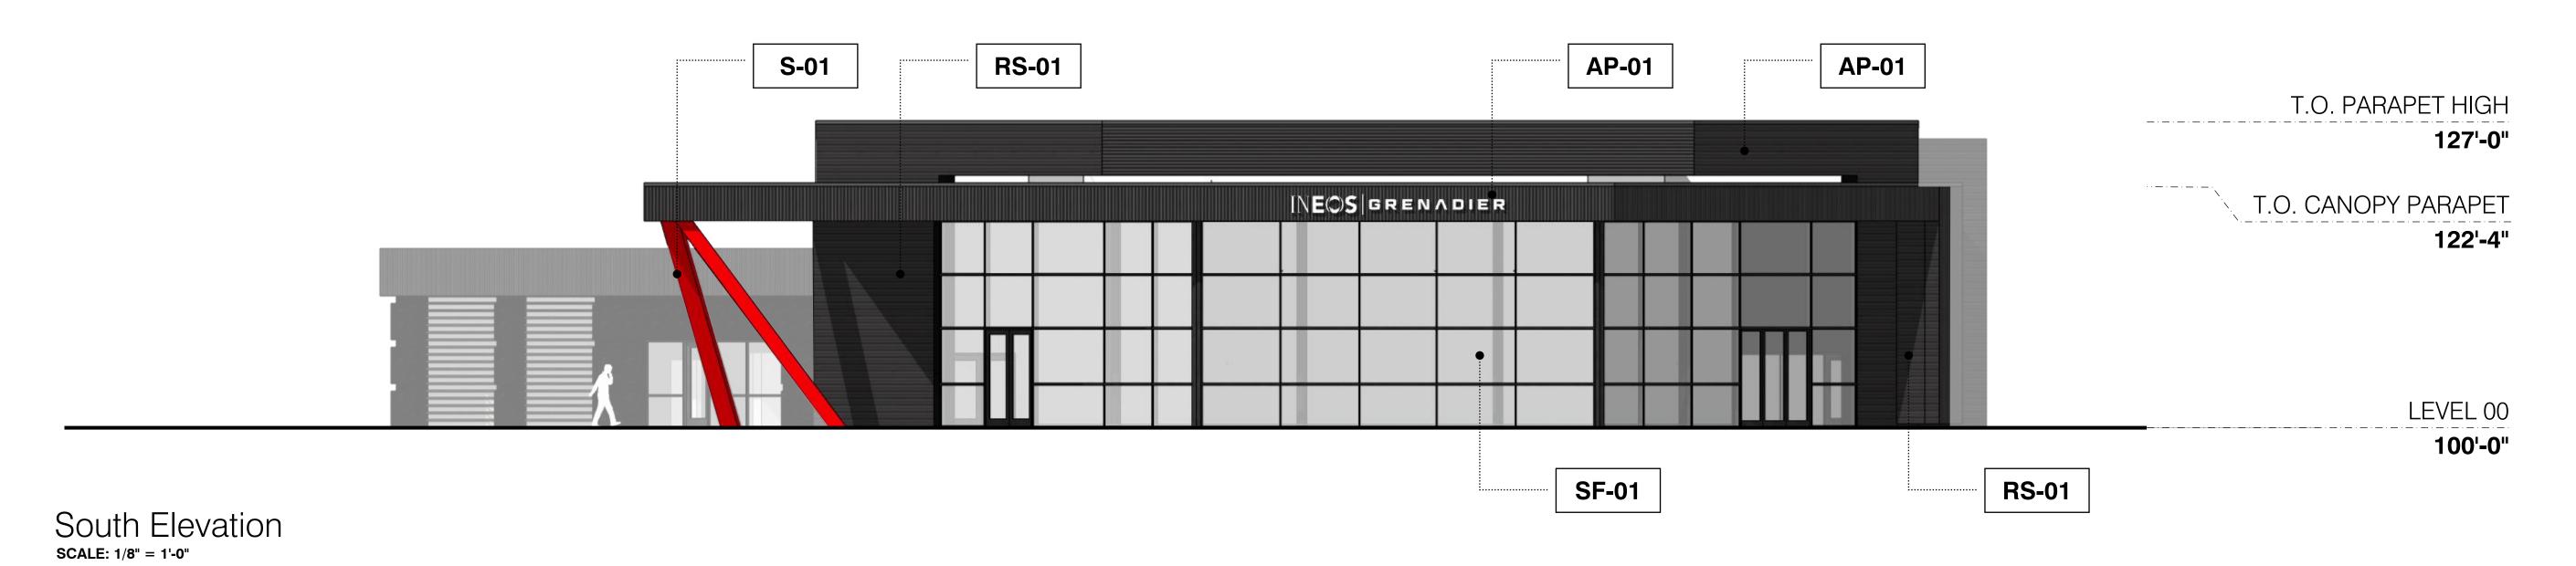

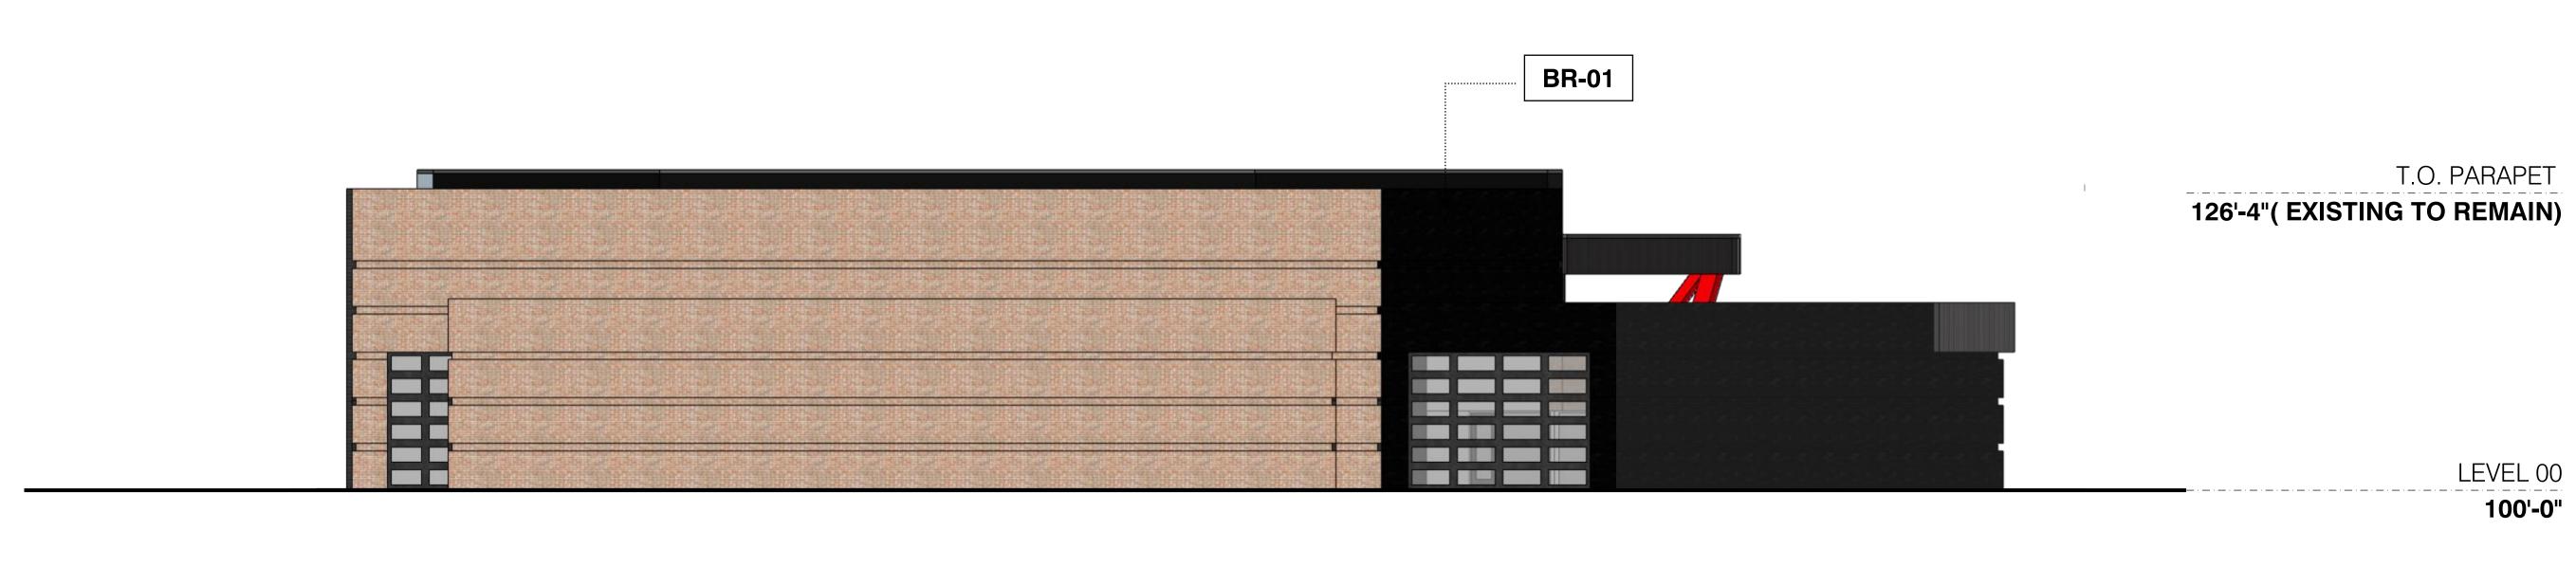


North Elevation SCALE: 1/8" = 1'-0"





NOTE:

SCOPE IS ONLY THE FACADE OF SHOWROOM AND FACADE OF RECEPTION. THE REST OF THE BUILDING TO REMAIN

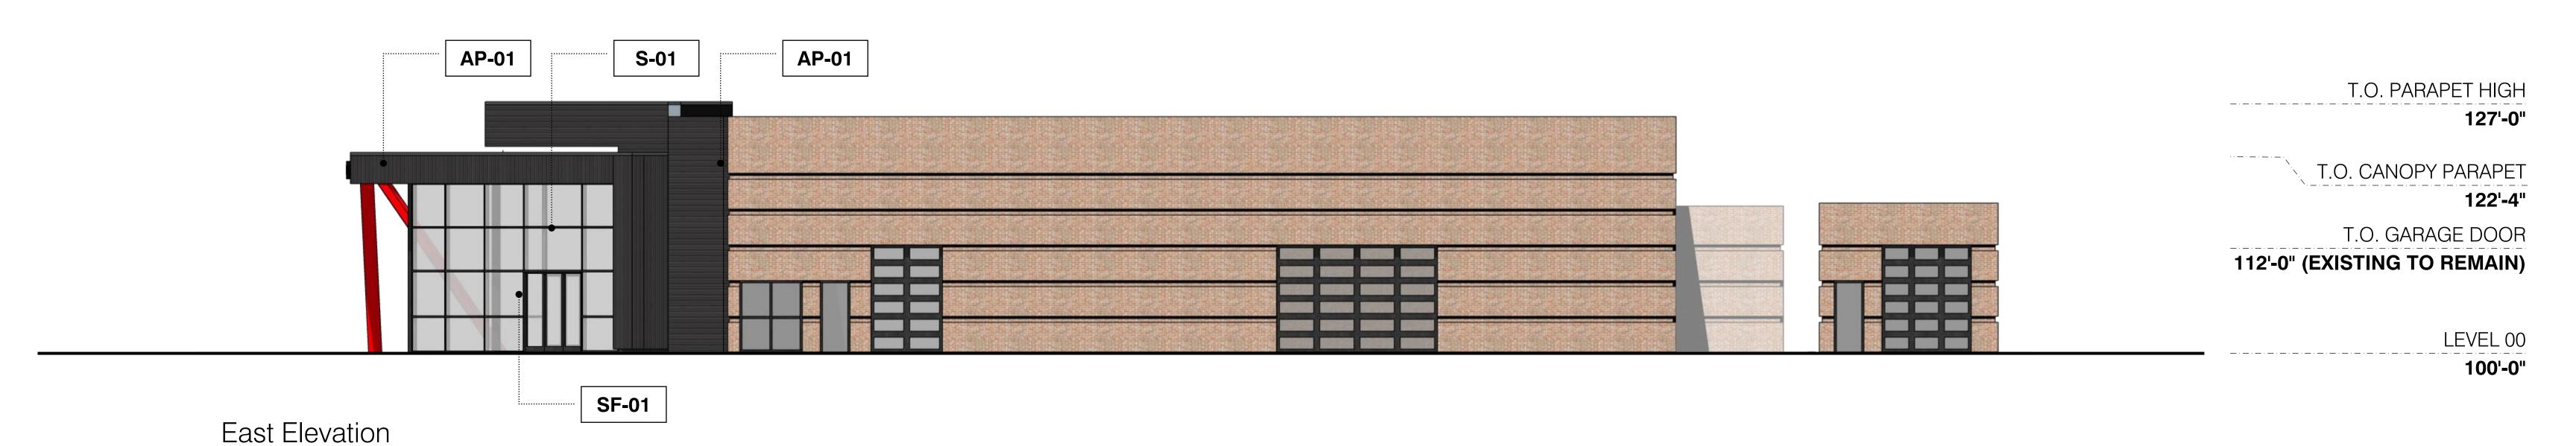







SCALE: 1/8" = 1'-0"





Material: Painted Structural steel TBD

Manufacturer:

Real Red (SW 6868) Color:




BR 01

Material: Manufacturer:

Existing Tricorn Black (SW 6258) Color:

Existing Brick

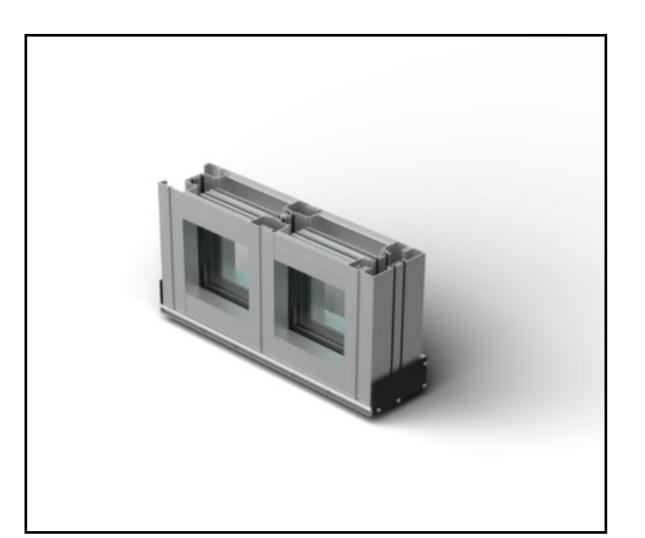

SF-01

Color:

Material: Trifab Versaglaze 451T Manufacturer: Kawneer

Black Frame




AP 01

Material: Horizontal Wall Panel Manufacturer: DMI

Color: Matte Black

Horizontally mounted on building Type:

Vertically mounted at canopy

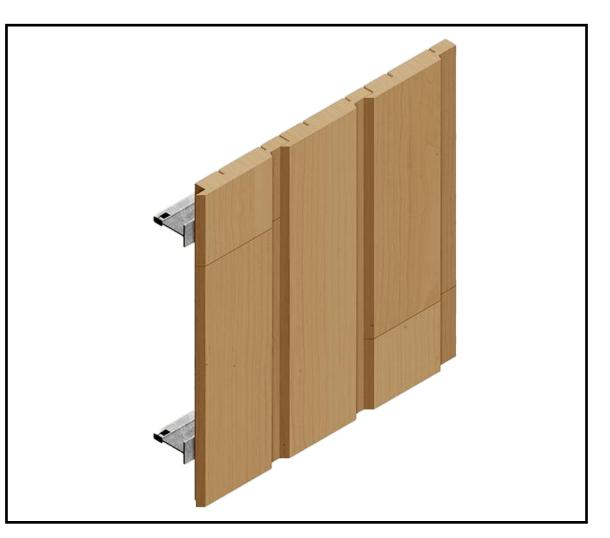

RS-01

Material: Wood like Rainscreen

Manufacturer: Trespa Style: Meteon


Elegant Oak Satin Color:



ACM-01

Material: Aluminum Composite Material

Manufacturer: Apolic BLX Black Color:

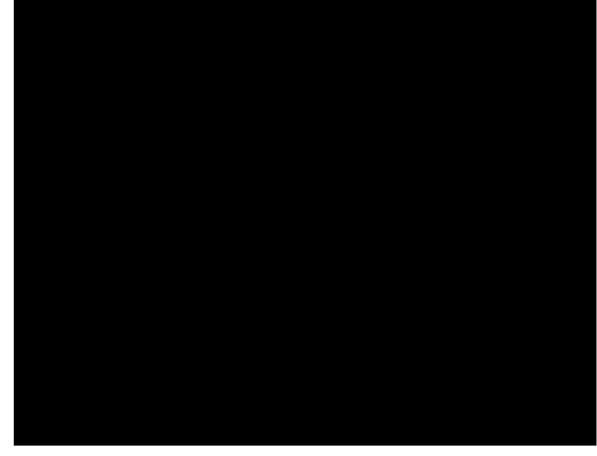





We have recently completed a project where we painted an existing building black, similar to the building we are proposing to paint in the submission.

Mercedes Benz of Easton Van center (ex Infinity of Easton) was previously a similar color material building. we painted key components tricorn black, and wrapped the rest in ACM. the set of photos to the right are the finished product, highlighted in blue.









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We would prep and paint existing brick, to insure proper adhesion to the product face, so paint wont chip or crack over time due to water penetration.

below is a closeup picture of the painted brick on the Mercedes Benz Van center showing finish quality.



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Horizontal Datum

The coordinates shown on this map are based on the Ohio State Plane Coordinate System, South Zone, NAD 83 (2011). Said coordinates are based upon positional solutions derived from RTK GNSS observations using the Ohio Department of Transportation's Ohio Real Time Network equipment and software at traverse control points numbered 200 and 201. The grid to ground combined scale factor (1.00002499118056) was applied at [the location of point number 200 (N 765406.922, E 1785298.738) (Fieldwork Completed 02/2025).

Vertical Datum

he elevations shown on this map are based on the North American Vertical Datum of 1988. Said elevations are based upon positional solutions derived from RTK GNSS observations using the Ohio Department of Transportation's Ohio Real Time Network equipment and software and the National Geodetic Survey's GEOID18 model at traverse control points numbered 200 and 201. Elevations from said traverse control points were then transferred by conventional leveling procedures to the permanent benchmarks listed hereon. (Fieldwork

Bench Mark	Elevation	Description
BM#1	919.73	Chiseled square on the northeast corner of a concrete light pole base, located on the south side of Perimeter Loop Road, being west 100 feet of the easterly entrance to Crown Ineos Grenadier of Dublin (6350 Perimeter Loop Drive)
BM#2	920.84	Chiseled "X" on the south flange bolt of a fire hydrant, located on the north side of Perimeter Loop Road, being the first fire hydrant (70 feet) west of the westerly entrance drive to Crown Inoes Grenadier of Dublin (6350 Perimeter Loop Road).
BM#3	920.45	Chiseled "X" on the south flange bolt of a fire hydrant, located on the north side of the building for Crown Ineos Grenadier of Dublin (6350 Perimeter Loop), being north of the parking lot 25 feet.

SITE DATA TABLE	
TOTAL SITE AREA	2.95 ACRES
TOTAL SITE AREA DISTURBED	0.20 ACRES
PRE-DEVELOPED IMPERVIOUS AREA	1.98 ACRES
POST-DEVELOPED IMPERVIOUS AREA	2.00 ACRES
DISTURBED AREA WITHIN R/W	0.00 ACRES
EXISTING LOT COVERAGE	67%
PROPOSED LOT COVERAGE	68%
EXISTING BUILDING LOT COVERAGE	14%
PROPOSED BUILDING LOT COVERAGE	14%
EXISTING/PROPOSED BUILDING HEIGHT	26'-4"
FLOOD INSURANCE RATE MAP NUMBER	39049C0132K
ZONE	X
EFFECTIVE DATE	06/17/2008
BASE FLOOD ELEVATION	916

RELATED PLANS		
FINAL DEVELOPMENT PLANNING NUMBER		
WATER SERVICE PLAN	N/A	
PUBLIC ROADWAY PLANS	N/A	
PUBLIC WATER PLAN	N/A	
PUBLIC SANITARY PLAN	N/A	
RELATED PERMITS		
OEPA FACILITY PERMIT NUMBER (NOI)	N/A	
SANITARY PTI	N/A	
WATER PTI	N/A	
SPECIAL FLOOD HAZARD AREA DEVELOPMENT PERMIT	N/A	


UTILITY NOTES

CONNECTIONS TO EXISTING PUBLIC INFRASTRUCTURE SHALL BE CORE DRILLED. CONNECTIONS TO EXISTING UTILITIES REQUIRE CITY OF DUBLIN INSPECTION.

PROPERTY BEARING AND DISTANCE IS BASED UPON DEED.

AMENDED FINAL DEVELOPMENT PLAN INEOS

6400 PERIMETER LOOP RD CITY OF DUBLIN, FRANKLIN COUNTY, OHIO 2025

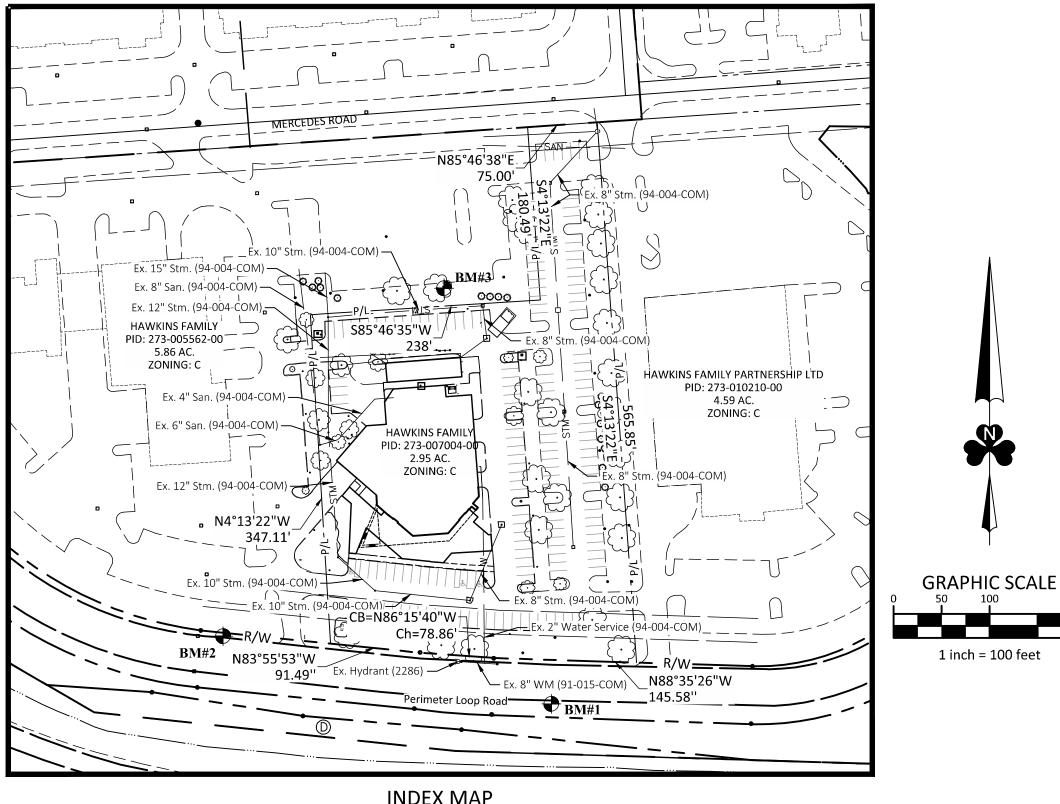

INDEX MAP SCALE: 1" = 100'

PROPERTY OWNER HAWKINS FAMILY PARTNERSHIP LTD 6001 34TH ST N ST. PETERSBURG, FL 33714

(614)799-4666

APPLICANT VINCE DESTEFANO ARCHALL ARCHITECTS 49 EAST 3RD AVENUE COLUMBUS, OH 43201 (614)469-7500

VDESTEFANO@ARCHALL.COM

ENGINEER MATTHEW STYPULA, PE EMH&T 5500 NEW ALBANY ROAD COLUMBUS, OH 43054 (614)775-4369

mstypula@emht.com


SURVEYOR JOSH KLEEMEYER, PS EMH&T 5500 NEW ALBANY ROAD COLUMBUS, OH 43054 (614)775-4124 jkleemeyer@emht.com

PROJECT DESCRIPTION

BUILDING RENOVATIONS AND MODIFICATION TO THE SHOWROOM. RECONSTRUCTION OF EXISTING PATIO AREA SOUTH OF THE SHOWROOM AND LANDSCAPE IMPROVEMENTS.

STANDARD CONSTRUCTION DRAWINGS SHALL BE IN THE FOLLOWING PRIORITY: CITY OF DUBLIN, CITY OF COLUMBUS, ODOT

STANDARD CONSTRUCTION DRAWINGS								
CITY OF DUBLIN		CITY OF COLUMBUS			ODOT			
RD-05								

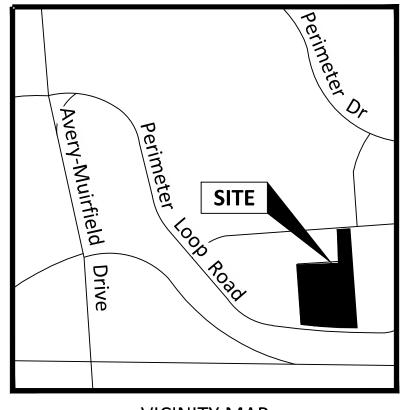

VICINITY MAP NOT TO SCALE

SHEET INDEX				
SHEET NUMBER SHEET NAME		SHEET NAME		
1	C1.0	TITLE SHEET		
2	C2.0	EXISTING CONDITIONS		
3	C3.0	DEMOLITION PLAN		
4	C4.0	STAKING PLAN		
5	C5.0	UTILITY PLAN		
6	C6.0	GRADING PLAN		
7	T1.0	TREE SURVEY		
8	L1.0	LANDSCAPE PLAN		

SIGNATURES BELOW SIGNIFY ONLY CONCURRENCE WITH THE GENERAL PURPOSES AND GENERAL LOCATION OF THE PROJECT AND DOES NOT CONSTITUTE ASSURANCE TO OPERATE AS INTENDED. ALL TECHNICAL DETAILS REMAIN THE RESPONSIBILITY OF THE PROFESSIONAL CIVIL ENGINEER PREPARING THE PLANS.

OWNER	DATE
ADDUCANT	
APPLICANT	DATE
PLANNING AND ZONING COMMISSION SECRETARY	DATE

DATE OF COMMISSION APPROVAL

THIS IS TO CERTIFY THAT GOOD ENGINEERING PRACTICES HAVE BEEN UTILIZED IN THE DESIGN OF THIS PROJECT AND THAT ALL OF THE MINIMUM STANDARDS AS SET FORTH BY THE CITY OF DUBLIN, INCLUDING THOSE STANDARDS GREATER THAN MINIMUM WHERE, IN MY OPINION, THEY ARE NEEDED TO PROTECT THE SAFETY OF THE PUBLIC.




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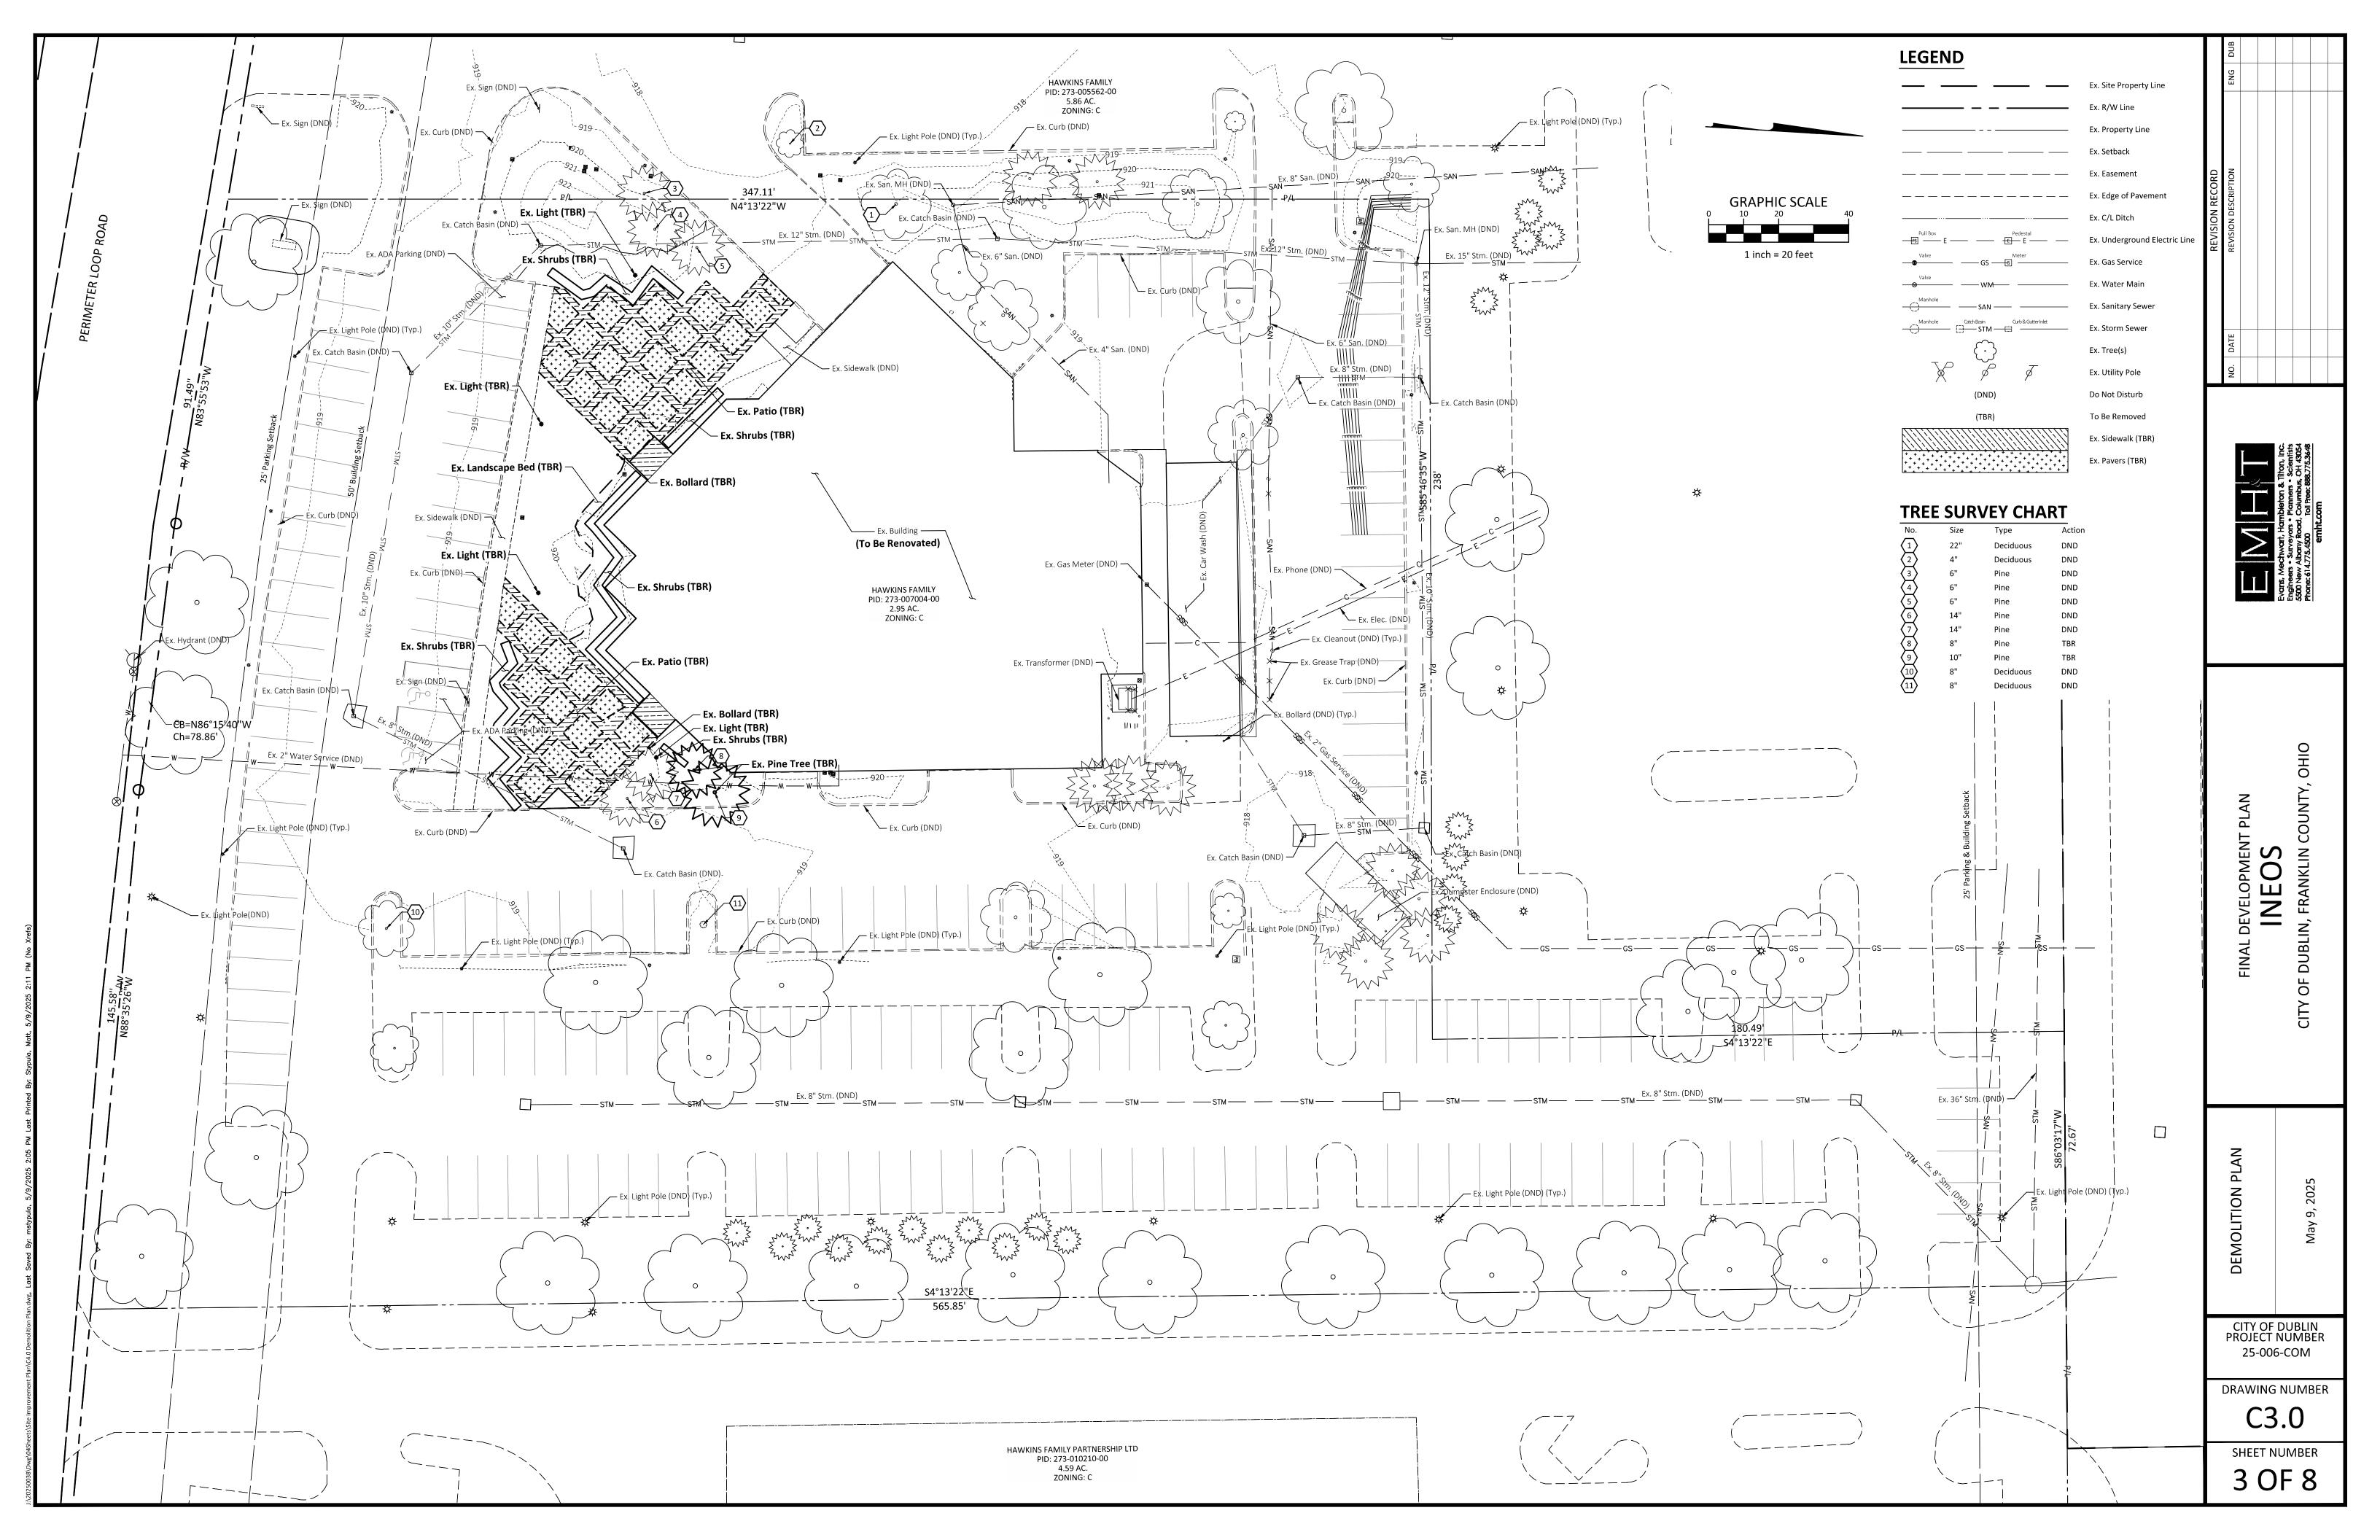
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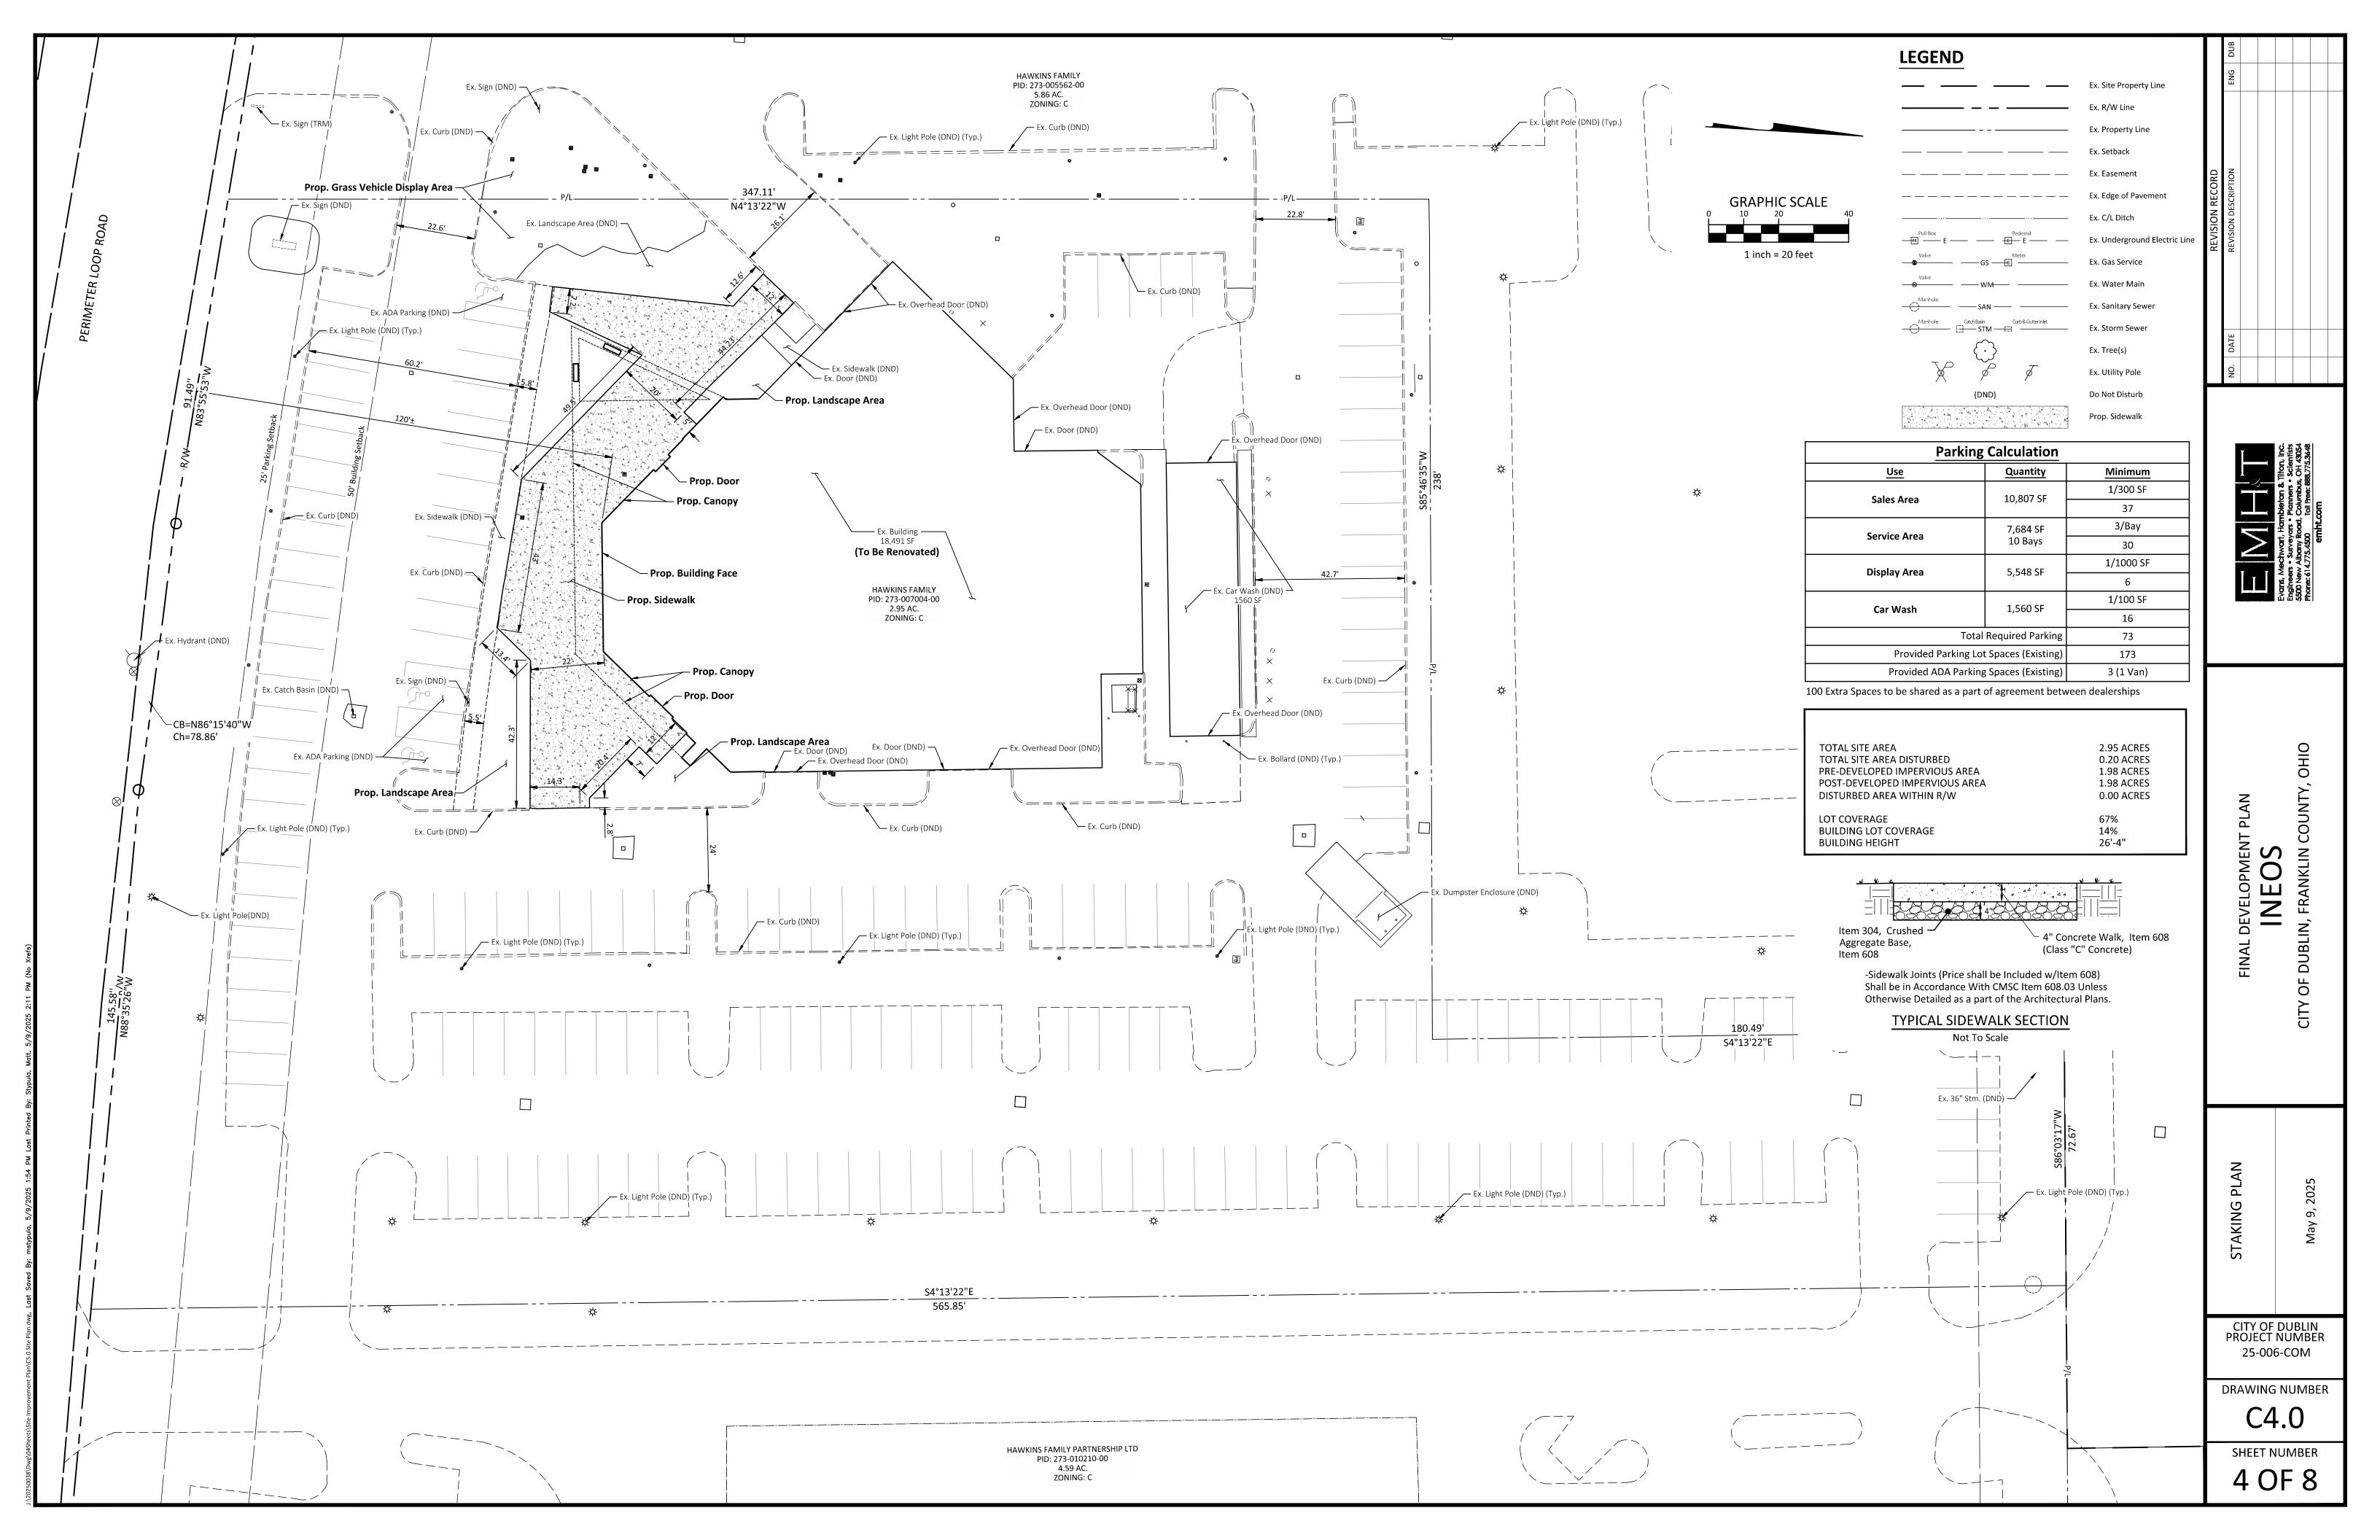
> SHEET NUMBER 1 OF 8


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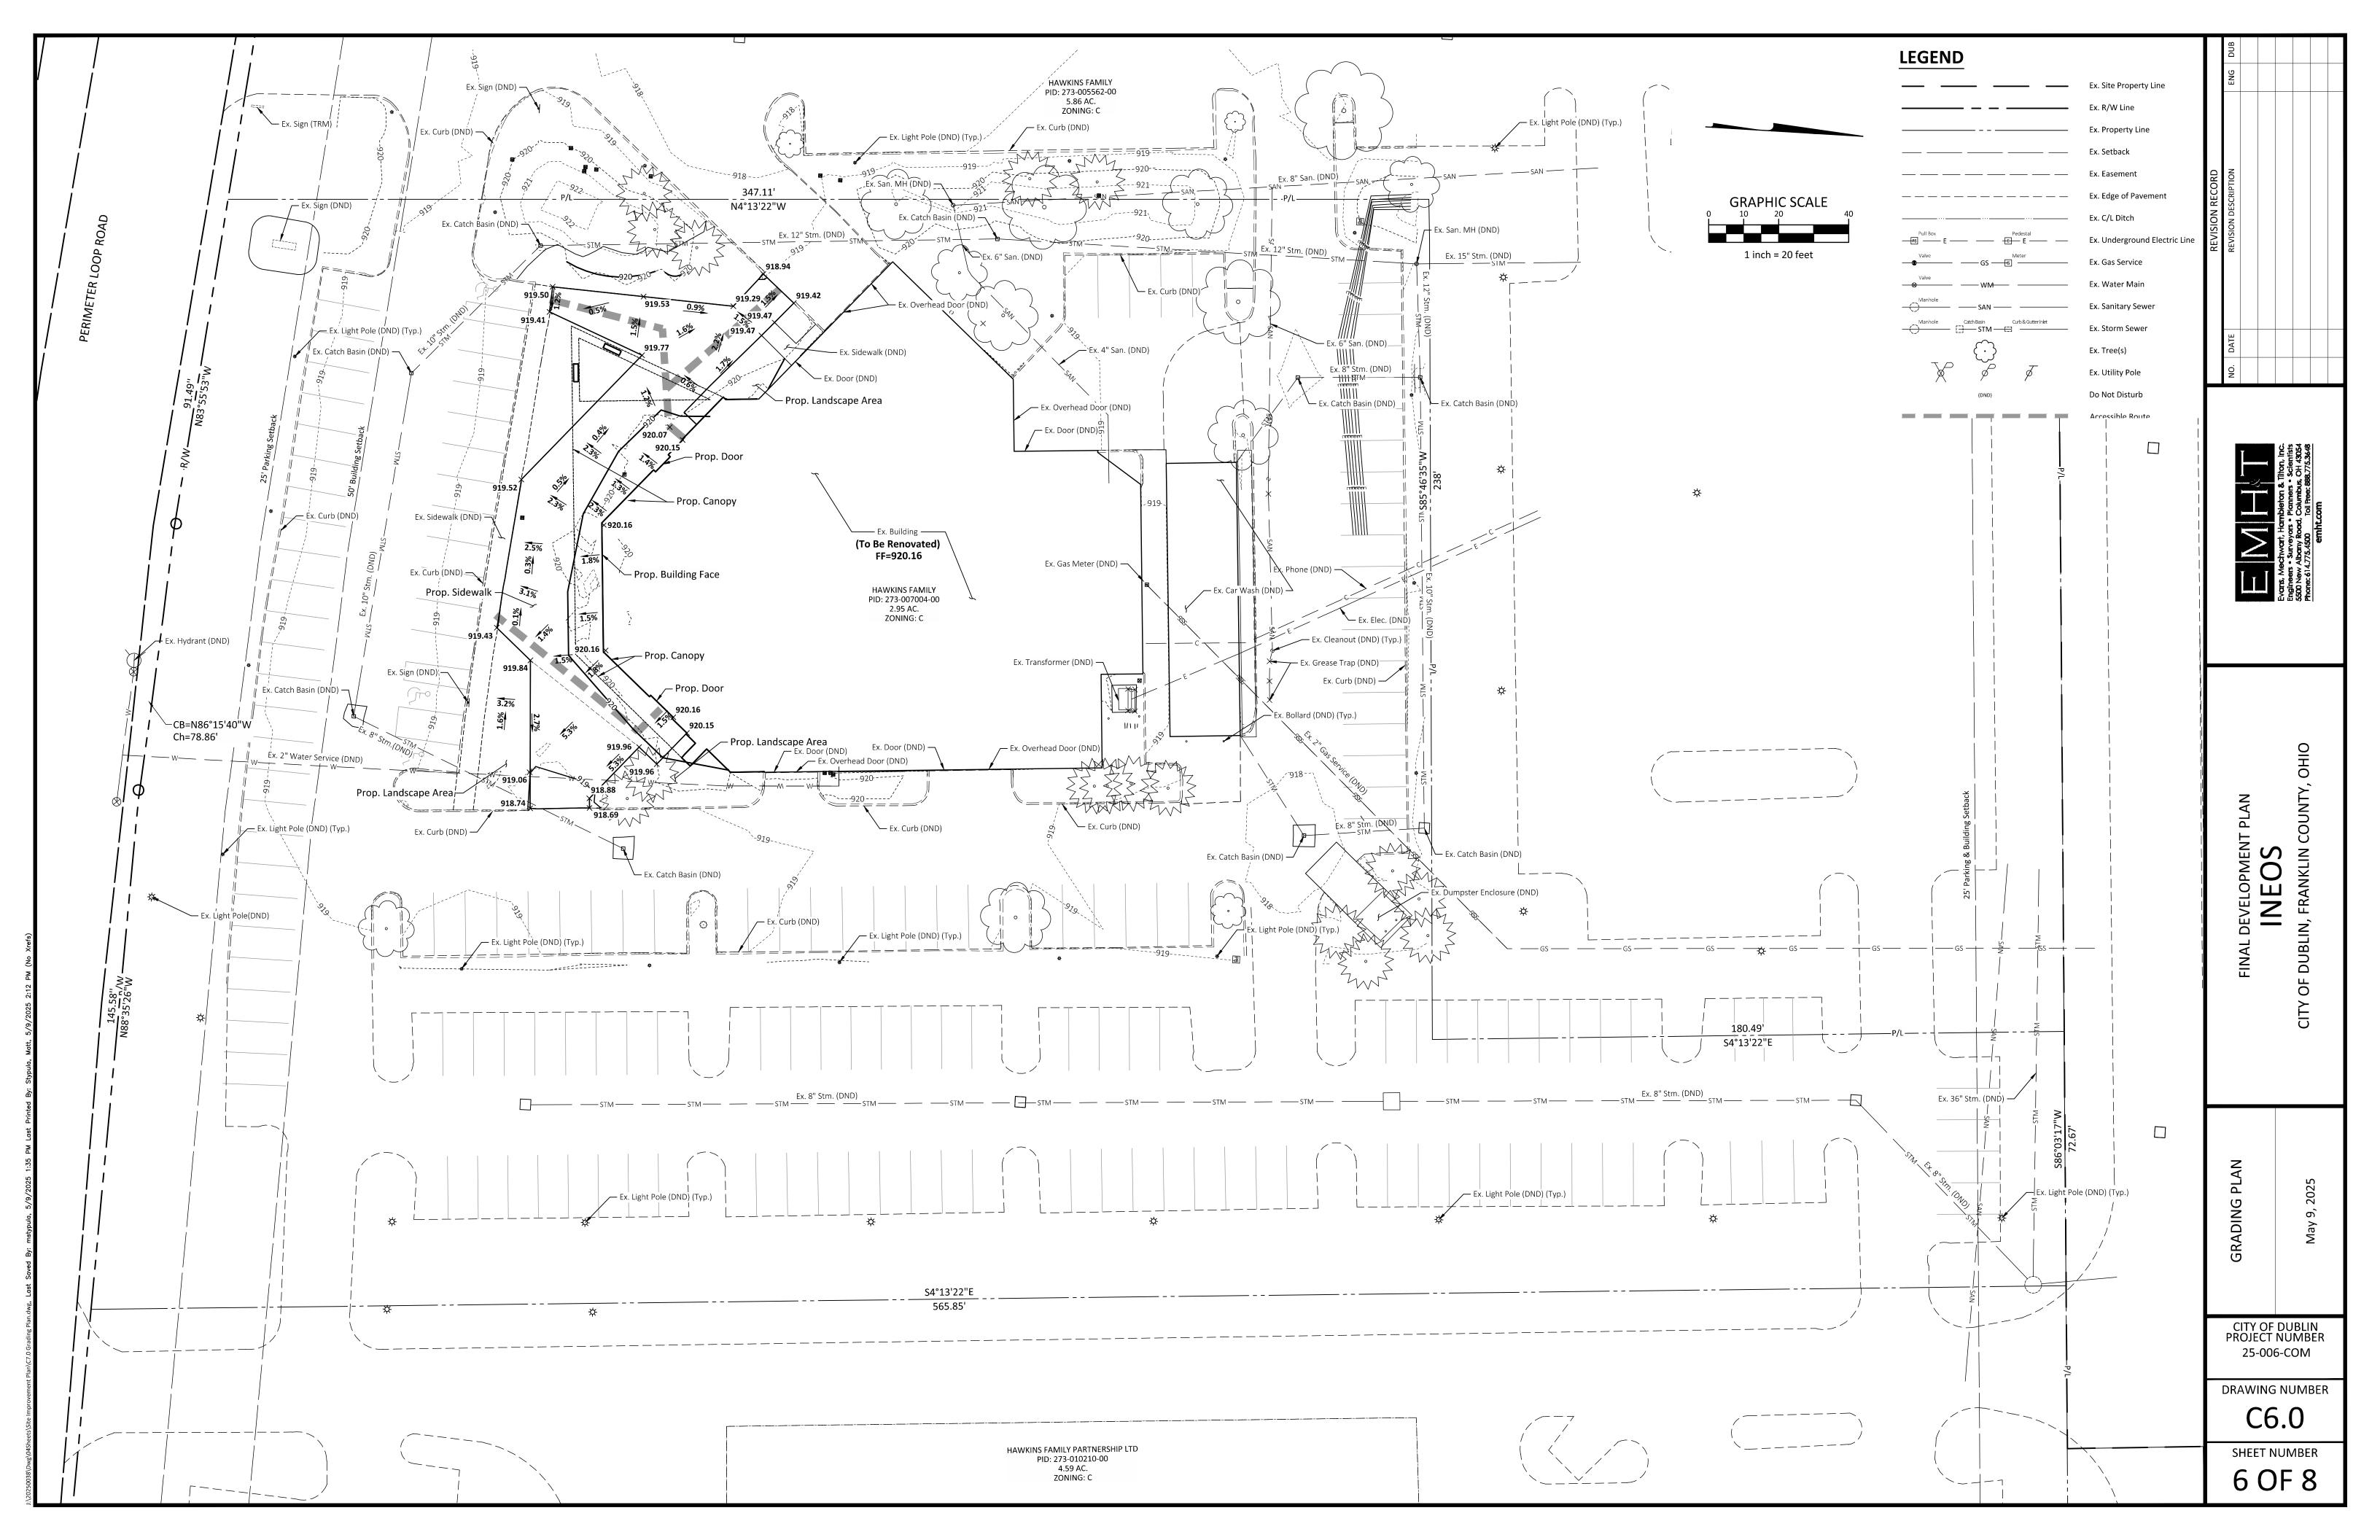










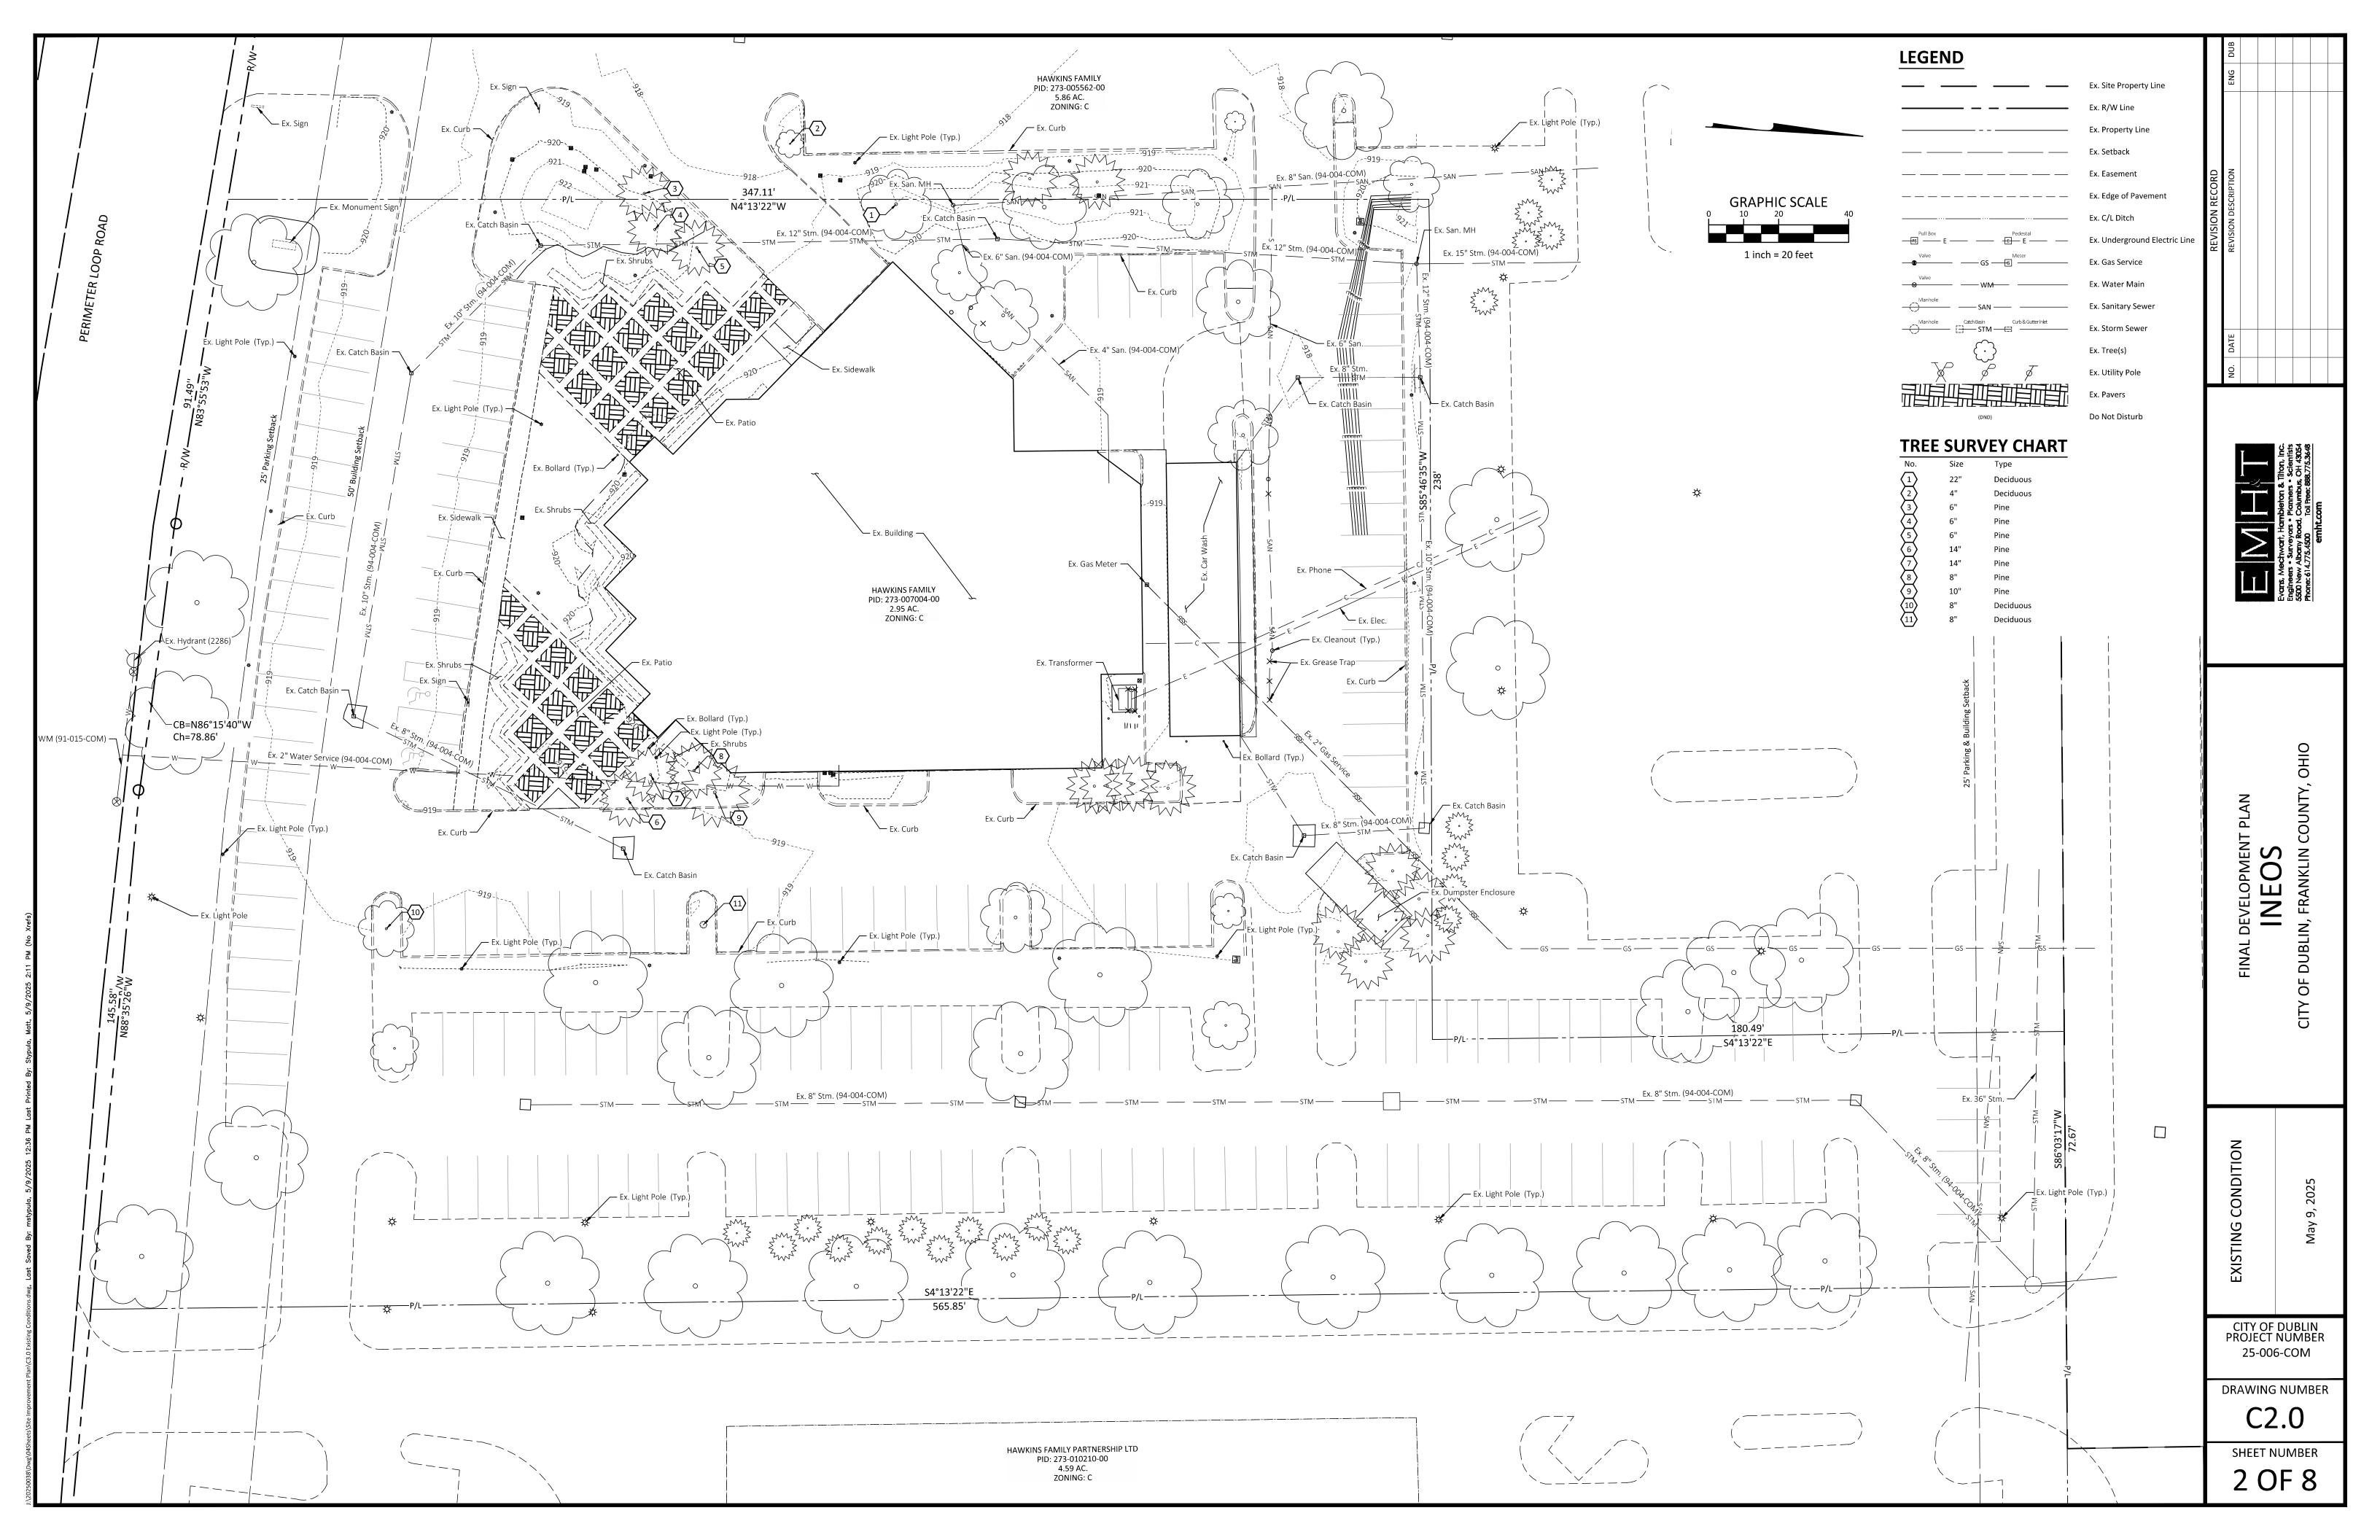

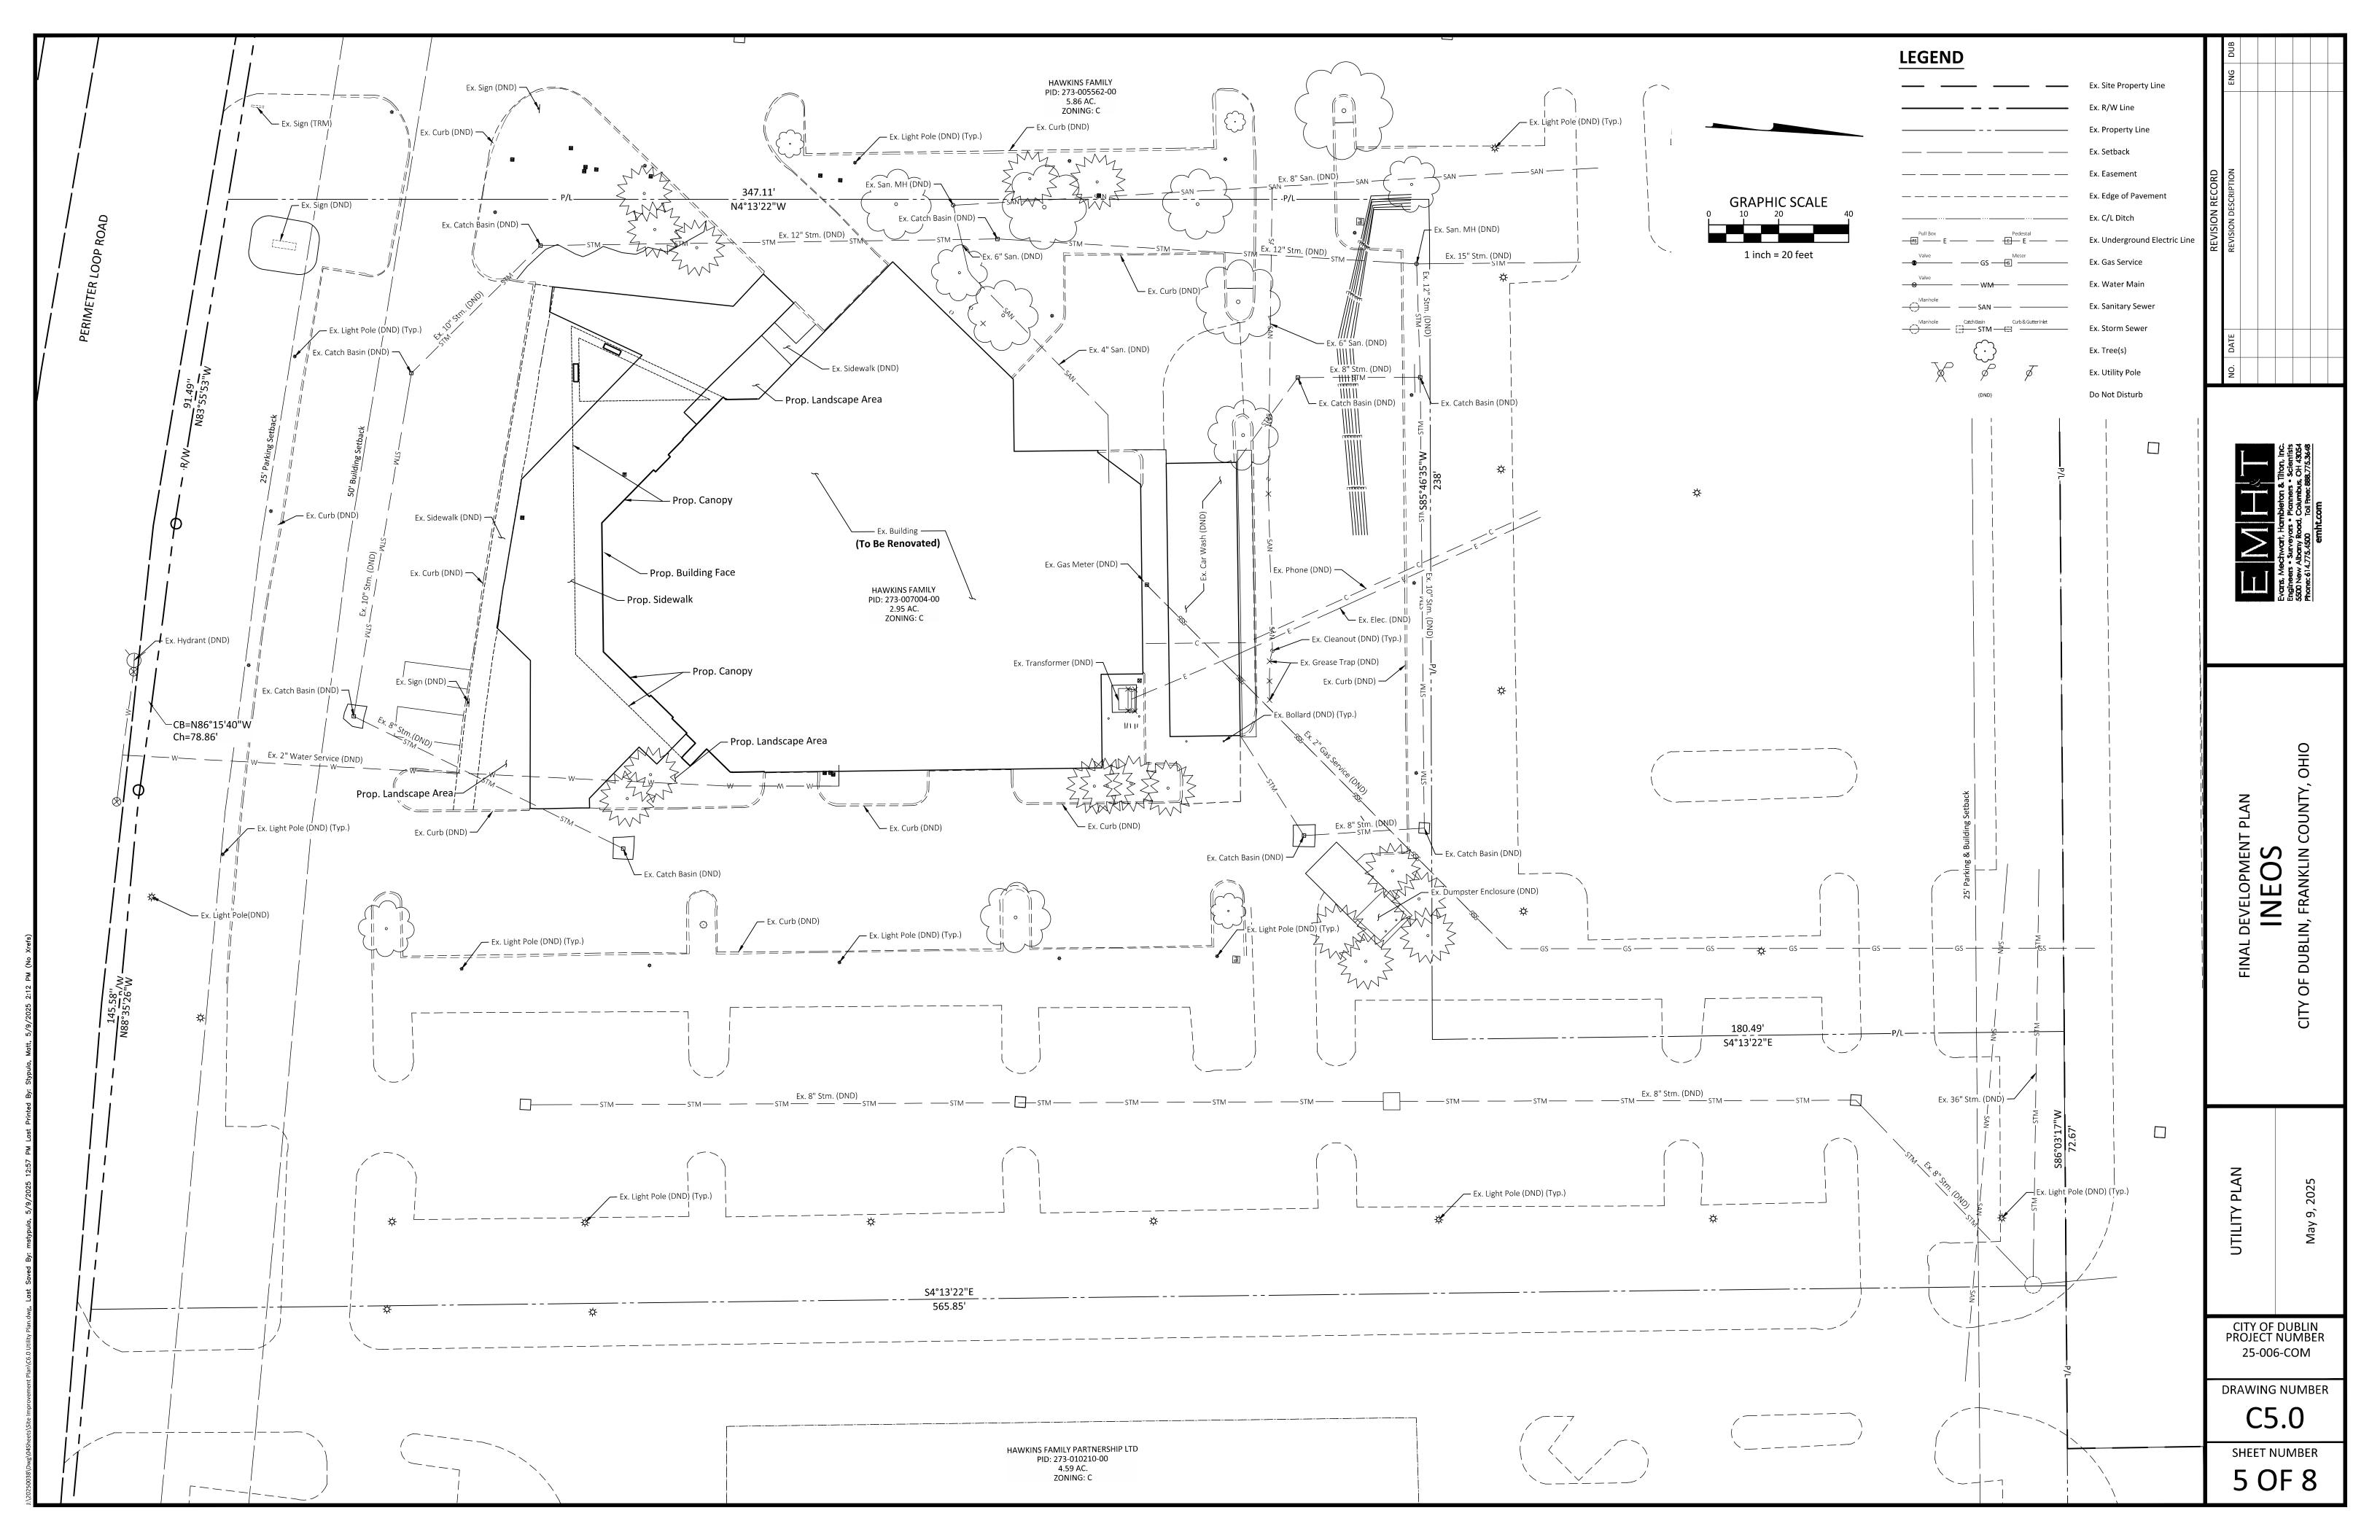

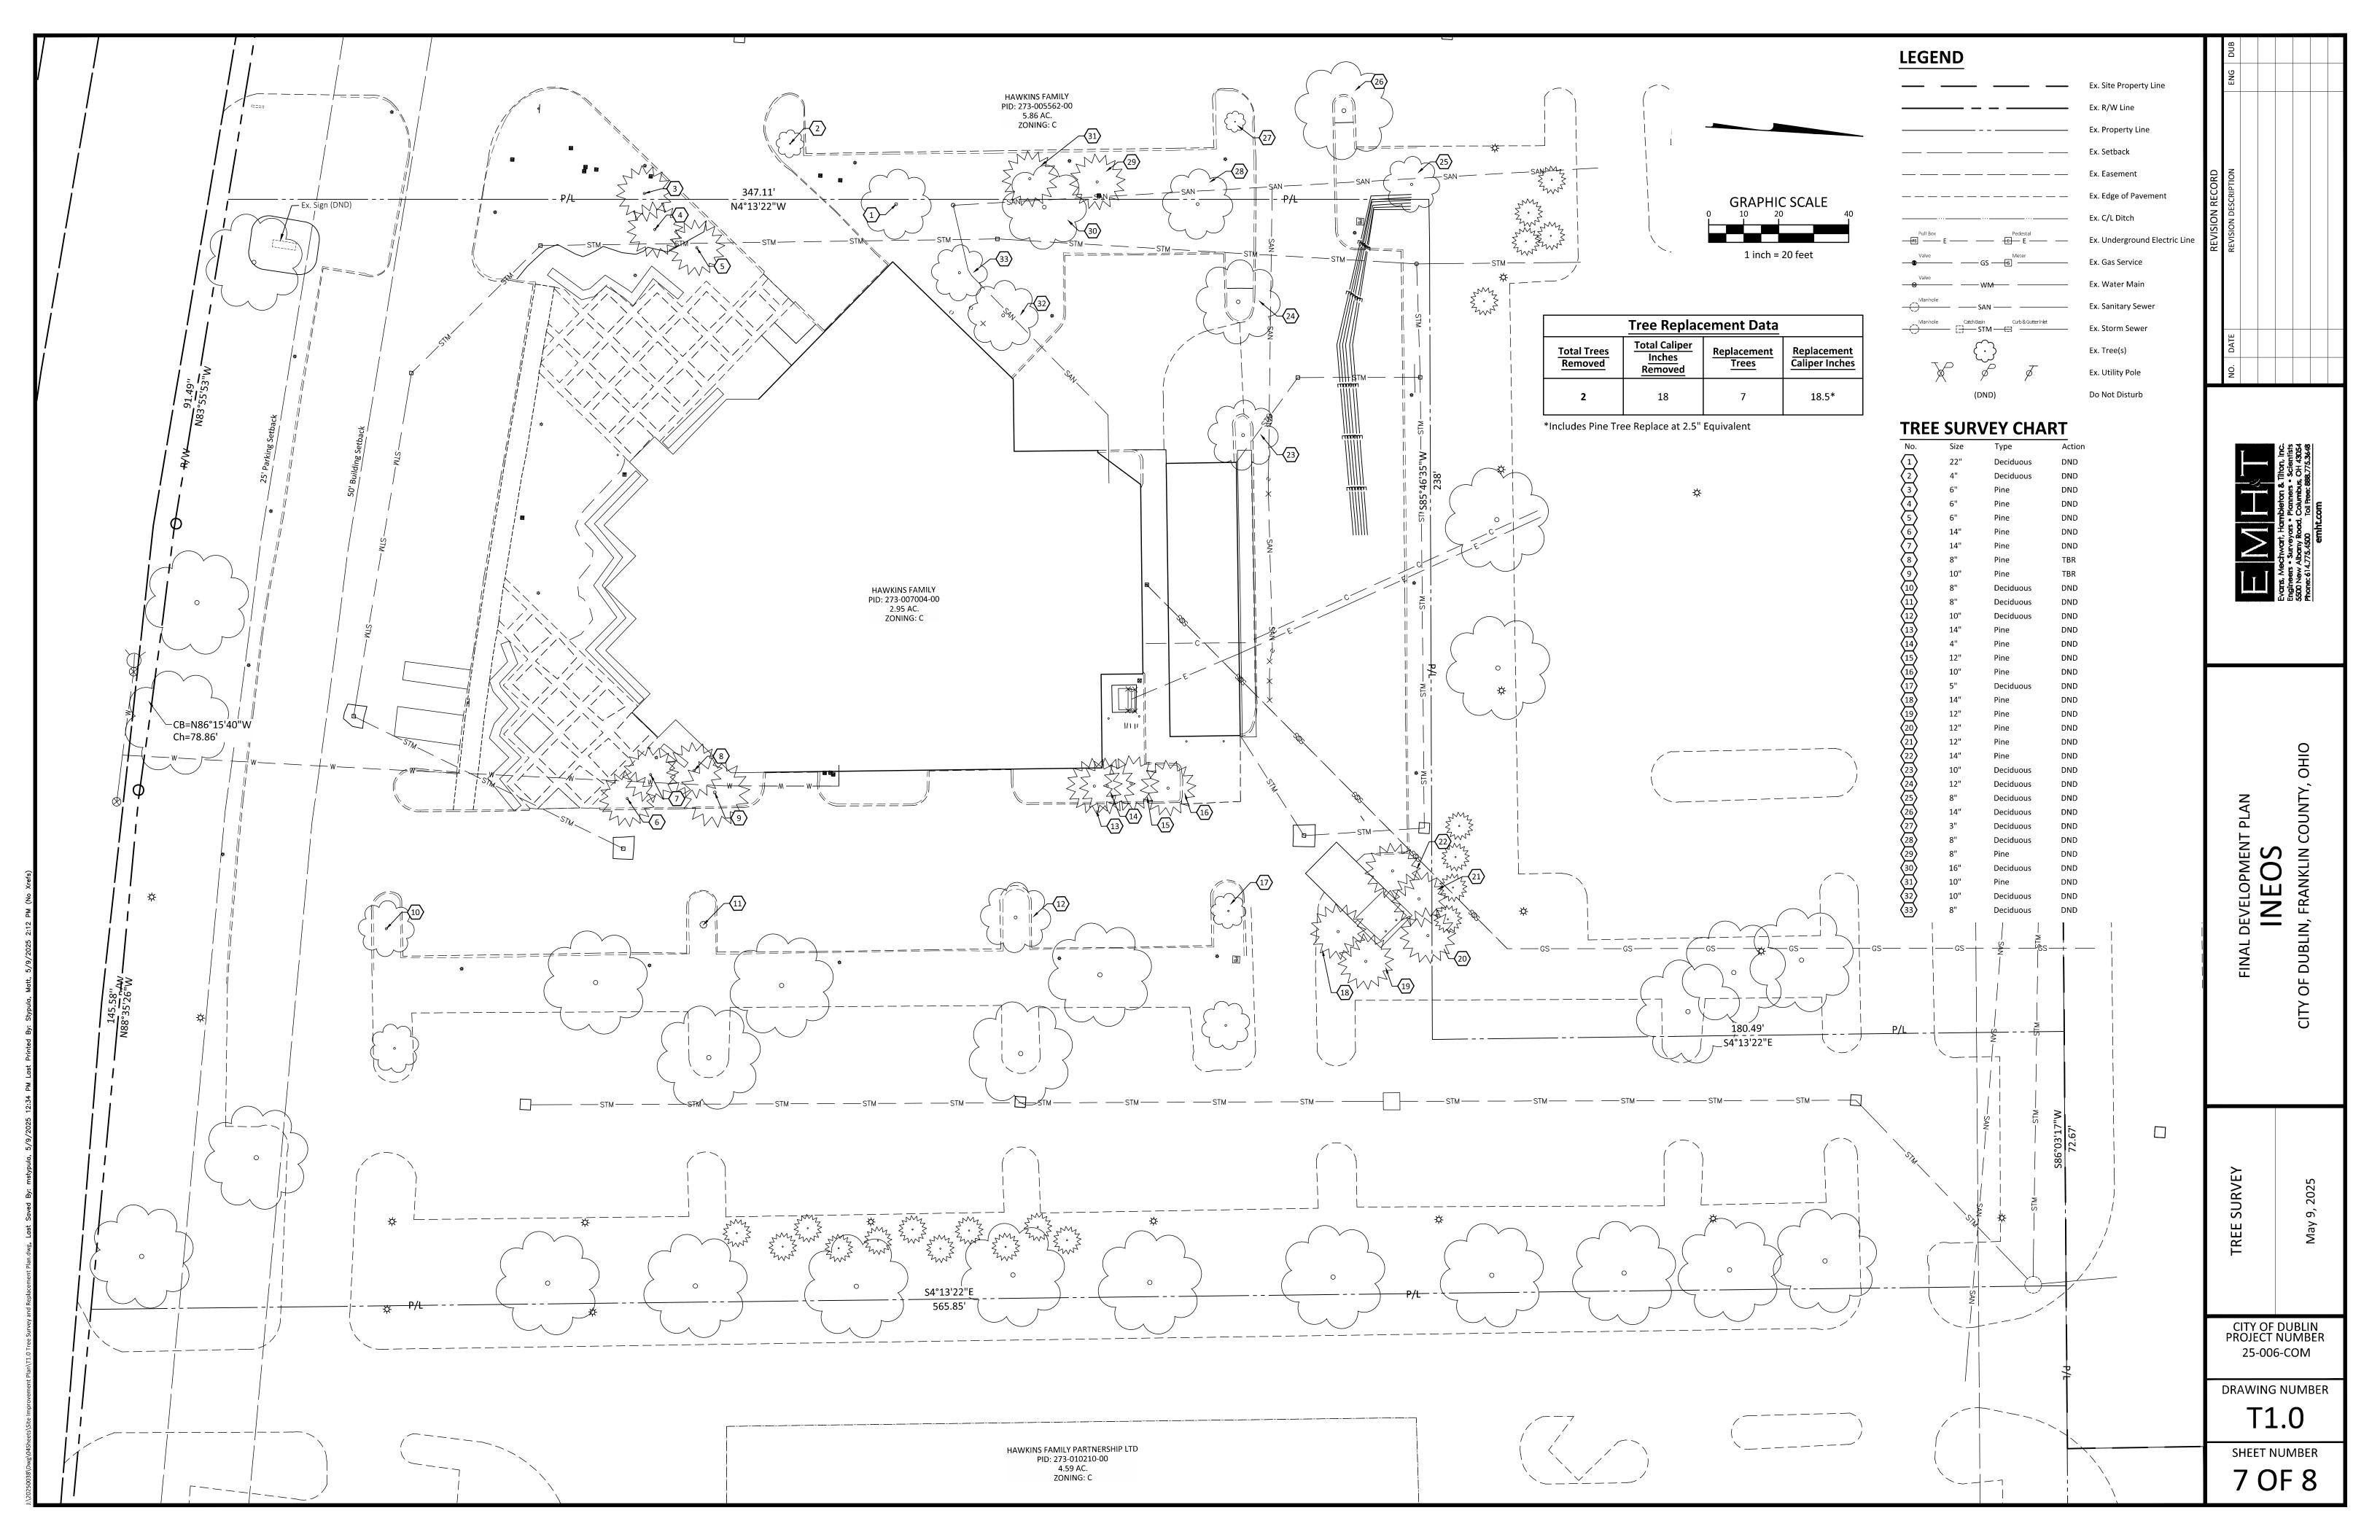

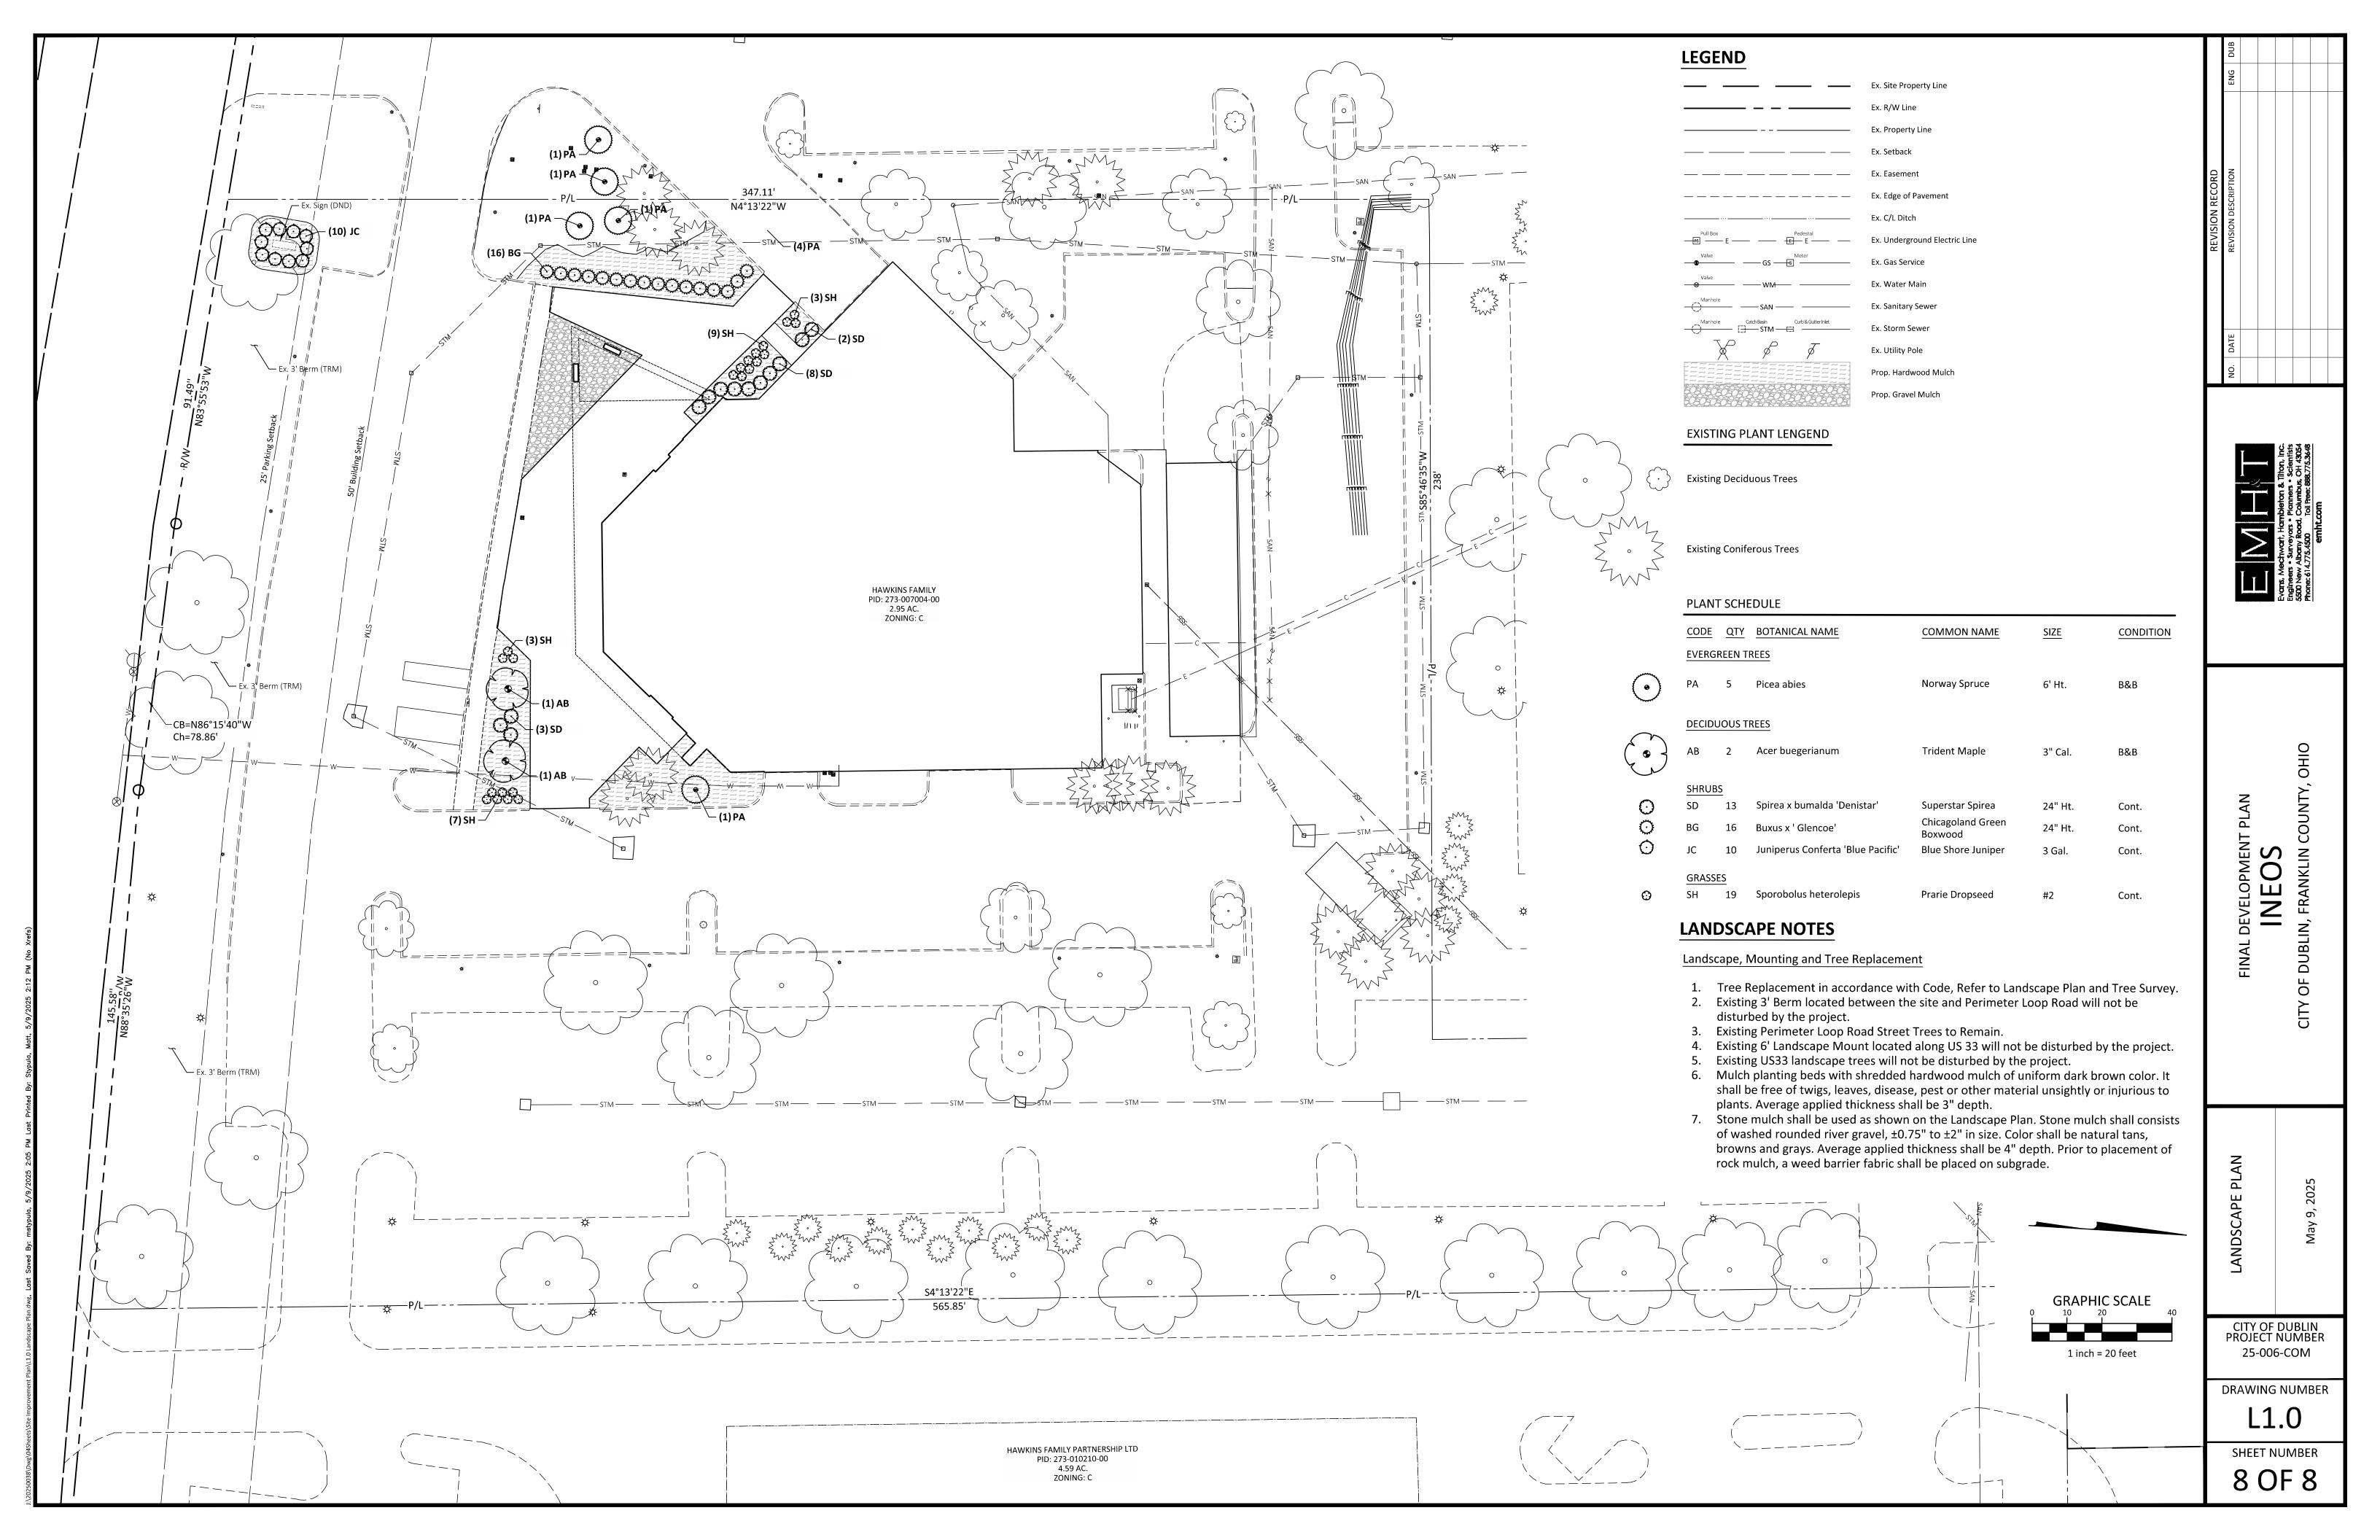




Note: Total Square footage on canopy canopy is 30 SQFT 20'-0" "INEOS" Script "GRENADIER" Script_

> 18" white acrylic face with Black anodized aluminum returns. Extents to be centered on canopy, internally illuminated to provide soft glow inside lettering.

12" white acrylic face with Black anodized aluminum returns. extents to be centered on "INEOS" Script, internally illuminated to provide soft glow inside lettering.

Daytime Render Scale: NTS

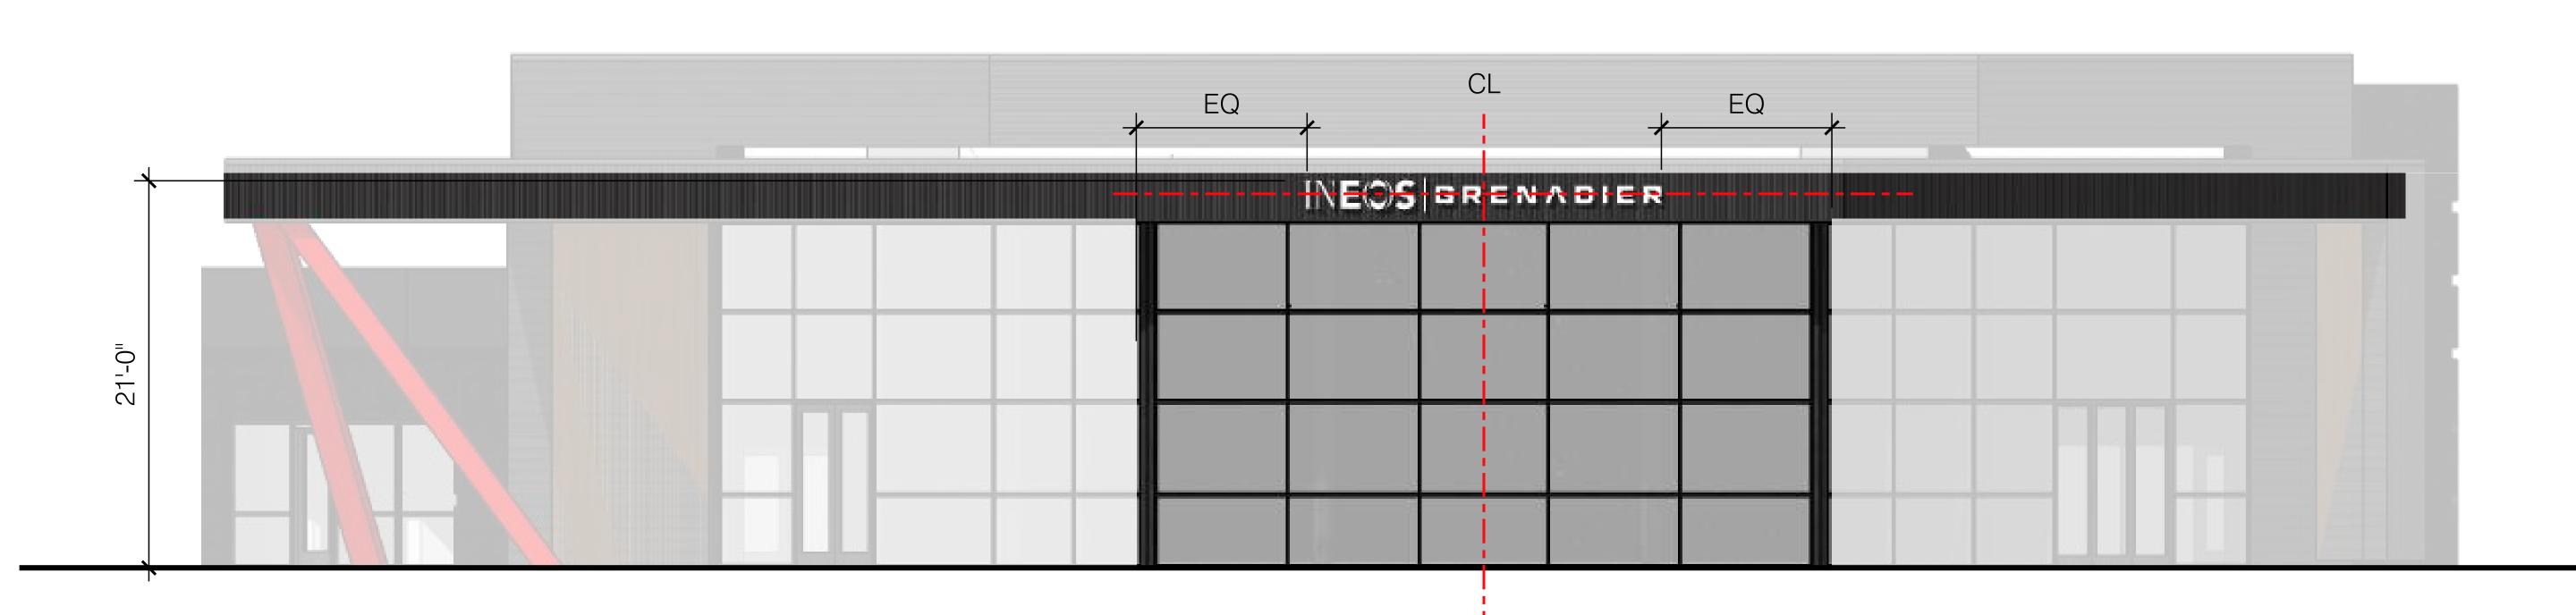





Note:
Total Square footage on canopy canopy is 30 SQFT

20'-0"

20'-0"


"INEOS" Script

"GRENADIER" Script

18" white acrylic face with Black anodized aluminum returns. Extents to be centered on canopy, internally illuminated to provide soft glow inside lettering.

12" white acrylic face with Black anodized aluminum returns. extents to be centered on "INEOS" Script, internally illuminated to provide soft glow inside lettering.

Nighttime Render Scale: NTS

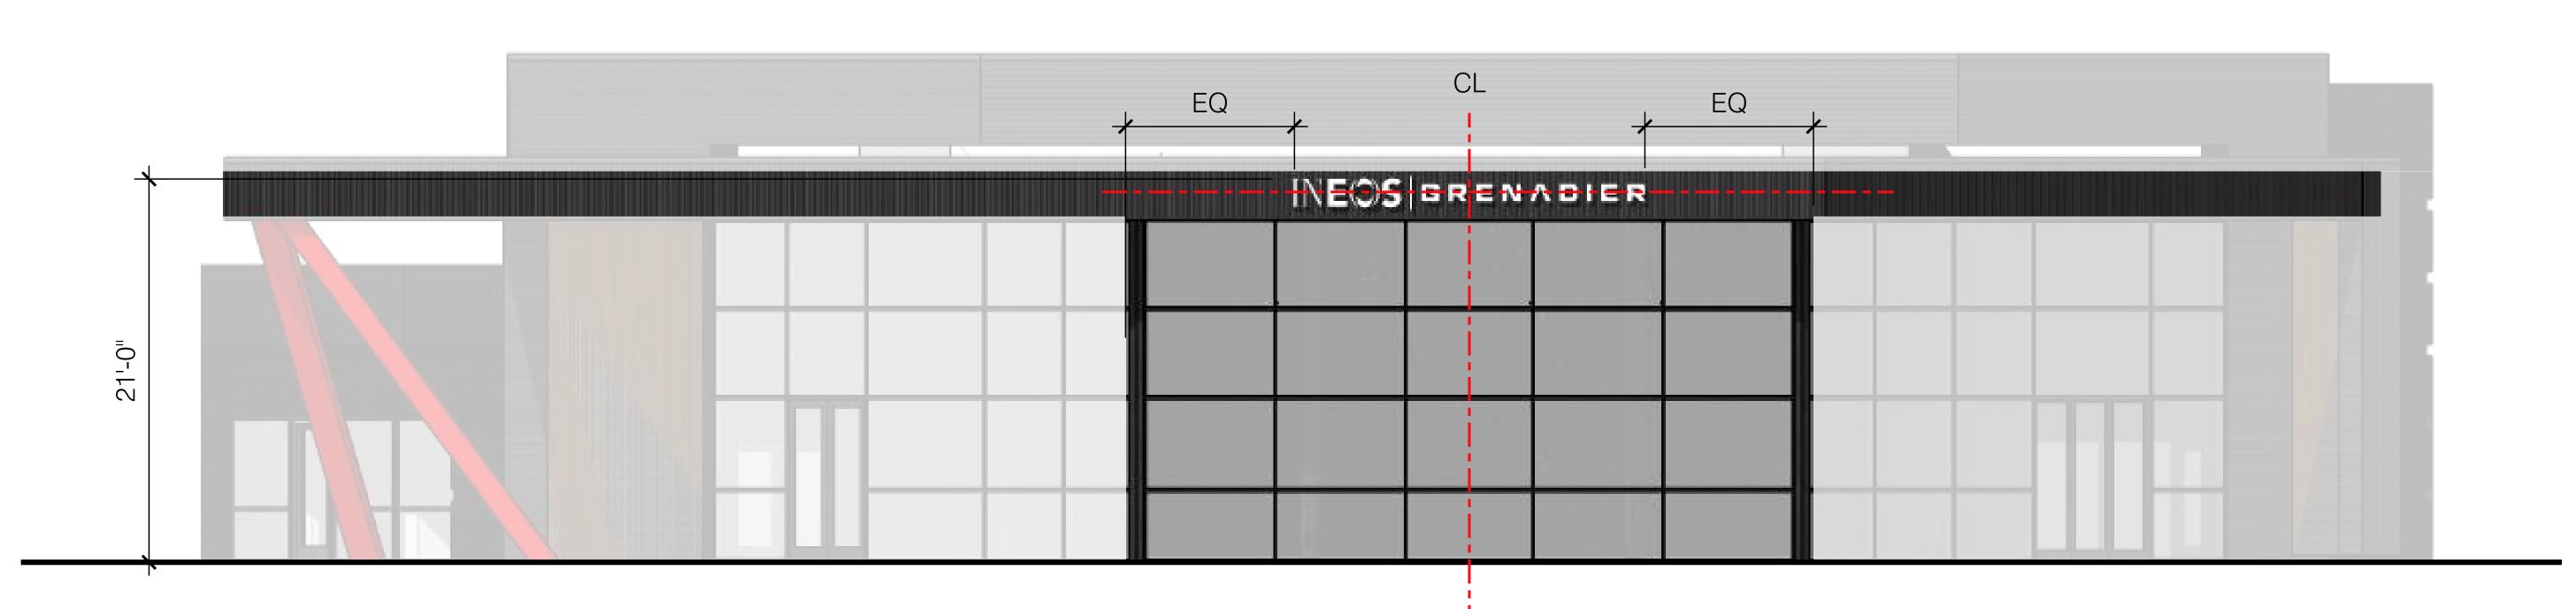



The photos on the right are examples of other INEOS projects that have been completed around the U.S with a similar color palette as the one we are proposing.



KO INEOS - Framingham, Massachusetts



Price Family INEOS - San Rafael, California



Sewell INEOS - San Antonio, Texas



