


(27) 7/8" COAX CABLES

COMMSCOPE-NHH-65C-R2B

(3 TOTAL, 1 PER SECTOR)

(3 TOTAL, 1 PER SECTOR)

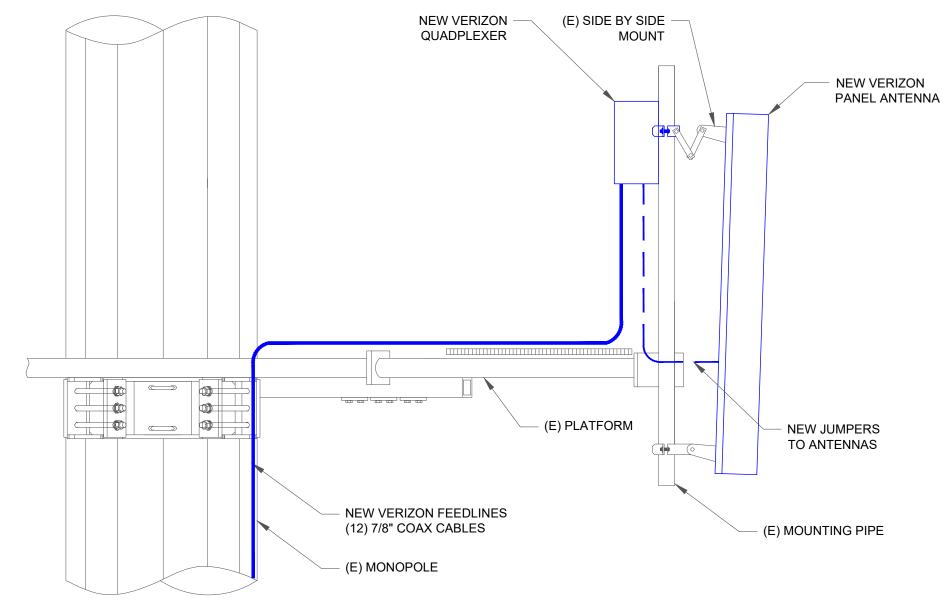

PROPOSED OVP/RRH/ANTENNA DETAIL SCALE: NOT TO SCALE

EXISTING ANTENNA LAYOUT


SCALE: NOT TO SCALE

SEQUENCE OF OPERATION:

- REMOVE (3) NOKIA UHFA B25 RRH 4x30, (3) NOKIA UHIE B66A RRH 4x45, (3) NOKIA - UHBA B13 RRH 4x30 RRHs, AND (6) JMA - QBC-67-C-A-P-2SF TWIN QUADPLEXERS FROM SHELTER.
- REMOVE (3) COMMSCOPE NHH-65C-R2B ANTENNAS FROM POSITION 2L (1
- REMOVE (12) 1-5/8" COAX AND REPLACE WITH (27) NEW 7/8" COAX.
- REMOVE (6) COMMSCOPE TMA-T-19-A-V TMAs, (6) COMMSCOPE -TMAT21X-11AV TMAs, AND (6) JMA - TBC-67C-A-P-2SF TWIN TRIPLEXERS FROM TOWER
- INSTALL (3) COMMSCOPE NHHS4-65C-R3B ANTENNAS IN POSITION 2L ON EXISTING SIDE BY SIDE ANTENNA MOUNT VERTICALLY CENTERED ON THE PLATFORM.
- INSTALL (6) COMMSCOPE SQX6192342T-43 TWIN QUADPLEXERS ON TOWER TOP AND (6) COMMSCOPE - SQX6192342T-43 TWIN QUADPLEXERS WITHIN
- INSTALL (3) SAMSUNG B2/B66A RRH ORAN (RF4439d-25A), (3) SAMSUNG -B5/B13 RRH ORAN (RF4440d-13A), (3) SAMSUNG - RT8808-77A RRHs AND (1) RAYCAP - RVZDC-4520-RM-48 OVP IN SHELTER
- 8. RETURN ALL REMOVED EQUIPMENT TO VERIZON WIRELESS.

CONTRUCTION ENGINEER: DUSTIN MCDANIEL EMAIL: DUSTIN.MCDANIEL@VERIZONWIRELESS.COM

VICINITY MAP

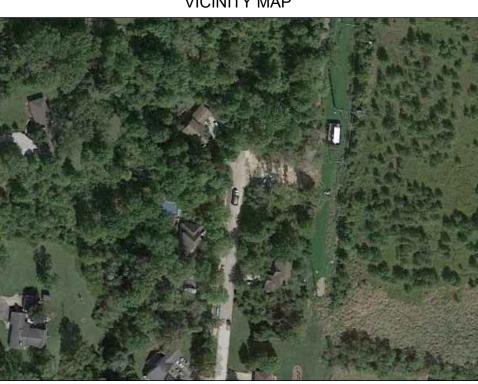

NOTES:

- 1. THIS DRAWING IS FOR EXHIBIT PURPOSES ONLY
- PLEASE REFER TO STRUCTURAL REPORT PROVIDED BY OTHERS FOR CONFIRMATION OF ADEQUATE STRUCTURE CAPACITY.
- NO LINE OR ANTENNA WORK TO BEGIN PRIOR TO CONFIRMATION OF ADEQUATE TOWER AND MOUNT CAPACITY USING THE FINAL CONFIGURATION.
- ALL EXISTING & PROPOSED INFORMATION PROVIDED BY LL AND VERIZON WIRELESS.
- NO NEW AC POWER CIRCUITS REQUIRED FOR THE SCOPE OF THIS PROJECT. POWER SCOPE OF WORK IS LIMITED TO -48VDC ONLY.
- ALL NEW OVPS MUST BE INSTALLED ON A MOUNT, NOT DIRECTLY ON THE TOWER LEG.
- 7. ALL ANTENNA MOUNTING PIPES NEED TO BE 2-7/8" x96" O.D. HEAVY DUTY GALVANIZED.

ANTENNA REPLACEMENT NOTES:

- 1. CONTRACTOR TO INSPECT THE CONDITION OF EXISTING MOUNTING PIPES. CONFIRM THE FOLLOWING:
 - CORROSION: IF MOUNTS ARE FOUND TO BE CORRODED CONTACT VERIZON REP. FOR DIRECTION.
 - CHECK CONDITION OF ATTACHMENT BOLTS. IF FOUND LOOSE, TIGHTEN TO ORIGINAL SPECIFICATIONS (ALSO, TURN OF THE NUT METHOD).
 - IF BOLTS ARE MISSING, REPLACE TO SUITE. CONFIRM MOUNTING PIPE IS ADEQUATELY SIZED TO ACCOMMODATE PROPOSED ANTENNA INSTALL
- 2. ALL WORK DEPICTED ON THIS DRAWING DESIGNED IN ACCORDANCE WITH 2024 OBC AND AMENDMENTS.

ACCESS DRIVE COORDINATES: N 40° 8' 13.4592" / 40.137072 W 83° 5' 42.2088" / -83.095058 (FROM GOOGLE EARTH)




LATITUDE: 40° 8' 13.4592" N / 40.137072

LONGITUDE: 83° 5' 42.2088" W



GPD GROUP 520 South Main Street, Suite 2531 Akron, OH 44311 330.572.2100 Fax 330.572.2101 Copyright; Glaus, Pyle, Schomer, Burns & DeHaven, Inc. 2025

DESCRIPTION UPDATED FOR PERMIT USUED FOR PERMIT UPDATED PER CLIENT COMMENTS ISSUED FOR CONSTRUCTION ISSUED FOR CONSTRUCTION REVISED PER CLIENT O7/24/2025 REVISED PER CLIENT O8/04/2025		ВУ	ROL	CJW	CJW	CJW	CJW	CJW		
DESCRIPTION ISSUED FOR PERMIT UPDATED PER CLIENT COMMENTS ISSUED FOR CONSTRUCTION ISSUED FOR CONSTRUCTION REVISED PER CLIENT REVISED PER CLIENT		DATE	04/22/2022	06/02/2022	07/12/2022	08/15/2022	07/24/2025	08/04/2025		
	REVISIONS	DESCRIPTION	ISSUED FOR PERMIT	UPDATED PER CLIENT COMMENTS	ISSUED FOR CONSTRUCTION	ISSUED FOR CONSTRUCTION	REVISED PER CLIENT	REVISED PER CLIENT		

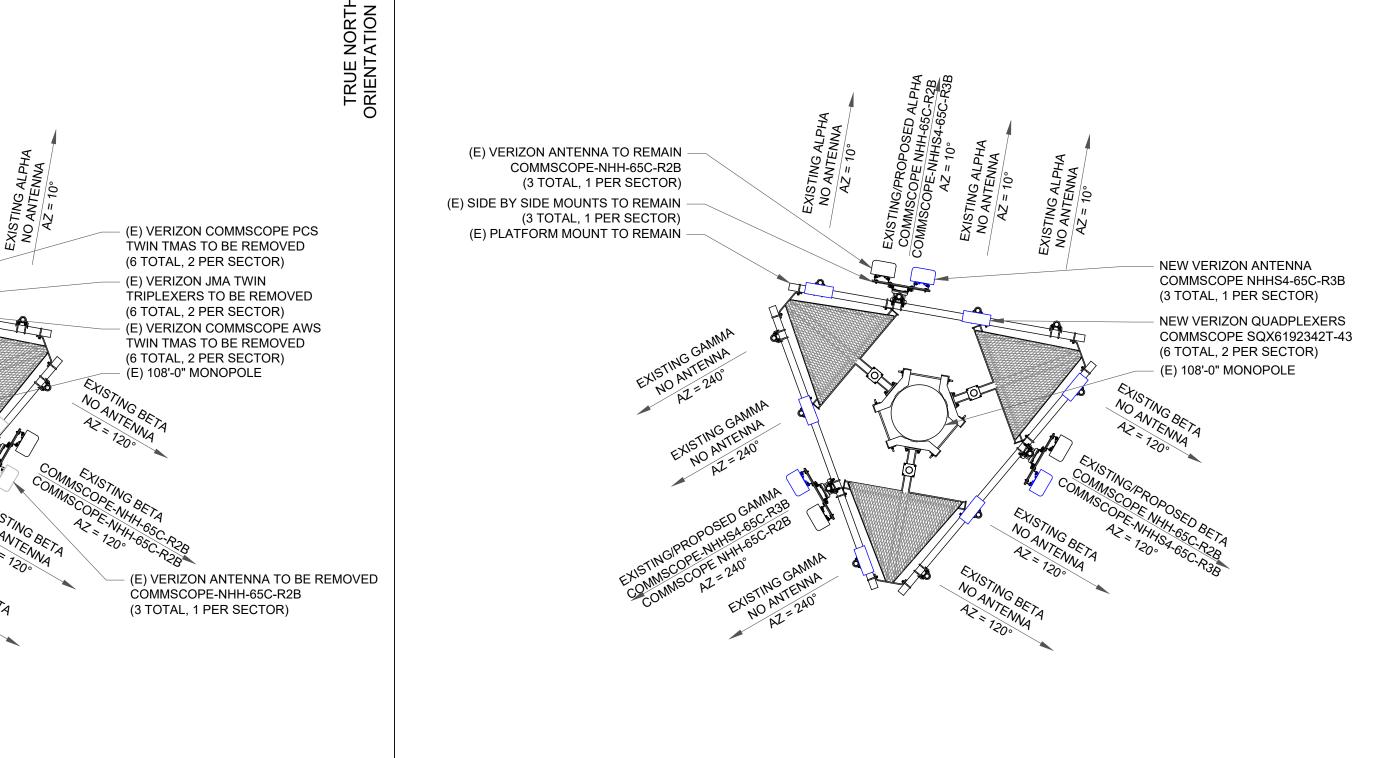

CHRISTOPHER J. SCHEKS E -78306

ARE ACTING UNDER THE DIRECTION OF THE LICENSED PROFESSIONAL ENGINEER, TO ALTER THIS DOCUMENT. SITE ID: 616893715 FUZE PROJECT ID: 16746381 MDG LOCATION ID: 5000089047

8358 GLENCREE PLACE DUBLIN, OHIO 43017

ROL

SUMMITVIEW RELO

DRAWN BY: CHECKED BY: 08/04/2025

PROJECT #: 2025737.00.149818.03 SHEET TITLE

TOWER ELEVATION & ANTENNA LAYOUTS

SHEET NUMBER

PROPOSED ANTENNA LAYOUT SCALE: NOT TO SCALE