


RENOVATION OF HEARTLAND BANK DUBLIN

6500 FRANTZ ROAD
DUBLIN, OH 43017

PREPARED FOR:

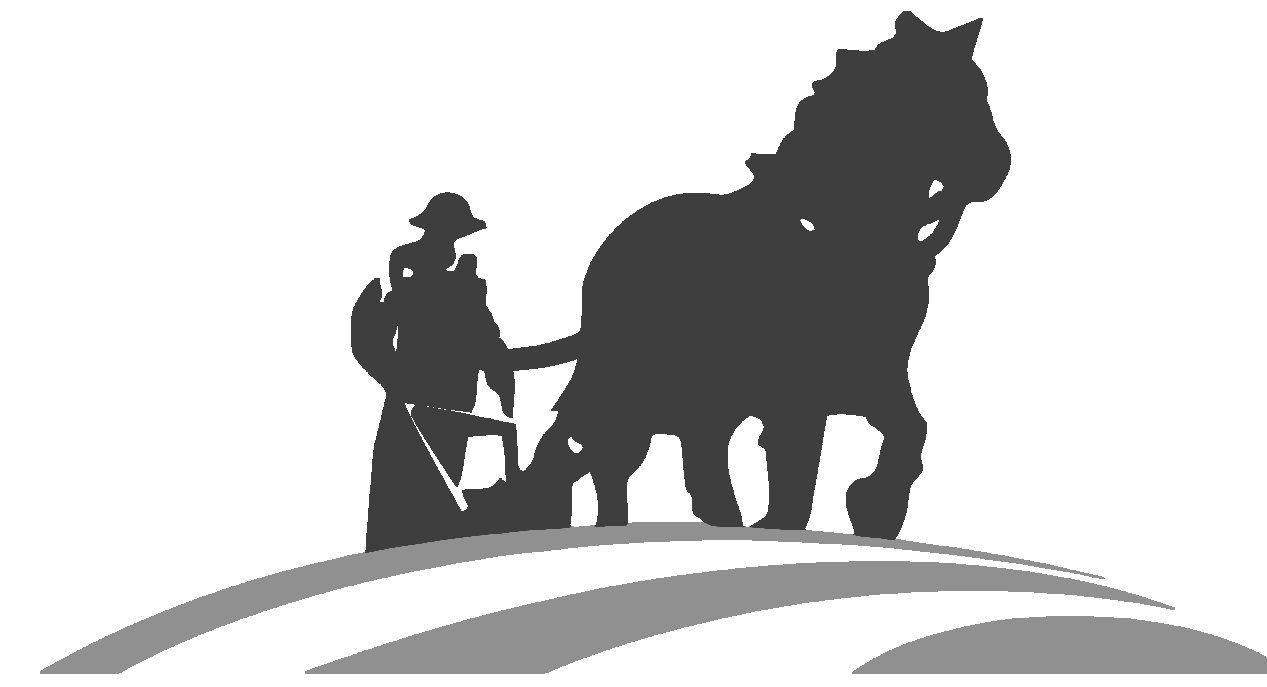

HEARTLAND BANK

430 N. HAMILTON ROAD
WHITEHALL, OH 43213

PREPARED BY:

CIVIL ENGINEER



300 SPRUCE STREET
SUITE 200
COLUMBUS, OH 43215

PHONE: (614) 280-8999

ARCHITECT



300 SPRUCE STREET
SUITE 300
COLUMBUS, OH 43215

PHONE: (614) 461-4664 FAX: (614) 280-8881

STRUCTURAL ENGINEER



5640 FRANTZ ROAD
DUBLIN, OH 43017

PHONE: (614) 766-0066

PLUMBING, MECHANICAL &
ELECTRICAL ENGINEER



1405 DUBLIN ROAD
COLUMBUS, OH 43215

PHONE: (614) 486-4778


PRELIMINARY DEVELOPMENT PLAN 09/10/2020

ABBREVIATIONS

SYMBOLS

Table of symbols and abbreviations including A (Anchor Bolt), B (Bottom of Curb), C (Cabinet), D (Double), E (East), F (Fire Alarm), G (Gage/Gauge), H (Height/High), I (Inside Diameter), J (Janitor), K (Kitchen), L (Length), M (Masonry), N (North), O (Overall), P (Pre-cast), Q (Quarry Tile), R (Radius/Riser), S (South), T (Tread), U (Unfinished), V (Vinyl), W (West/Width), Y (Yard).

SYMBOLS LEGEND

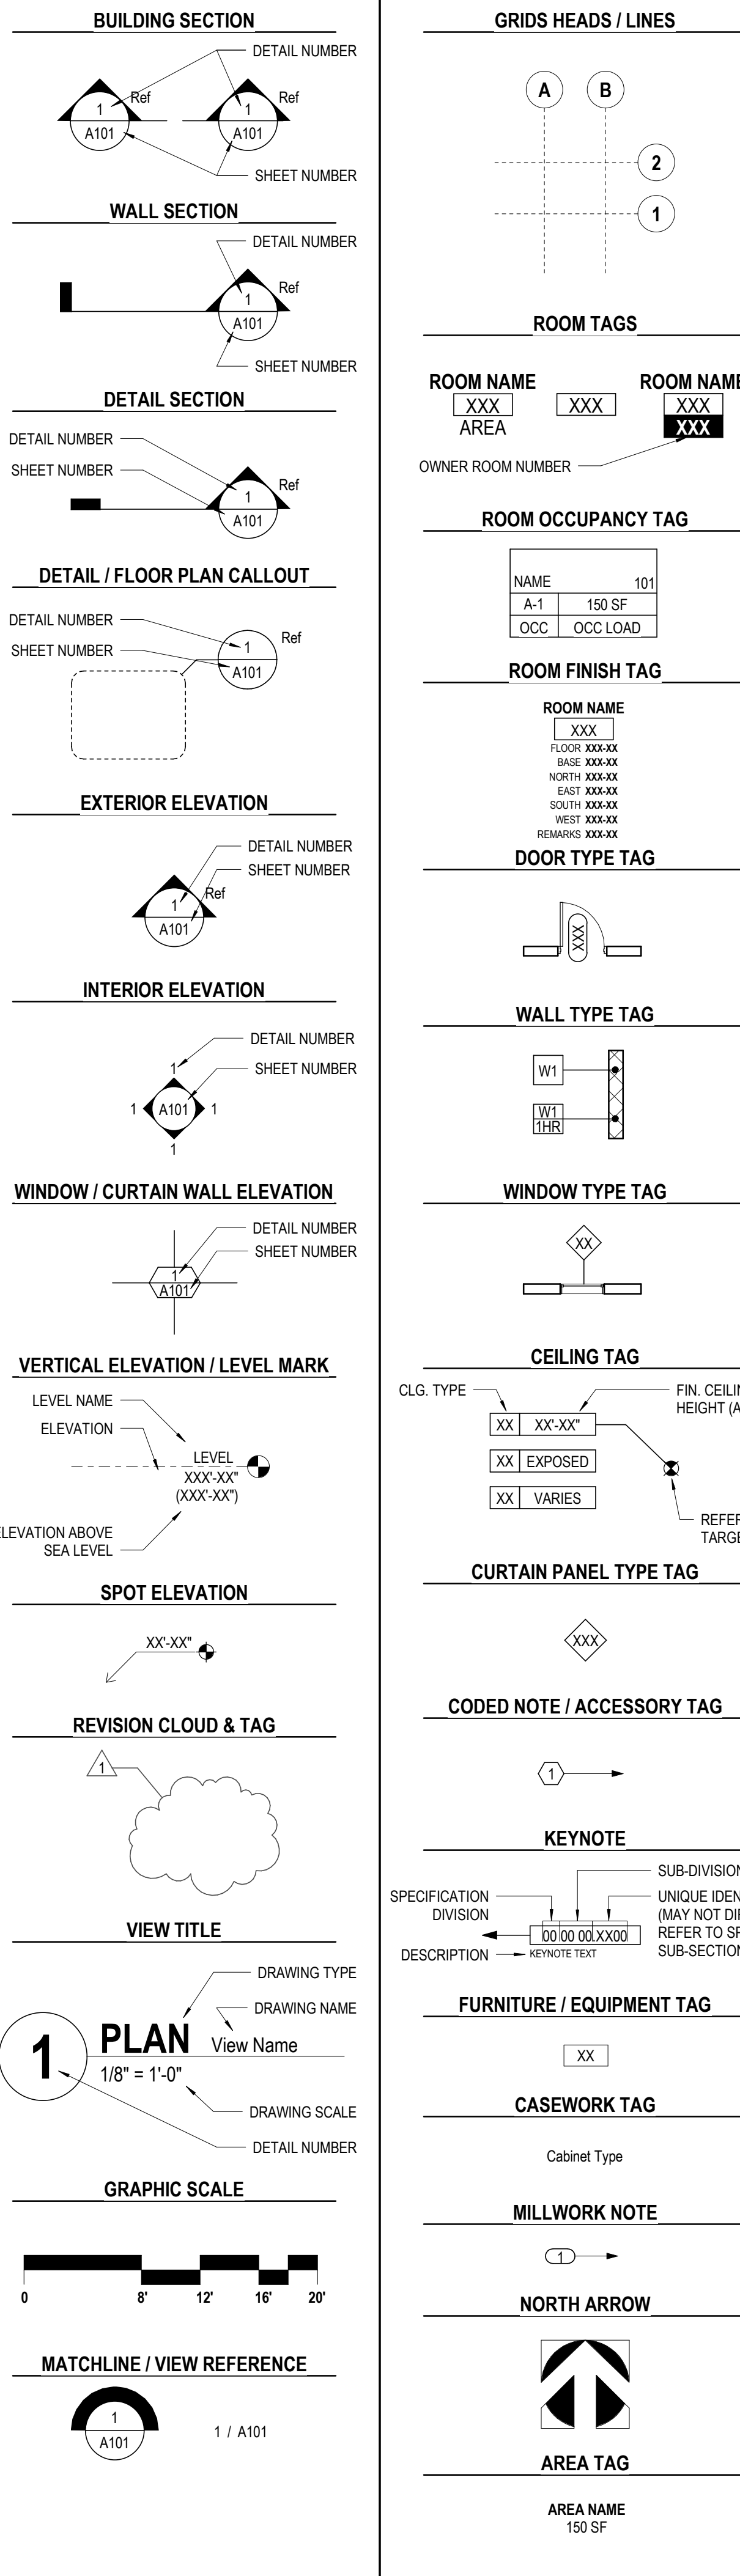

CODE SUMMARY

OWNER: HEARTLAND BANK
OWNERS ADDRESS: 430 N. HAMILTON ROAD, WHITEHALL, OH 43013
OWNERS PHONE:
SITE ADDRESS: 6500 FRANTZ ROAD, DUBLIN, OH 43017
SITE ZONING:
SITE AREA: 0.913 ACRES
PARKING REQUIRED: 4,436 SF/1000 x 2.5 = 12
PARKING SHOWN: 20 + 2 HANDICAPPED = 22
BUILDING CODES:
-OHIO BUILDING CODE: 2017 OBC
-OHIO PLUMBING CODE: 2017 OPC
-OHIO MECHANICAL CODE: 2017 OMC
-NATIONAL ELECTRIC CODE: 2017 NEC - NFPA 70
-INTERNATIONAL FUEL GAS CODE: 2015 IFGC
-INTERNATIONAL ENERGY CONSERVATION CODE: 2012 IECC
-ASHRAE 90.1 2007 ENERGY STANDARDS FOR BUILDING EXCEPT LOW-RISE RESIDENTIAL BUILDINGS: 2010 ASHRAE 90.1
-ICC A117.1-2009 ACCESSIBLE AND USEABLE BUILDINGS AND FACILITIES: ANSI A117.1 - 2009
-OHIO FIRE CODE: 2017 OFC
-NATIONAL FIRE ALARM AND SIGNALLING CODE NFPA 72-10
BUILDING DATA:
CONSTRUCTION TYPE: TYPE VB (COMBUSTIBLE, NON-PROTECTED)
USE GROUP: B - BUSINESS
ALLOWABLE HEIGHT: 40'-0"
ACTUAL HEIGHT: 25'-6"
ALLOWABLE AREA SF: 9,000 SF
ALLOWABLE AREA INCREASE FOR OPEN PERIMETER:
ALLOWABLE FLOOR AREA:
ACTUAL FLOOR AREAS: BASEMENT 2,106 SF
FIRST FLOOR 2,330 SF
TOTAL 4,436 SF
FIRE RESISTANCE RATINGS TABLE 602
EXTERIOR WALLS: 0 HR
VERTICAL CIRCULATION: 0 HR
EXIT ACCESS CORRIDORS: 0 HR
STRUCTURE: 0 HR
FLOORS: 0 HR
ROOF: 0 HR

INDEX OF DRAWINGS

Table listing drawing index - volume 1, sheet number, sheet name, and categories like GENERAL, CIVIL, LANDSCAPE, STRUCTURAL, DEMOLITION, ARCHITECTURAL, PLUMBING, MECHANICAL, ELECTRICAL.

GENERAL NOTES

AREA MAP

VICINITY MAP

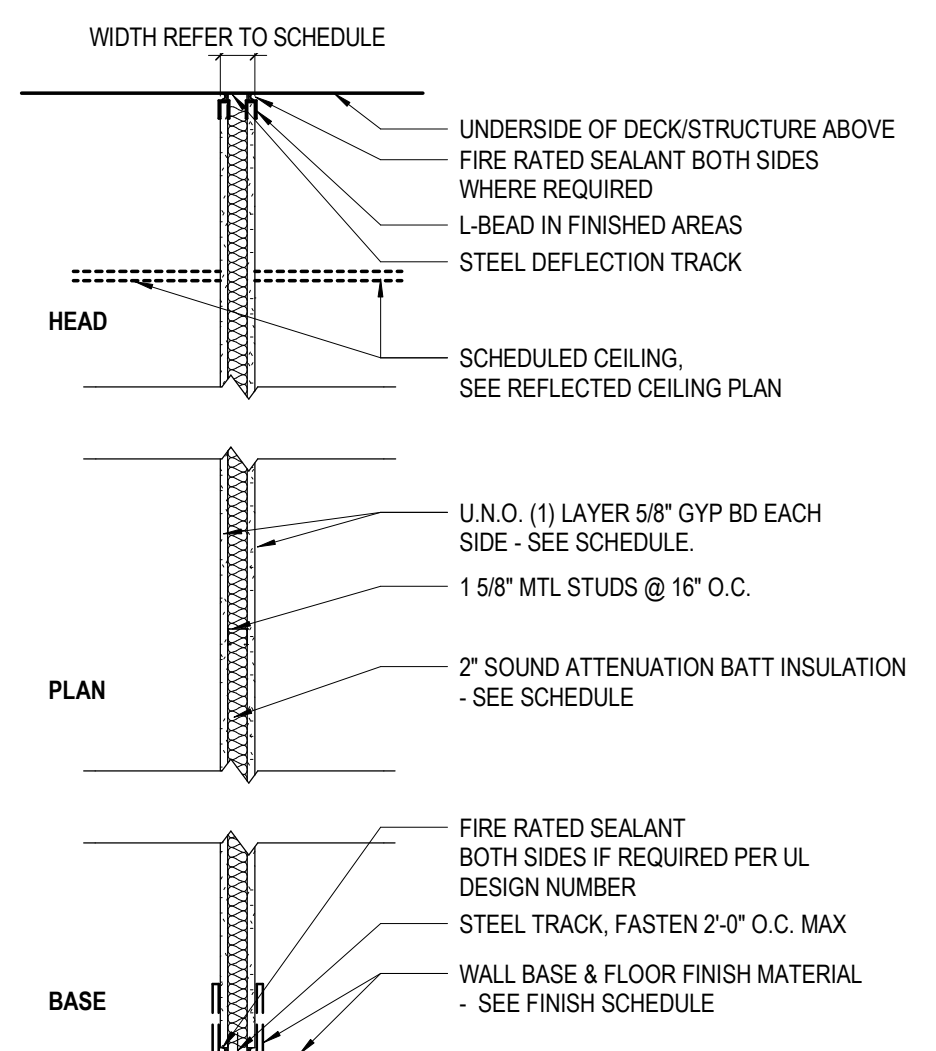
MATERIALS LEGEND

Table of materials legend including Aluminum, Acoustic Ceiling, Brick, Concrete, Concrete Masonry, Concrete (Surface), Earth, Glass - Large Scale, Glass - Small Scale, Granular Fill, Gypsum Board, Insulation - Batt, Insulation - Rigid, Plywood, Steel, Wood - Rough Framing, Wood - Rough Blocking, Wood - Finished.

RENOVATION OF HEARTLAND BANK DUBLIN
6500 FRANTZ ROAD
DUBLIN, OH 43017
FOR HEARTLAND BANK
300 SPRUCE STREET
SUITE 300
COLUMBUS, OHIO 43215
PHONE: (614) 461-4664
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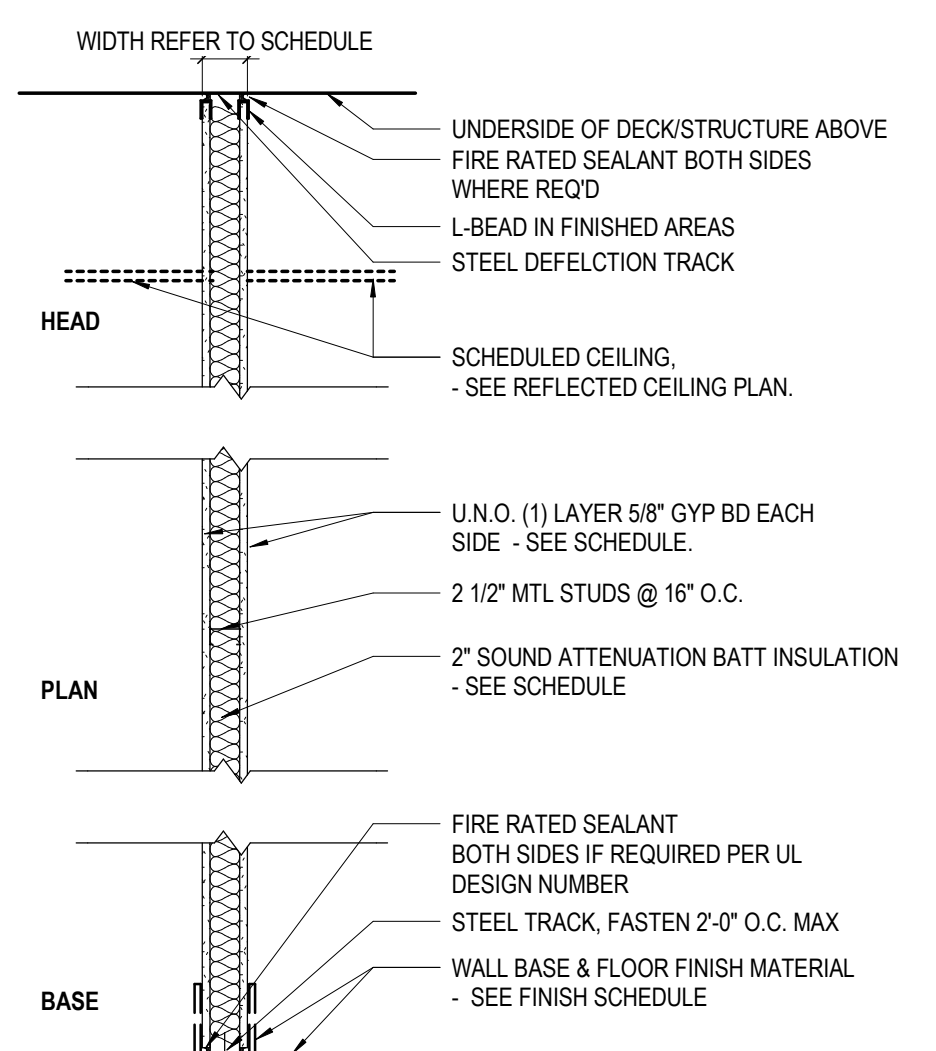
DRAWING INDEX
09/10/2020
DRAWN BY: xxx CHECKED BY: xxx
20022
PROGRESS DRAWING NOT FOR CONSTRUCTION
G001
PRELIMINARY DEVELOPMENT PLAN

TYPE 1 - 1 5/8" METAL STUD WALL TYPES




TYPE	WIDTH	STUD WIDTH	GYP. BD. - 1 SIDE	GYP. BD. - 2 SIDES	"TYPE X" GYP. BD.	FIRE RATING	UL #	STC RATING	SOUND INSUL.	CODED NOTES	COMMENTS
1H	2 1/4"	1 5/8"	Yes	No	No	0HR		35	No	04	

TYPE 2 - 2 1/2" METAL STUD WALL TYPES




TYPE	WIDTH	STUD WIDTH	GYP. BD. - 1 SIDE	GYP. BD. - 2 SIDES	"TYPE X" GYP. BD.	FIRE RATING	UL #	STC RATING	SOUND INSUL.	CODED NOTES	COMMENTS

TYPE 3 - 3 5/8" METAL STUD WALL TYPES

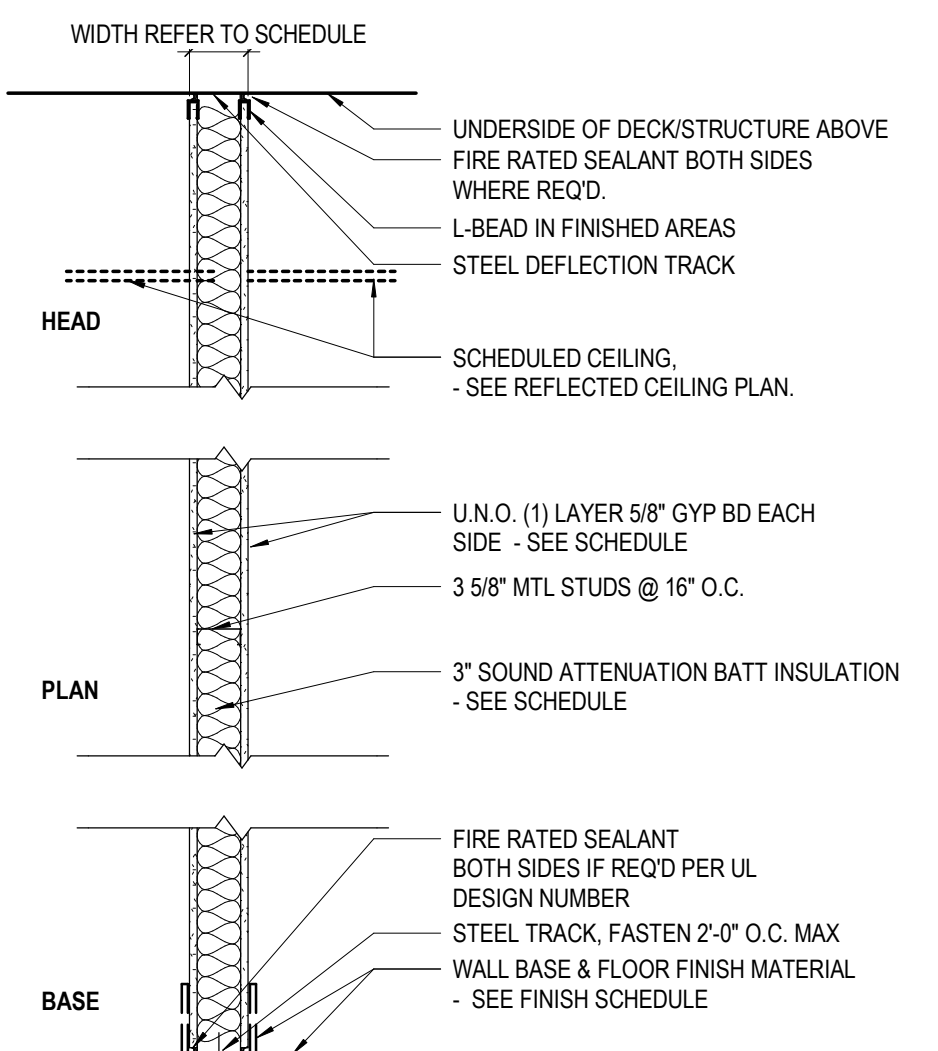


TYPE	WIDTH	STUD WIDTH	GYP. BD. - 1 SIDE	GYP. BD. - 2 SIDES	"TYPE X" GYP. BD.	FIRE RATING	UL #	STC RATING	SOUND INSUL.	CODED NOTES	COMMENTS

TYPE 4 - 6" METAL STUD WALL TYPES

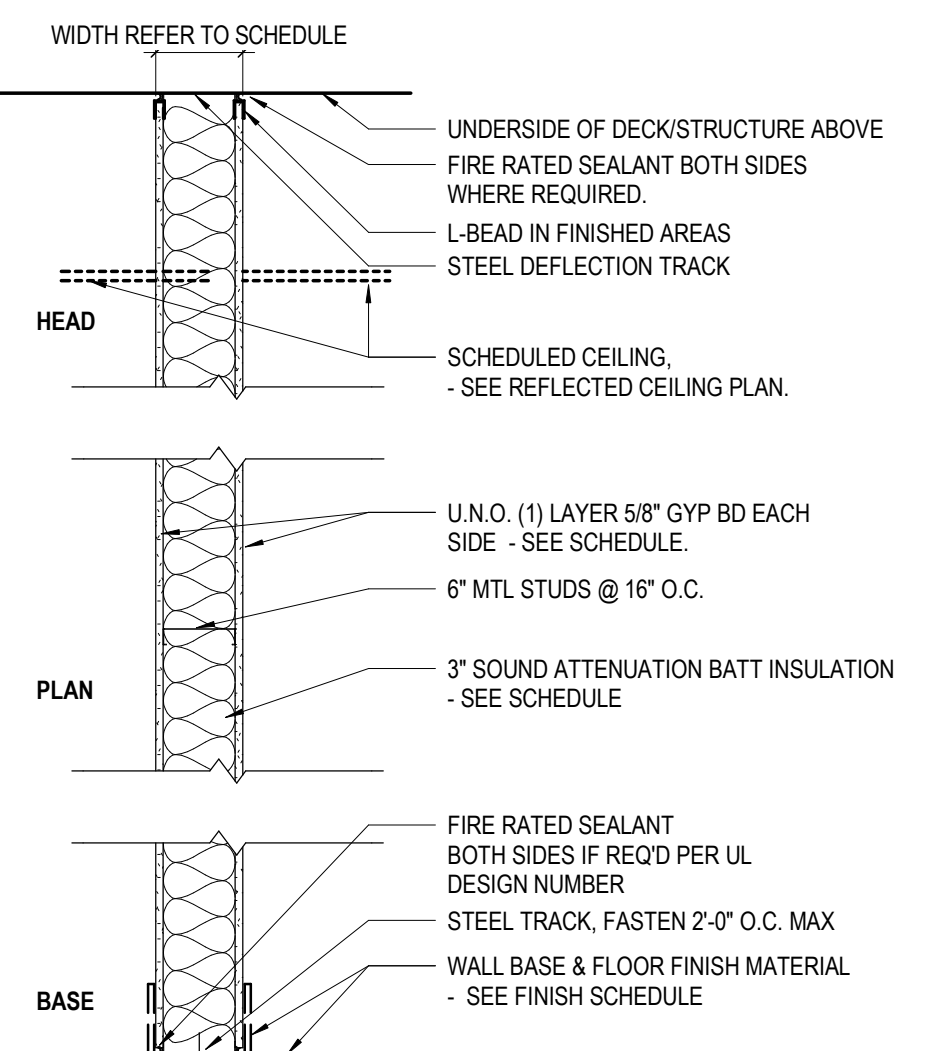

TYPE	WIDTH	STUD WIDTH	GYP. BD. - 1 SIDE	GYP. BD. - 2 SIDES	"TYPE X" GYP. BD.	FIRE RATING	UL #	STC RATING	SOUND INSUL.	CODED NOTES	COMMENTS

TYPE 5 - MISC. METAL STUD WALL TYPES

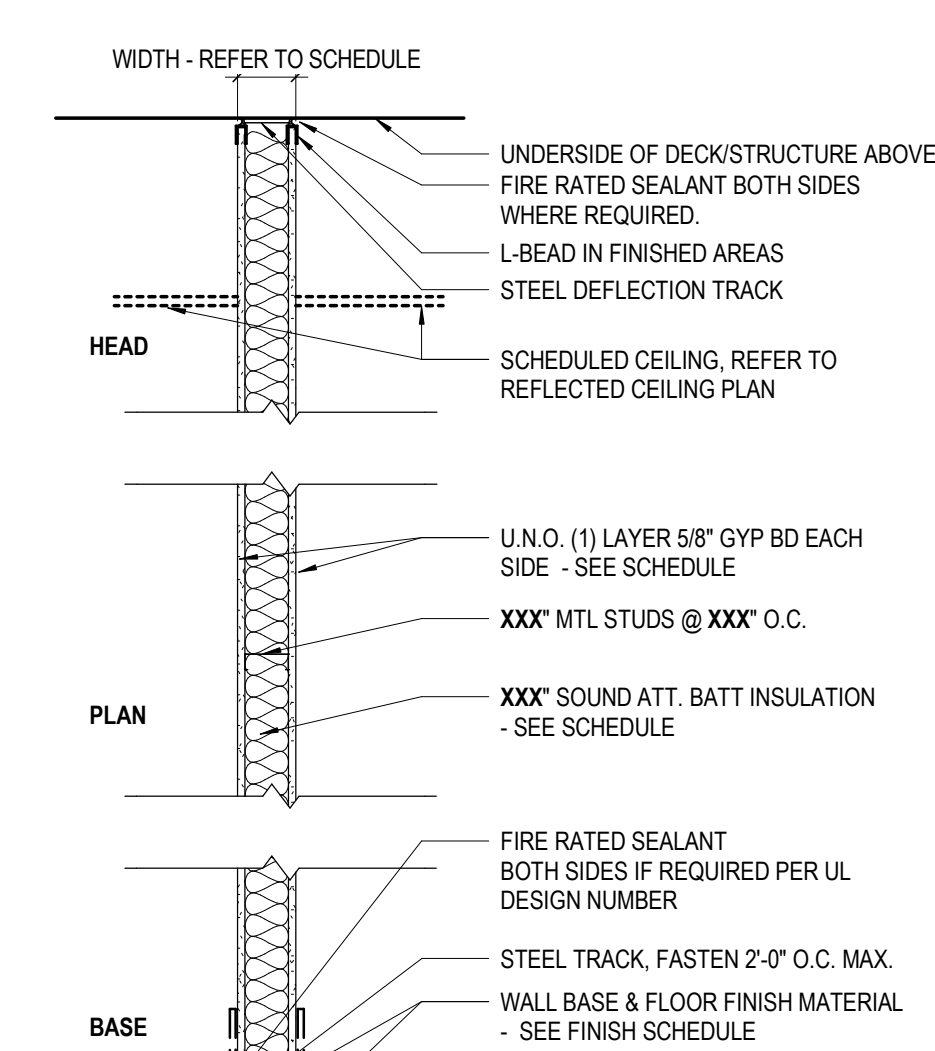

TYPE	WIDTH	STUD WIDTH	GYP. BD. - 1 SIDE	GYP. BD. - 2 SIDES	"TYPE X" GYP. BD.	FIRE RATING	UL #	STC RATING	SOUND INSUL.	CODED NOTES	COMMENTS


GENERAL NOTES - WALL TYPE

- ALL DIMENSIONS TO FACE OF WALL UN.O.
- USE 5/8" WATER RESISTANT GYP. BD. ON ALL WET WALLS, LINO.
- USE CEMENT BOARD FOR ALL WALLS TO RECEIVE CERAMIC TILE, LINO.
- FIRE SAFE ALL JOINTS AND PENETRATIONS AT FIRE RATED PARTITIONS.
- UL NUMBERS LISTED APPLY ONLY TO THE TESTED MANUFACTURERS. EQUAL MANUFACTURERS EQUIVALENT ASSEMBLY INFORMATION MUST BE APPROVED BY ARCHITECT.
- INSULATION MUST EXTEND FULL HEIGHT OF PARTITION. WHERE SOUND ATTENUATION BATTS ARE INDICATED IN PARTITIONS, INSTALL ACOUSTIC SEALANT AT BOTH SIDES, ALONG THE TOP AND BOTTOM, AND AT INTERSECTING PARTITIONS.
- WHERE 3 5/8", 4" OR 6" STUD WALLS ARE INDICATED, SEE SPECIFICATIONS FOR HEIGHT LIMITS.
- REFER TO FINISH SCHEDULE FOR FINISHES.
- PROVIDE ACOUSTIC SEALANT AT TOP & BOTTOM OF PARTITION AS REQUIRED BY STC RATING.

CODED NOTE LEGEND


- BRACE EACH STUD @ 4'-0" O.C. TO BACK-UP WALL FOR ENTIRE HEIGHT OF PARTITION.
- BRACE EACH STUD @ 8'-0" O.C. TO BACK-UP WALL FOR ENTIRE HEIGHT OF PARTITION.
- SMOKE TIGHT SEAL SHALL BE PROVIDED AT TOP, BOTTOM AND ENDS OF WALL AND AT ALL PENETRATIONS.
- FULL HEIGHT PARTITION. TERMINATE GYP. BD. AND STUDS AT DECK/STRUCTURE ABOVE.
- STOP GYP. BD. AND STUDS 6" AFC. BRACE PARTITION TO DECK/STRUCTURE PER METAL STUD MANUFACTURER DESIGN LOADING CRITERIA.
- FULL HEIGHT SHAF WALL. TERMINATE GYP. BD. AND STUDS AT DECK/STRUCTURE ABOVE.
- FULL HEIGHT PARTITION. TERMINATE GYP. BD., PLYWOOD AND STUDS AT DECK/STRUCTURE ABOVE.
- FULL HEIGHT PARTITION. TERMINATE CMU AT DECK/STRUCTURE ABOVE.
- STOP CMU FULL COURSE ABOVE FINISH CEILING. BRACE WALL TO STRUCTURE PER STRUCTURAL DRAWINGS.
- FULL HEIGHT PARTITION. TERMINATE CMU AT DECK ABOVE. STOP FURRING AND GYP. BD. @ 6" ABOVE FINISHED CEILING.
- STOP WALL FULL COURSE ABOVE FINISH CEILING. BRACE WALL TO STRUCTURE PER STRUCTURAL DRAWINGS.

TYPE 6 - 4" CONCRETE MASONRY WALLS

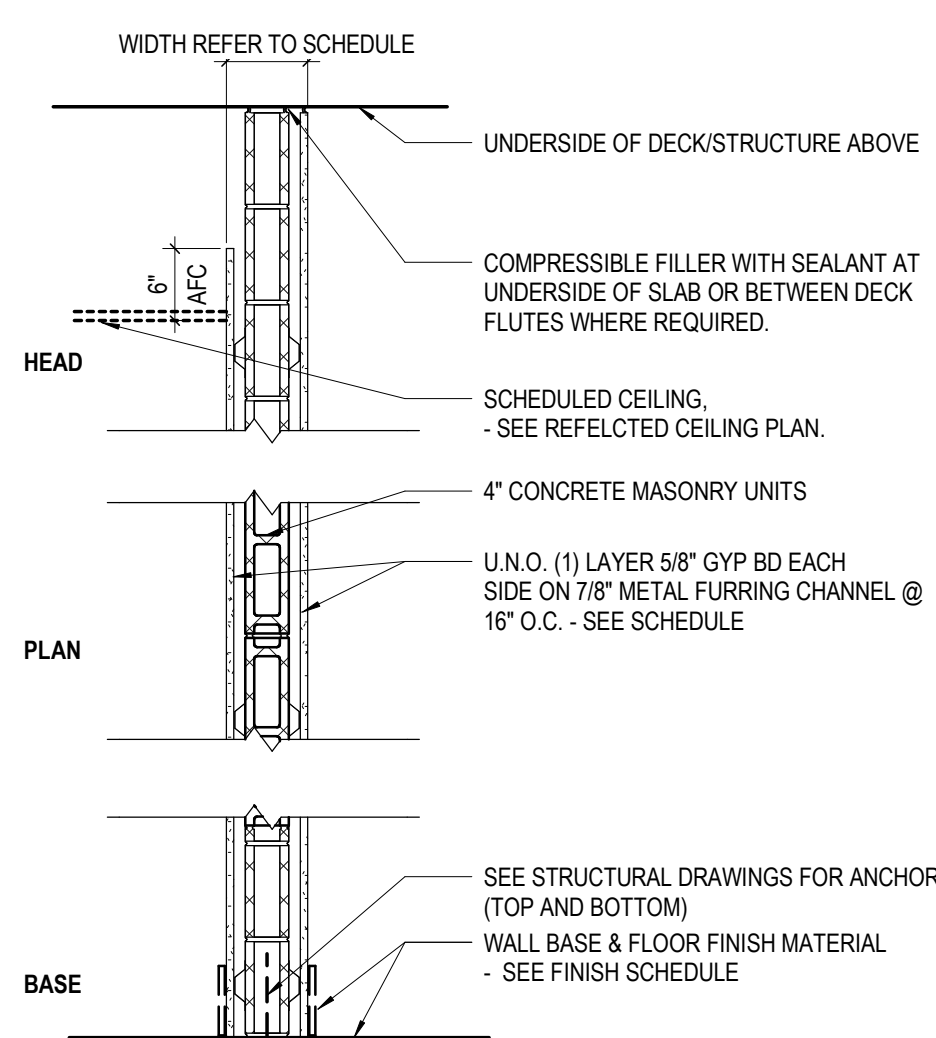


TYPE	WIDTH	GYP. BD. - 1 SIDE	GYP. BD. - 2 SIDES	"TYPE X" GYP. BD.	FIRE RATING	UL #	STC RATING	SOUND INSUL.	CODED NOTES	COMMENTS

TYPE 7 - 6" CONCRETE MASONRY WALLS

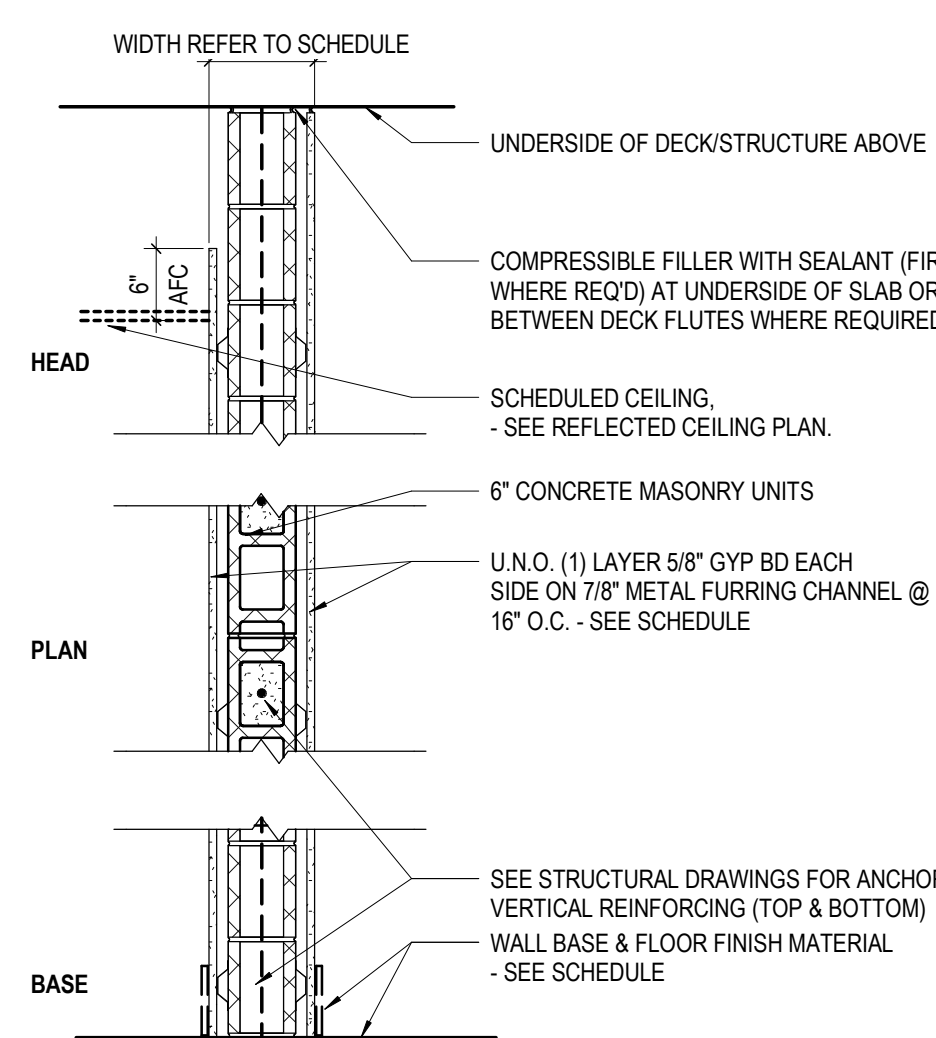


TYPE	WIDTH	GYP. BD. - 1 SIDE	GYP. BD. - 2 SIDES	"TYPE X" GYP. BD.	FIRE RATING	UL #	STC RATING	SOUND INSUL.	CODED NOTES	COMMENTS

TYPE 8 - 8" CONCRETE MASONRY WALLS

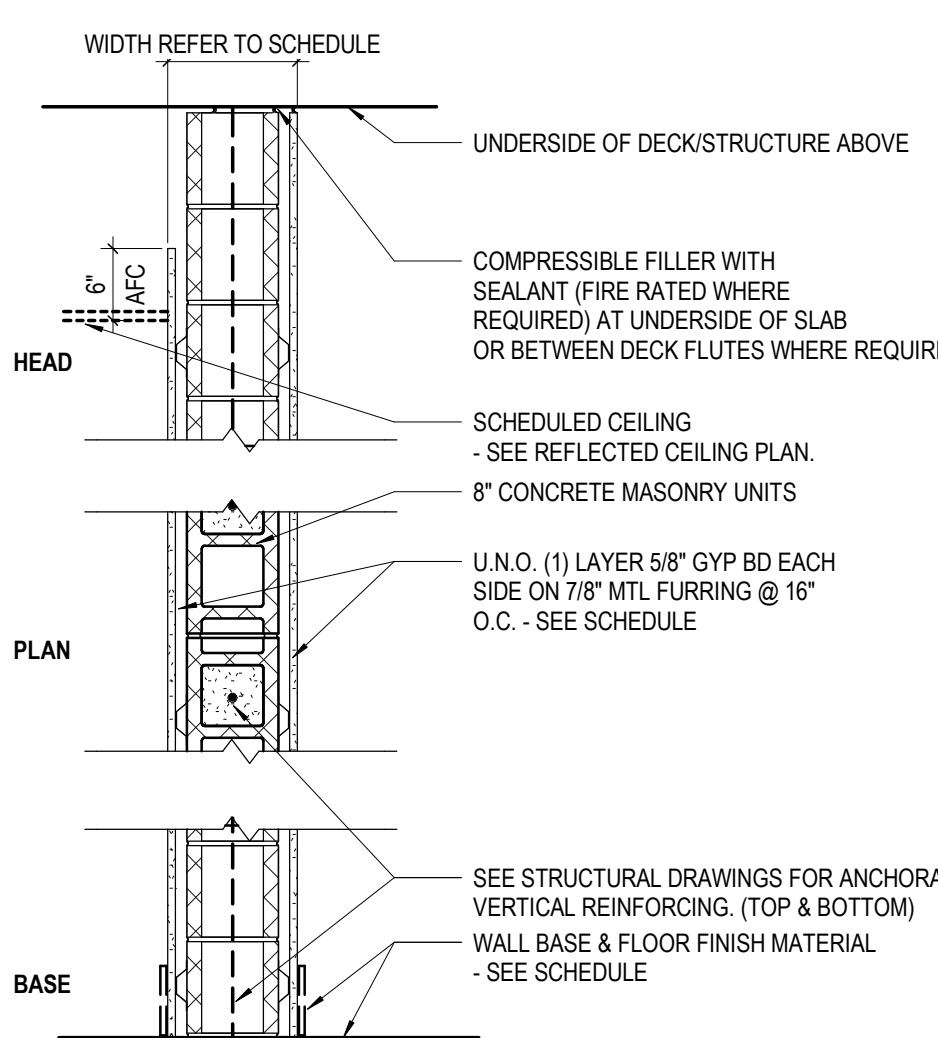


TYPE	WIDTH	GYP. BD. - 1 SIDE	GYP. BD. - 2 SIDES	"TYPE X" GYP. BD.	FIRE RATING	UL #	STC RATING	SOUND INSUL.	CODED NOTES	COMMENTS

TYPE 9 - 10" CONCRETE MASONRY WALLS

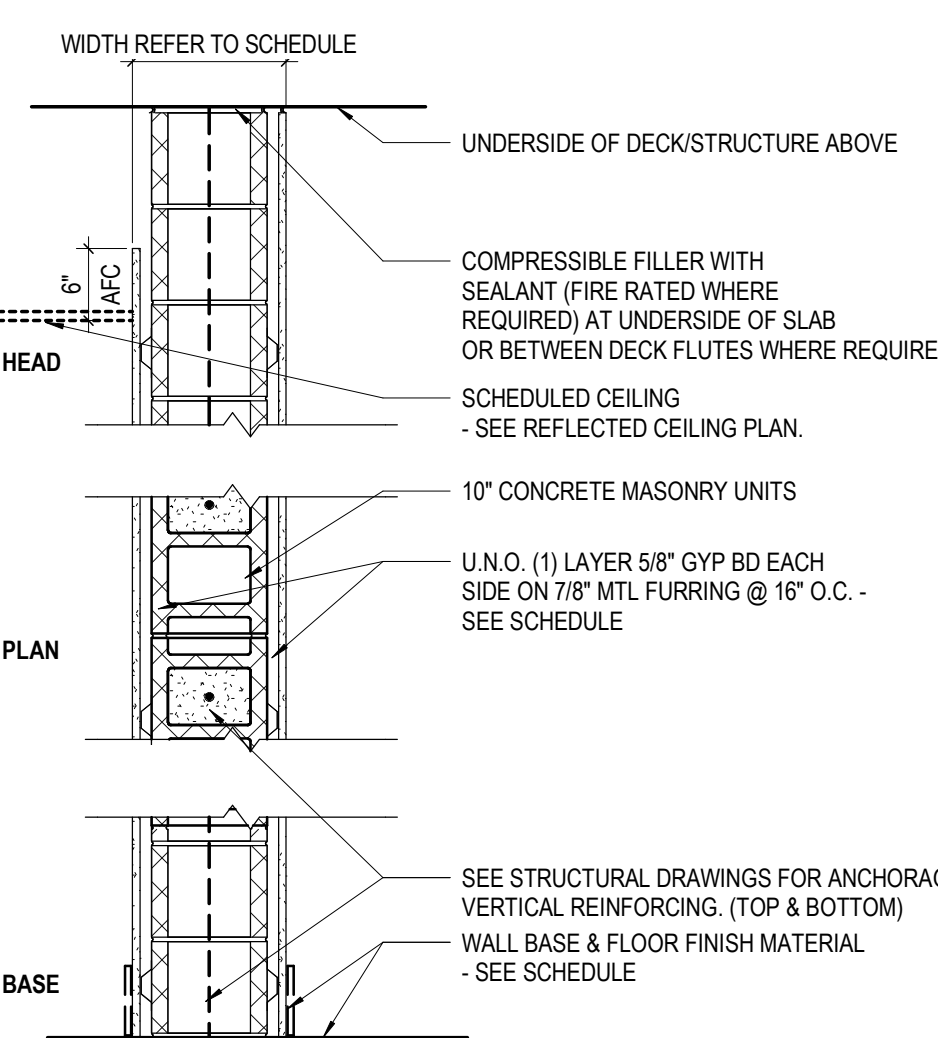


TYPE	WIDTH	GYP. BD. - 1 SIDE	GYP. BD. - 2 SIDES	"TYPE X" GYP. BD.	FIRE RATING	UL #	STC RATING	SOUND INSUL.	CODED NOTES	COMMENTS

TYPE 10 - 12" CONCRETE MASONRY WALLS

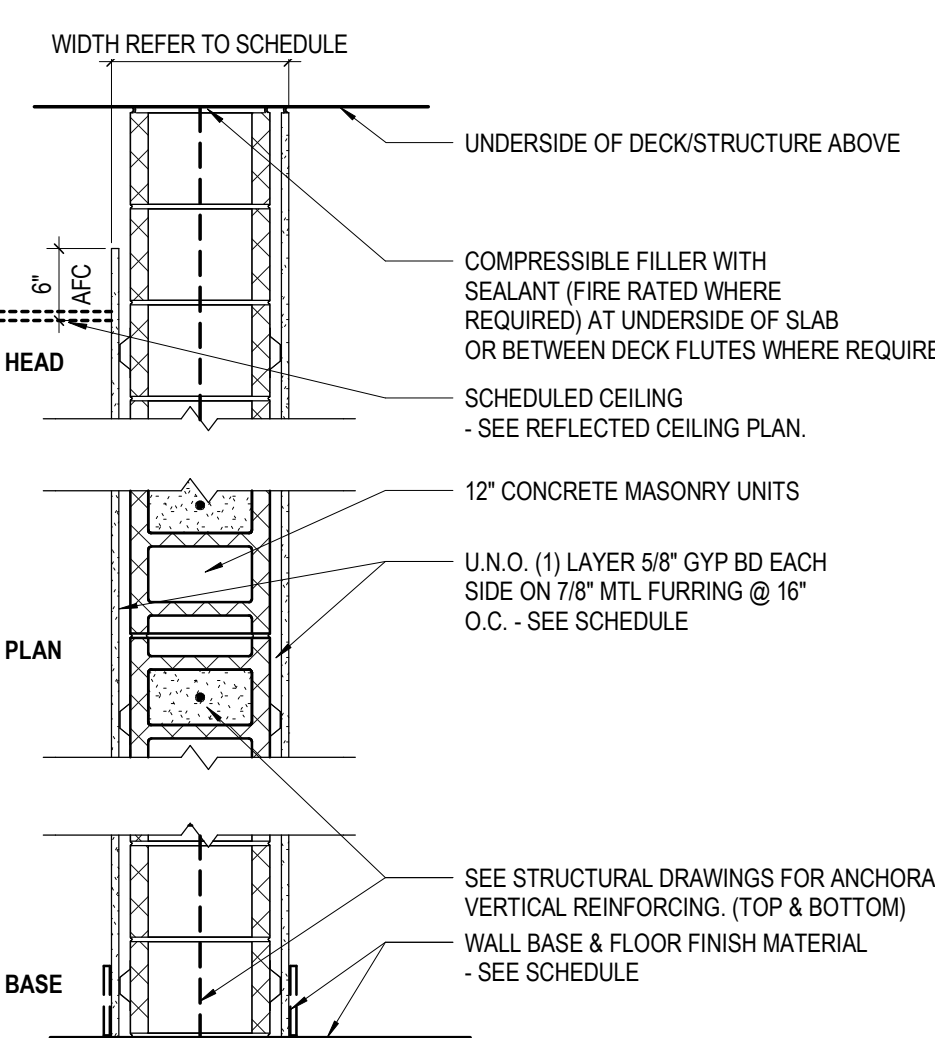


TYPE	WIDTH	GYP. BD. - 1 SIDE	GYP. BD. - 2 SIDES	"TYPE X" GYP. BD.	FIRE RATING	UL #	STC RATING	SOUND INSUL.	CODED NOTES	COMMENTS

TYPE 11 - 2 X 4 WOOD STUD WALL TYPES

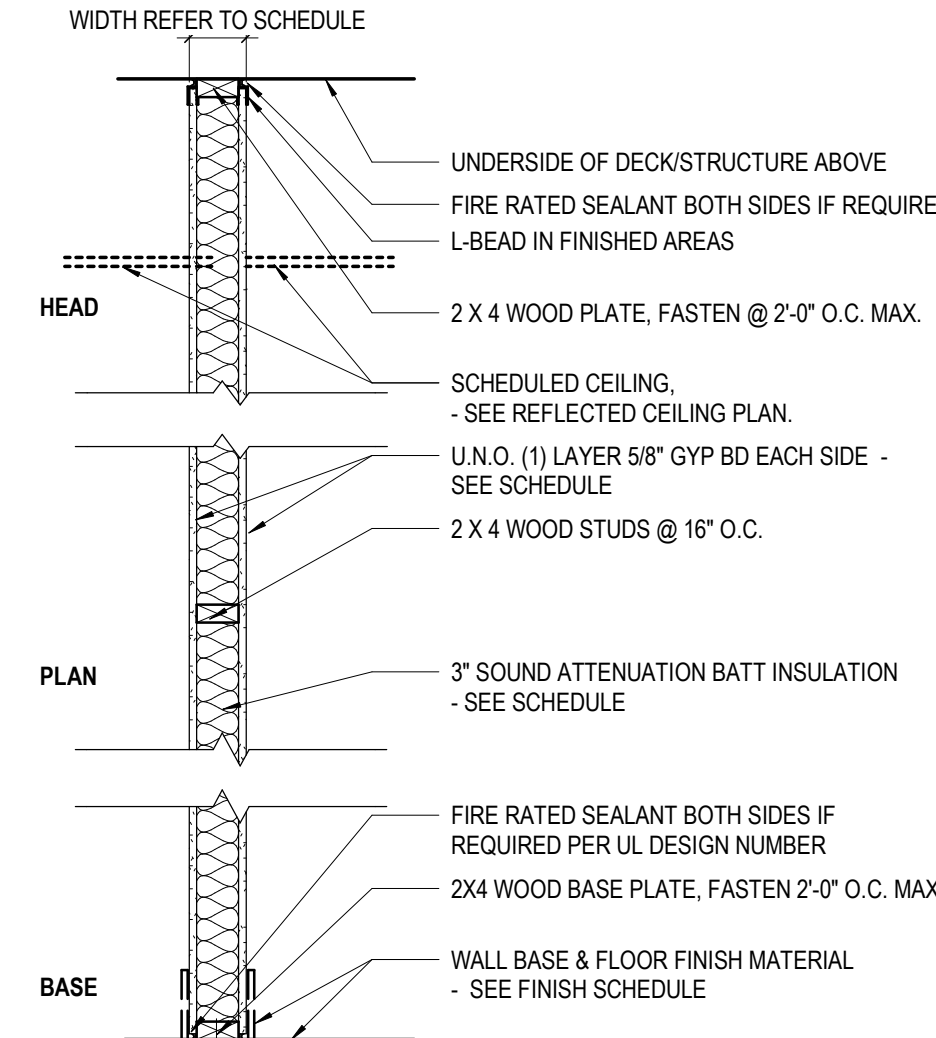


TYPE	WIDTH	STUD WIDTH	GYP. BD. - 1 SIDE	GYP. BD. - 2 SIDES	"TYPE X" GYP. BD.	FIRE RATING	UL #	STC RATING	SOUND INSUL.	CODED NOTES	COMMENTS
11D	4 3/4"	2x4	No	Yes	No	0HR		35	No	04	
11F	4 3/4"	2x4	No	Yes	No	0HR		35	No	05	

TYPE 12 - 2 X 6 WOOD STUD WALL TYPES

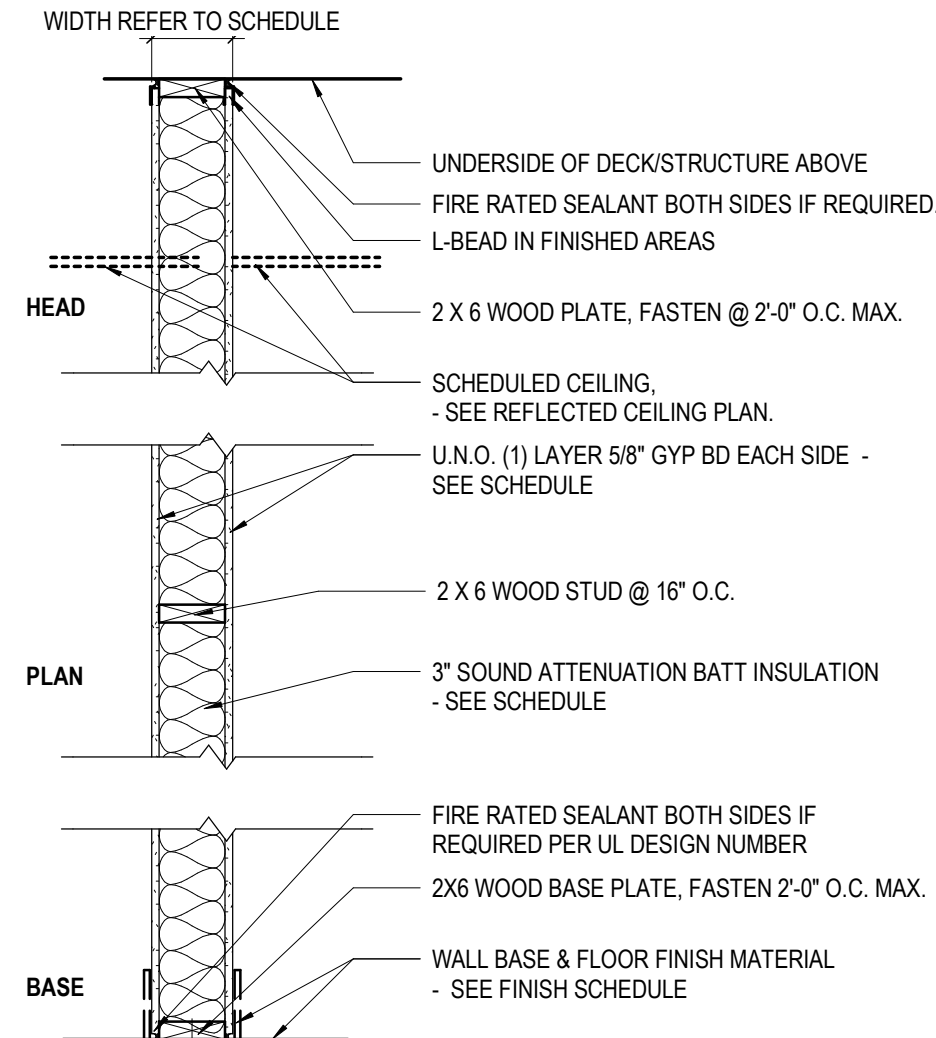


TYPE	WIDTH	STUD WIDTH	GYP. BD. - 1 SIDE	GYP. BD. - 2 SIDES	"TYPE X" GYP. BD.	FIRE RATING	UL #	STC RATING	SOUND INSUL.	CODED NOTES	COMMENTS
12C	6 3/4"	2x6	No	Yes	No	0HR		46 EST.	Yes	04	
12D	6 3/4"	2x6	No	Yes	No	0HR		35 EST.	No	04	

TYPE S - SHAFT WALL TYPES

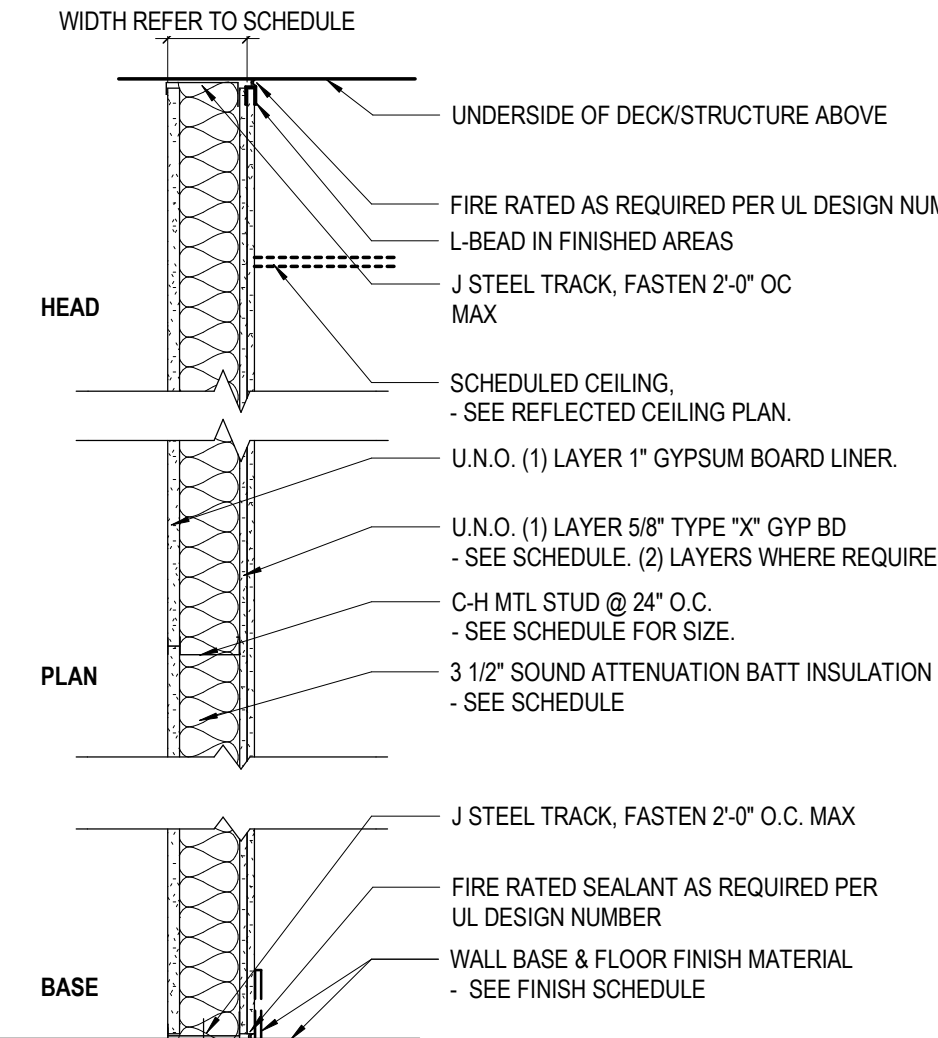


TYPE	WIDTH	STUD WIDTH	GYP. BD. - 1 SIDE	GYP. BD. - 2 SIDES	"TYPE X" GYP. BD.	FIRE RATING	UL #	STC RATING	SOUND INSUL.	CODED NOTES	COMMENTS

TYPE CM - MASONRY CHASE WALL TYPES

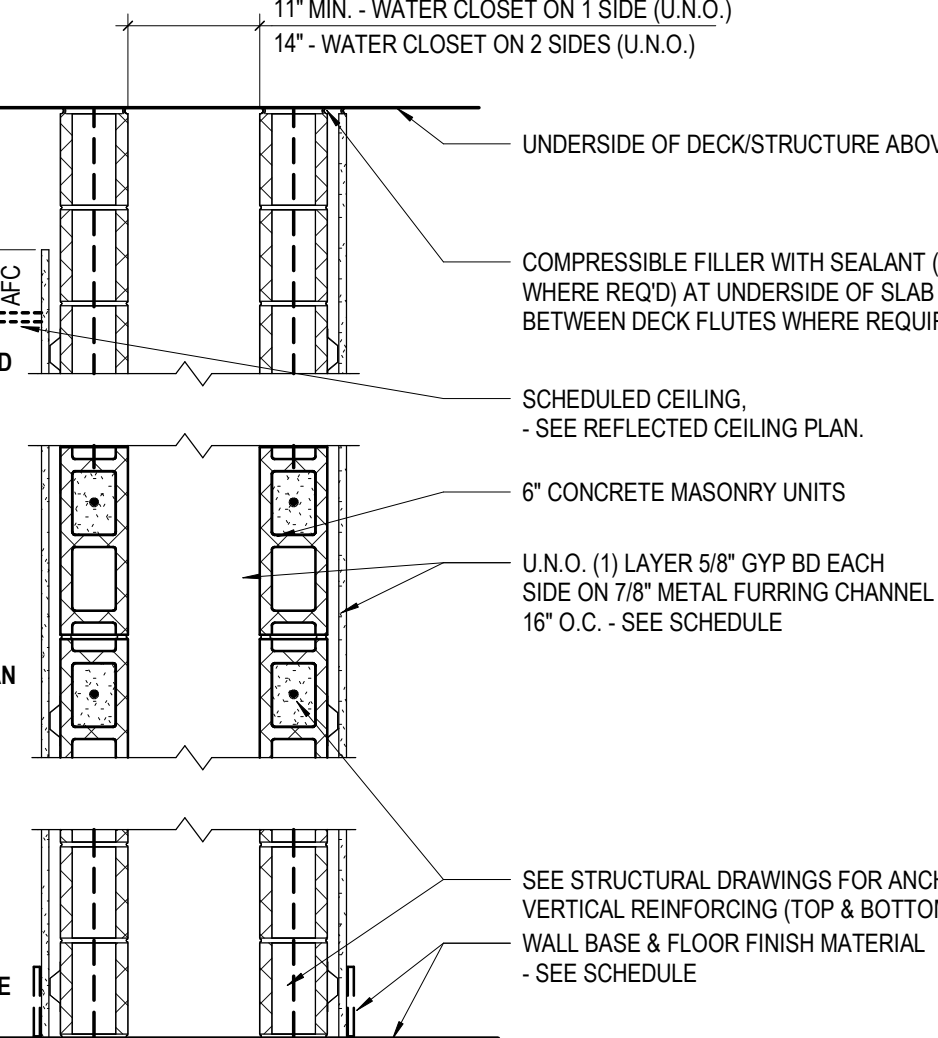

TYPE	WIDTH	STUD WIDTH	GYP. BD. - 1 SIDE	GYP. BD. - 2 SIDES	"TYPE X" GYP. BD.	FIRE RATING	UL #	STC RATING	SOUND INSUL.	CODED NOTES	COMMENTS

TYPE CS - STUD CHASE WALL TYPES

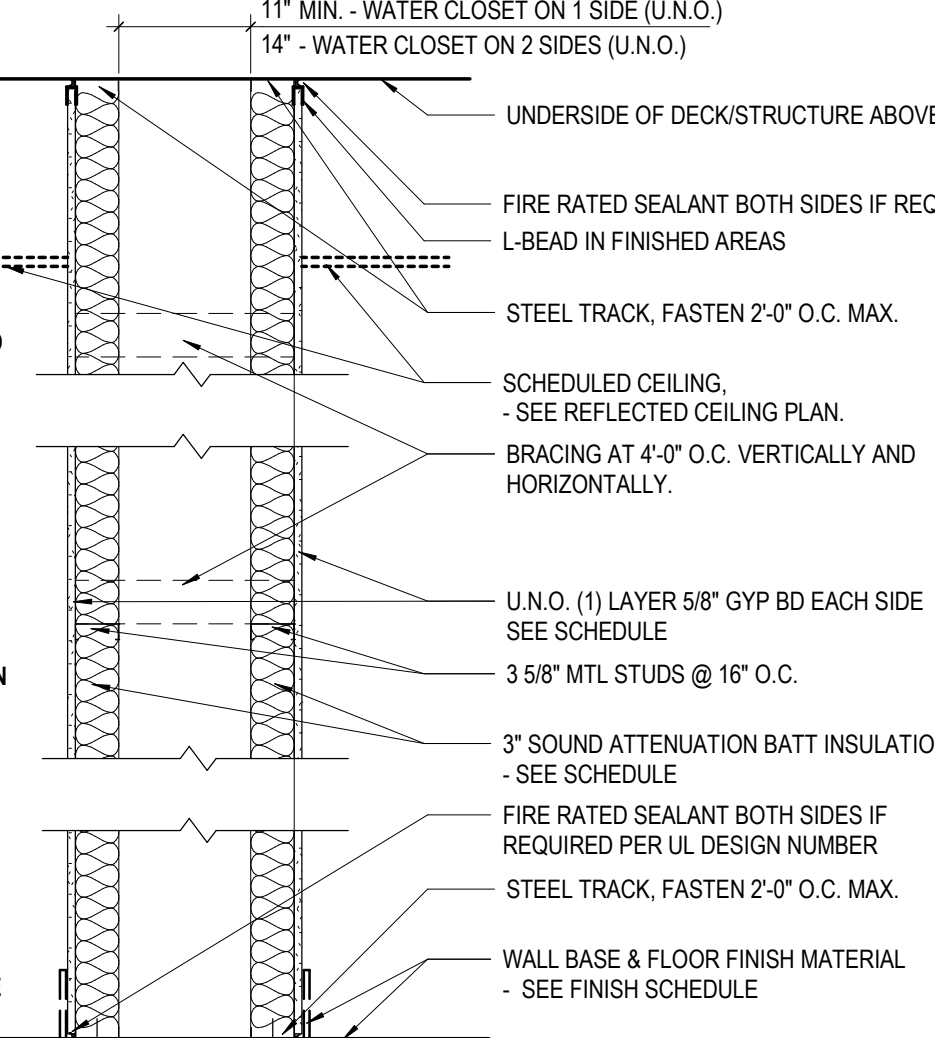

TYPE	WIDTH	STUD WIDTH	GYP. BD. - 1 SIDE	GYP. BD. - 2 SIDES	"TYPE X" GYP. BD.	FIRE RATING	UL #	STC RATING	SOUND INSUL.	CODED NOTES	COMMENTS


#	DATE	CHANGE DESCRIPTION

RENOVATION OF HEARTLAND BANK DUBLIN
 5303 FRONT ROAD
 DUBLIN, OH 43017
 FOR
HEARTLAND BANK
 300 SPRUCE STREET
 SUITE 300
 COLUMBUS, OHIO 43215
 PHONE: (614) 461-4664
 FAX: (614) 280-8881

DRAWING TITLE:
WALL TYPE SCHEDULE
 09/10/2020
 DRAWN BY: XXX CHECKED BY: XXX
 2022
G002
 PRELIMINARY DEVELOPMENT PLAN



Situated in the State of Ohio, County of Franklin, City of Dublin, being all of the land conveyed to Heartland Bank as shown of Record O.R.V. 21589 J01, Recorder's Office, Franklin County, Ohio.

REVISIONS:			
No.	Date	Description	By

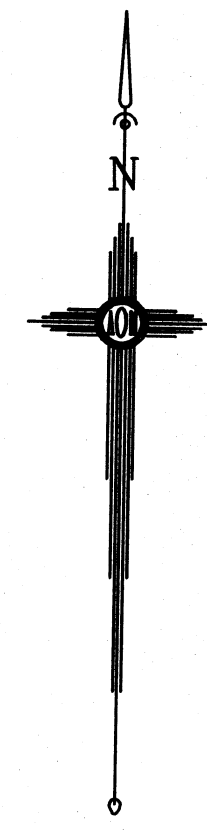

Scale: 1" = 20'
 July 30, 2020
 Address: 6500 Frantz Road
 Dublin, OH 43017

Source & Site Benchmark - V21
 Brass plug in concrete monument at the southeast corner of S.R. 161 and Frantz Road, in front of the Ohio Federal Bank, 63.8 Feet south of the centerline of the S.R. 161 eastbound lanes, 18.2 feet east of the back of curb of Frantz Road, 12.7' southwest of a concrete base for a bank sign, 9 inches below the ground.
 Elevation = 864.965' (NAVD 88)

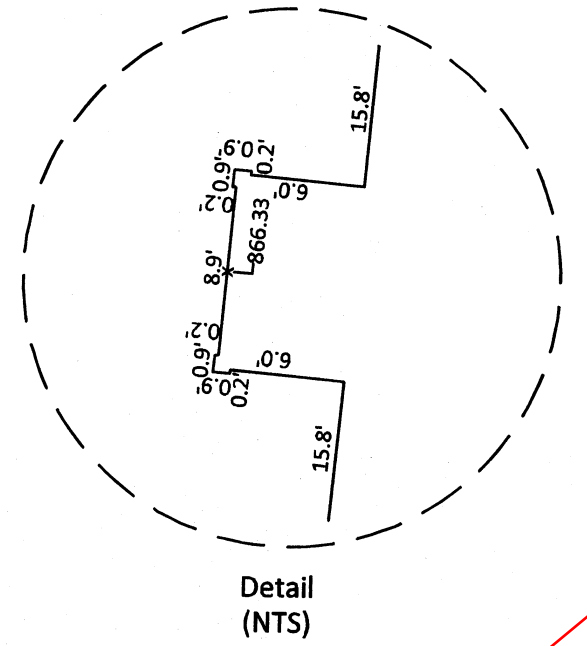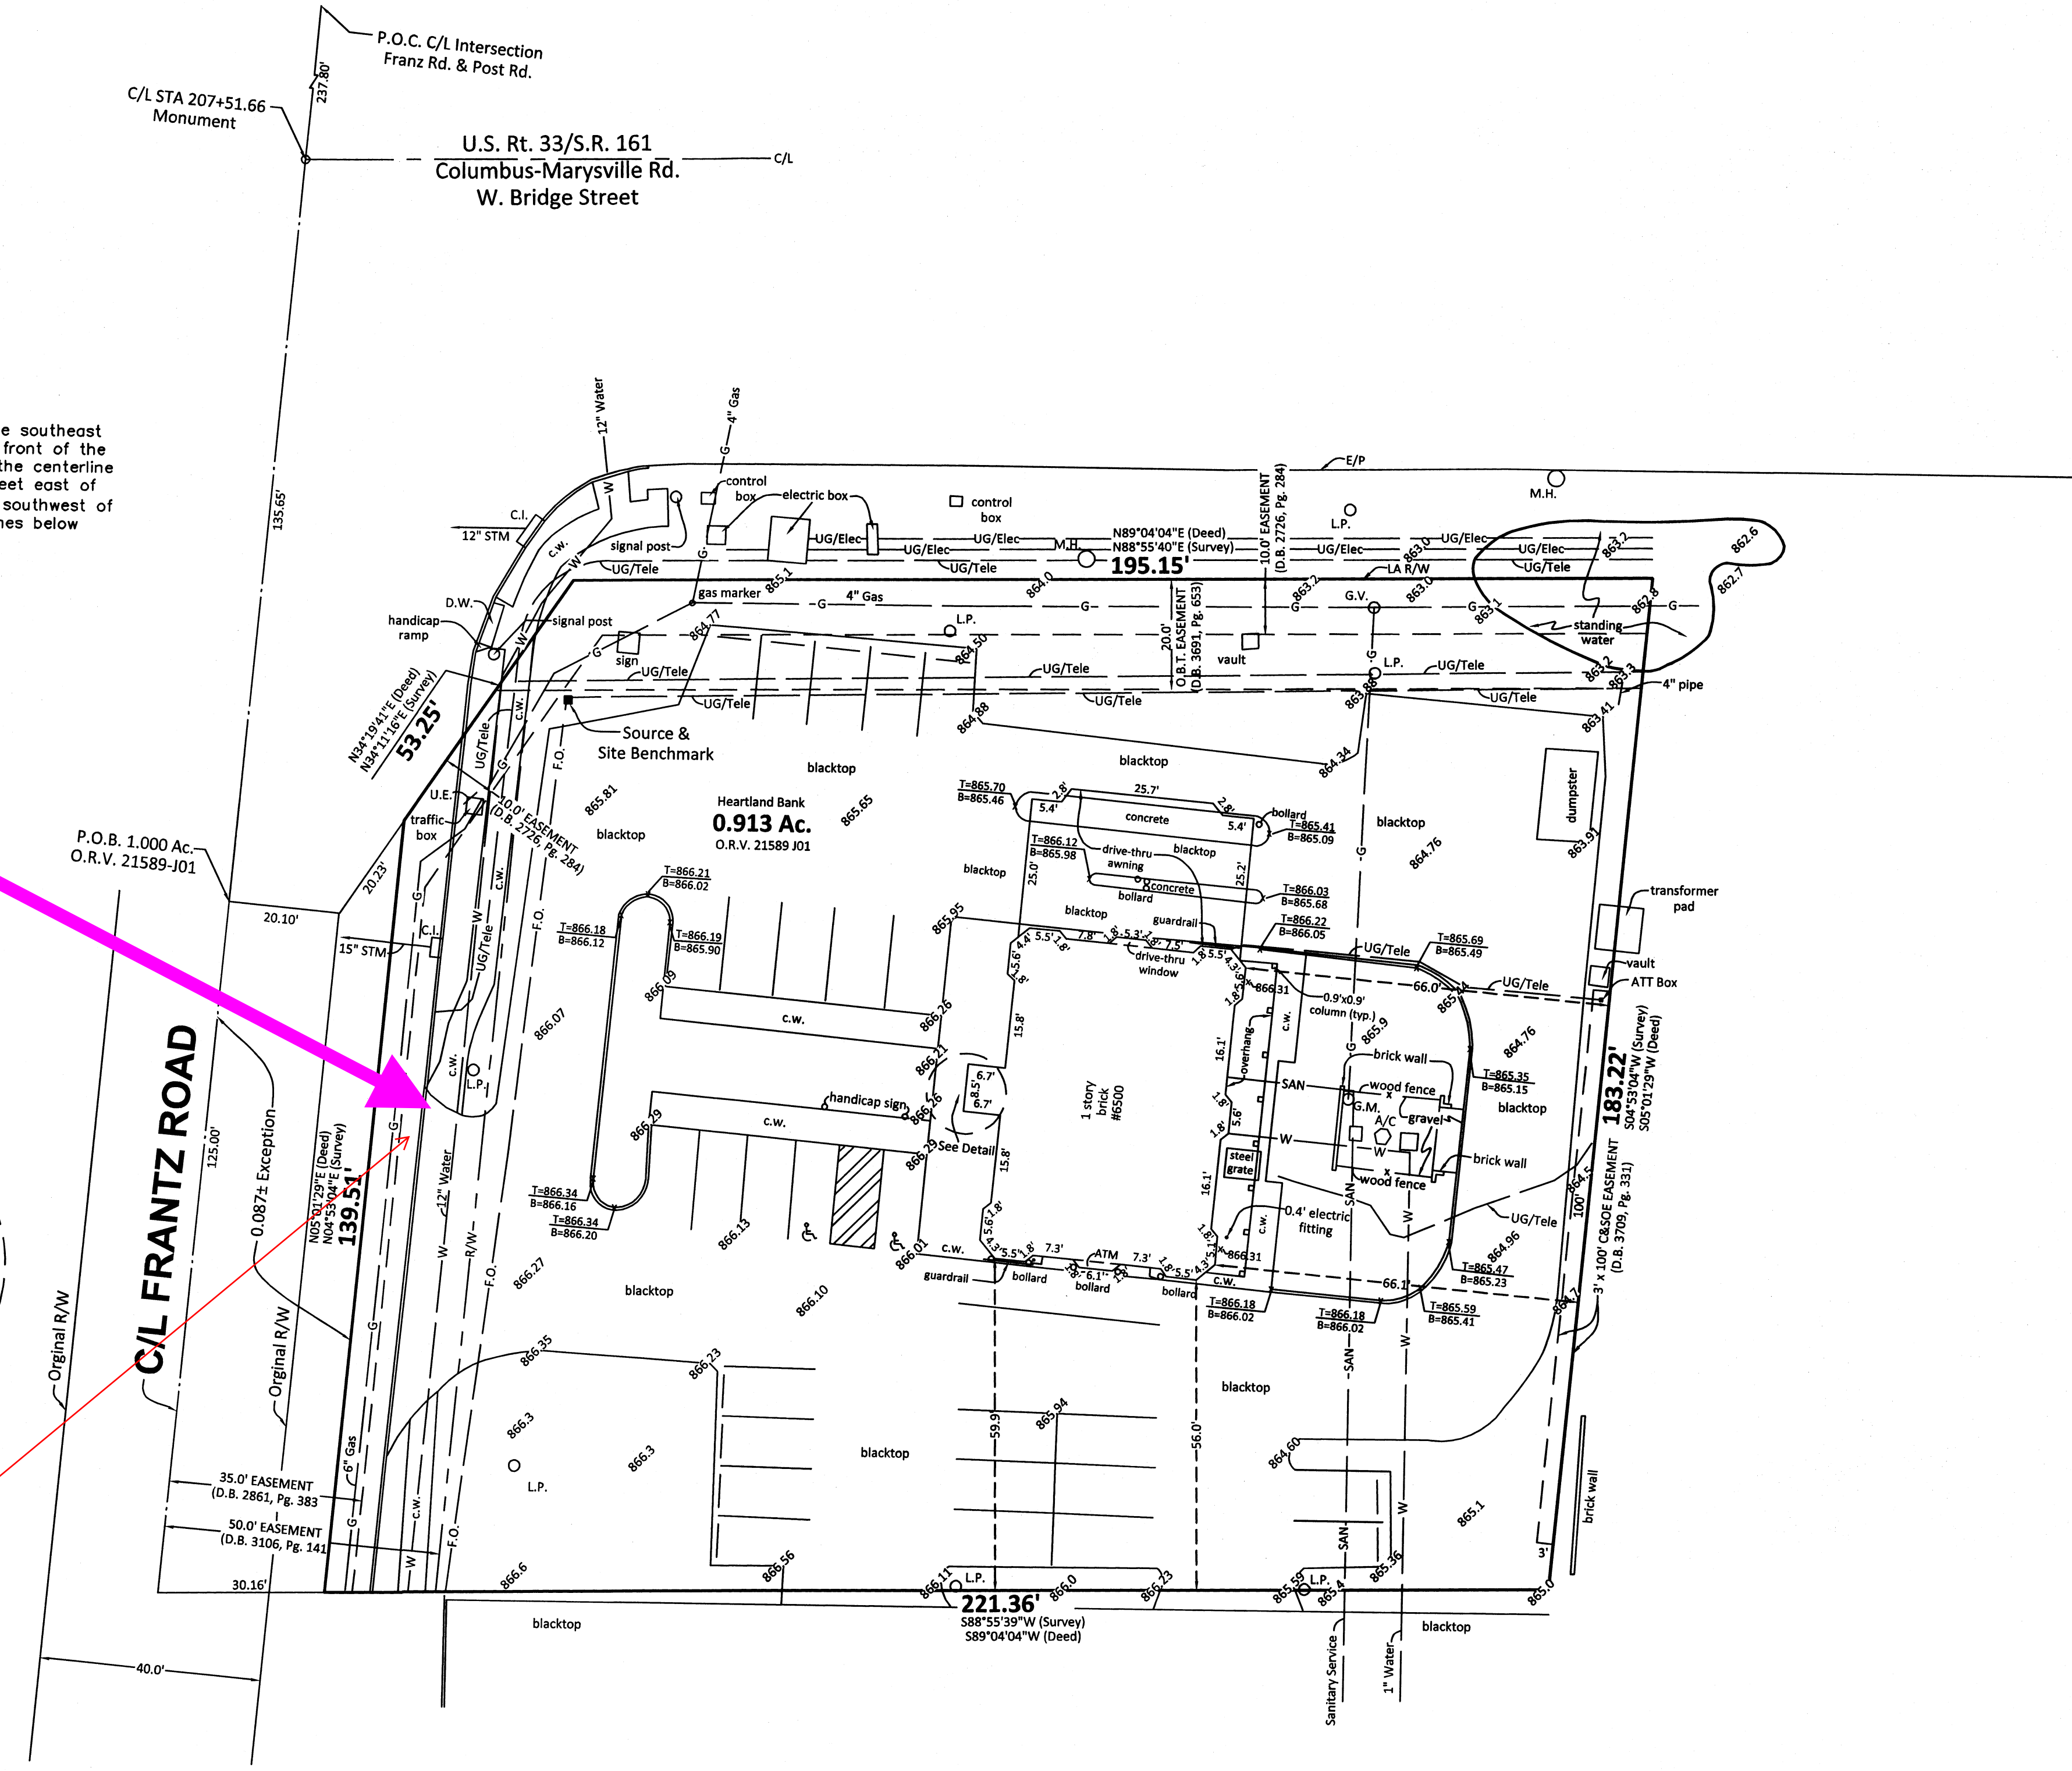

The owner has directed us that they do not want to disturb this part of the site


- EASEMENTS
 Lawyers Title Insurance Corporation
 Policy Date: January 20, 1993
 Policy Number: 113-00-763041
- Item 5. Easement to Columbus and Southern Ohio Electric Company over part of a larger tract of which insured premises is a part, of record in Deed Book 1127, page 69; Deed Book 1955, page 275; and Deed Book 2669, Page 3. All Do Not Apply.
 - Item 6. Easement to State of Ohio over part of a larger tract of which insured premises is a part, of record in Deed Book 2669, Page 396 - Wrong Page Number
 - Item 7. Easement to Columbia Gas of Ohio, Inc., over an unspecified location affecting a tract of land of which insured premises is a part, of record in Deed Book 2726, page 284 and Deed Book 2861, Page 383. PLOTTED
 - Item 8. Easement to County of Franklin, of record in Deed Book 3106, Page 141. PLOTTED
 - Item 9. Easement to Columbus and Southern Ohio Electric Company, of record in Deed Book 3709, Page 331. PLOTTED
 - Item 10. Easement to The Ohio Bell Telephone Company, of record in Deed Book 3691, Page 653. PLOTTED
 - Item 11. Easement to Southwick, Solove and Company, of record in Official Record 20376C19, Blanket Easement over drive areas and access to streets, highways and alleys.

Legend	
P.B.	= Plat Book
D.B.	= Deed Book
O.R.V.	= Official Records Volume
Inst.No.	= Instrument Number
RR Spk	= Railroad Spike
C/L	= Centerline
R/W	= Right-of-Way
LA, R/W	= Limited Access Right-of-Way
M.H.	= Manhole
C.B.	= Catch Basin
F.H.	= Fire Hydrant
U.P.	= Utility Pole
L.P.	= Light Pole
E	= Electric
U.E.	= Underground Electric
E.M.	= Electric Meter
E.T.	= Electric Transformer
G	= Gas
G.M.	= Gas Meter
G.V.	= Gas Valve
W	= Water
W.M.	= Water Meter
W.V.	= Water Valve
T.P.	= Telephone Pedestal
T	= Telephone
O.B.T.	= Ohio Bell Telephone
C&S/OE	= Cola. & Southern Ohio Electric
CATV	= Cable Television
R.P.	= Record Plan
San.	= Sanitary Sewer
Stm.	= Storm Sewer
Comb.	= Combination Sewer
T.C.	= Top of Coating
INV.	= Invert
c.w.	= Concrete Walk
c.s.	= Concrete Stoop/Steps
c.o.	= Cleanout
d.s.	= Downspout
868.4	= Spot Elevation 868.4
②	= Existing Striped Parking Space

To: Heartland Bank
 and/or
 Moody Engineering

We hereby certify that the foregoing Topographic Survey was prepared from field measurements in July, 2020. Basis of Bearings is the Ohio State Plane Coordinate System, Ohio South Zone, NAD83 (2011). The bearing herein are based on GPS observations using the CORS Network to determine a grid bearing of North 88°55'40" East for the south right of way of U.S. Rt. 33.

By: *Joseph P. Myers* 7/30/2020
 Joseph P. Myers, Professional Surveyor No. 7361

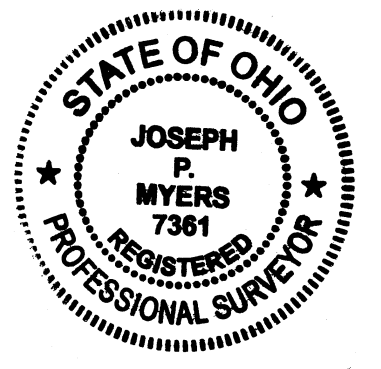


Utility Warning

THE UNDERGROUND UTILITIES SHOWN HAVE BEEN LOCATED FROM FIELD SURVEY INFORMATION AND EXISTING DRAWINGS. THE SURVEYOR MAKES NO GUARANTEE THE UNDERGROUND UTILITIES SHOWN COMPRISE ALL SUCH UTILITIES IN THE AREA, EITHER IN SERVICE OR ABANDONED. THE SURVEYOR FURTHER DOES NOT WARRANT THE UNDERGROUND UTILITIES SHOWN ARE IN THE EXACT LOCATION INDICATED, ALTHOUGH HE DOES CERTIFY THEY ARE LOCATED AS ACCURATELY AS POSSIBLE FROM THE INFORMATION AVAILABLE. THE SURVEYOR HAS NOT PHYSICALLY LOCATED THE UNDERGROUND UTILITIES.




Myers Surveying
 COMPANY
 2740 E. Main St., Bexley, Ohio 43209-2577
 (614) 235-8677 - (614) 235-4559 fax
 info@myerssurveying.com

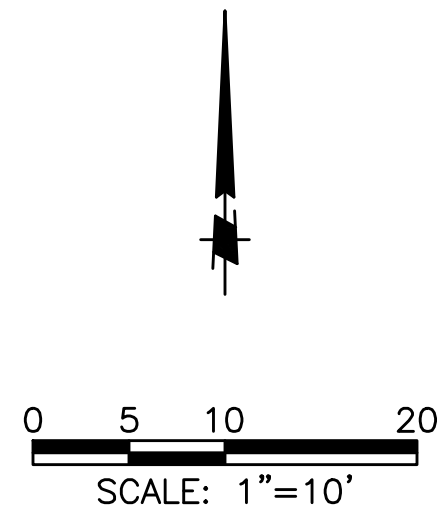

LEGEND


 CONCRETE SIDEWALK REMOVED AND REPLACED

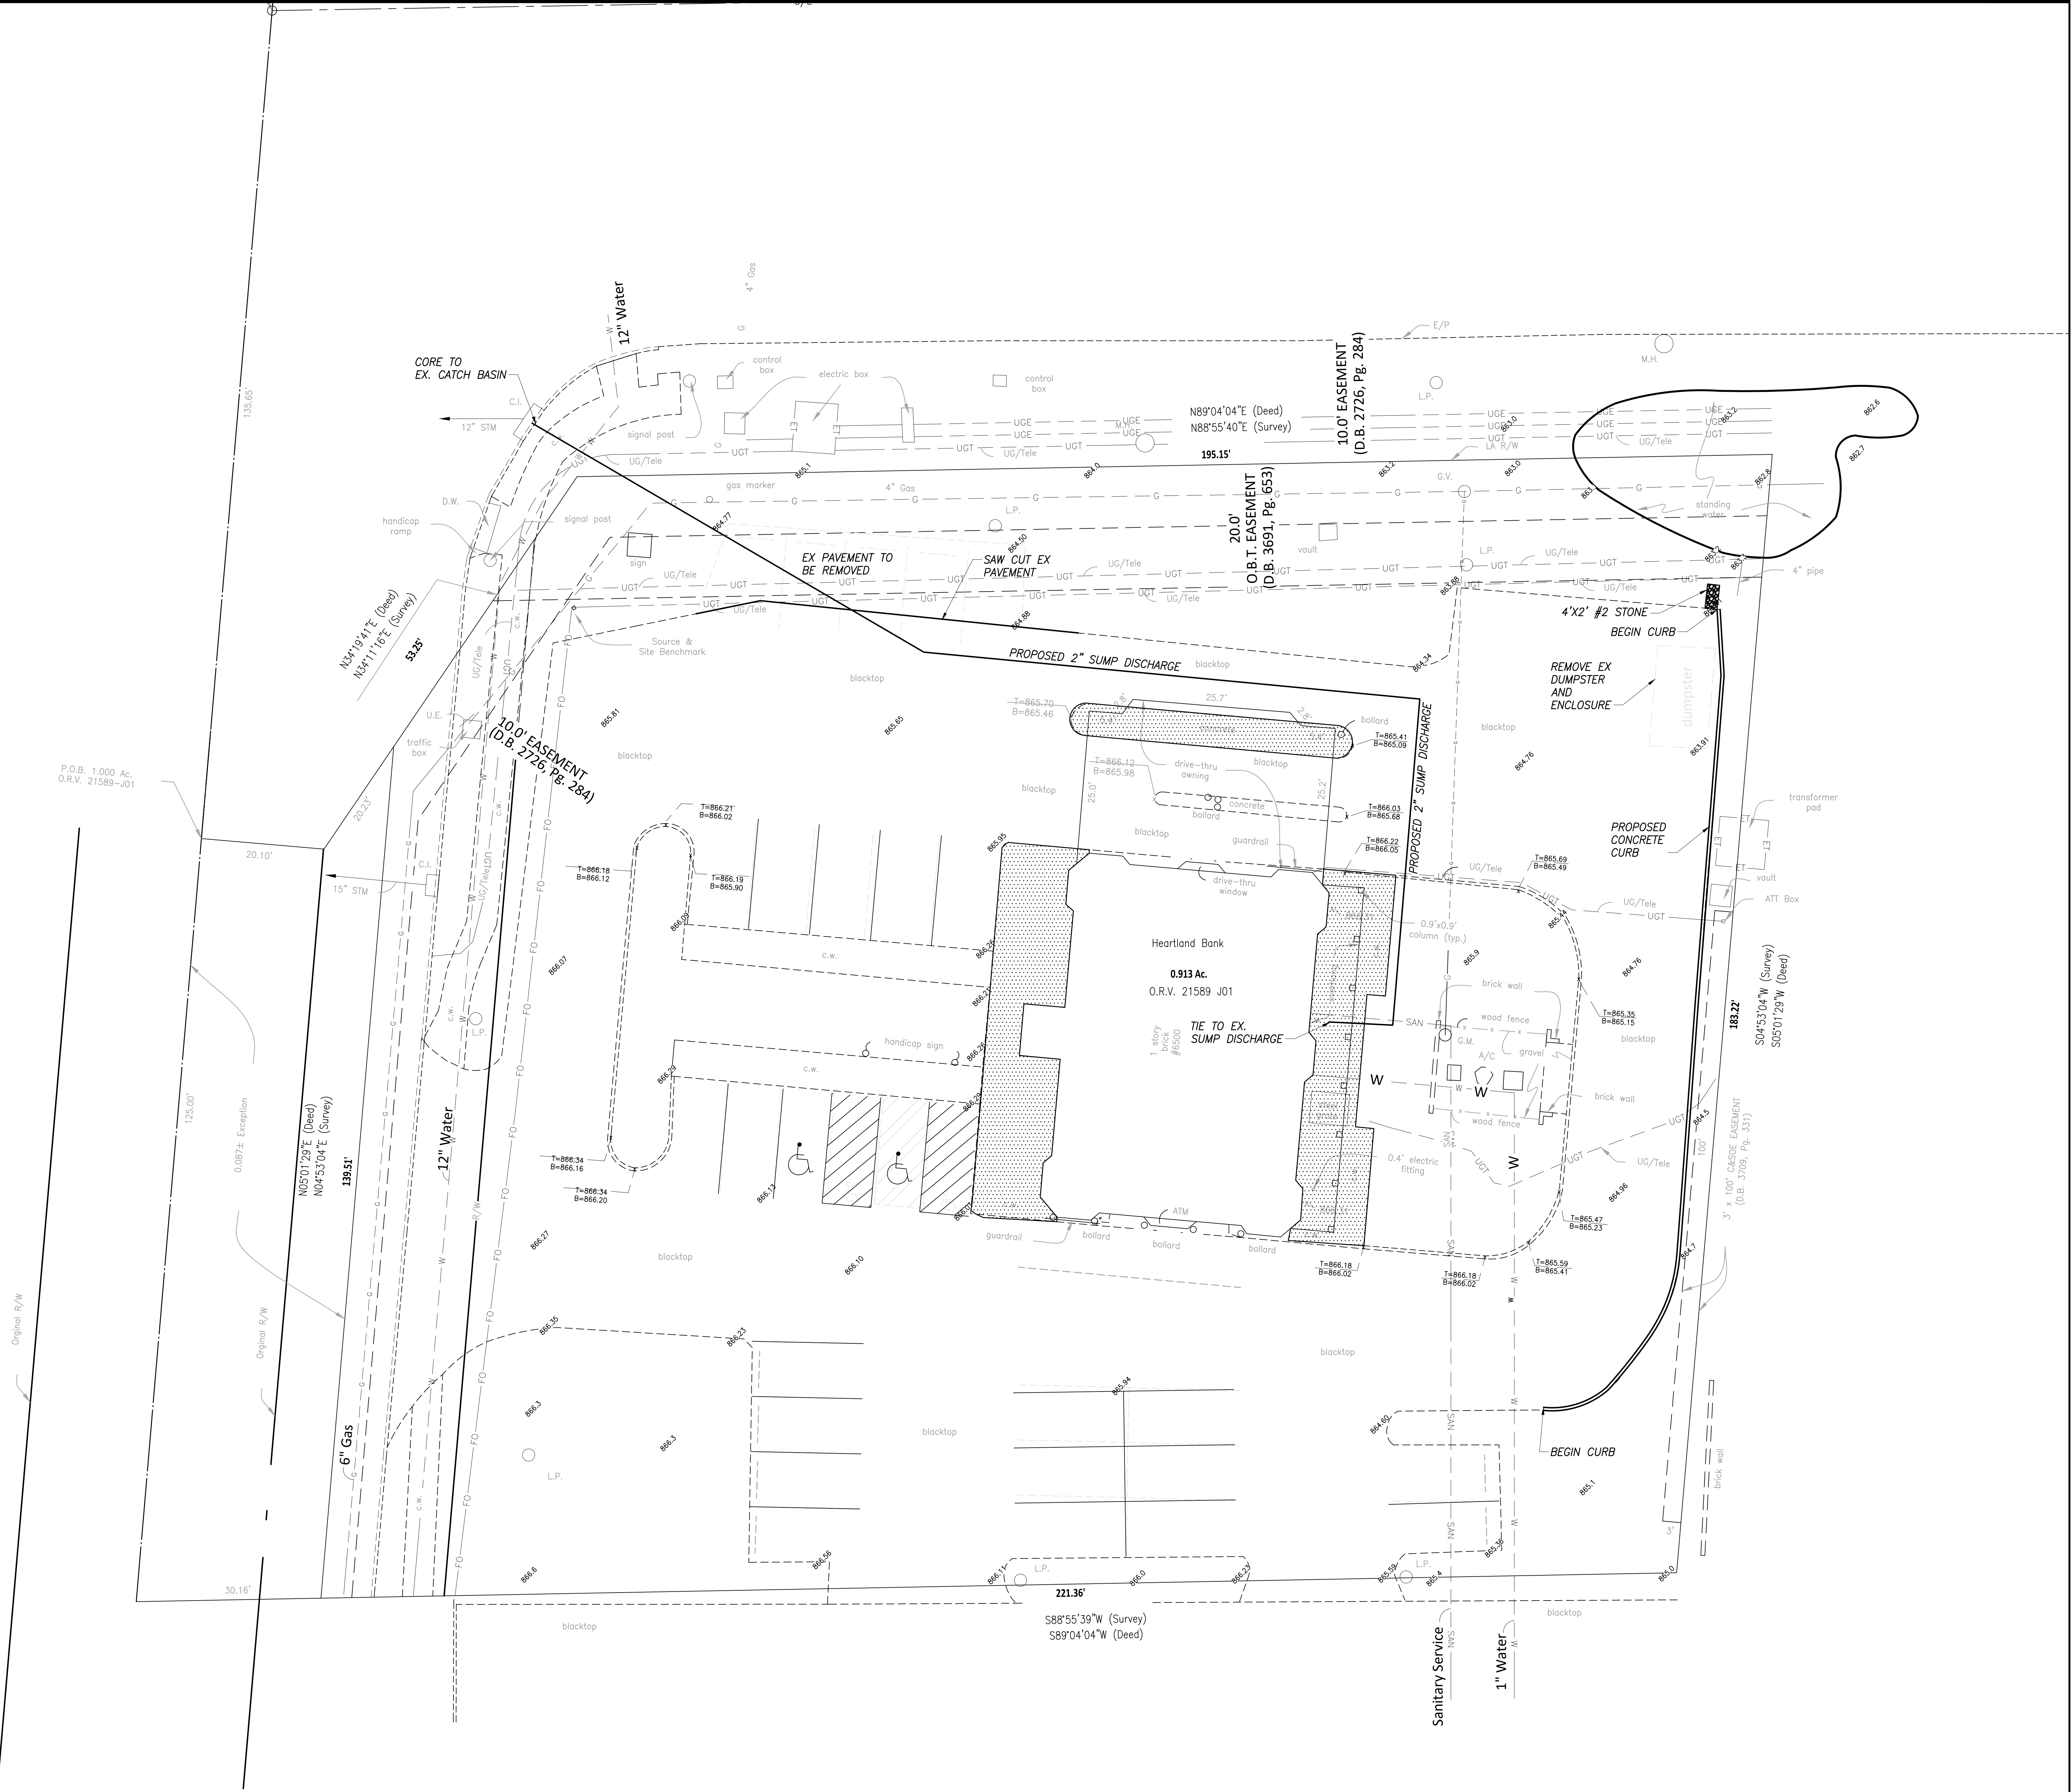

NOTE:
1) SEE ARCHITECTURAL SITE PLAN FOR PROPOSED LOT STRIPING

#	DATE	CHANGE DESCRIPTION


RENOVATION OF HEARTLAND BANK DUBLIN
 800 FRANTZ ROAD
 DUBLIN, OH 43017
 FOR
HEARTLAND BANK

 300 SPRUCE STREET
 SUITE 300
 COLUMBUS, OHIO 43215
 PHONE: (614) 461-4664
 FAX: (614) 280-8881

DRAWING TITLE: **CIVIL SITE PLAN**


PROGRESS DRAWING NOT FOR CONSTRUCTION	09/10/2020	
	DRAWN BY: MSL	CHECKED BY: MSL
	20022	
C100		
PRELIMINARY DEVELOPMENT PLAN		

WEST BRIDGE STREET

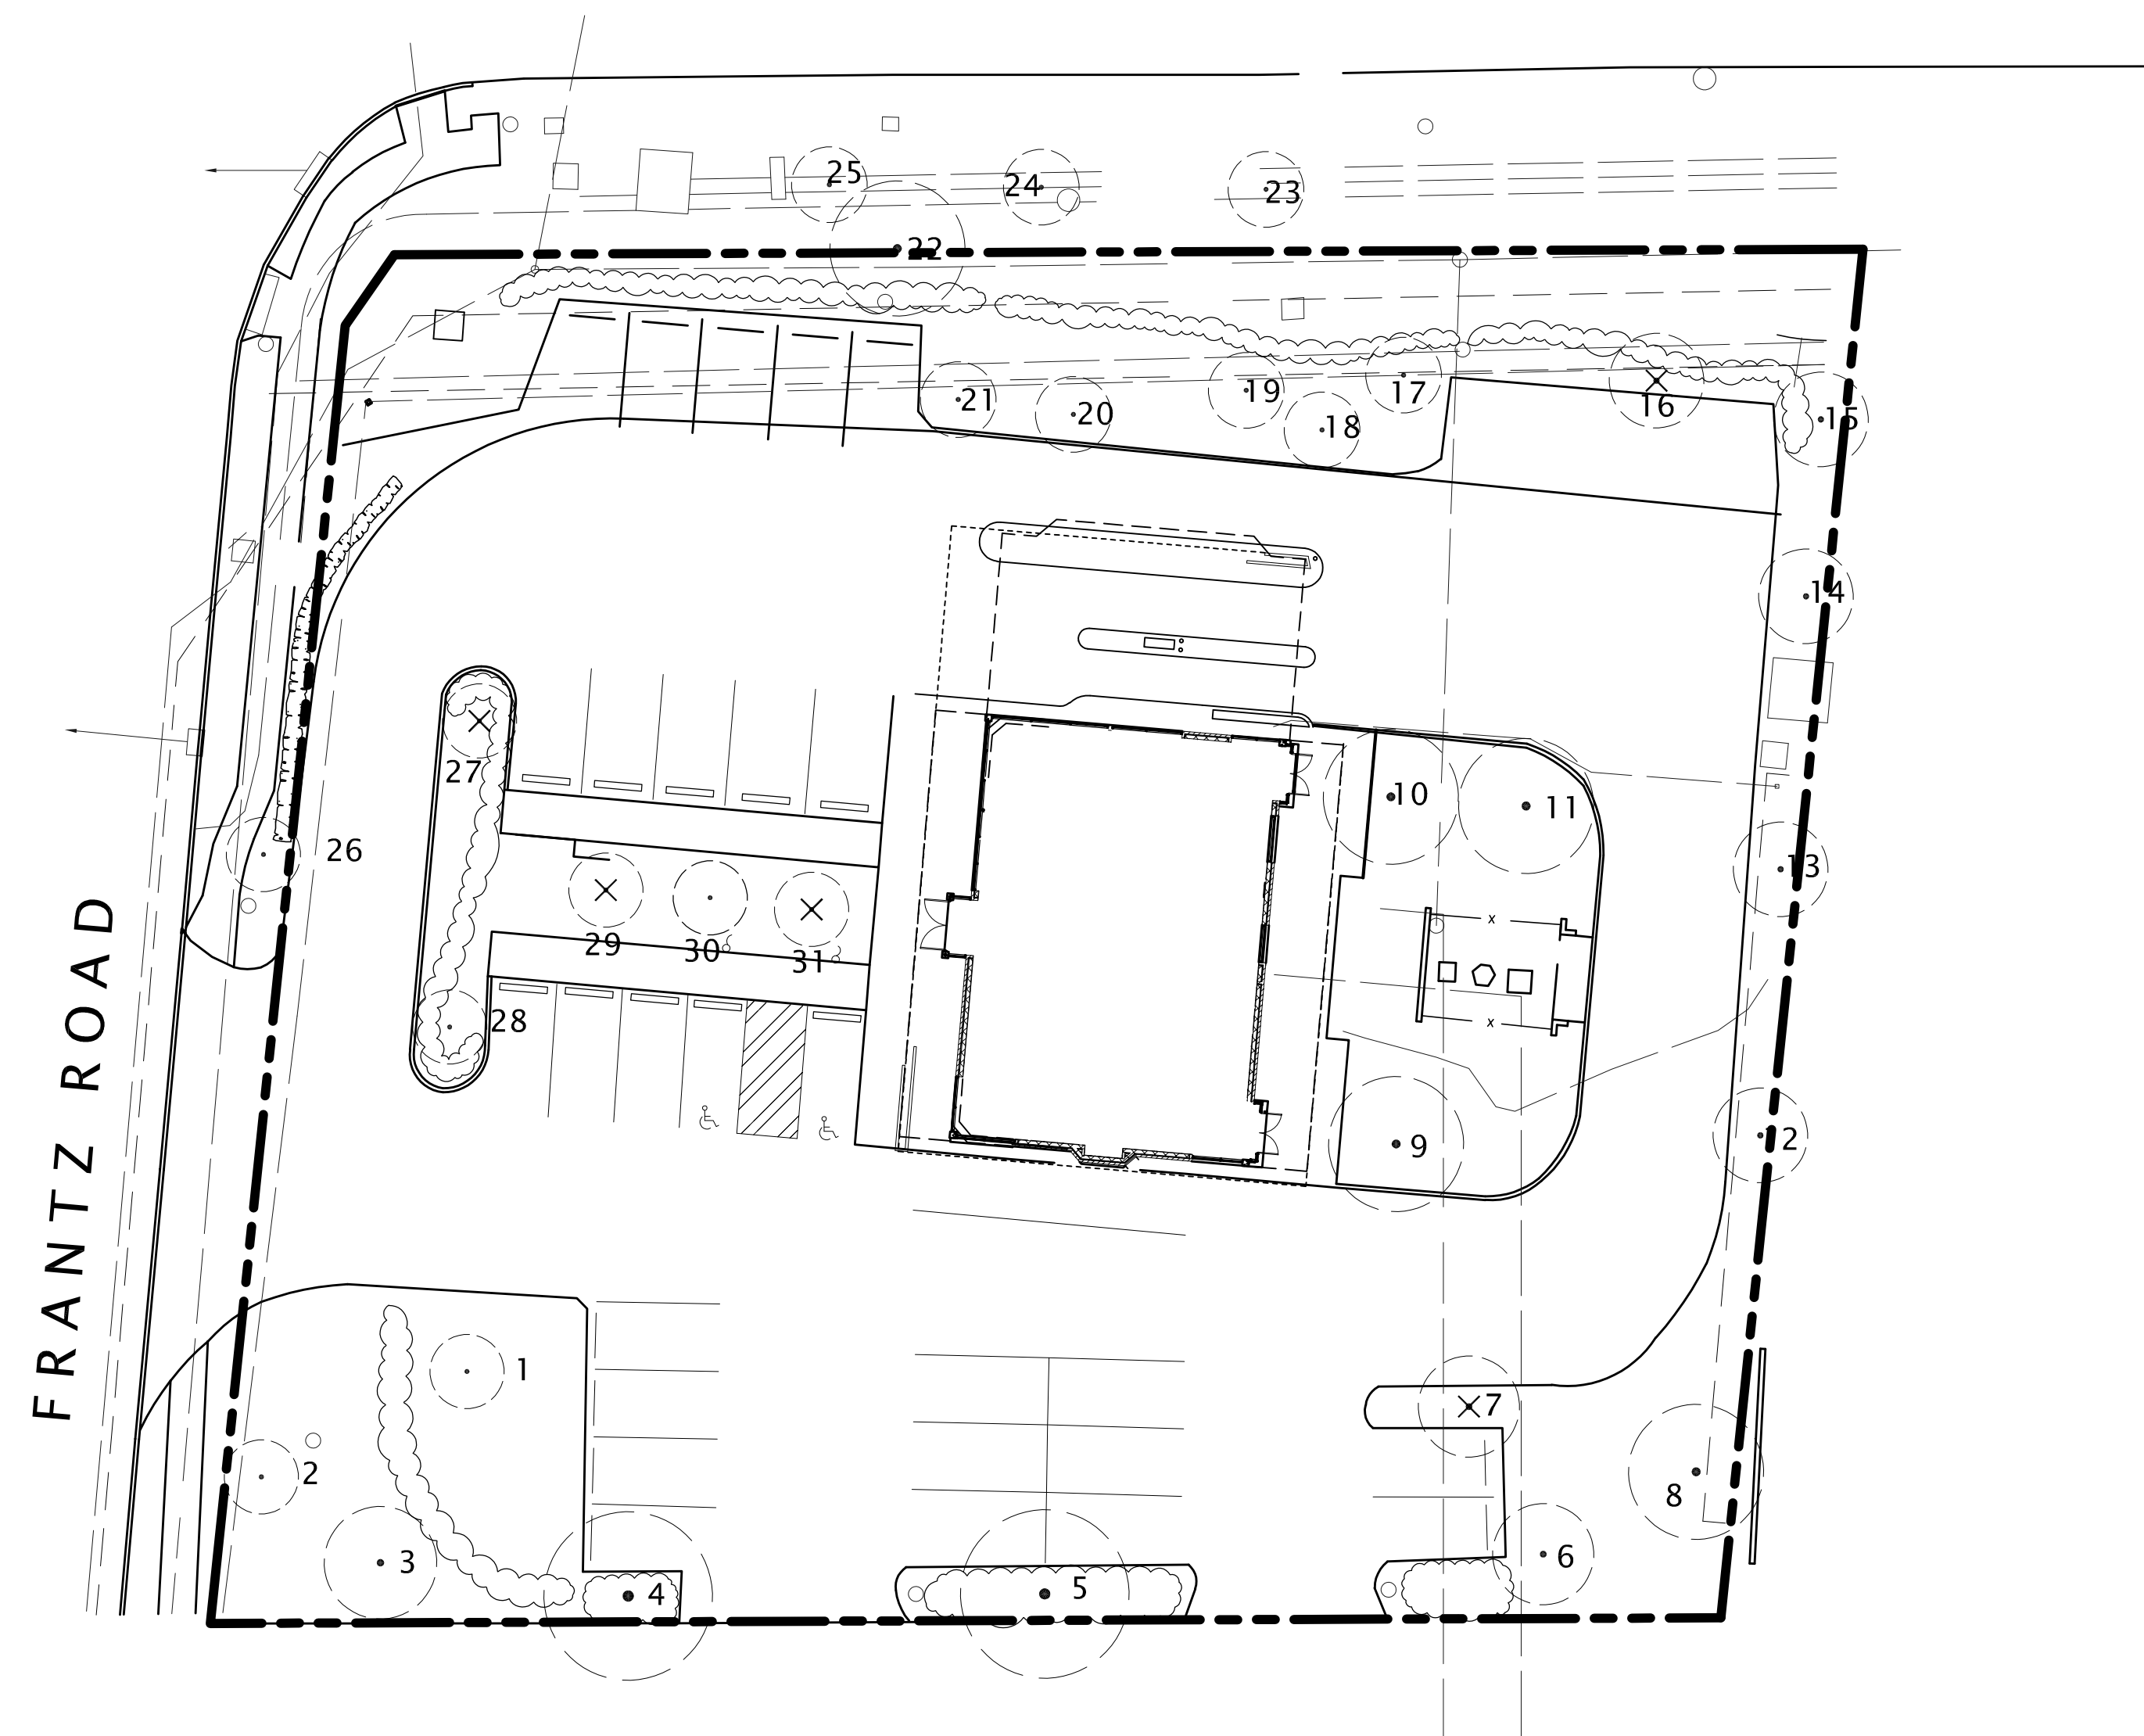


EXISTING TREE LEGEND

NO.	TREE TYPE	SIZE	CONDITION	
1	GINKGO	2" CALIPER	GOOD	RETAIN
2	CRABAPPLE	3" CALIPER	GOOD	RETAIN
3	ZELCOVA	4" CALIPER	GOOD	RETAIN
4	ZELCOVA	6" CALIPER	GOOD	RETAIN
5	ZELCOVA	6" CALIPER	GOOD	RETAIN
6	ZELCOVA	3" CALIPER	GOOD	RETAIN
7	OAK	3" CALIPER	POOR	REPLACE
8	MAPLE	20" CALIPER	GOOD	RETAIN
9	HONEYLOCUS	15" CALIPER	GOOD	RETAIN
10	HONEYLOCUS	17" CALIPER	GOOD	RETAIN
11	HONEYLOCUS	15" CALIPER	GOOD	RETAIN
12	PEAR	6" CALIPER	GOOD	RETAIN
13	PEAR	6" CALIPER	GOOD	RETAIN
14	PEAR	6" CALIPER	GOOD	RETAIN
15	PEAR	6" CALIPER	GOOD	RETAIN
16	ZELCOVA	4" CALIPER	POOR	REPLACE
17	ZELCOVA	3" CALIPER	GOOD	RETAIN
18	GINKGO	1" CALIPER	GOOD	RETAIN
19	ZELCOVA	11" CALIPER	GOOD	RETAIN
20	GINKGO	2" CALIPER	GOOD	RETAIN
21	GINKGO	2" CALIPER	GOOD	RETAIN
22	OAK	24" CALIPER	GOOD	RETAIN
23	LILAC	4" CALIPER	GOOD	RETAIN
24	LILAC	5" CALIPER	GOOD	RETAIN
25	LILAC	8" CALIPER	GOOD	RETAIN
26	LILAC	3" CALIPER	GOOD	RETAIN
27	MAPLE	5" CALIPER	POOR	REPLACE
28	LINDEN	5" CALIPER	GOOD	RETAIN
29	MAGNOLIA	5" CALIPER	GOOD	REMOVE
30	MAGNOLIA	5" CALIPER	GOOD	RETAIN
31	MAGNOLIA	5" CALIPER	GOOD	REMOVE

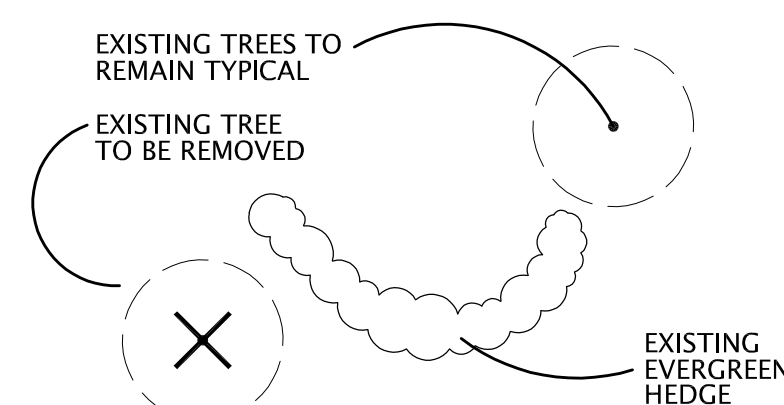

TREE LEGEND

1 TREE DEMOLITION AND PRESERVATION PLAN

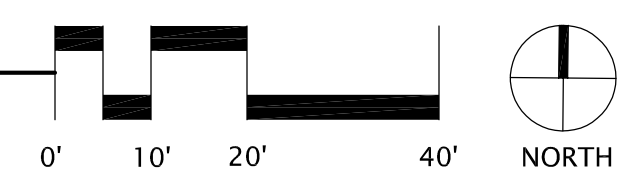


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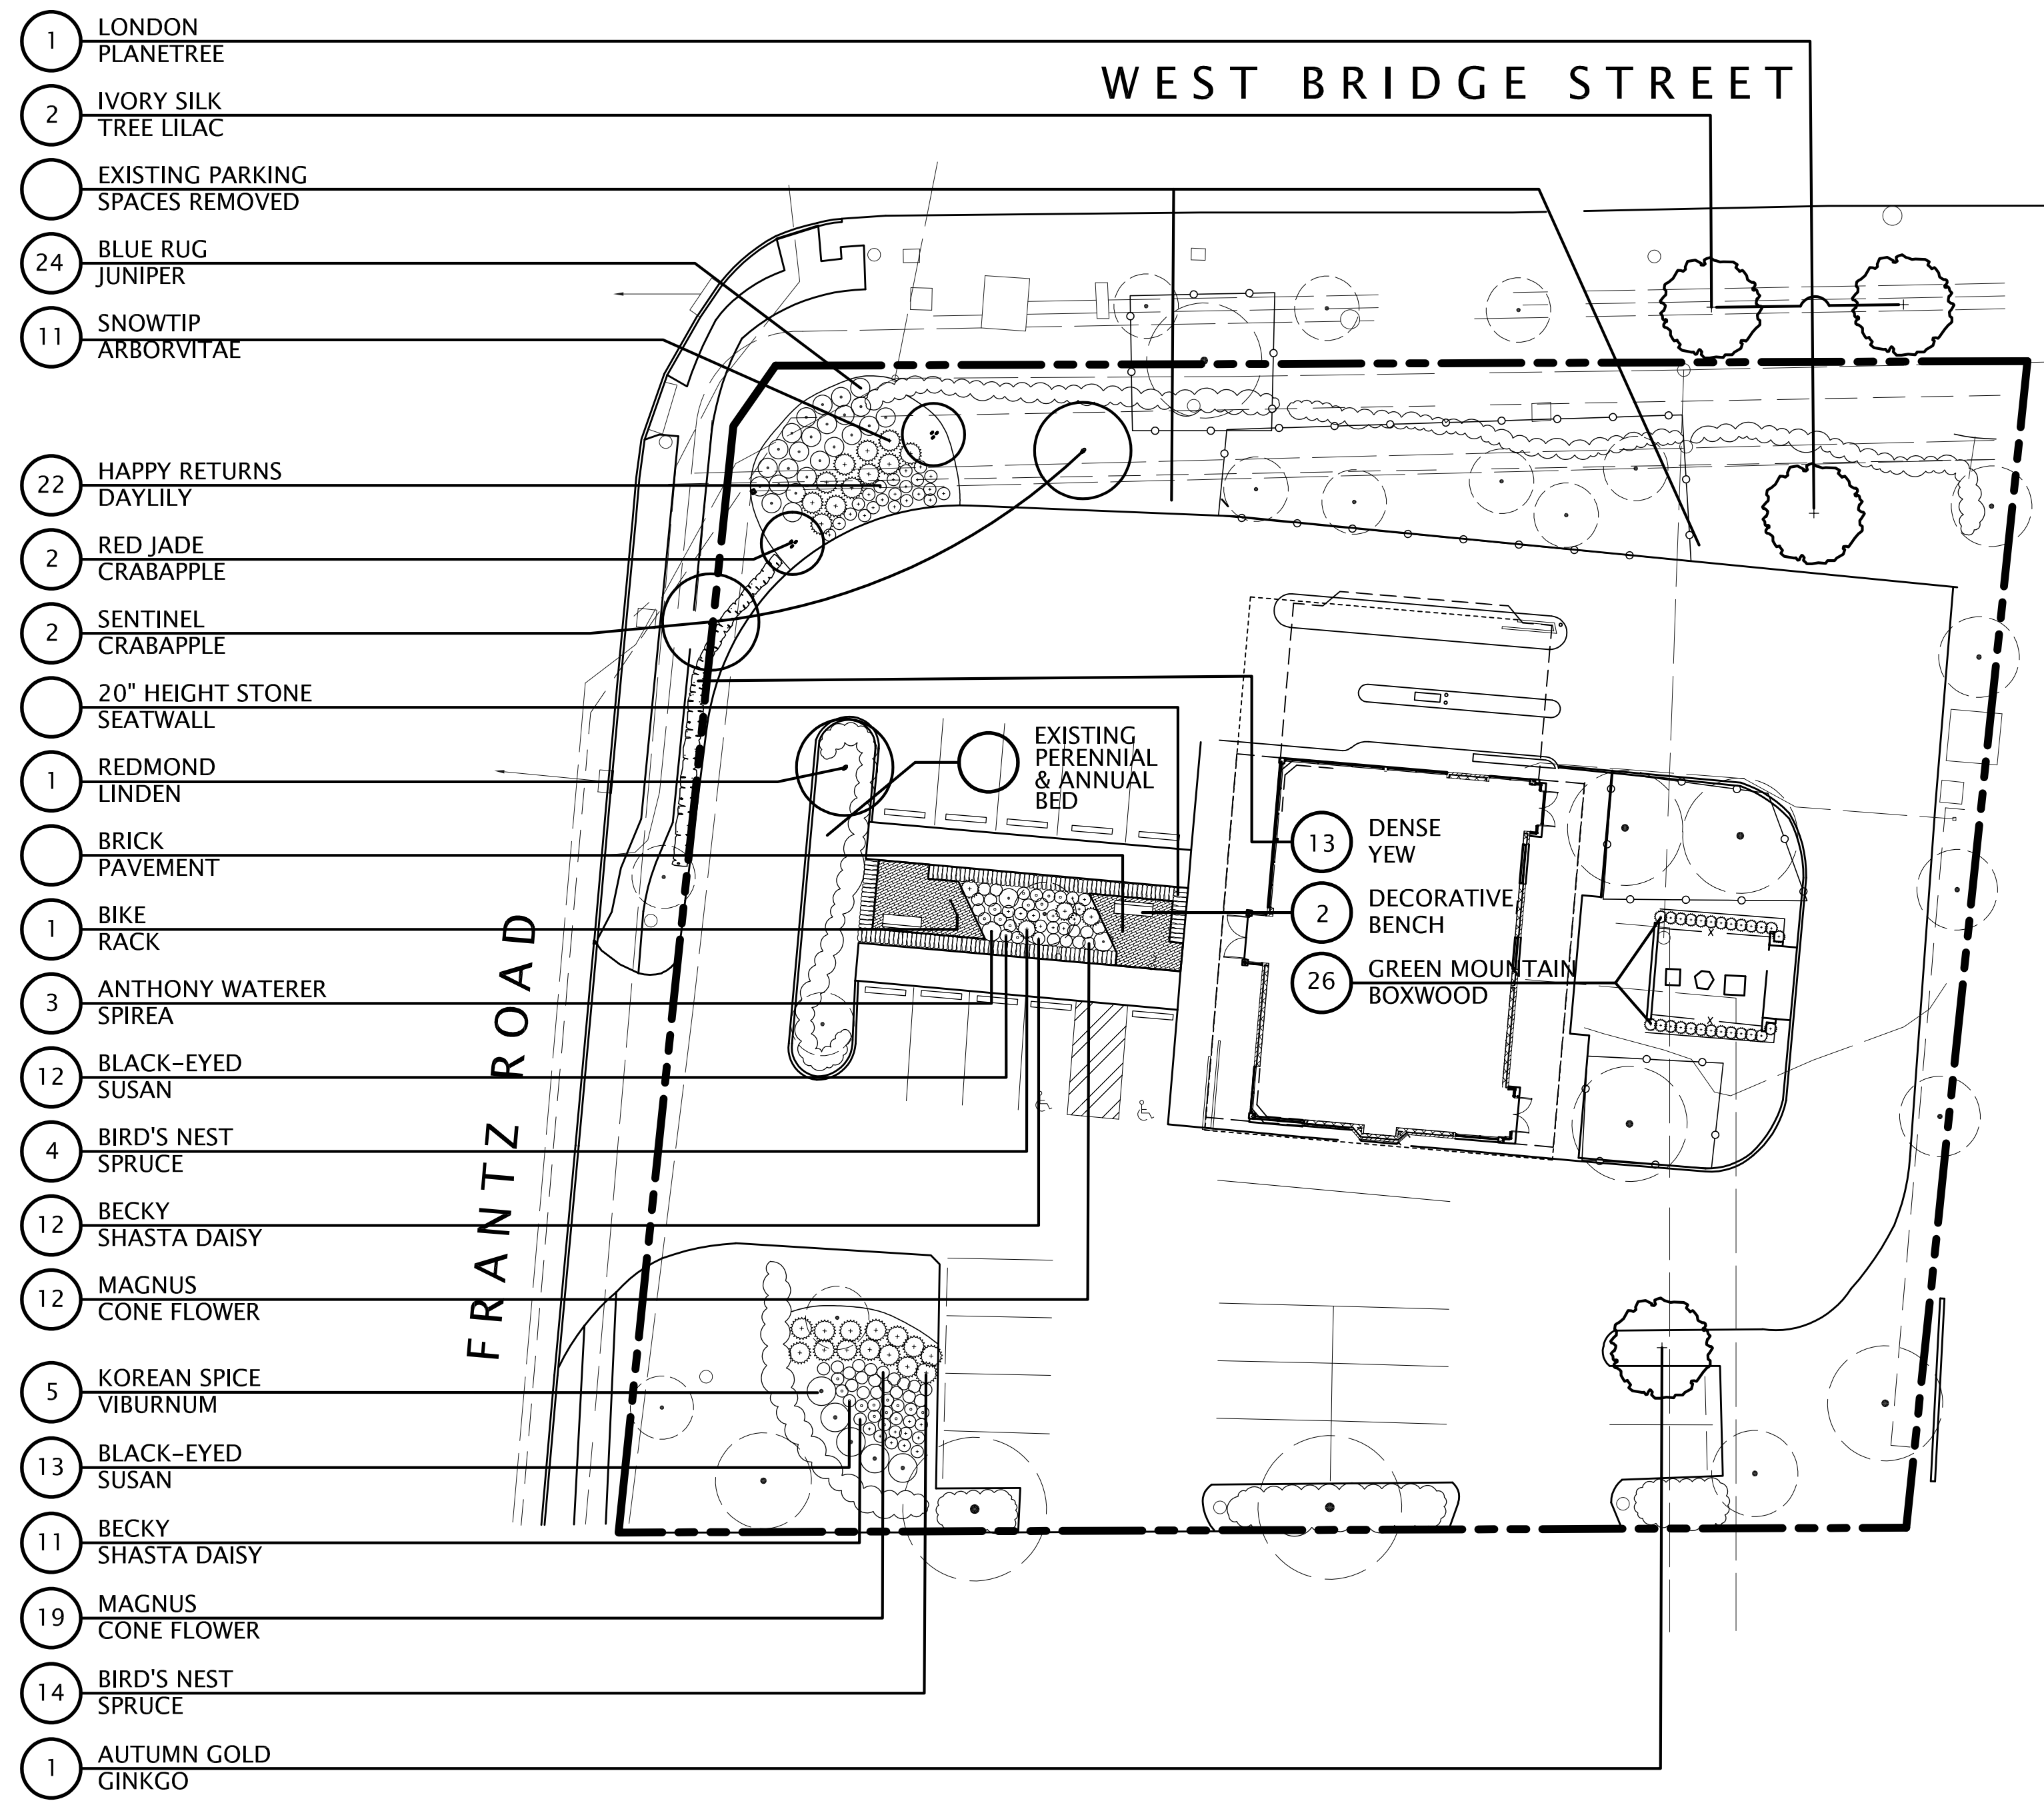
RENOVATION OF HEARTLAND BANK DUBLIN
 5500 FRANTZ ROAD
 DUBLIN, OH 43077
 FOR
HEARTLAND BANK

MOODY-NOLAN
 300 SPRUCE STREET
 SUITE 300
 COLUMBUS, OHIO 43215
 PHONE: (614) 461-4664
 FAX: (614) 280-8881

DRAWING TITLE:
TREE DEMOLITION AND PRESERVATION PLAN

PROGRESS DRAWING NOT FOR CONSTRUCTION	08/21/2020
	DRAWN BY: GJK CHECKED BY: GJK
	2022
L1.01	
PRELIMINARY DEVELOPMENT PLAN	



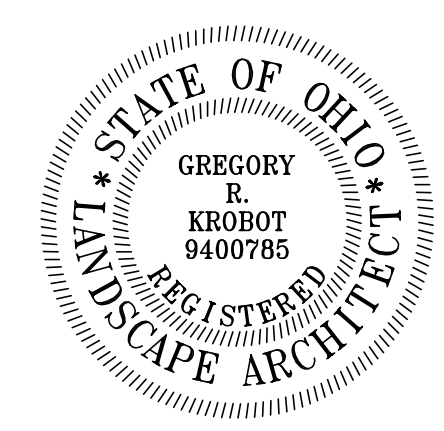


- 1 LONDON PLANETREE
- 2 IVORY SILK TREE LILAC
- EXISTING PARKING SPACES REMOVED
- 24 BLUE RUG JUNIPER
- 11 SNOWTIP ARBORVITAE

- 22 HAPPY RETURNS DAYLILY
- 2 RED JADE CRABAPPLE
- 2 SENTINEL CRABAPPLE
- 20" HEIGHT STONE SEATWALL
- 1 REDMOND LINDEN
- BRICK PAVEMENT
- 1 BIKE RACK
- 3 ANTHONY WATERER SPIREA
- 12 BLACK-EYED SUSAN
- 4 BIRD'S NEST SPRUCE
- 12 BECKY SHASTA DAISY
- 12 MAGNUS CONE FLOWER
- 5 KOREAN SPICE VIBURNUM
- 13 BLACK-EYED SUSAN
- 11 BECKY SHASTA DAISY
- 19 MAGNUS CONE FLOWER
- 14 BIRD'S NEST SPRUCE
- 1 AUTUMN GOLD GINKGO


PLANT MATERIALS LIST

QTY.	COMMON NAME	BOTANICAL NAME	SIZE	ROOT
TREES				
5	SKYLINE HONEYLOCUST	Geditsia t. i. 'Skyline'	2 1/2" Cal.	B&B
3	SOMERSET MAPLE	Acer rubrum 'Somerset'	2 1/2" Cal.	B&B
1	REDMOND LINDEN	Tilia americana 'Redmond'	2 1/2" Cal.	B&B
1	LONDON PLANETREE	Platanus x acerifolia	2 1/2" Cal.	B&B
2	IVORY SILK TREE LILAC	Syringa reticulata 'Ivory Silk'	2" Cal.	B&B
2	RED JADE CRABAPPLE	Malus 'Red Jade'	1 3/4" Cal.	B&B
2	SENTINEL CRABAPPLE	Malus 'Sentinel'	1 3/4" Cal.	B&B
1	AUTUMN GOLD GINKGO	Ginkgo 'Autumn Gold'	2 1/2" Cal.	B&B
SHRUBS				
11	SNOWTIP ARBORVITAE	Thuja occidentalis 'Snowtip'	5' Hgt.	B&B
13	DENSE YEW	Taxus x media 'Densiformis'	24" Hgt.	B&B
24	BLUE RUG JUNIPER	Juniperus horizontalis 'Blue Rug'	18" Spr.	Cont.
18	BIRD'S NEST SPRUCE	Picea abies 'Nidiformis'	15" Spr.	Cont.
5	KOREAN SPICE VIBURNUM	Viburnum carlesii	24" Hgt.	Cont.
3	ANTHONY WATERER SPIREA	Spiraea 'Anthony Waterer'	24" Spr.	Cont.
23	BECKY SHASTA DAISY	Leucanthemum x superbum 'Becky'	Clump	#2 Cont.
25	BLACK-EYED SUSAN	Rudbeckia fulgida 'Goldsturm'	Clump	#2 Cont.
31	MAGNUS CONE FLOWER	Echinacea 'Magnus'	Clump	#2 Cont.
22	HAPPY RETURNS DAYLILY	Hemerocallis 'Happy Returns'	Clump	#2 Cont.
26	GREEN MOUNTAIN BOXWOOD	Buxus x 'Green Mountain'	24" Hgt.	Hgt.

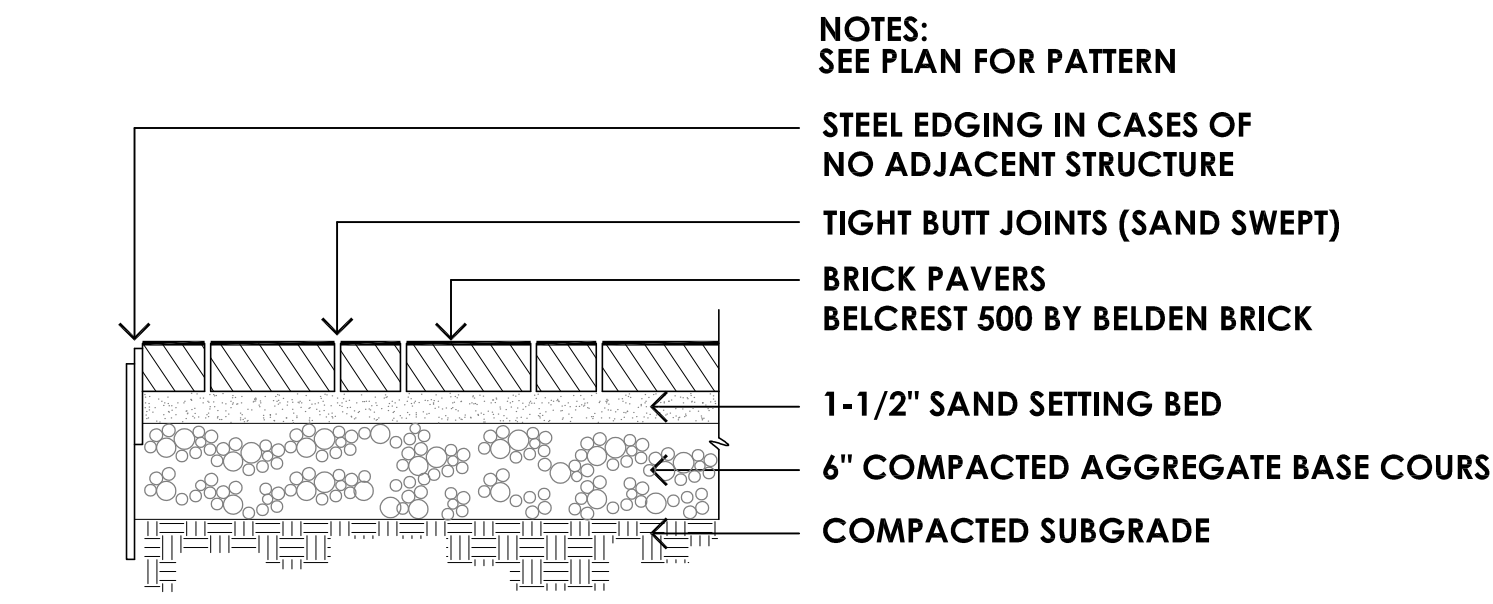


5 DRY LAID BRICK PAVEMENT
NTS

1 SITE LANDSCAPE PLAN
0' 10' 20' 40' NORTH

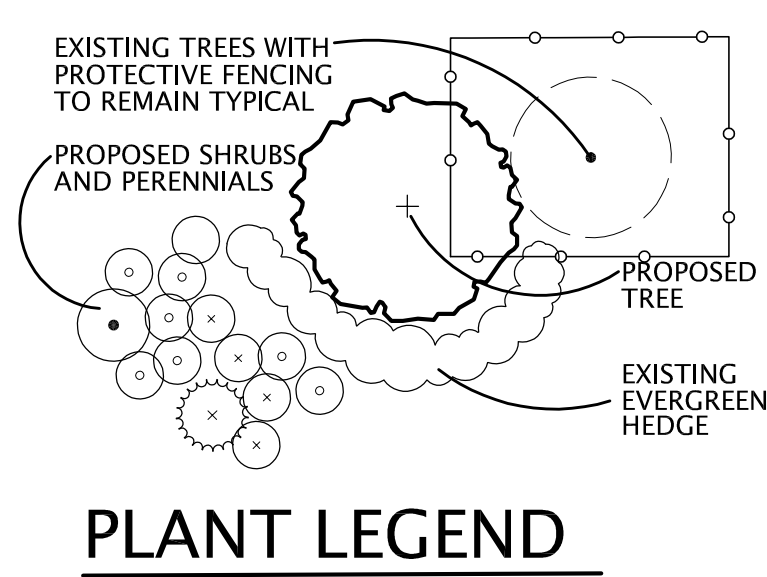


PLANT LEGEND

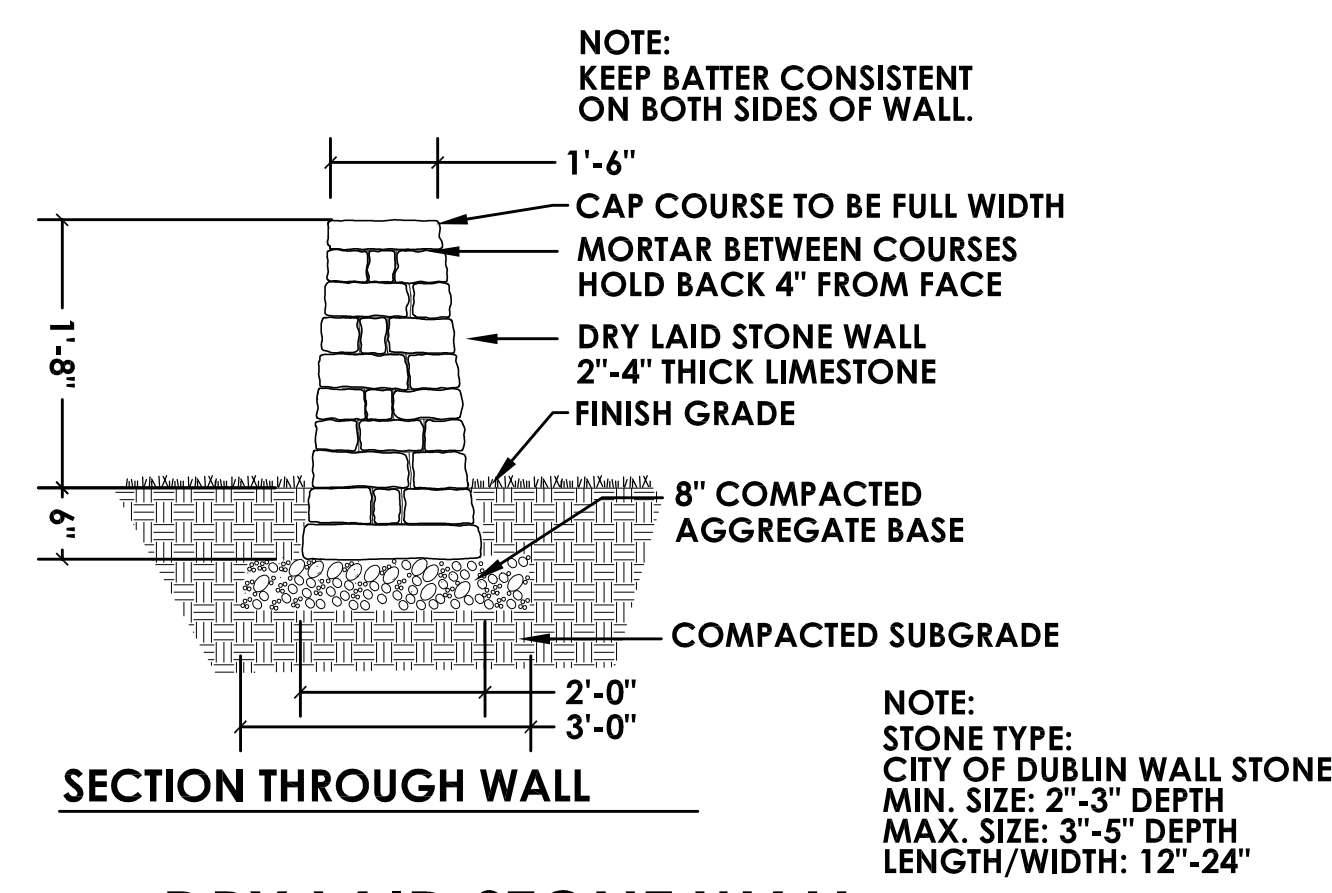


2 DRY LAID STONE WALL
NTS



3 6' SCARBOROUGH BENCH
BY LANDSCAPE FORMS

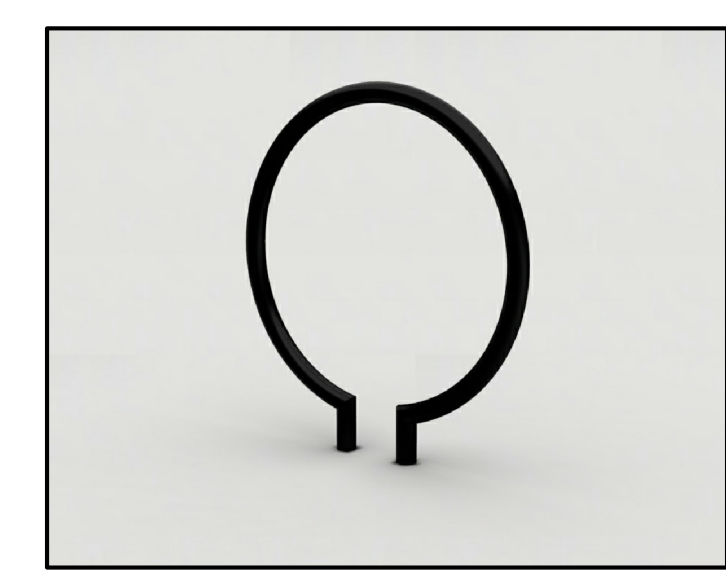

4 RING BIKE RACK
BY LANDSCAPE FORMS

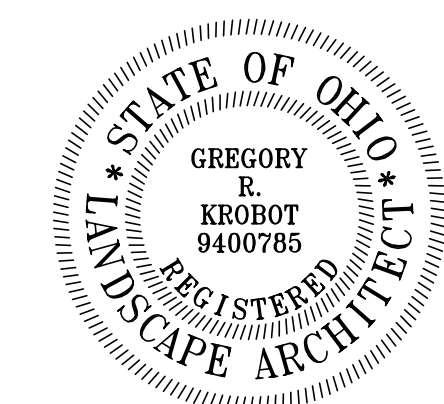

#	DATE	CHANGE DESCRIPTION

RENOVATION OF HEARTLAND BANK DUBLIN
5505 FRANTZ ROAD
DUBLIN, OH 43017
FOR
HEARTLAND BANK


300 SPRUCE STREET
SUITE 300
COLUMBUS, OHIO 43215
PHONE: (614) 461-4664
FAX: (614) 280-8881

SITE LANDSCAPE PLAN

08/21/2020
DRAWN BY: GJK | CHECKED BY: GJK
20022

PROGRESS DRAWING NOT FOR CONSTRUCTION

L1.02
PRELIMINARY DEVELOPMENT PLAN

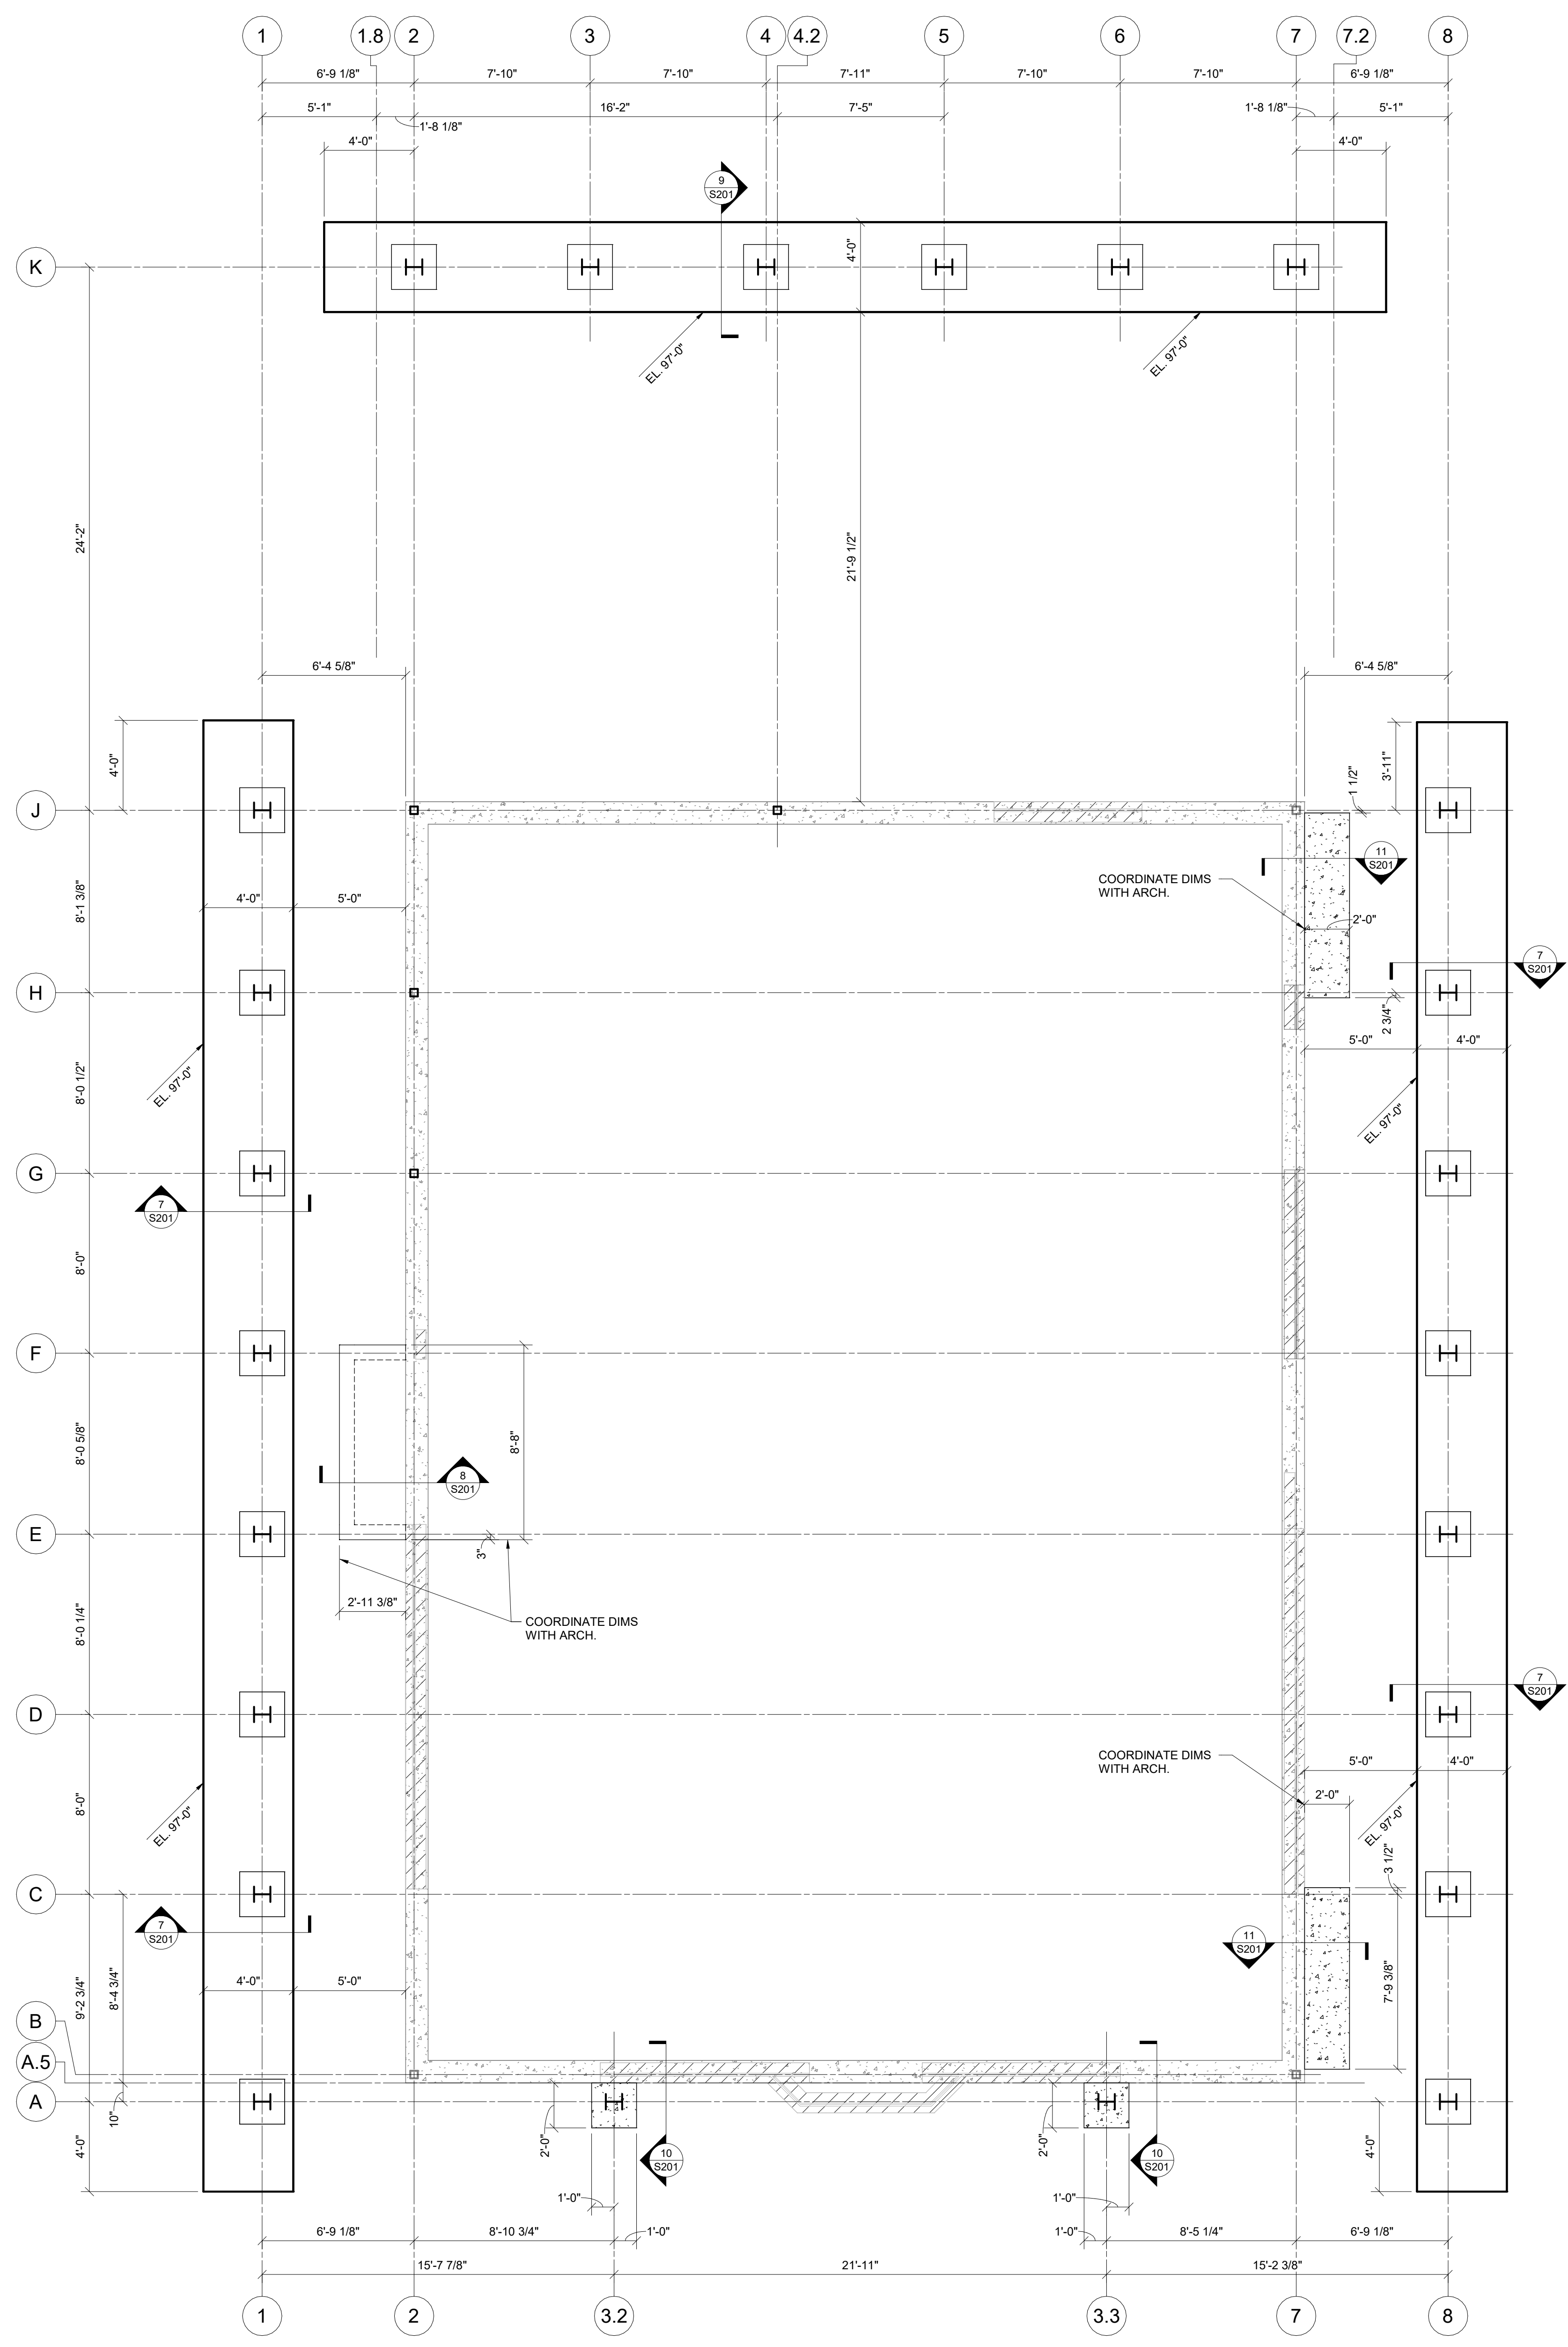

FOUNDATION/FIRST FLOOR FRAMING PLAN

1/4" = 1'-0"

FOUNDATION NOTES

- DESIGN SOIL BEARING PRESSURE = 3,000 PSF. SEE S001 FOR REFERENCE SOILS REPORT INFORMATION. REFERENCE THIS REPORT FOR ANY REQUIRED SITE BUILDING PREPARATION PRIOR TO FOUNDATION AND/OR SLAB ON GROUND CONSTRUCTION. FOOTING LOCATIONS MAY BE REQUIRED TO EXTEND THROUGH EXISTING FILL, RESULTING IN THEM TO BEAR ON SUITABLE MATERIAL. OVER-ELEVATIONS ARE TO BE FILLED WITH LEAN CONCRETE UP TO THE PLANNED BOTTOM OF FOOTING ELEVATION. PLACE NO CONCRETE PRIOR TO INSPECTION AND APPROVAL OF BEARING SURFACES BY SOILS ENGINEER.
- KEEP FOUNDATIONS FREE OF WATER AT ALL TIMES. REPLACE WEAKENED SOIL WITH LEAN CONCRETE OR FLOWABLE FILL.
- BOTTOM OF FOOTINGS ARE TO BE AT LEAST 36 INCHES BELOW THE ADJACENT EXTERIOR FINISHED GRADE FOR Frost Protection.
- ELEVATIONS SHOWN ON FOOTINGS INDICATE ELEVATION AT TOP OF FOOTING. REFERENCE ELEVATION TOP OF CONCRETE SLAB ELEVATION AS NOTED ON PLANS. COORDINATE ABSOLUTE ELEVATION OF TOP OF SLAB WITH SITE DRAWINGS.
- PROVIDE CORNER BARS AT ALL FOOTING AND CONCRETE WALL INTERSECTIONS PER DETAIL S101.
- SEE SECTION 41001 FOR TYPICAL INDOOR AND OUTDOOR MECHANICAL EQUIPMENT PADS.
- EXISTING BUILDING STRUCTURE SHOWN IS BASED ON LIMITED FIELD INVESTIGATION. EXISTING CONDITIONS, DIMENSIONS, ELEVATIONS, ETC. ARE TO BE VERIFIED PRIOR TO CONSTRUCTION OR FABRICATION OF ANY MATERIAL BY CONTRACTOR PERFORMING WORK IN EXISTING AREAS. REPORT ANY DISCREPANCIES TO ARCHITECT IMMEDIATELY. DO NOT REMOVE EXISTING LOAD-BEARING WALLS, COLUMNS, OR ANY SUB-STRUCTURE WITHOUT THE PRIOR APPROVAL OF THE ARCHITECT. WHERE NEW STRUCTURE IS TO BE INSTALLED, PROVIDE SHORING AND BRACING AS REQUIRED TO PROPERLY SUPPORT THE REMAINING STRUCTURE UNTIL THE NEW STRUCTURE IS IN PLACE AND PROPERLY BRACED.
- SEE SHEET S001 FOR GENERAL STRUCTURAL INFORMATION.


#	DATE	CHANGE DESCRIPTION

RENOVATION OF HEARTLAND BANK DUBLIN
 5303 FRANTZ ROAD,
 DUBLIN, OH 43017
 FOR
HEARTLAND BANK

MOODY-NOLAN 300 SPRUCE STREET
 SUITE 300
 COLUMBUS, OHIO 43215
 PHONE: (614) 461-4664
 FAX: (614) 280-8881

DRAWING TITLE:
1ST FLOOR FRAMING PLAN

PROGRESS DRAWING NOT FOR CONSTRUCTION	09/10/2020
	DRAWN BY: Author CHECKED BY: Checker
	20022
S101	
PRELIMINARY DEVELOPMENT PLAN	

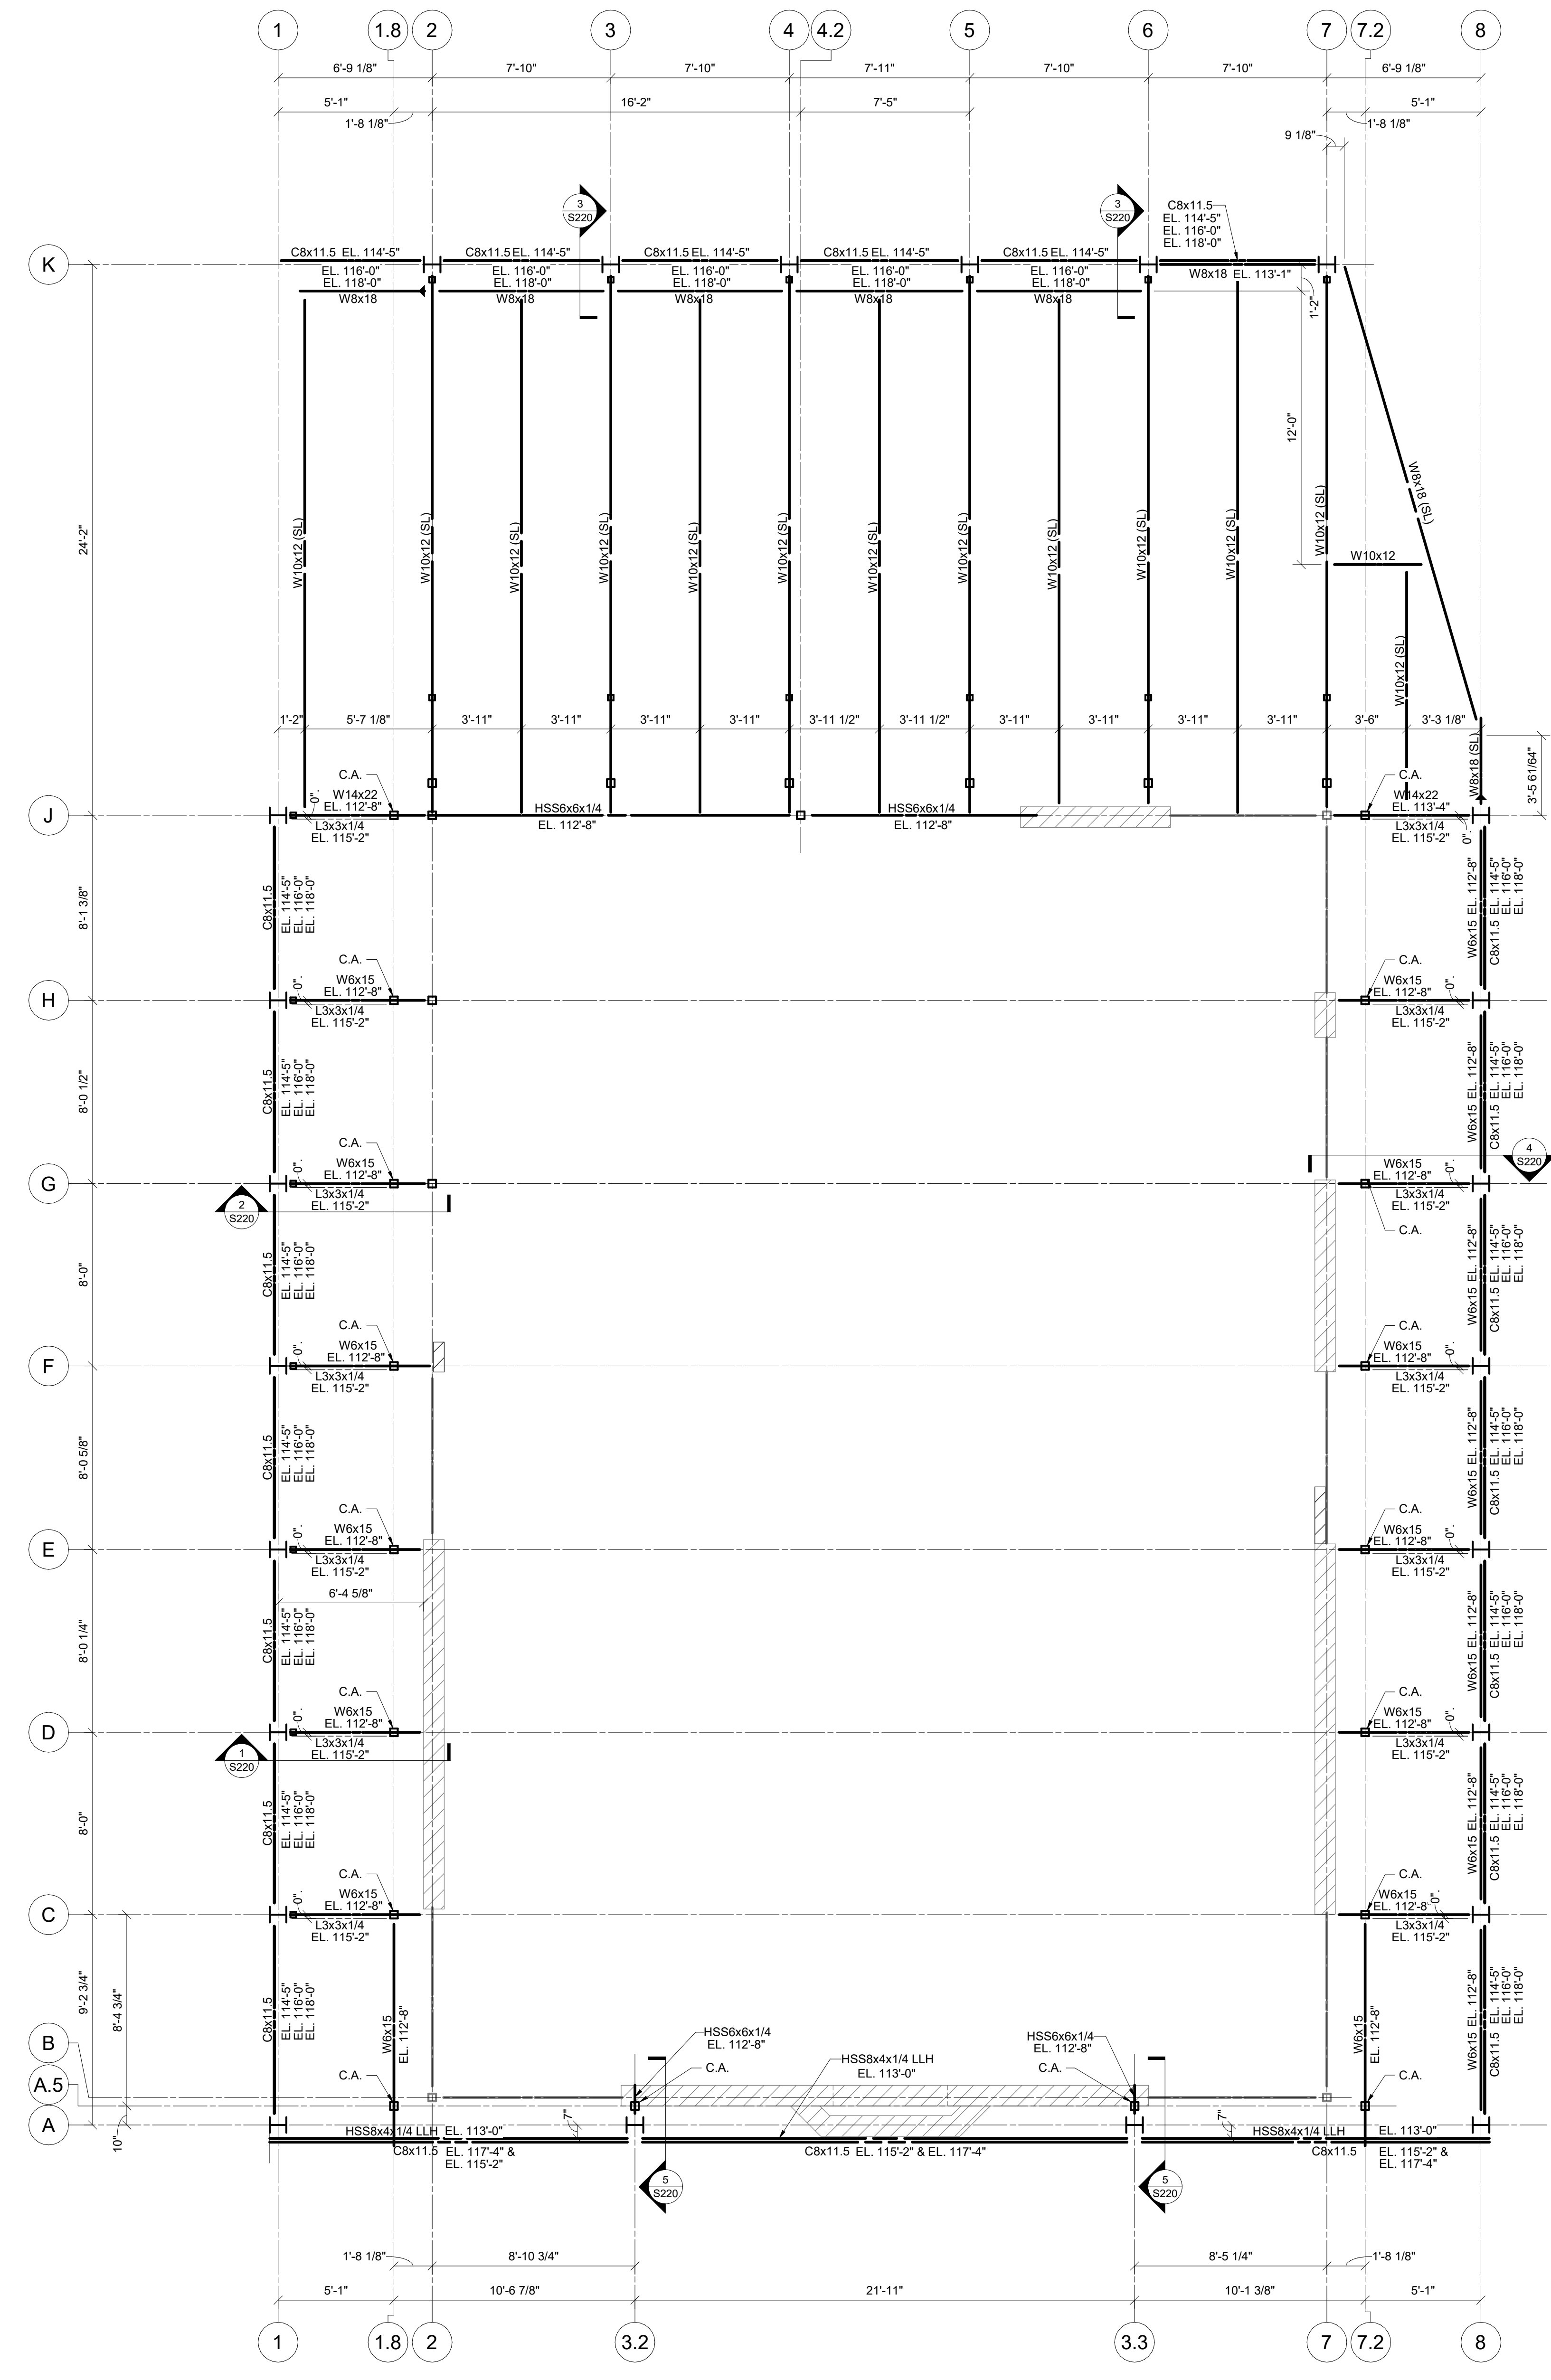

ROOF FRAMING PLAN
 1/4" = 1'-0"

#	DATE	CHANGE DESCRIPTION

RENOVATION OF HEARTLAND BANK DUBLIN
 8300 FRANTZ ROAD,
 DUBLIN OH - 43017
 FOR
HEARTLAND BANK

MOODY-NOLAN
 300 SPRUCE STREET
 SUITE 300
 COLUMBUS, OHIO 43215
 PHONE: (614) 461-4664
 FAX: (614) 280-8881


ROOF FRAMING PLAN

09/10/2020
 DRAWN BY: Author CHECKED BY: Checker
 20022

S102

PRELIMINARY DEVELOPMENT PLAN

PROGRESS DRAWING NOT FOR CONSTRUCTION

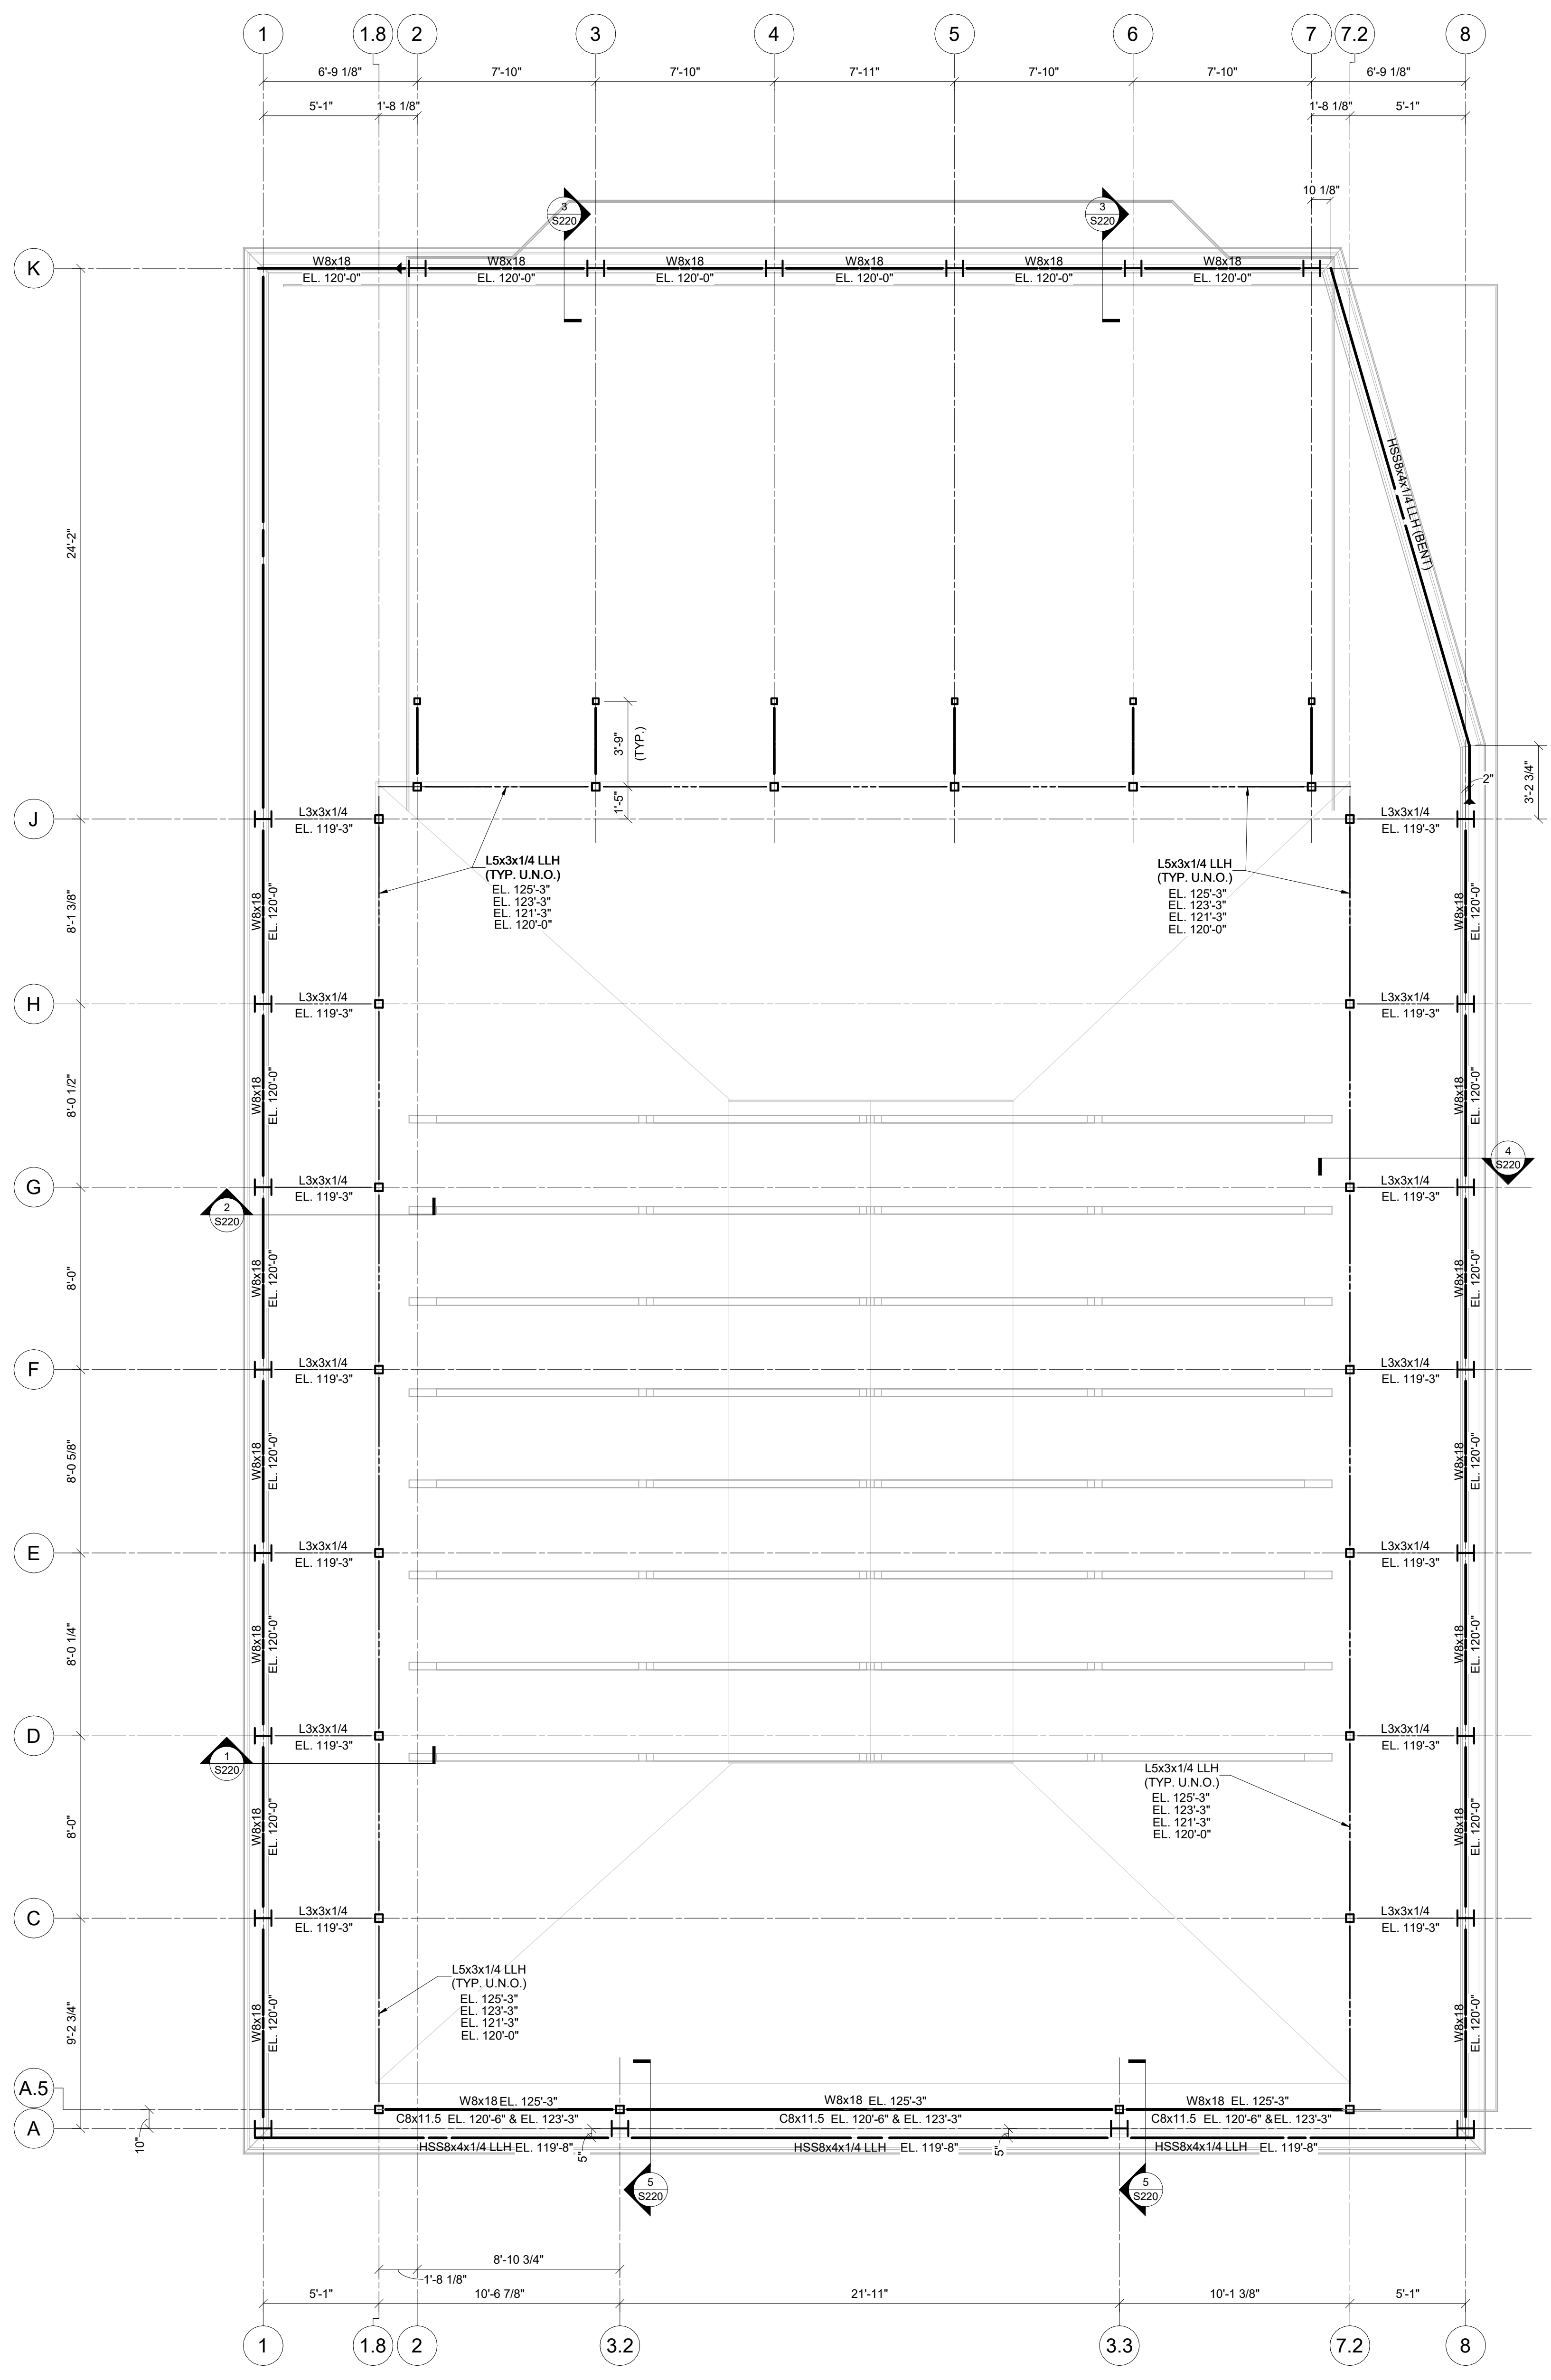

SCREENWALL FRAMING PLAN

1/4" = 1'-0"


#	DATE	CHANGE DESCRIPTION

RENOVATION OF HEARTLAND BANK DUBLIN
 5303 FRANTZ ROAD,
 DUBLIN OH - 43017
 FOR
HEARTLAND BANK


MOODY-NOLAN 300 SPRUCE STREET
 SUITE 300
 COLUMBUS, OHIO 43215
 PHONE: (614) 461-4664
 FAX: (614) 280-8881

DRAWING TITLE:
SCREENWALL FRAMING PLAN

PROGRESS DRAWING NOT FOR CONSTRUCTION	09/10/2020
	DRAWN BY: Author CHECKED BY: Checker
	20022
S103	
PRELIMINARY DEVELOPMENT PLAN	

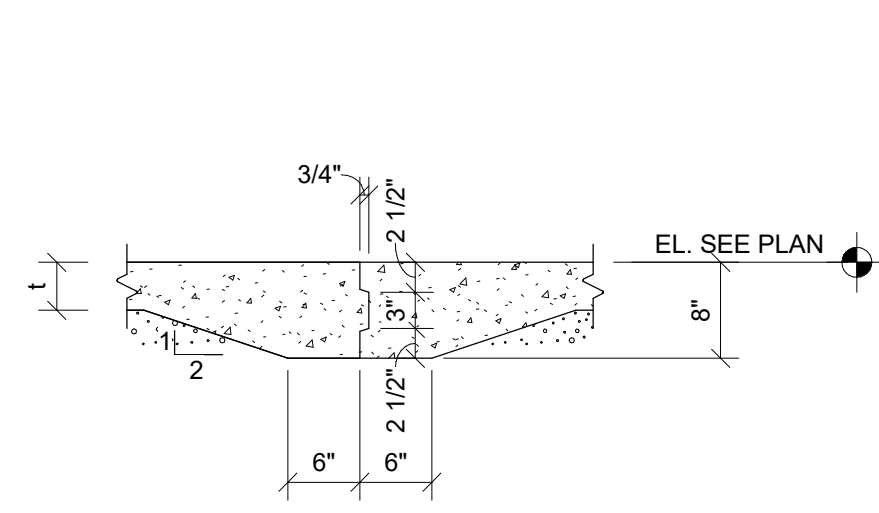


TYPICAL FLOOR CONSTRUCTION JOINT

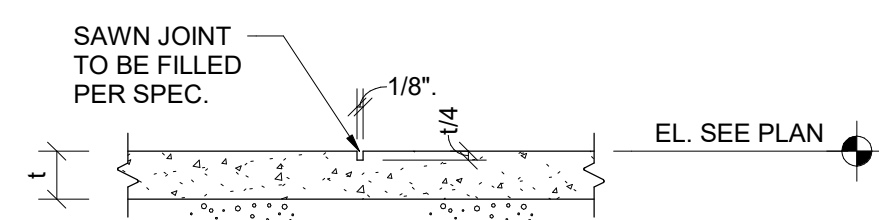


TYPICAL FLOOR CONTROL JOINT

SECTION 1 3/4" = 1'-0"

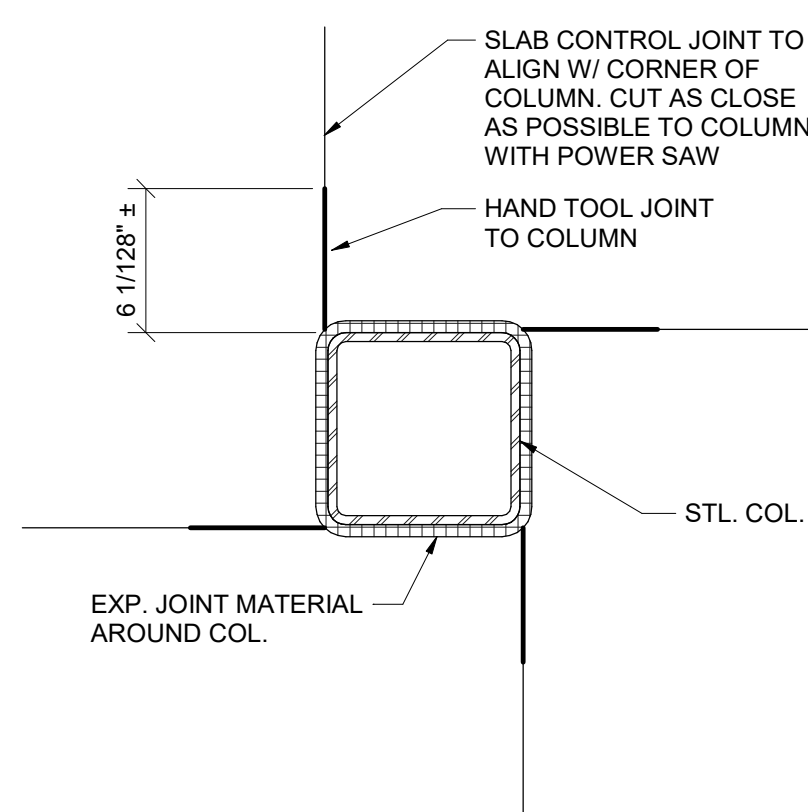


CONTROL JOINTS AT SQUARE COLUMN

SECTION 2 1 1/2" = 1'-0"

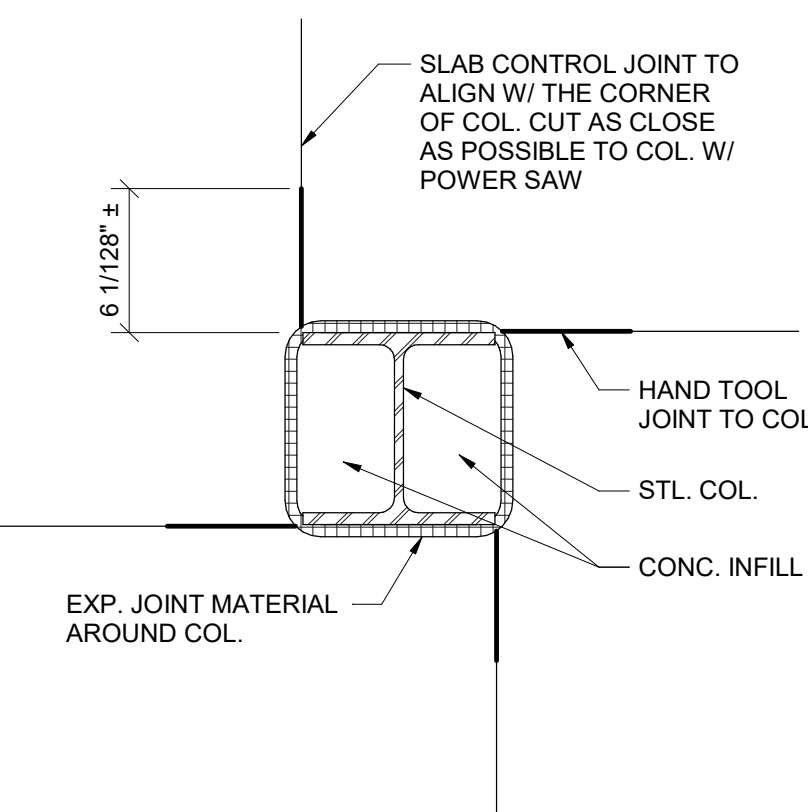


CONTROL JOINTS AT W COLUMN

SECTION 3 1 1/2" = 1'-0"

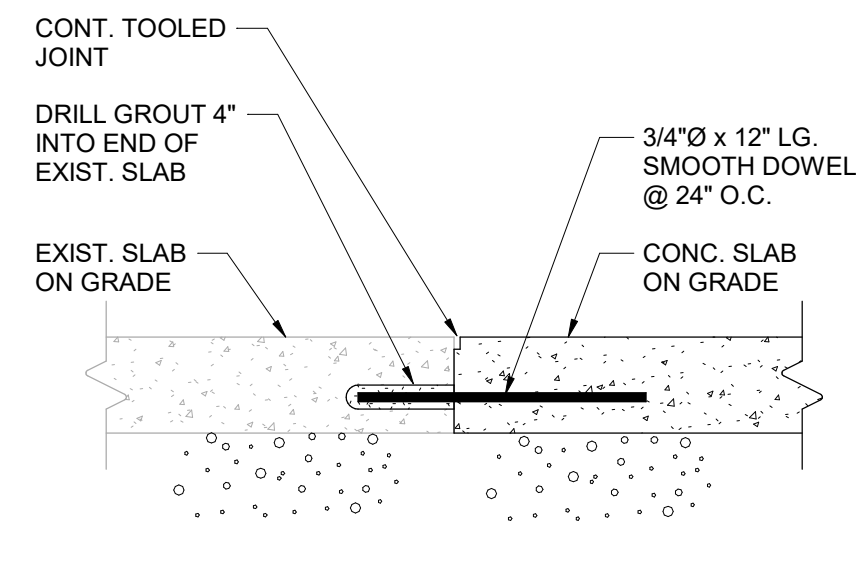


TYPICAL NEW-TO-EXISTING SLAB TRANSITION

SECTION 4 1 1/2" = 1'-0"

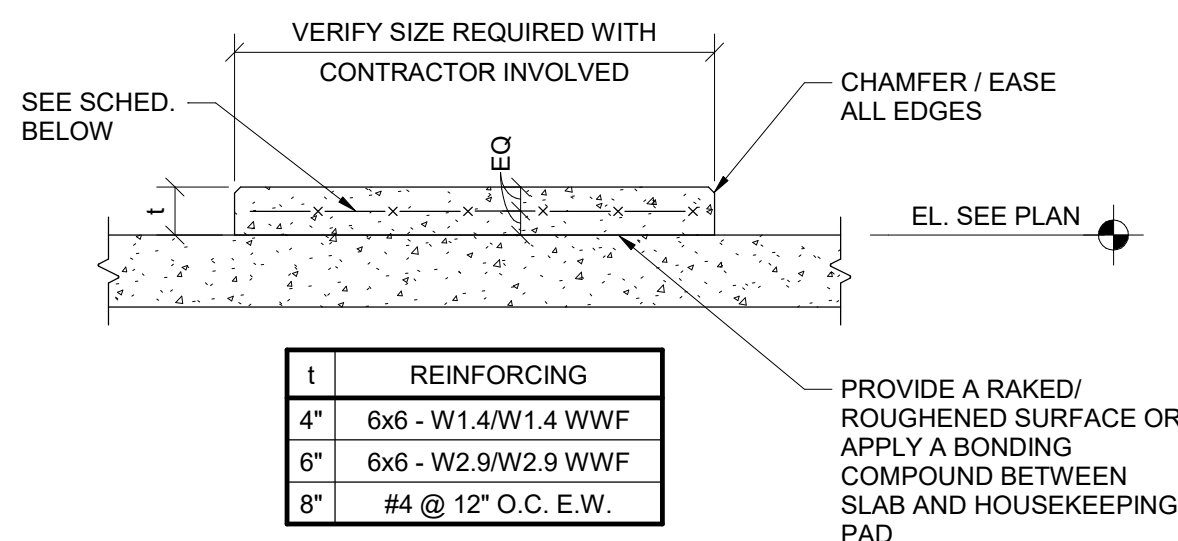


TYPICAL HOUSEKEEPING PADS FOR SLABS ON GRADE & STRUCTURAL DECK

SECTION 5 3/4" = 1'-0"

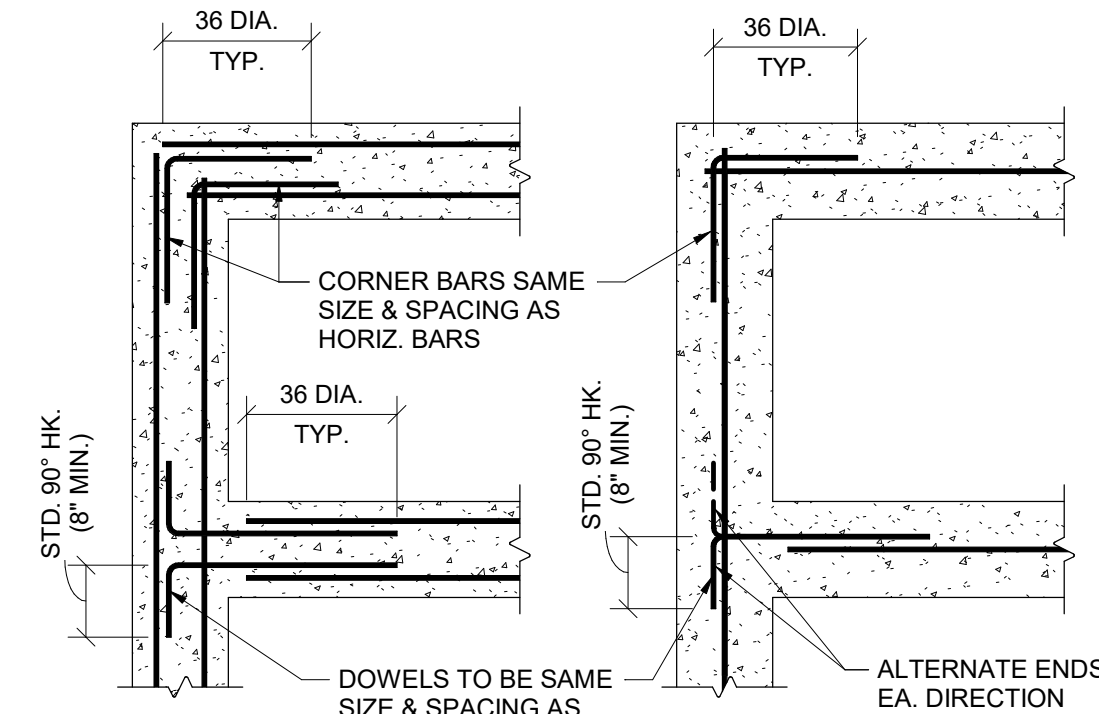


TYPICAL CORNER BARS FOR CONCRETE WALL AND FOOTING CONSTRUCTION

SECTION 6 3/4" = 1'-0"

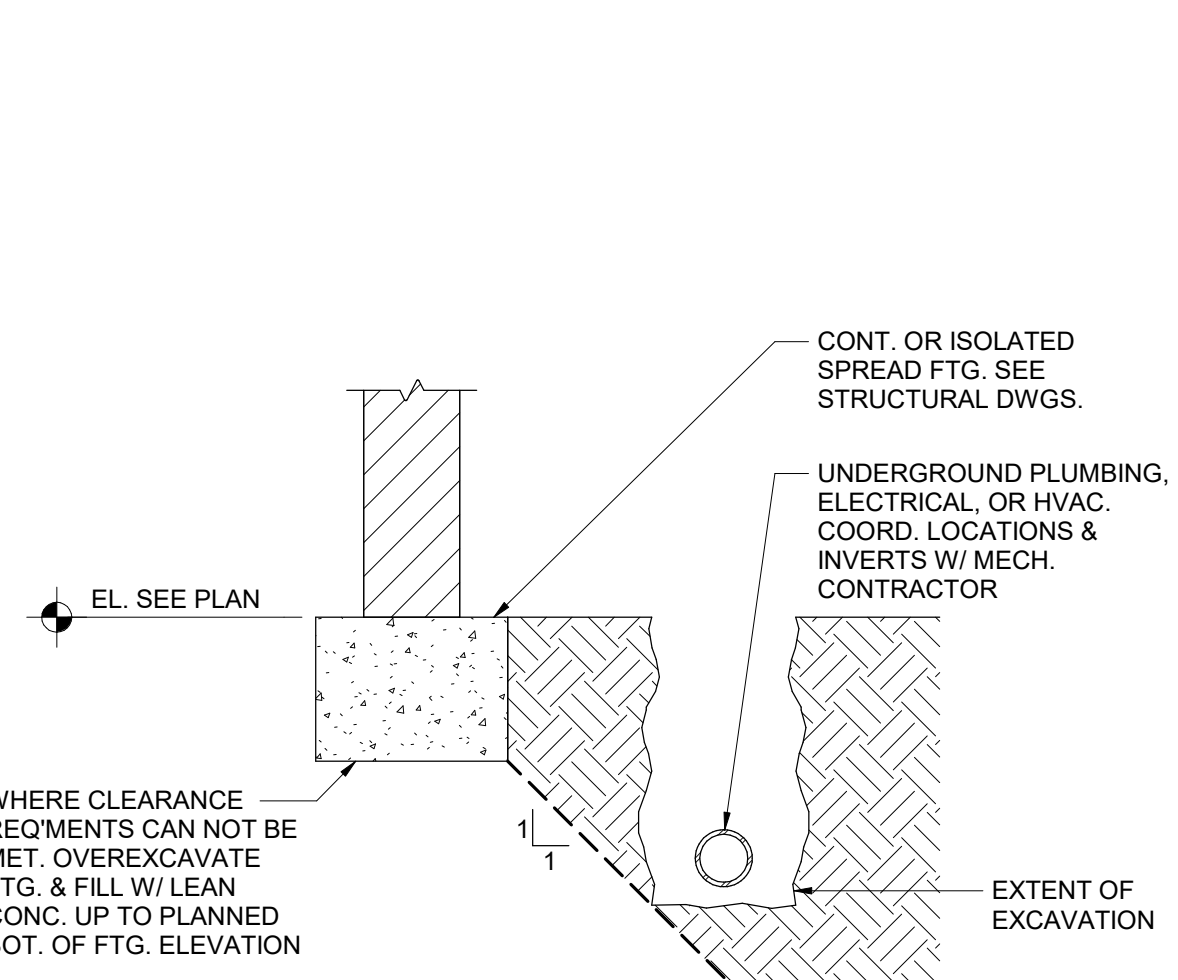


TYPICAL EXCAVATION CLEARANCE REQUIREMENTS


SECTION 7 3/4" = 1'-0"

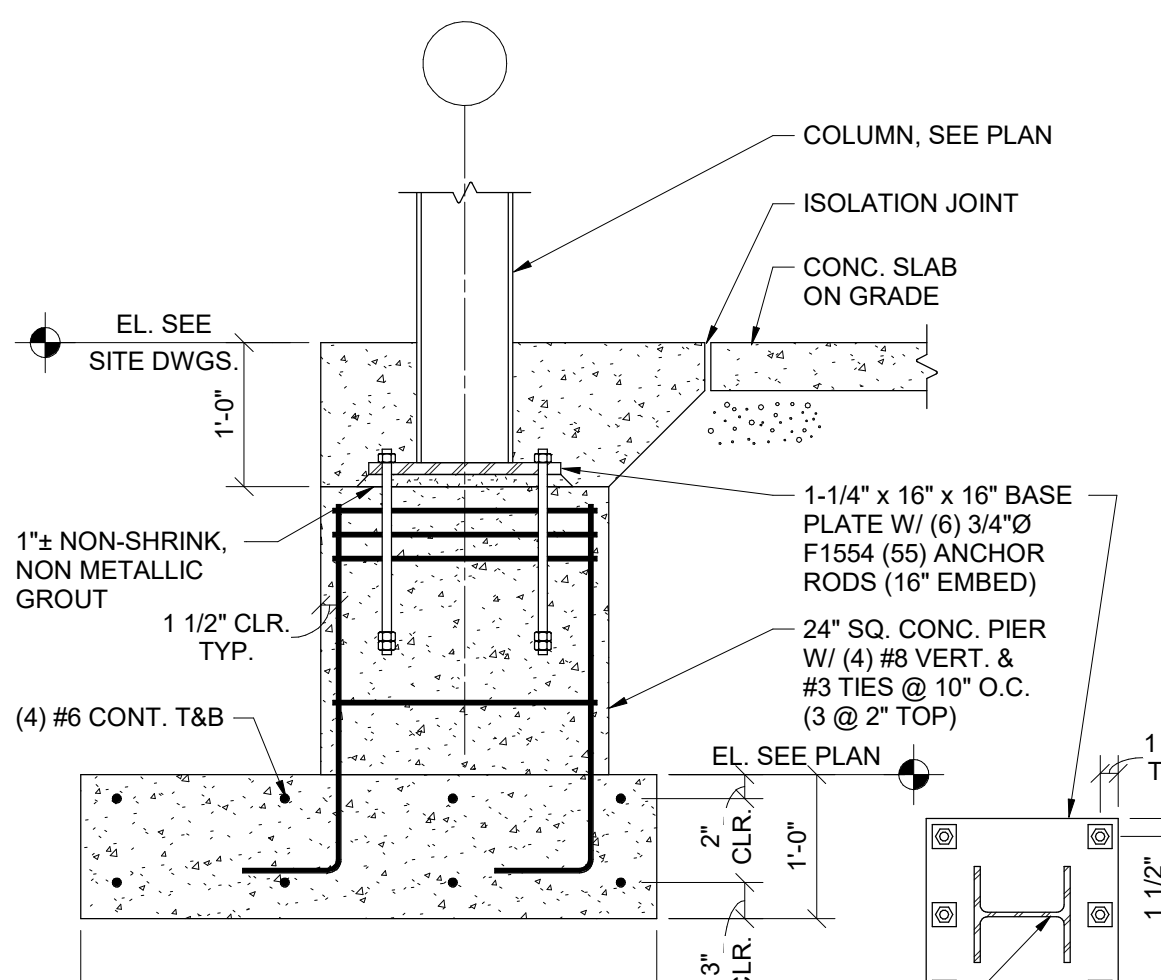


SECTION 8 3/4" = 1'-0"

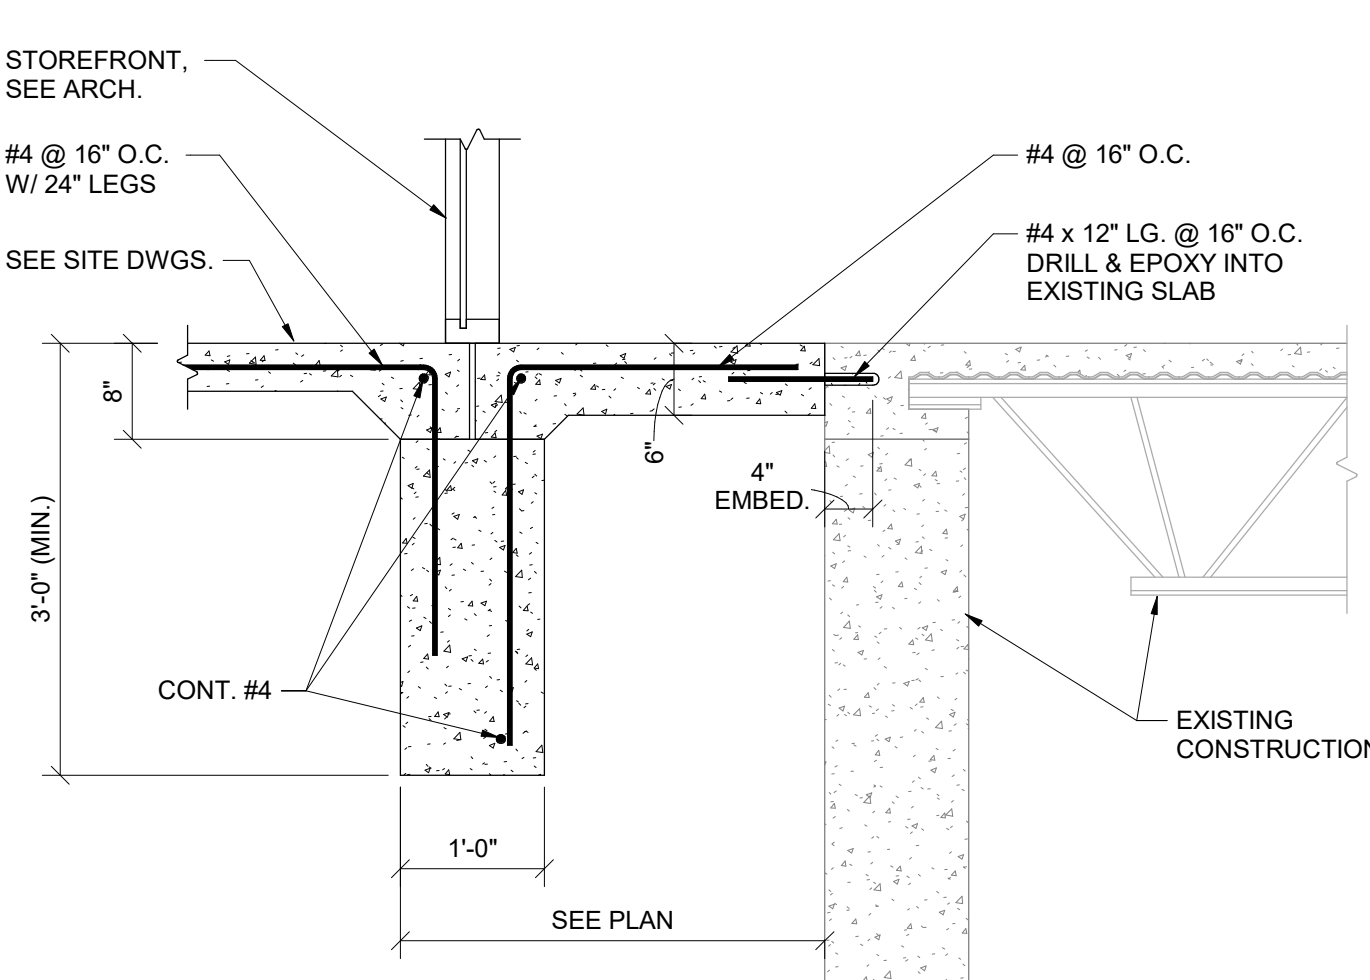


SECTION 9 3/4" = 1'-0"

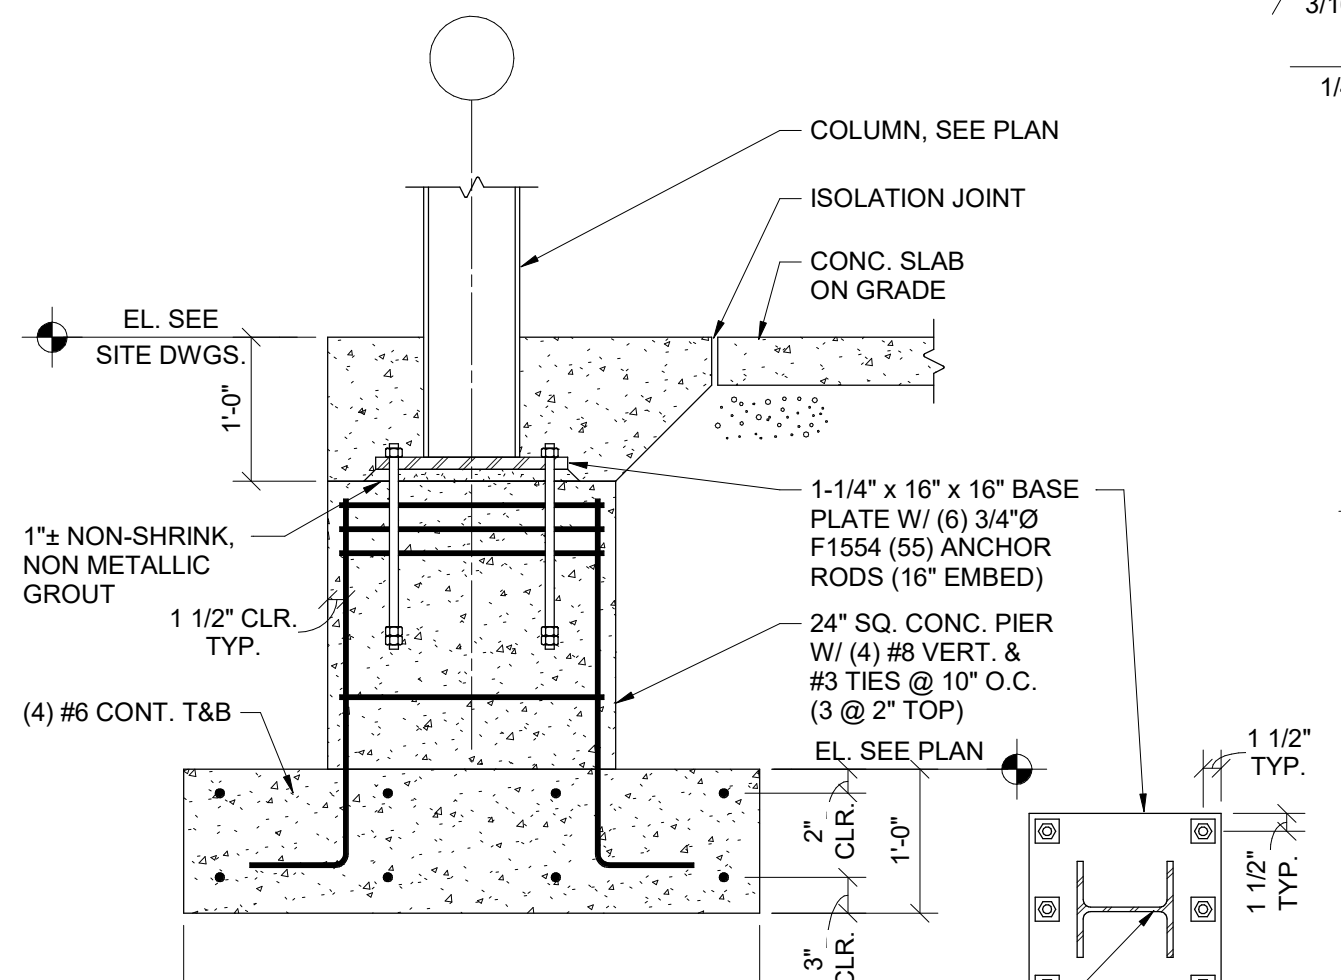

SECTION 10 3/4" = 1'-0"

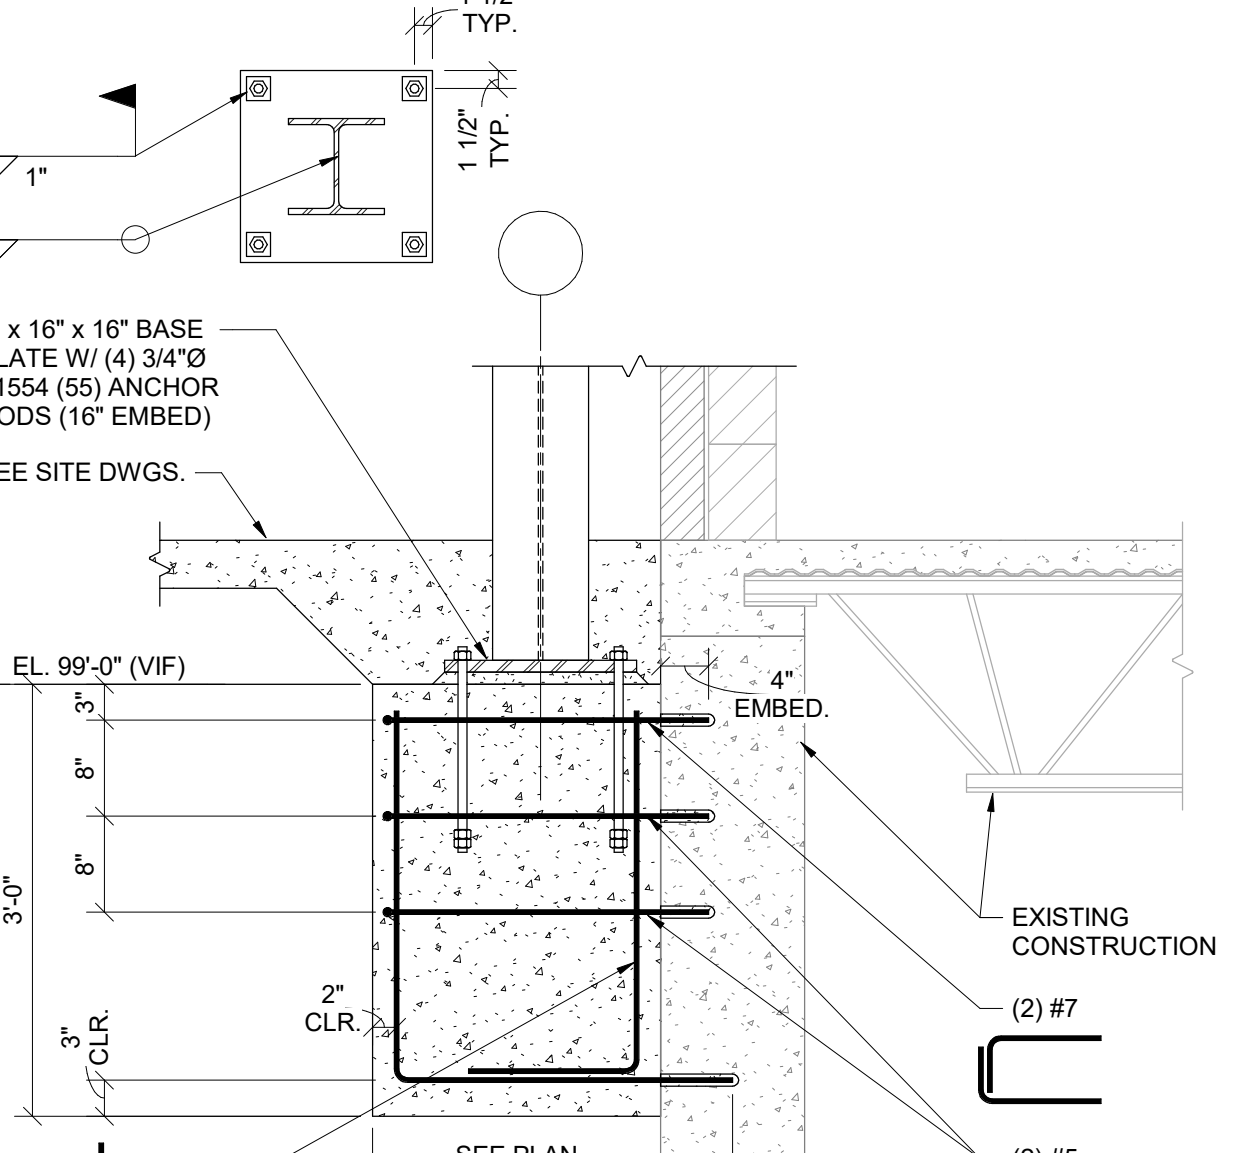

SECTION 11 3/4" = 1'-0"

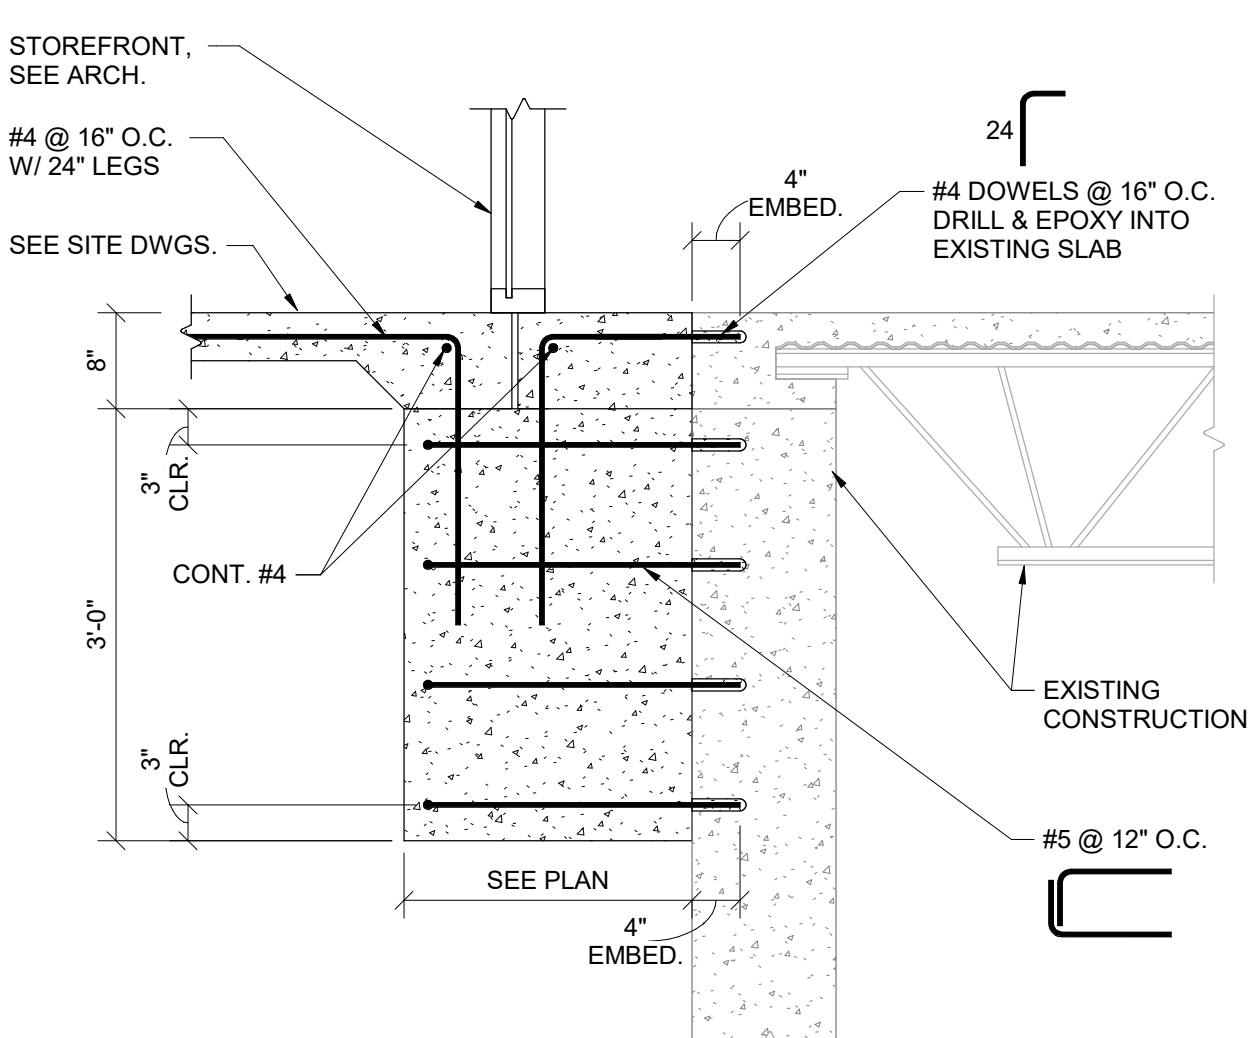

SECTION 12 3/4" = 1'-0"


#	DATE	CHANGE DESCRIPTION

RENOVATION OF HEARTLAND BANK DUBLIN
 5303 FRANTZ ROAD,
 DUBLIN OH - 43017
 FOR
HEARTLAND BANK





MOODY-NOLAN
 300 SPRUCE STREET
 SUITE 300
 COLUMBUS, OHIO 43215
 PHONE: (614) 461-4664
 FAX: (614) 280-8881

FOUNDATION DETAILS

PROGRESS DRAWING NOT FOR CONSTRUCTION	09/10/2020
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	20022
S201	
PRELIMINARY DEVELOPMENT PLAN	

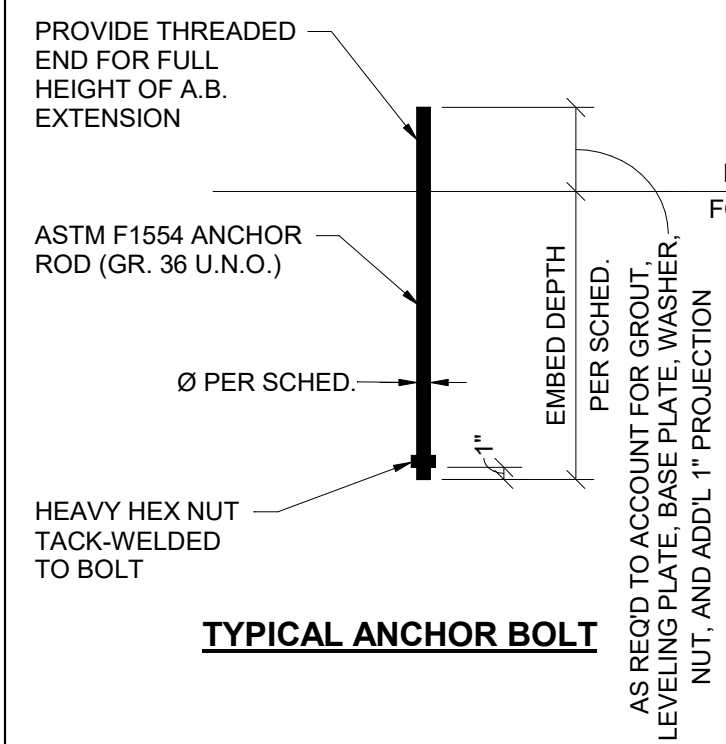

BASE PLATE DETAILING SCHEDULE			
BOLT SIZE	BASE PLATE HOLE SIZE	EDGE DISTANCE	PLATE WASHER
3/4"Ø	1-5/16"Ø	1-1/2"	1/4" x 2-1/2" SQ.
1"	1-13/16"Ø	2"	3/8" x 3" SQ.
1-1/4"Ø	2-1/16"Ø	2"	1/2" x 3" SQ.
1-1/2"Ø	2-5/16"Ø	2-1/2"	1/2" x 3-1/2" SQ.
1-3/4"Ø	2-3/4"Ø	3"	5/8" x 4" SQ.
2"Ø	3-1/4"Ø	3-1/2"	3/4" x 5" SQ.

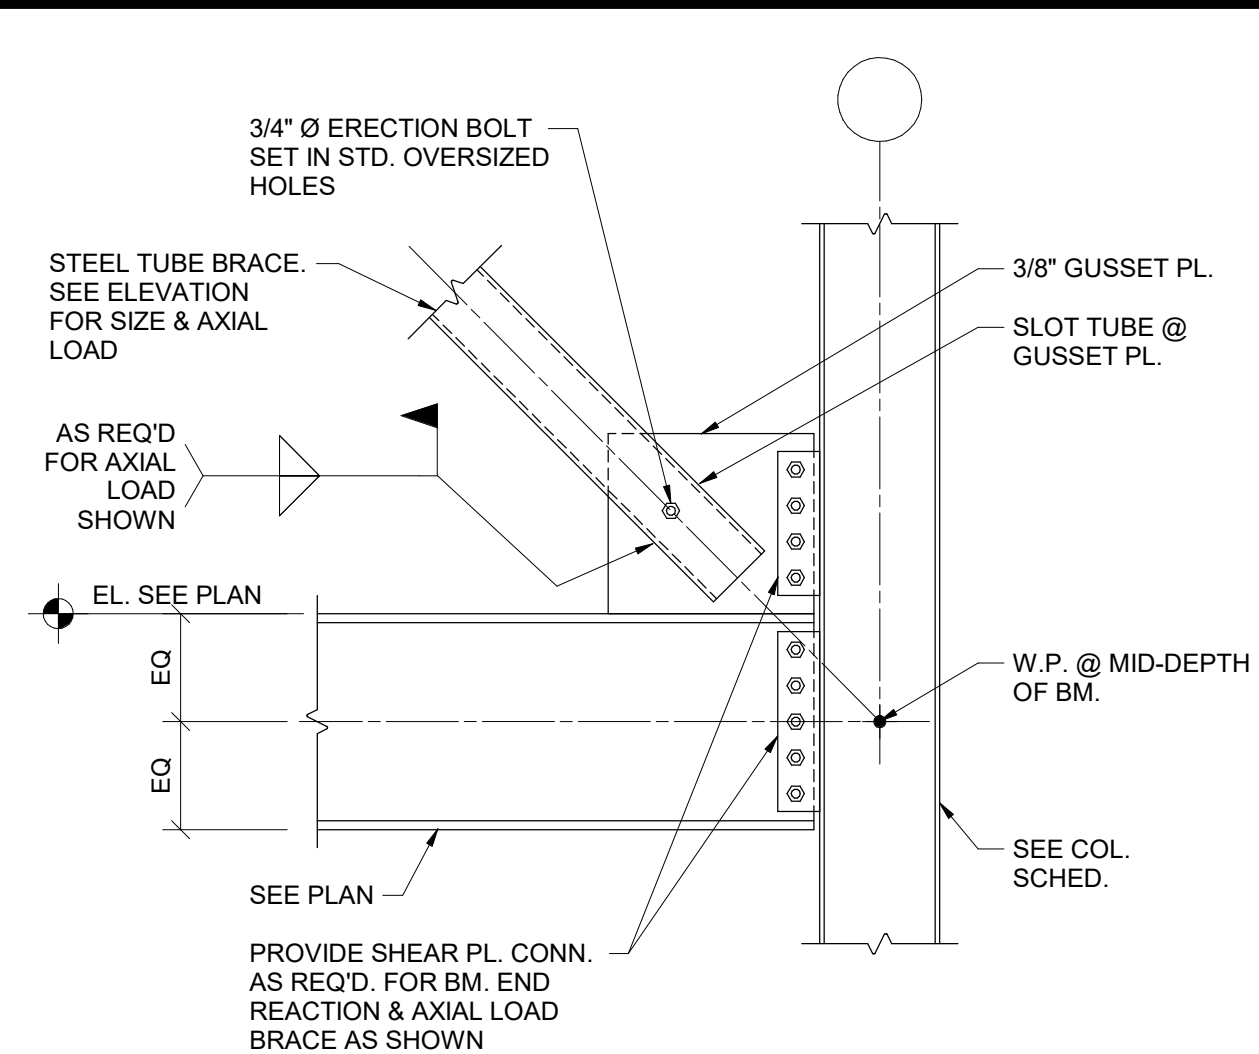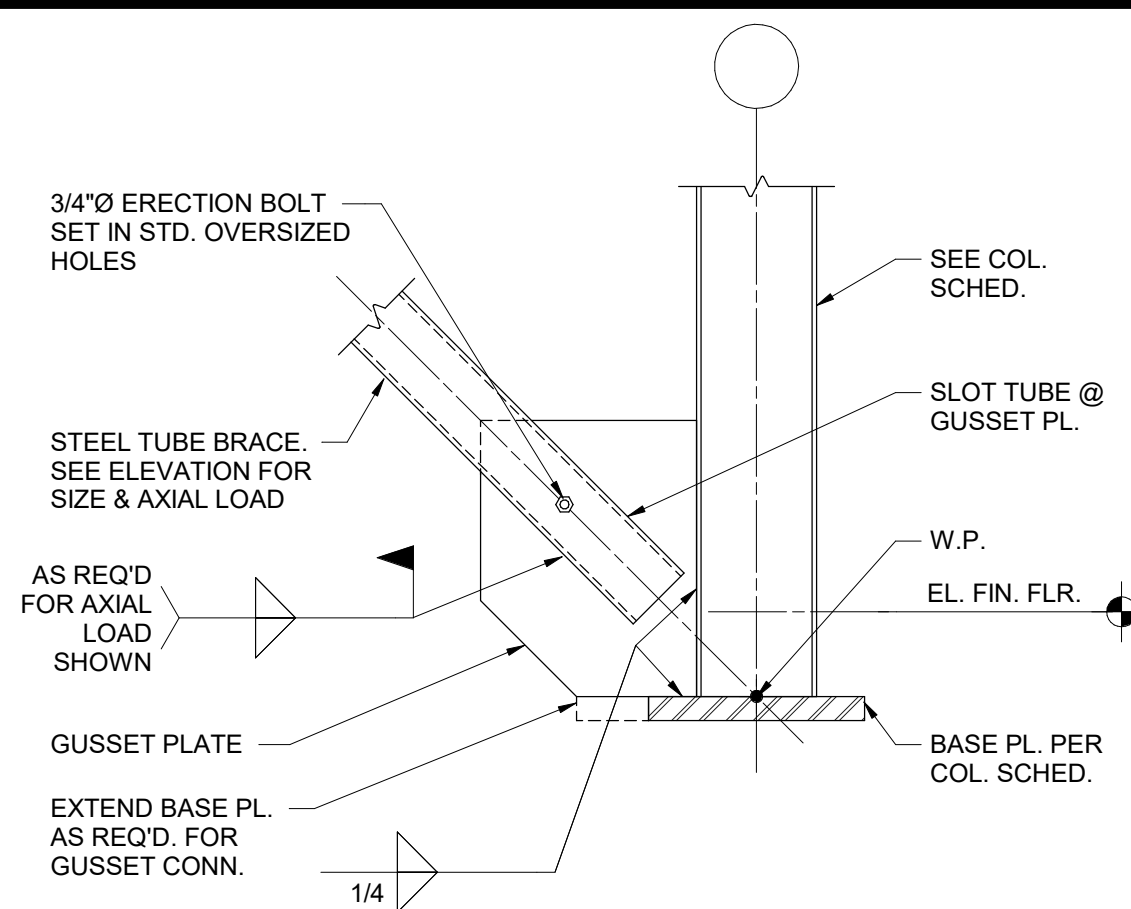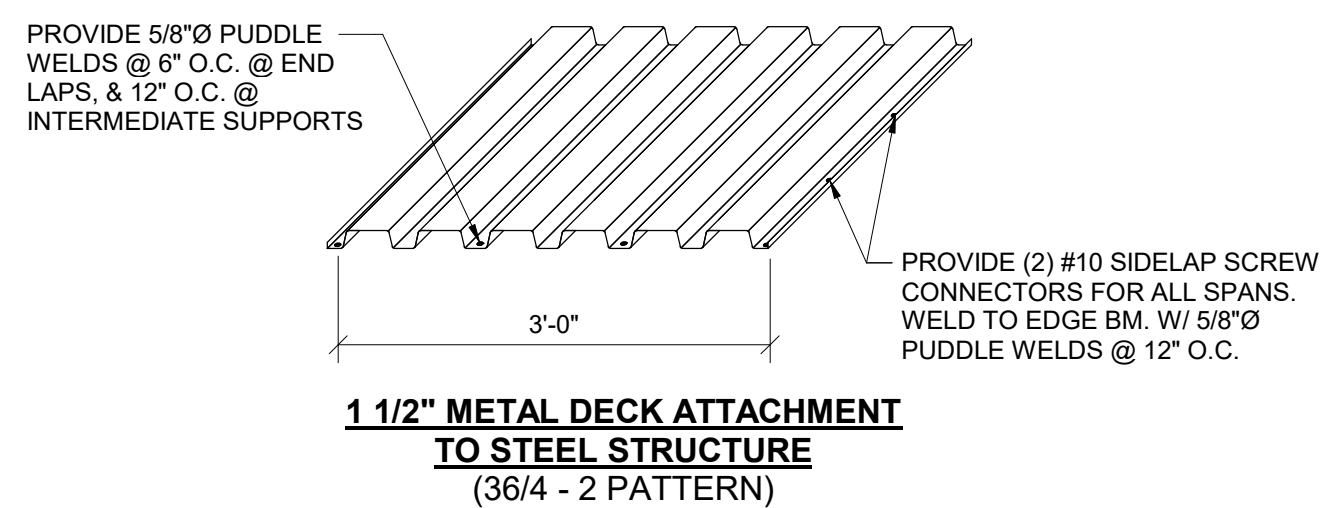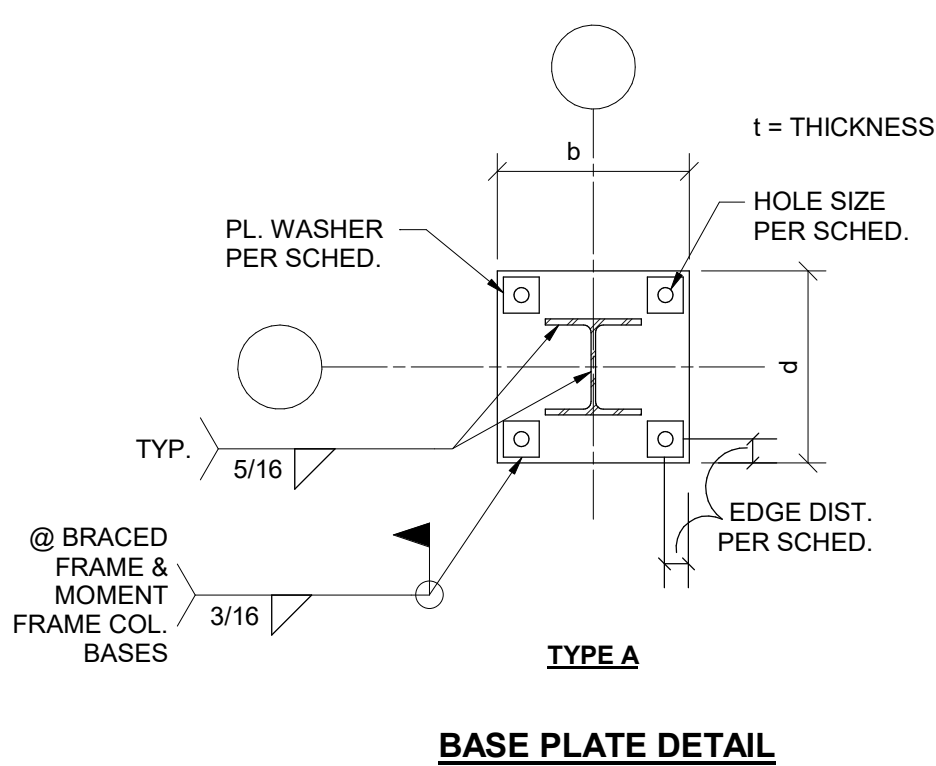






SECTION 1
3/4" = 1'-0"

SECTION 2
3/4" = 1'-0"

SECTION 3
3/4" = 1'-0"

SECTION 4
3/4" = 1'-0"

SECTION 5
3/4" = 1'-0"

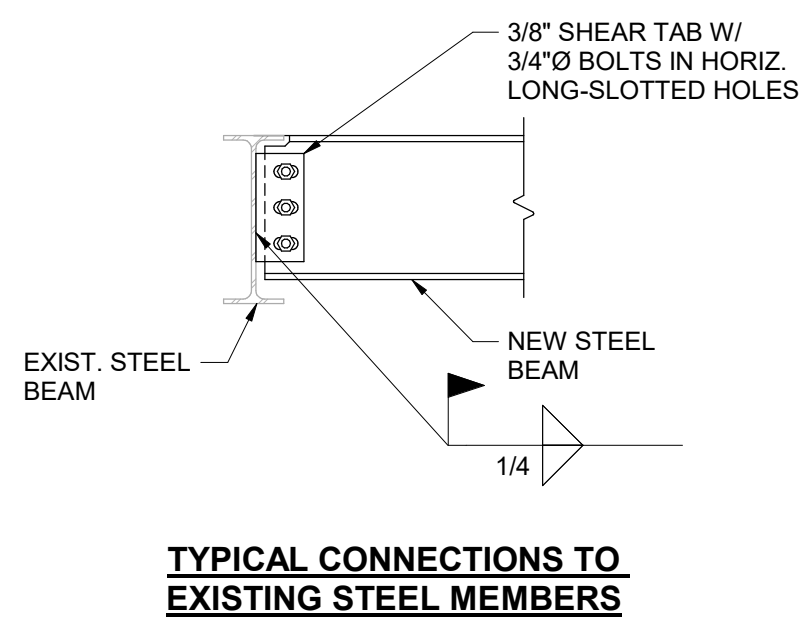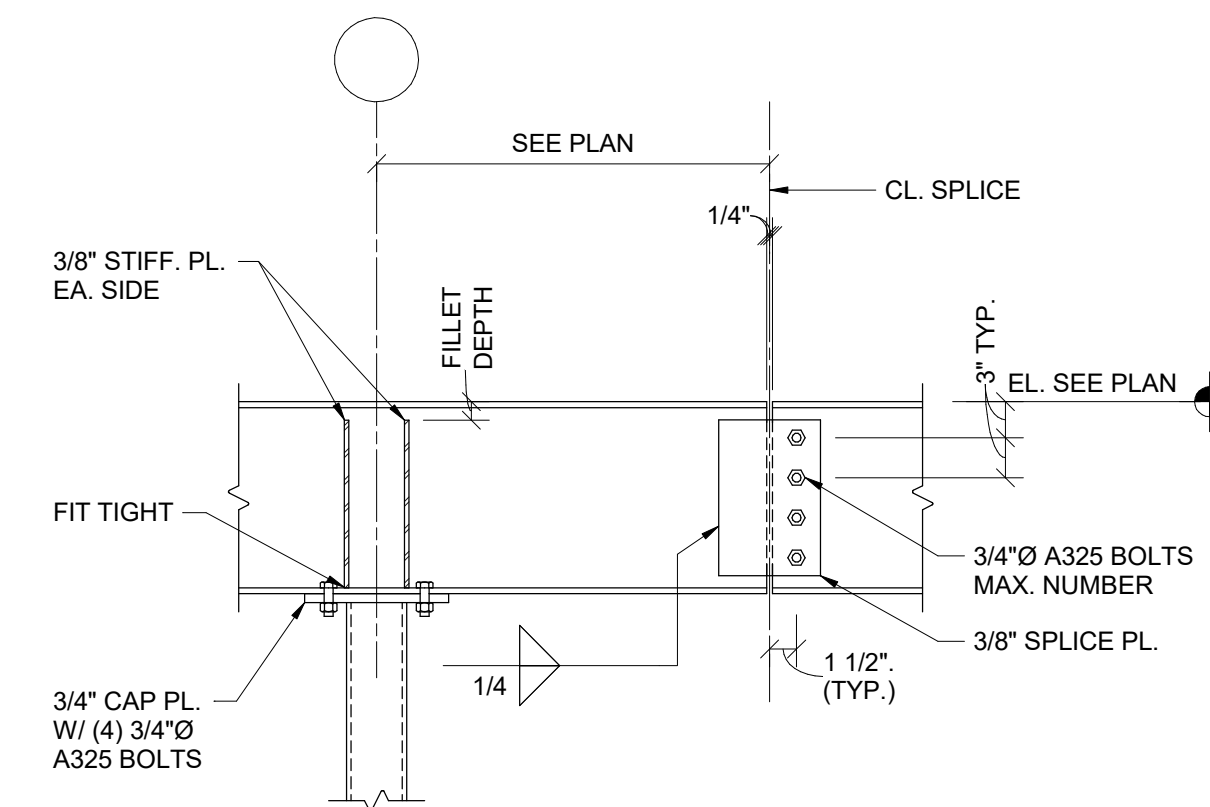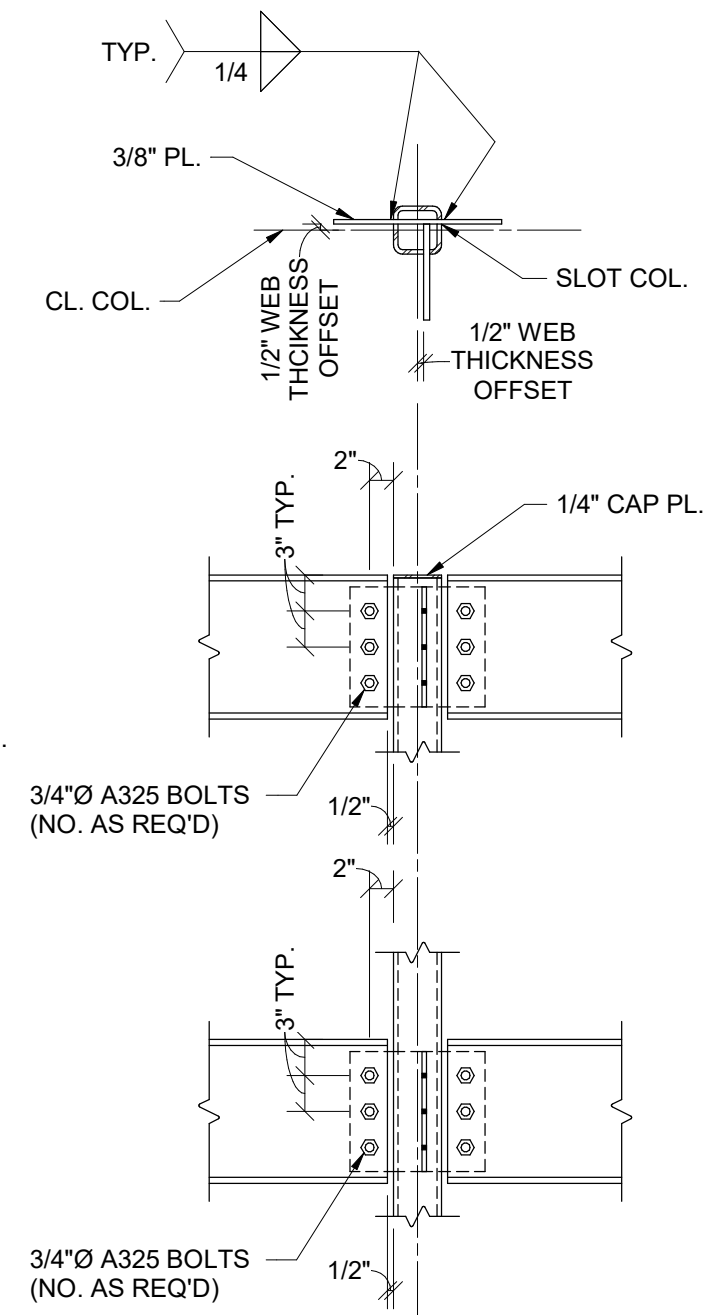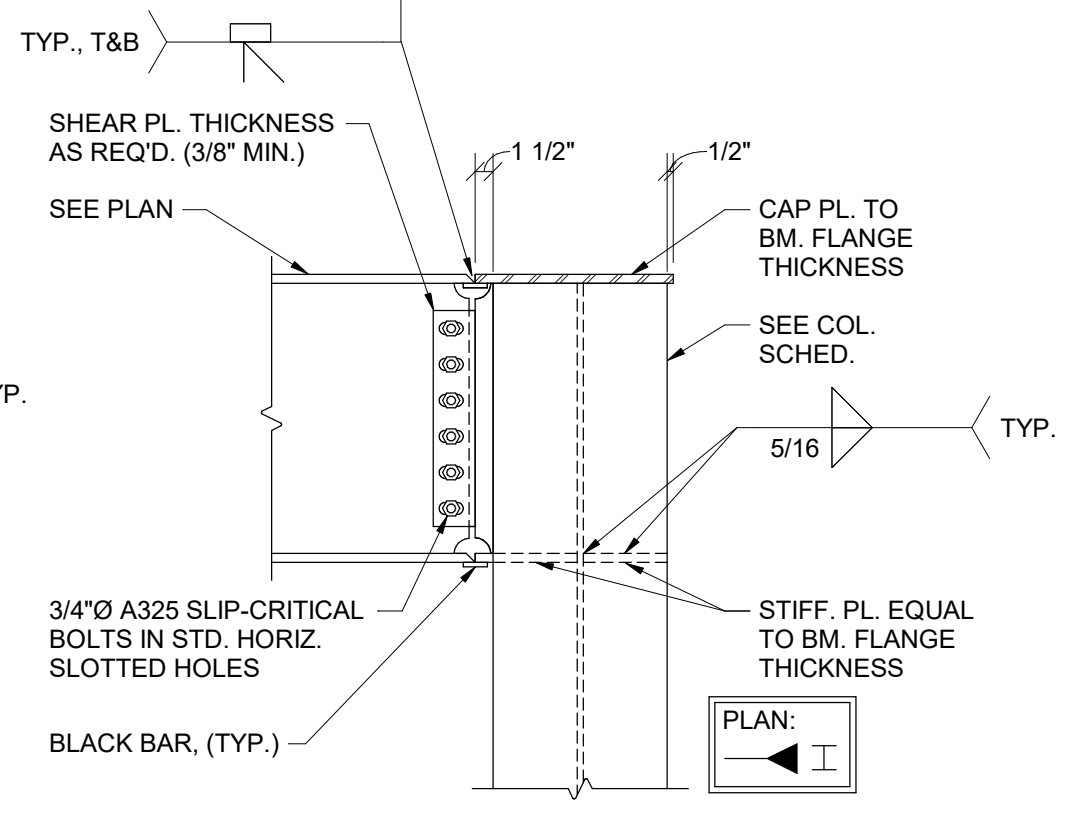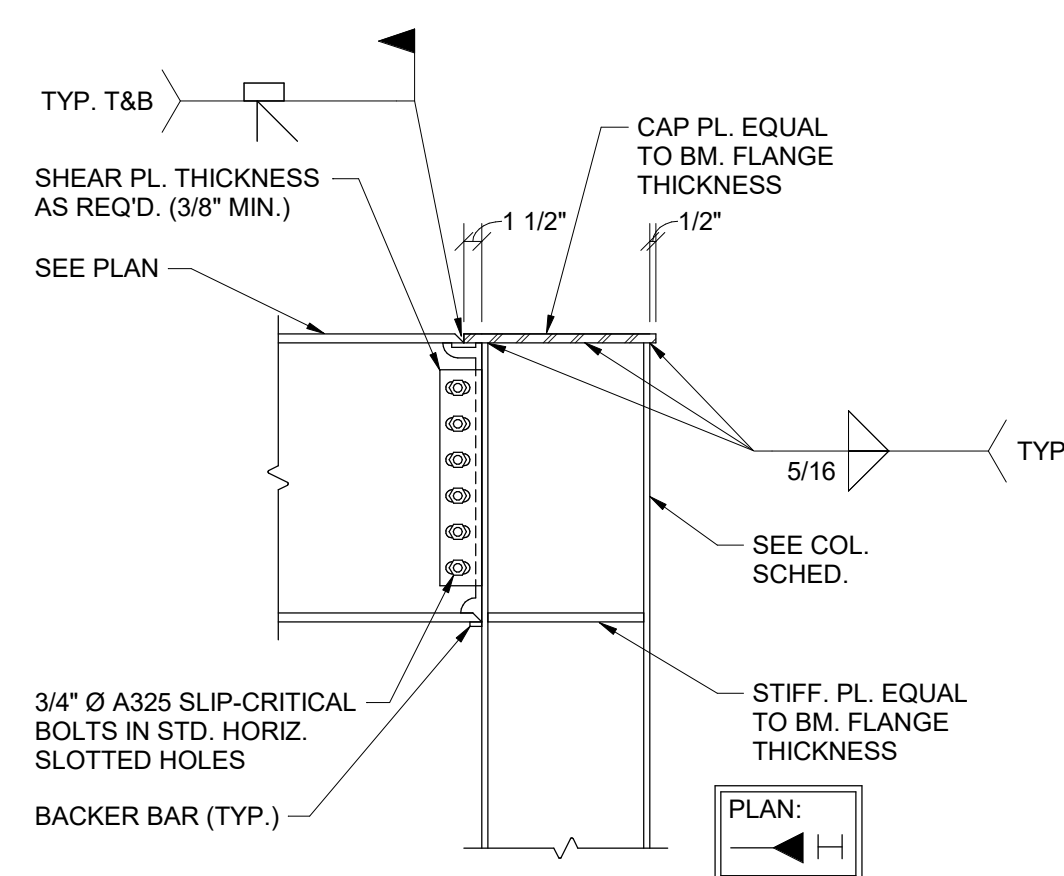

SECTION 6
3/4" = 1'-0"

SECTION 7
3/4" = 1'-0"

SECTION 8
3/4" = 1'-0"

SECTION 9
3/4" = 1'-0"

SECTION 10
3/4" = 1'-0"

#	DATE	CHANGE DESCRIPTION

RENOVATION OF HEARTLAND BANK DUBLIN
 5303 FRANTZ ROAD,
 DUBLIN OH - 43017
 FOR
HEARTLAND BANK


MOODY-NOLAN
 300 SPRUCE STREET
 SUITE 300
 COLUMBUS, OHIO 43215
 PHONE: (614) 461-4664
 FAX: (614) 280-8881

DRAWING TITLE: **FRAMING DETAILS**

PROGRESS DRAWING NOT FOR CONSTRUCTION

09/10/2020
 DRAWN BY: Author CHECKED BY: Checker
 20022
S210
 PRELIMINARY DEVELOPMENT PLAN

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#	DATE	CHANGE DESCRIPTION

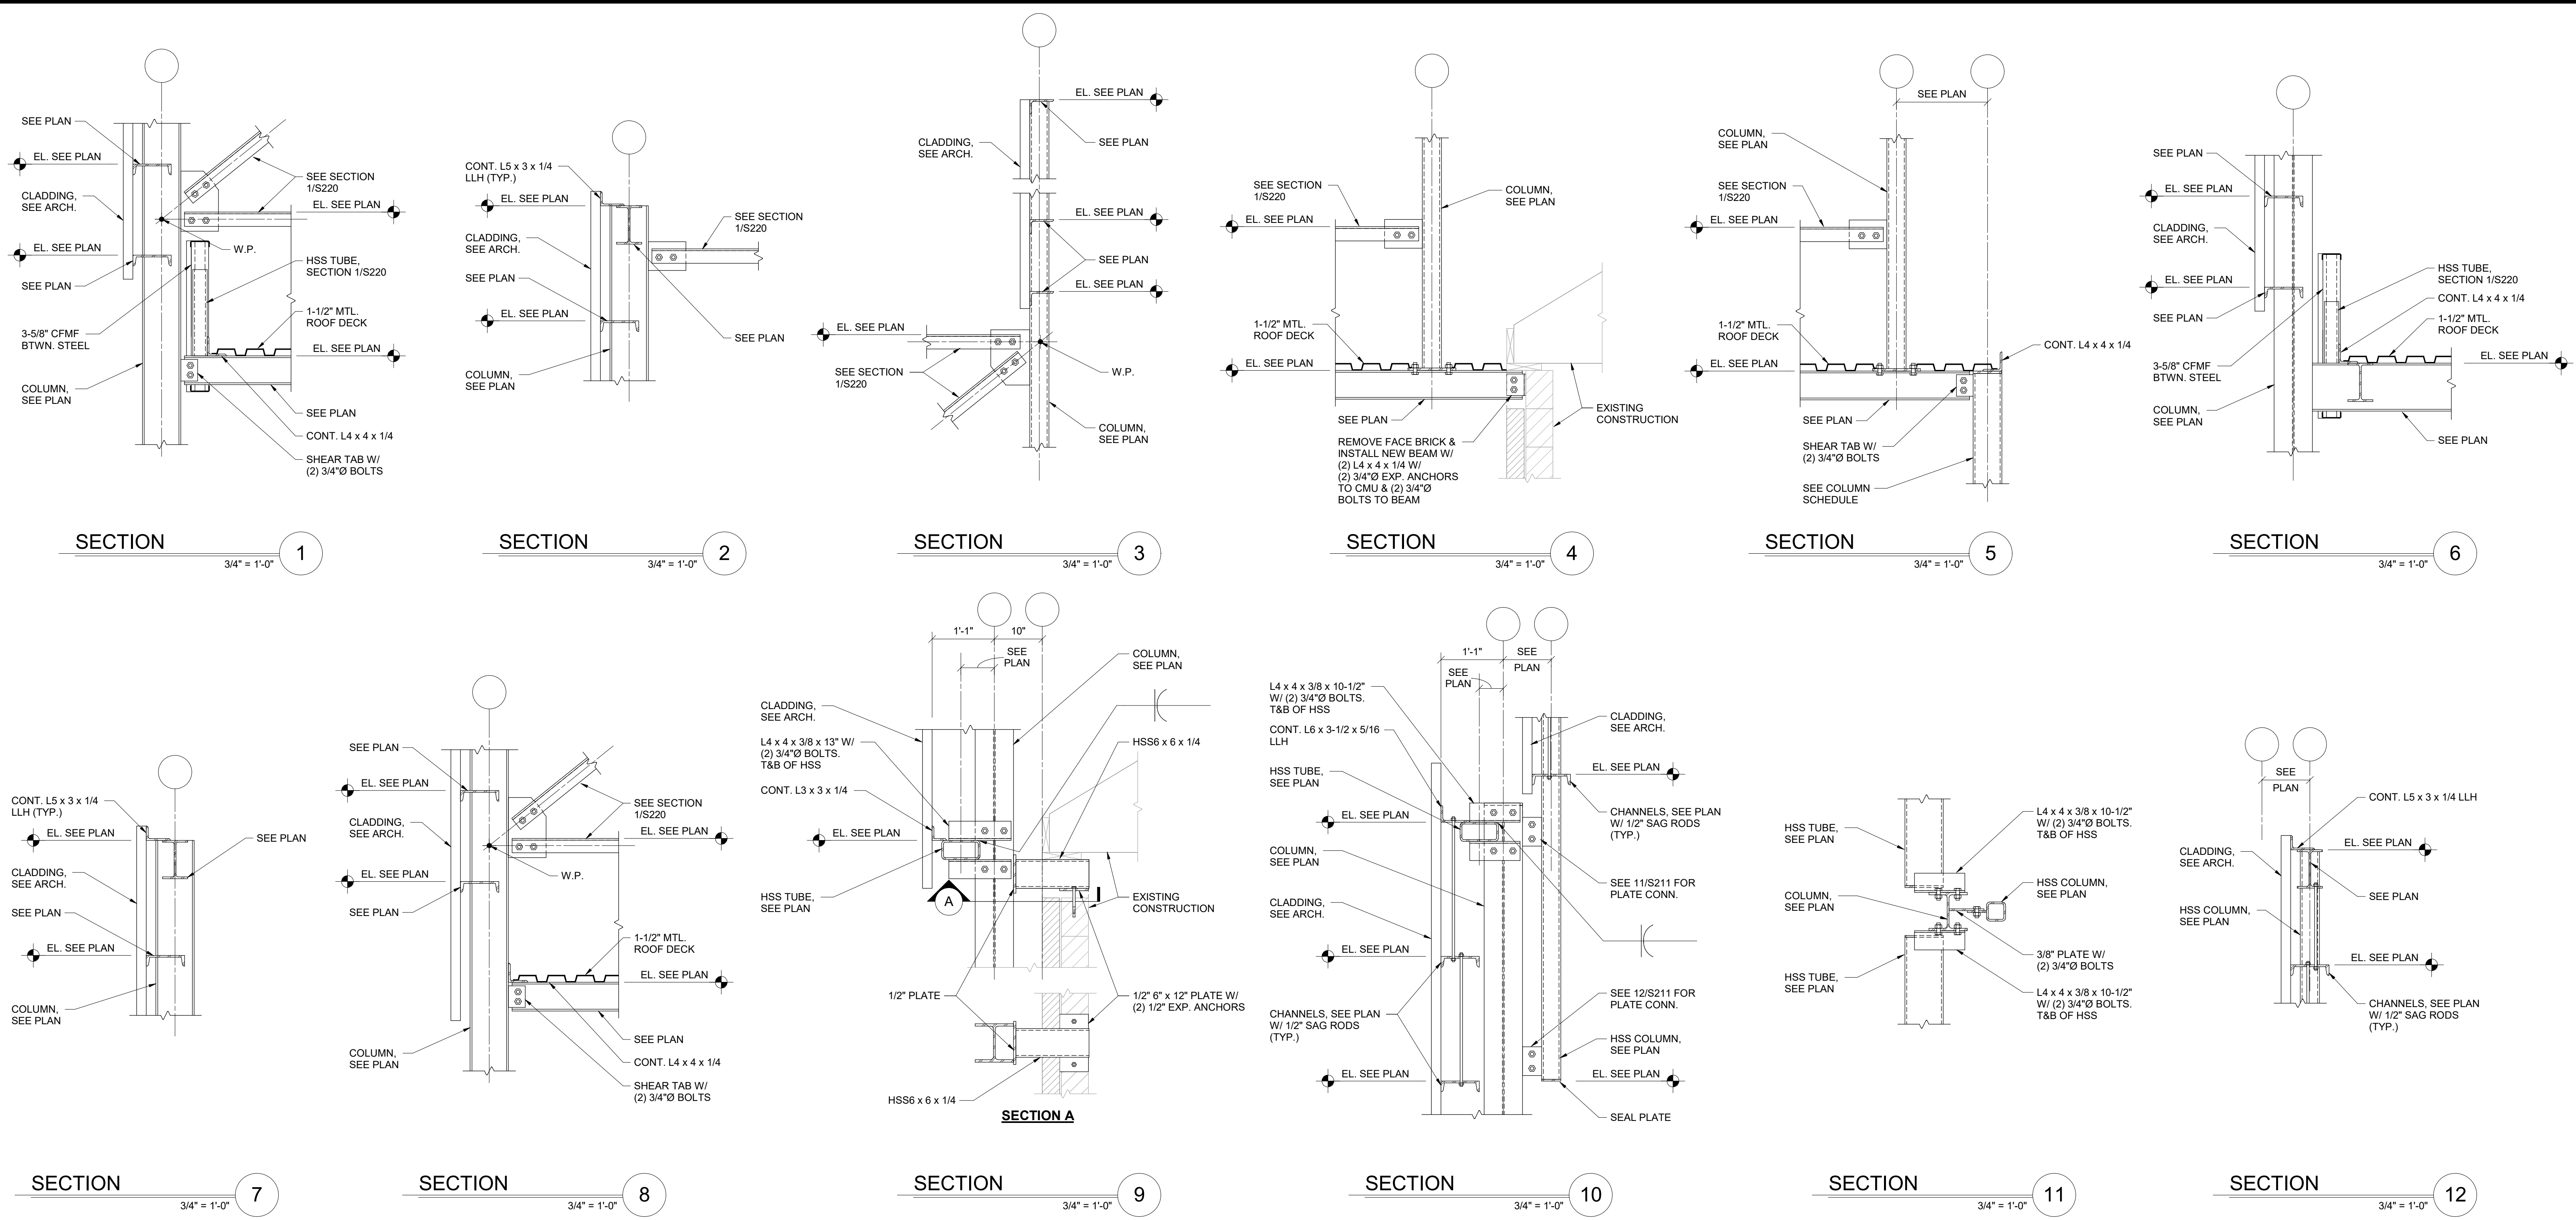RENOVATION OF HEARTLAND BANK DUBLIN
 5303 FRANTZ ROAD,
 DUBLIN OH - 43017
 FOR
HEARTLAND BANK


MOODY-NOLAN
 300 SPRUCE STREET
 SUITE 300
 COLUMBUS, OHIO 43215
 PHONE: (614) 461-4664
 FAX: (614) 280-8881

DRAWING TITLE: **FRAMING DETAILS**


PROGRESS DRAWING NOT FOR CONSTRUCTION	09/10/2020
	DRAWN BY: Author CHECKED BY: Checker
	20022

S211


PRELIMINARY DEVELOPMENT PLAN

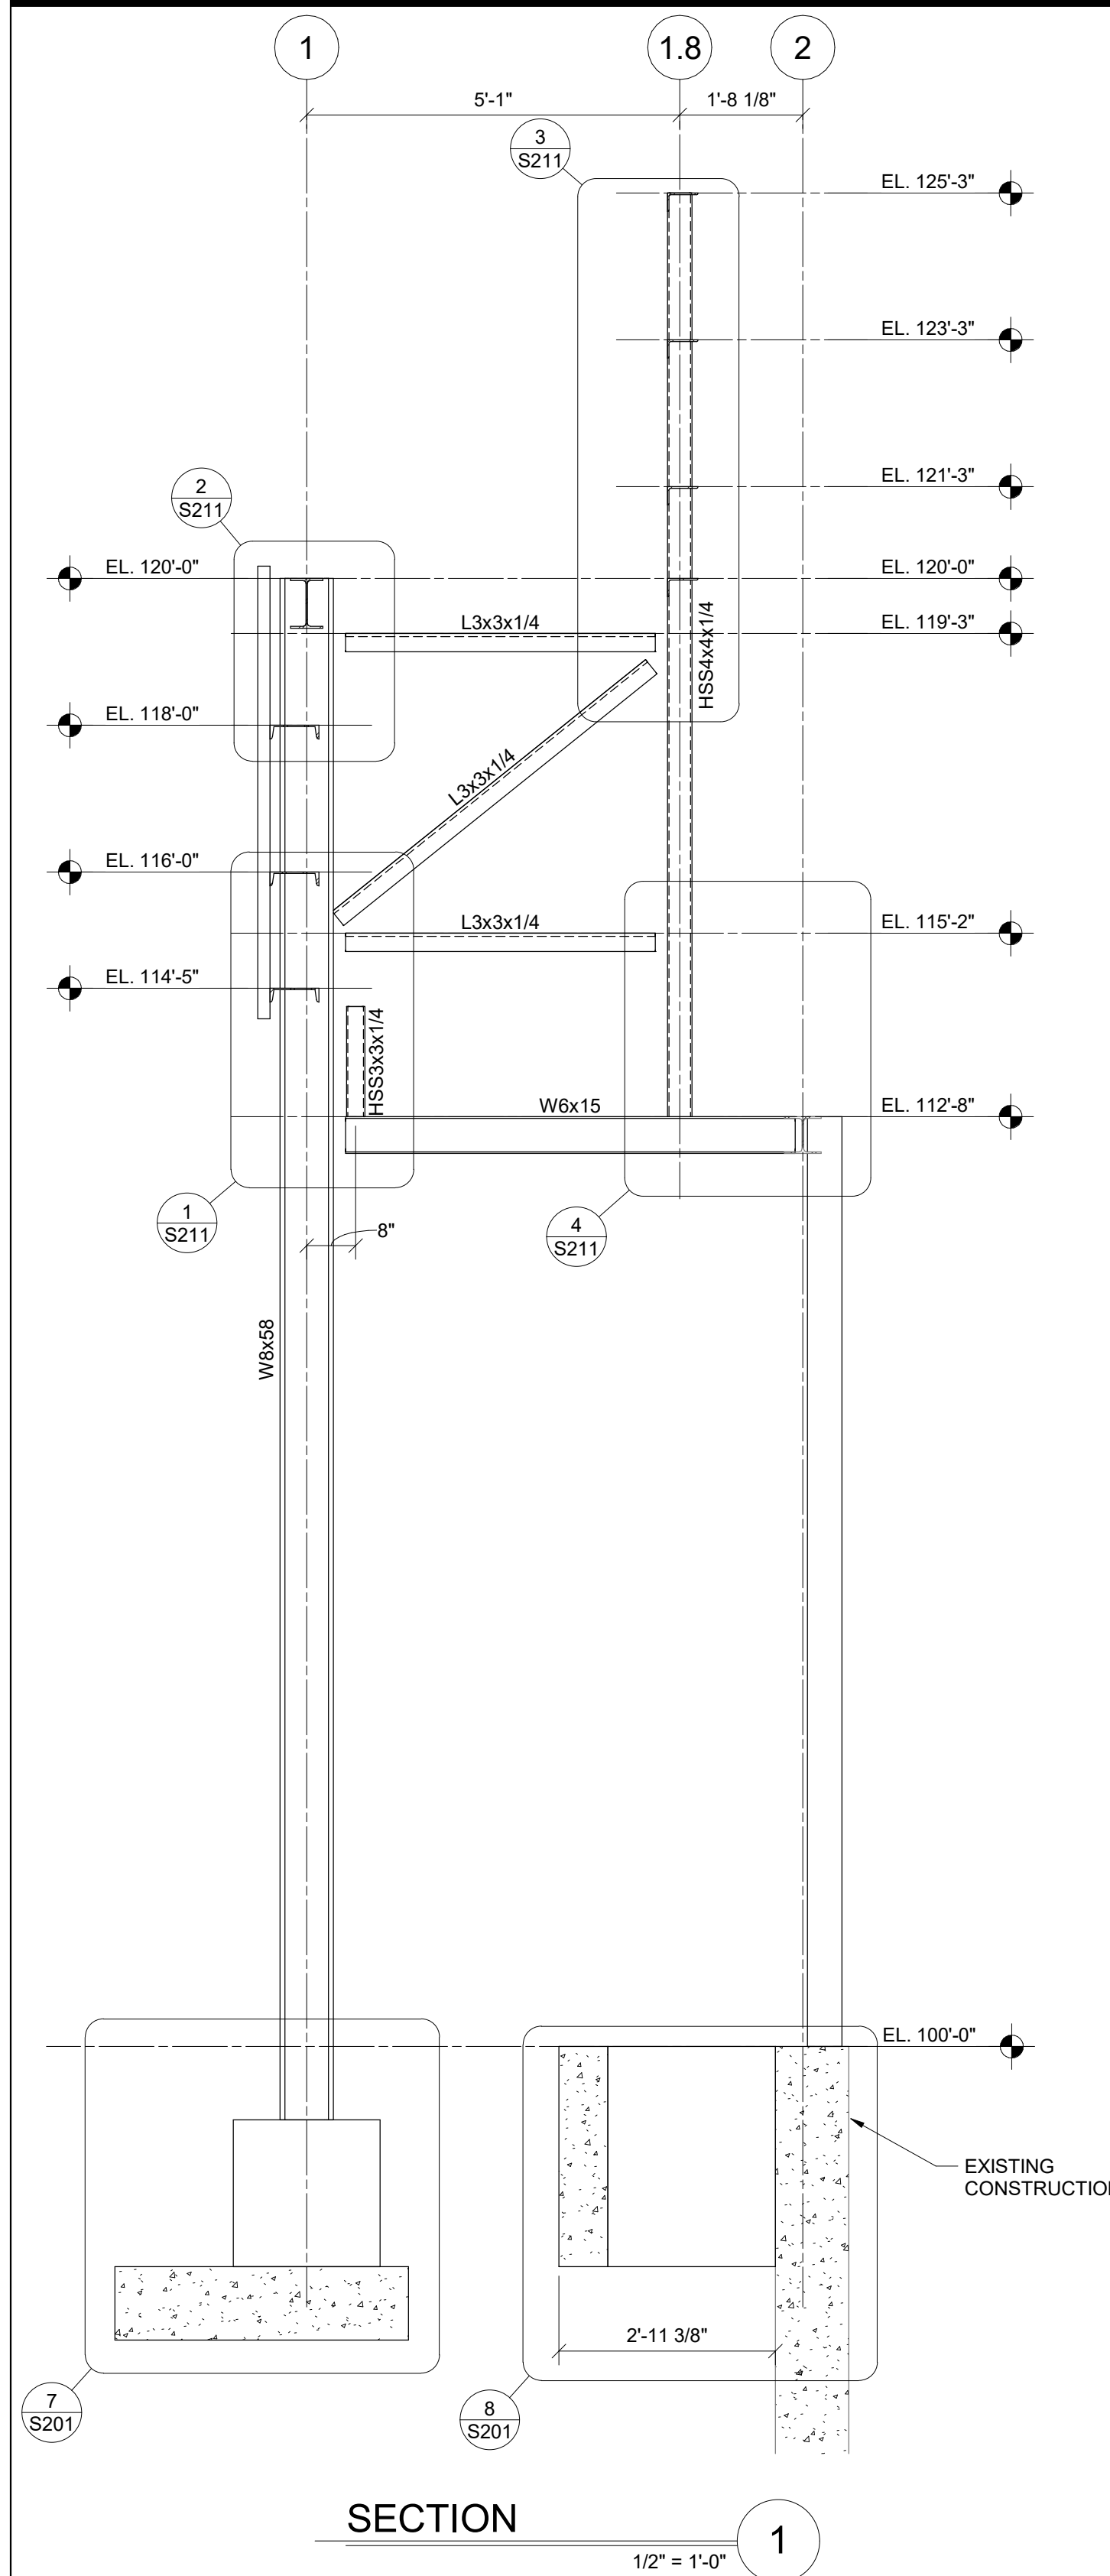


SECTION 1
1/2" = 1'-0"

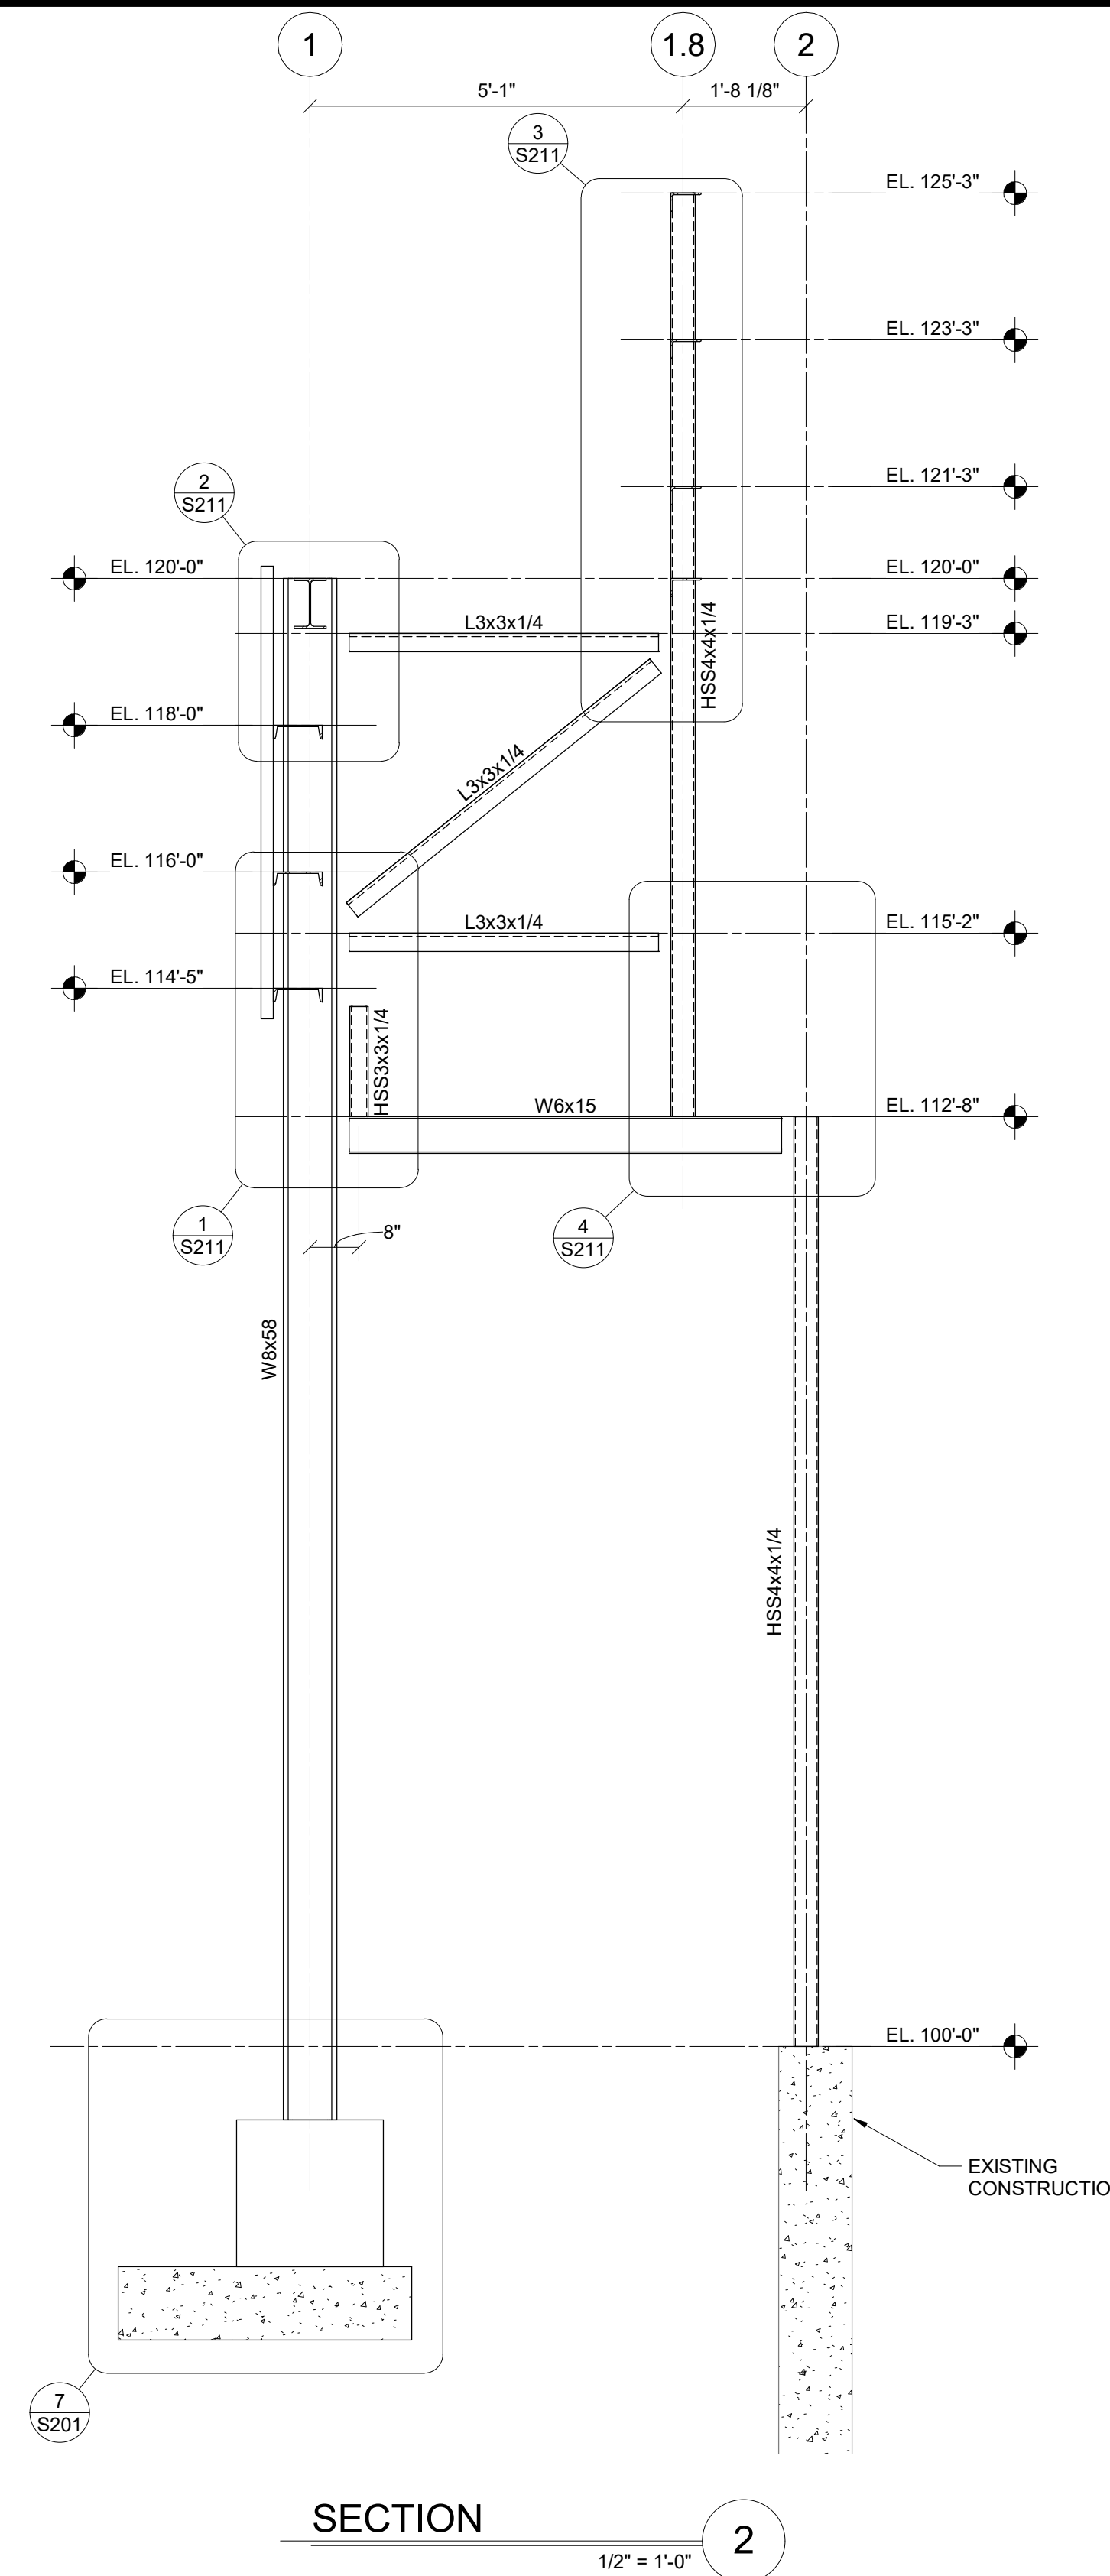


SECTION 2
1/2" = 1'-0"

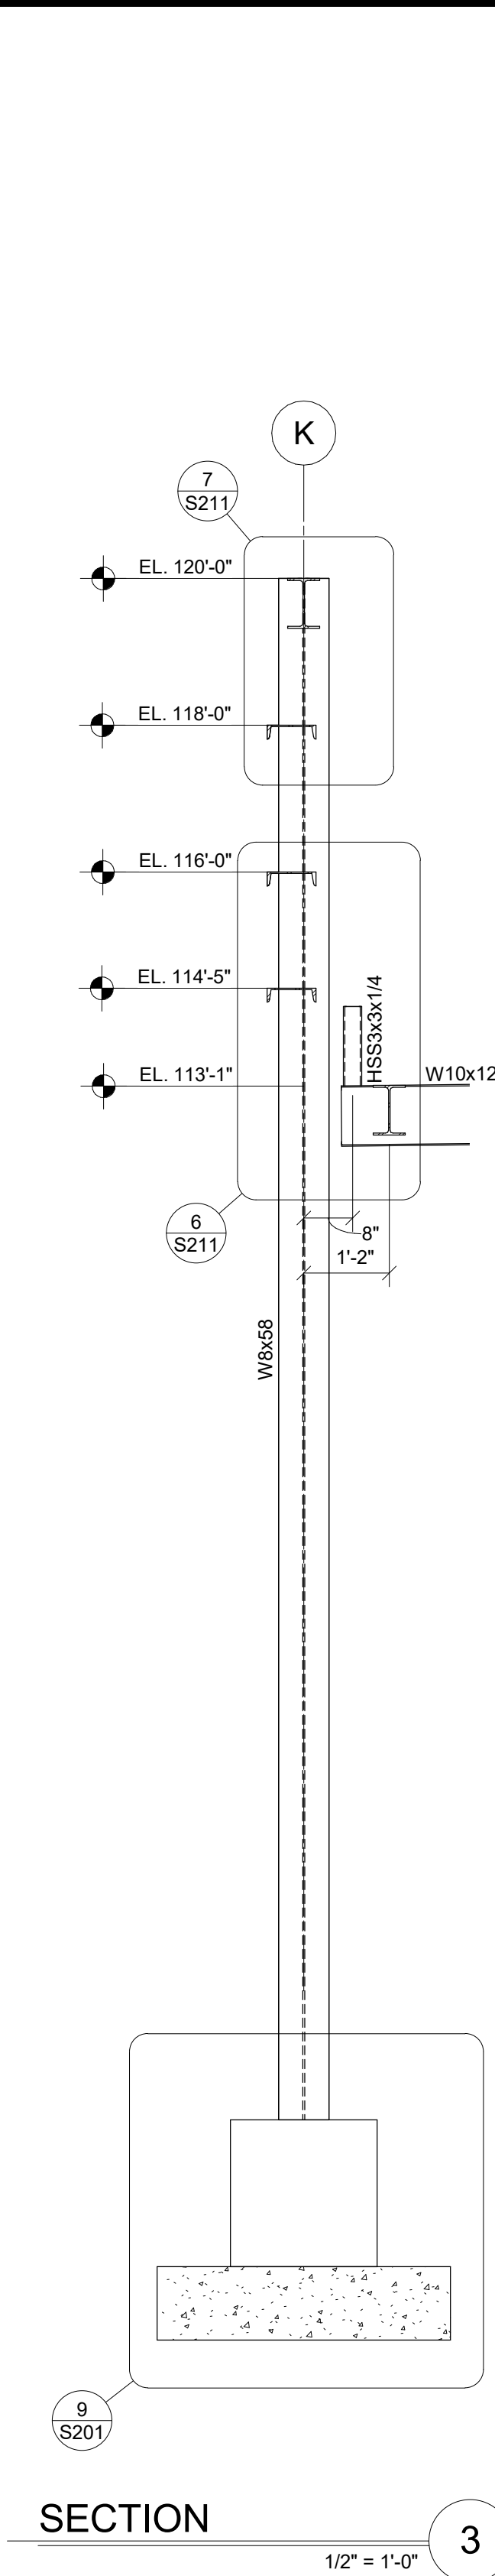

SECTION 3
1/2" = 1'-0"

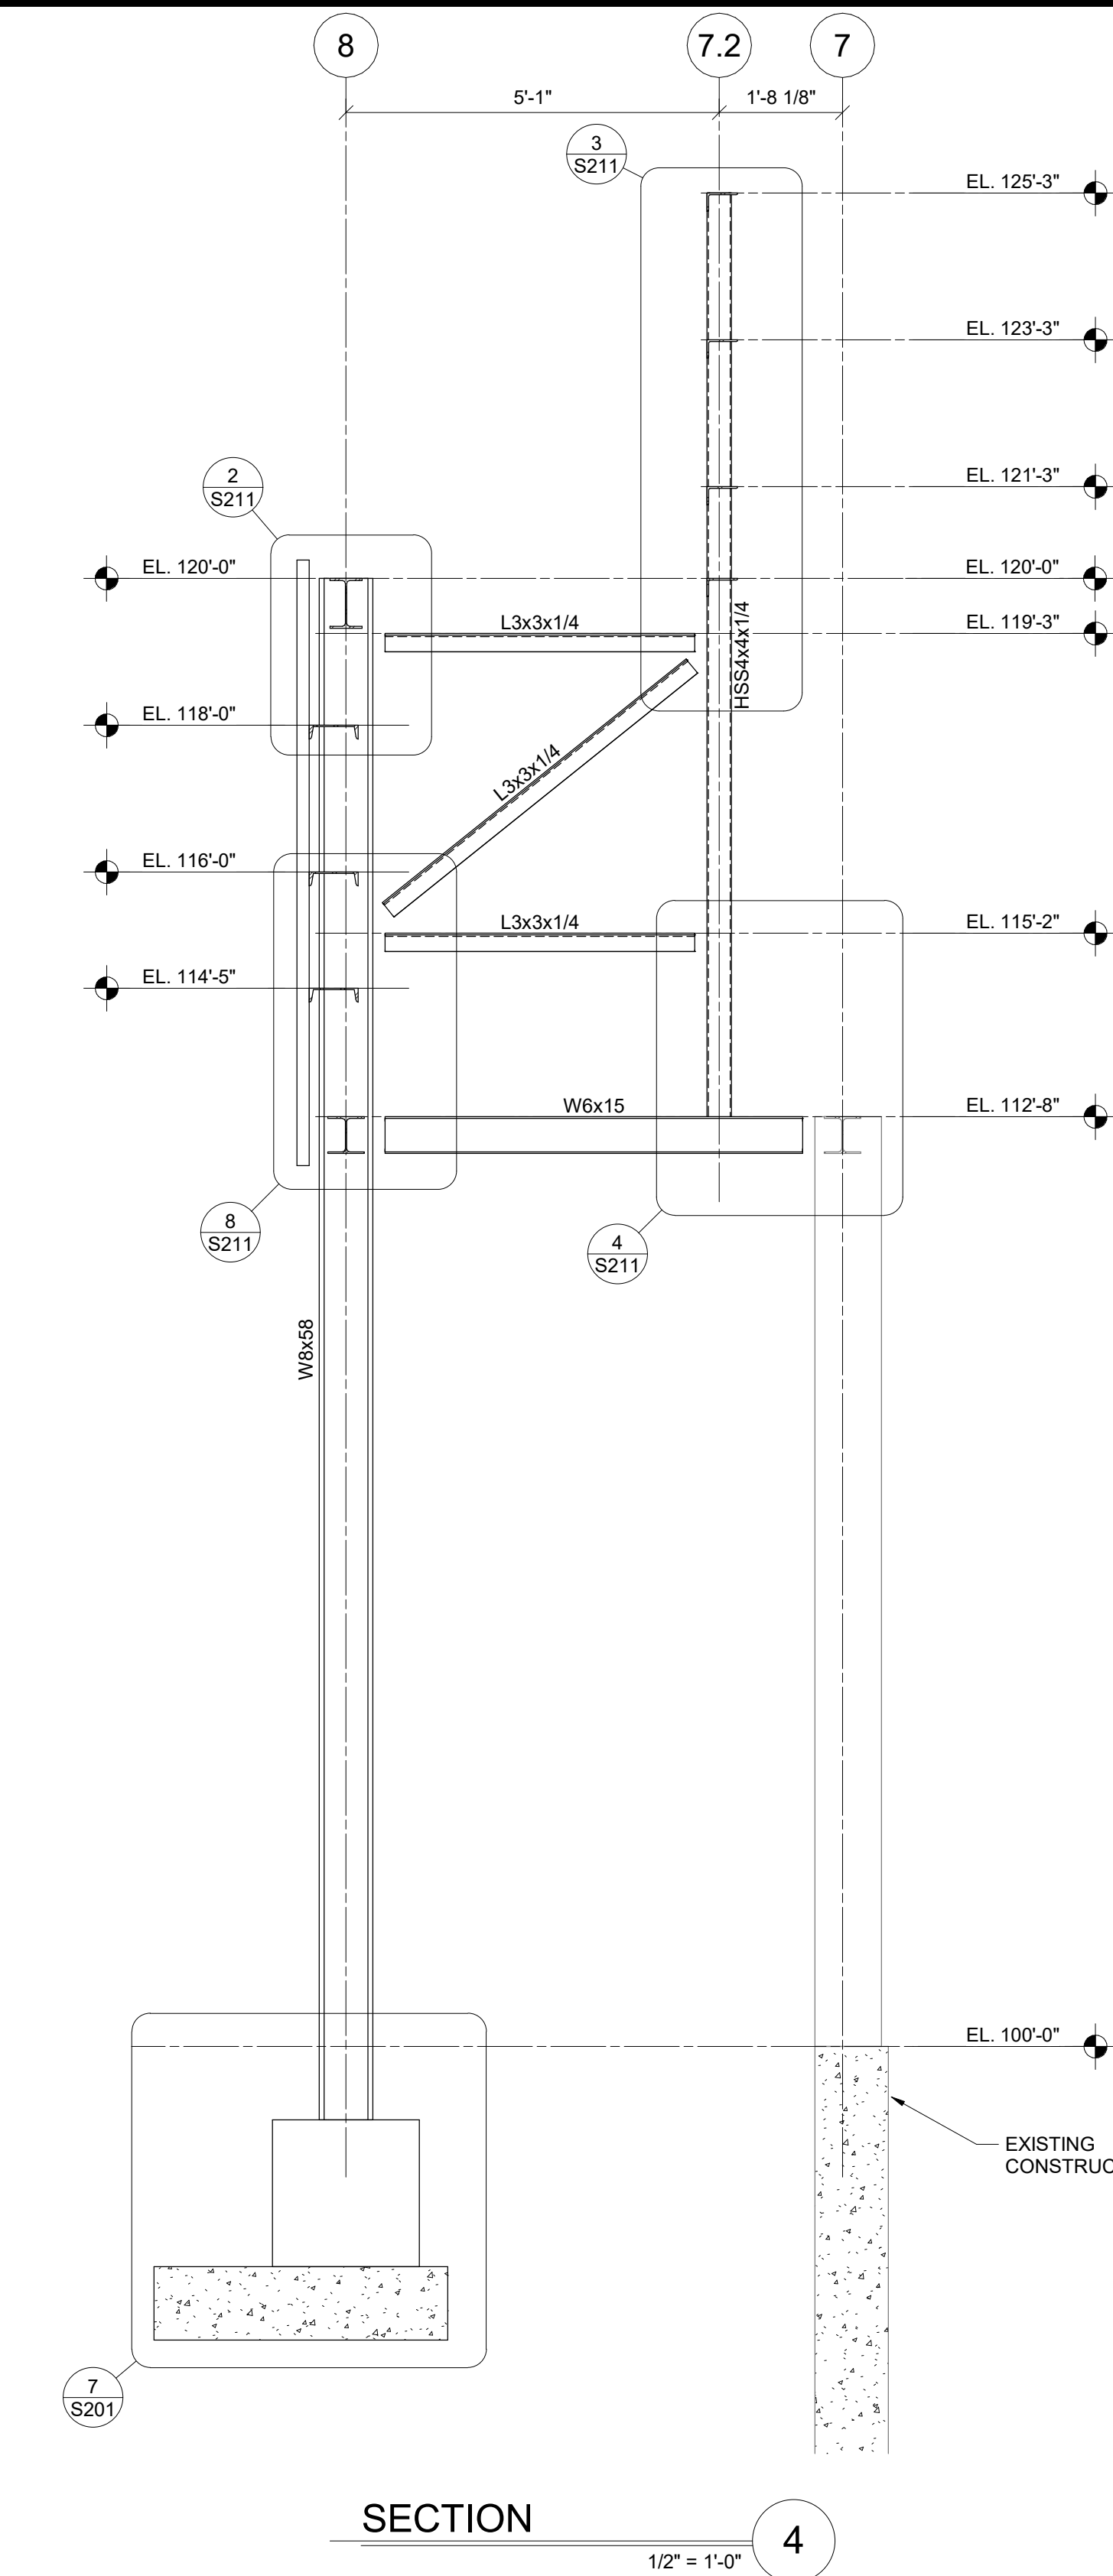

SECTION 4
1/2" = 1'-0"

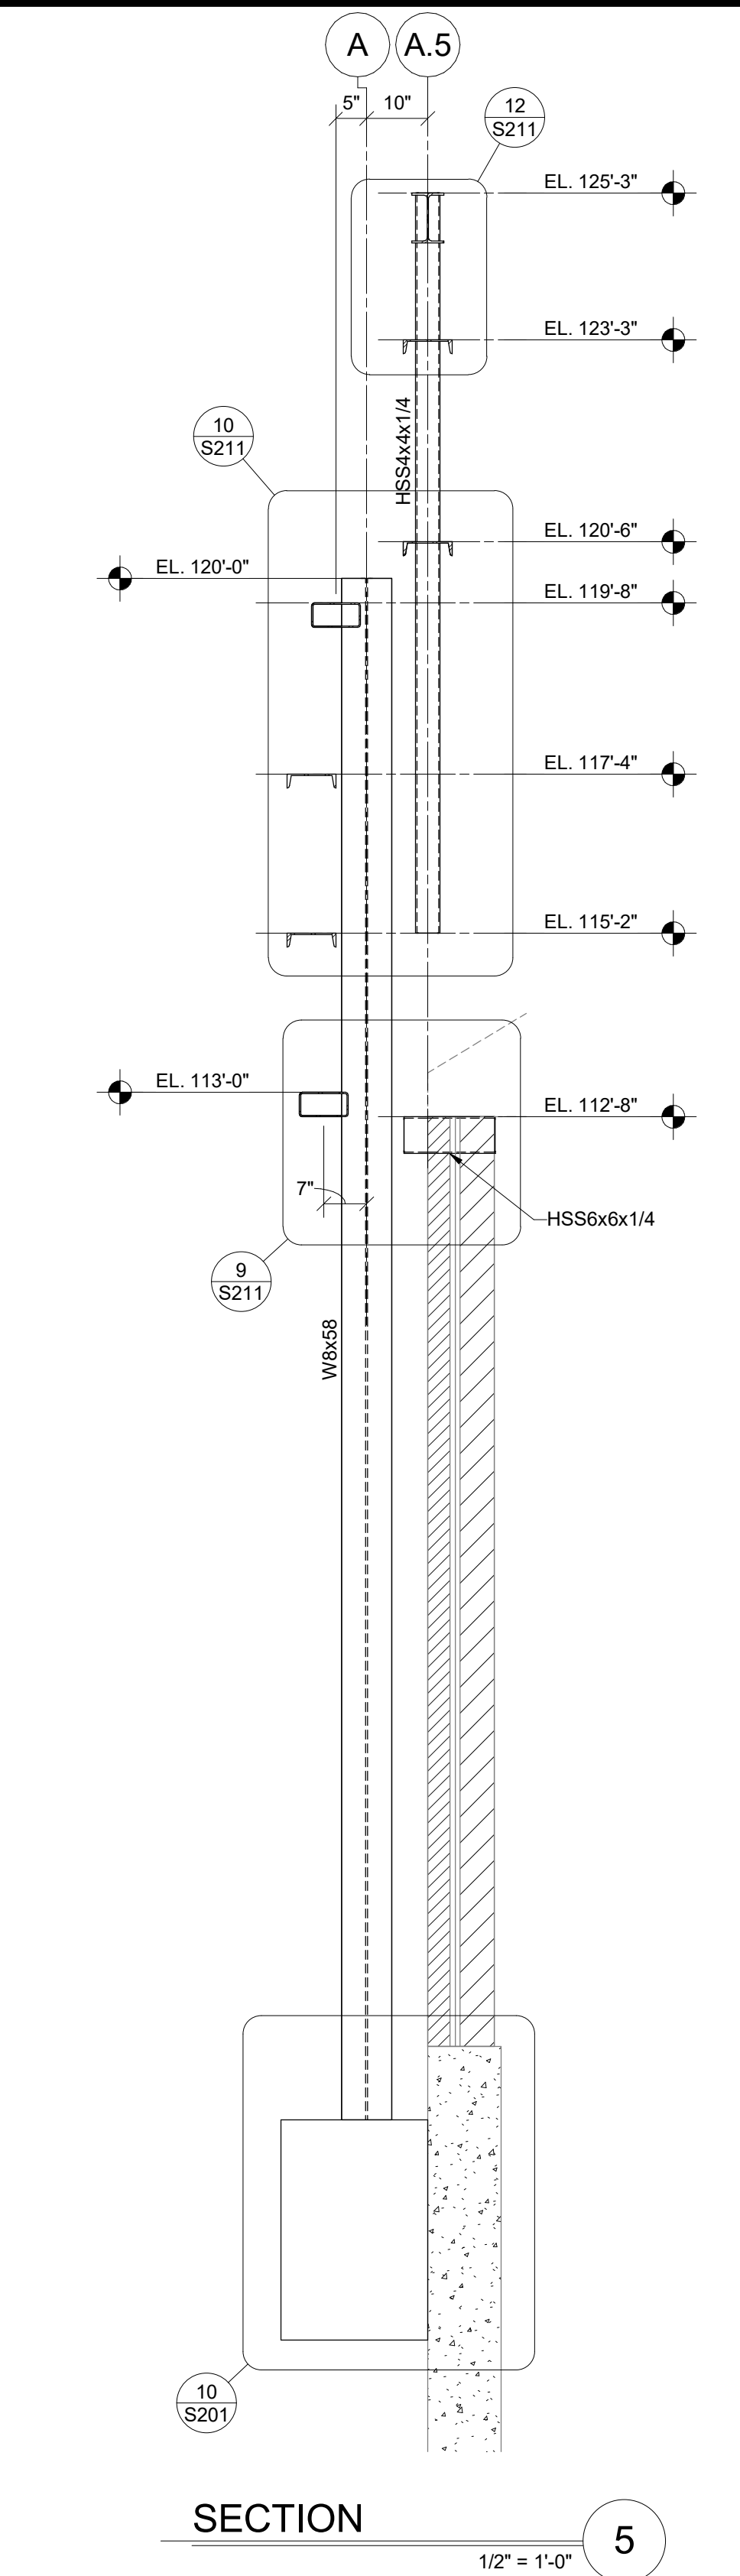

SECTION 5
1/2" = 1'-0"


#	DATE	CHANGE DESCRIPTION

RENOVATION OF HEARTLAND BANK DUBLIN
 5303 FRANTZ ROAD,
 DUBLIN OH - 43017
 FOR
HEARTLAND BANK


MOODY-NOLAN
 300 SPRUCE STREET
 SUITE 300
 COLUMBUS, OHIO 43215
 PHONE: (614) 461-4664
 FAX: (614) 280-8881

FRAMING DETAILS

PROGRESS DRAWING NOT FOR CONSTRUCTION	09/10/2020
	DRAWN BY: Author CHECKED BY: Checker
	20022
	S220
PRELIMINARY DEVELOPMENT PLAN	

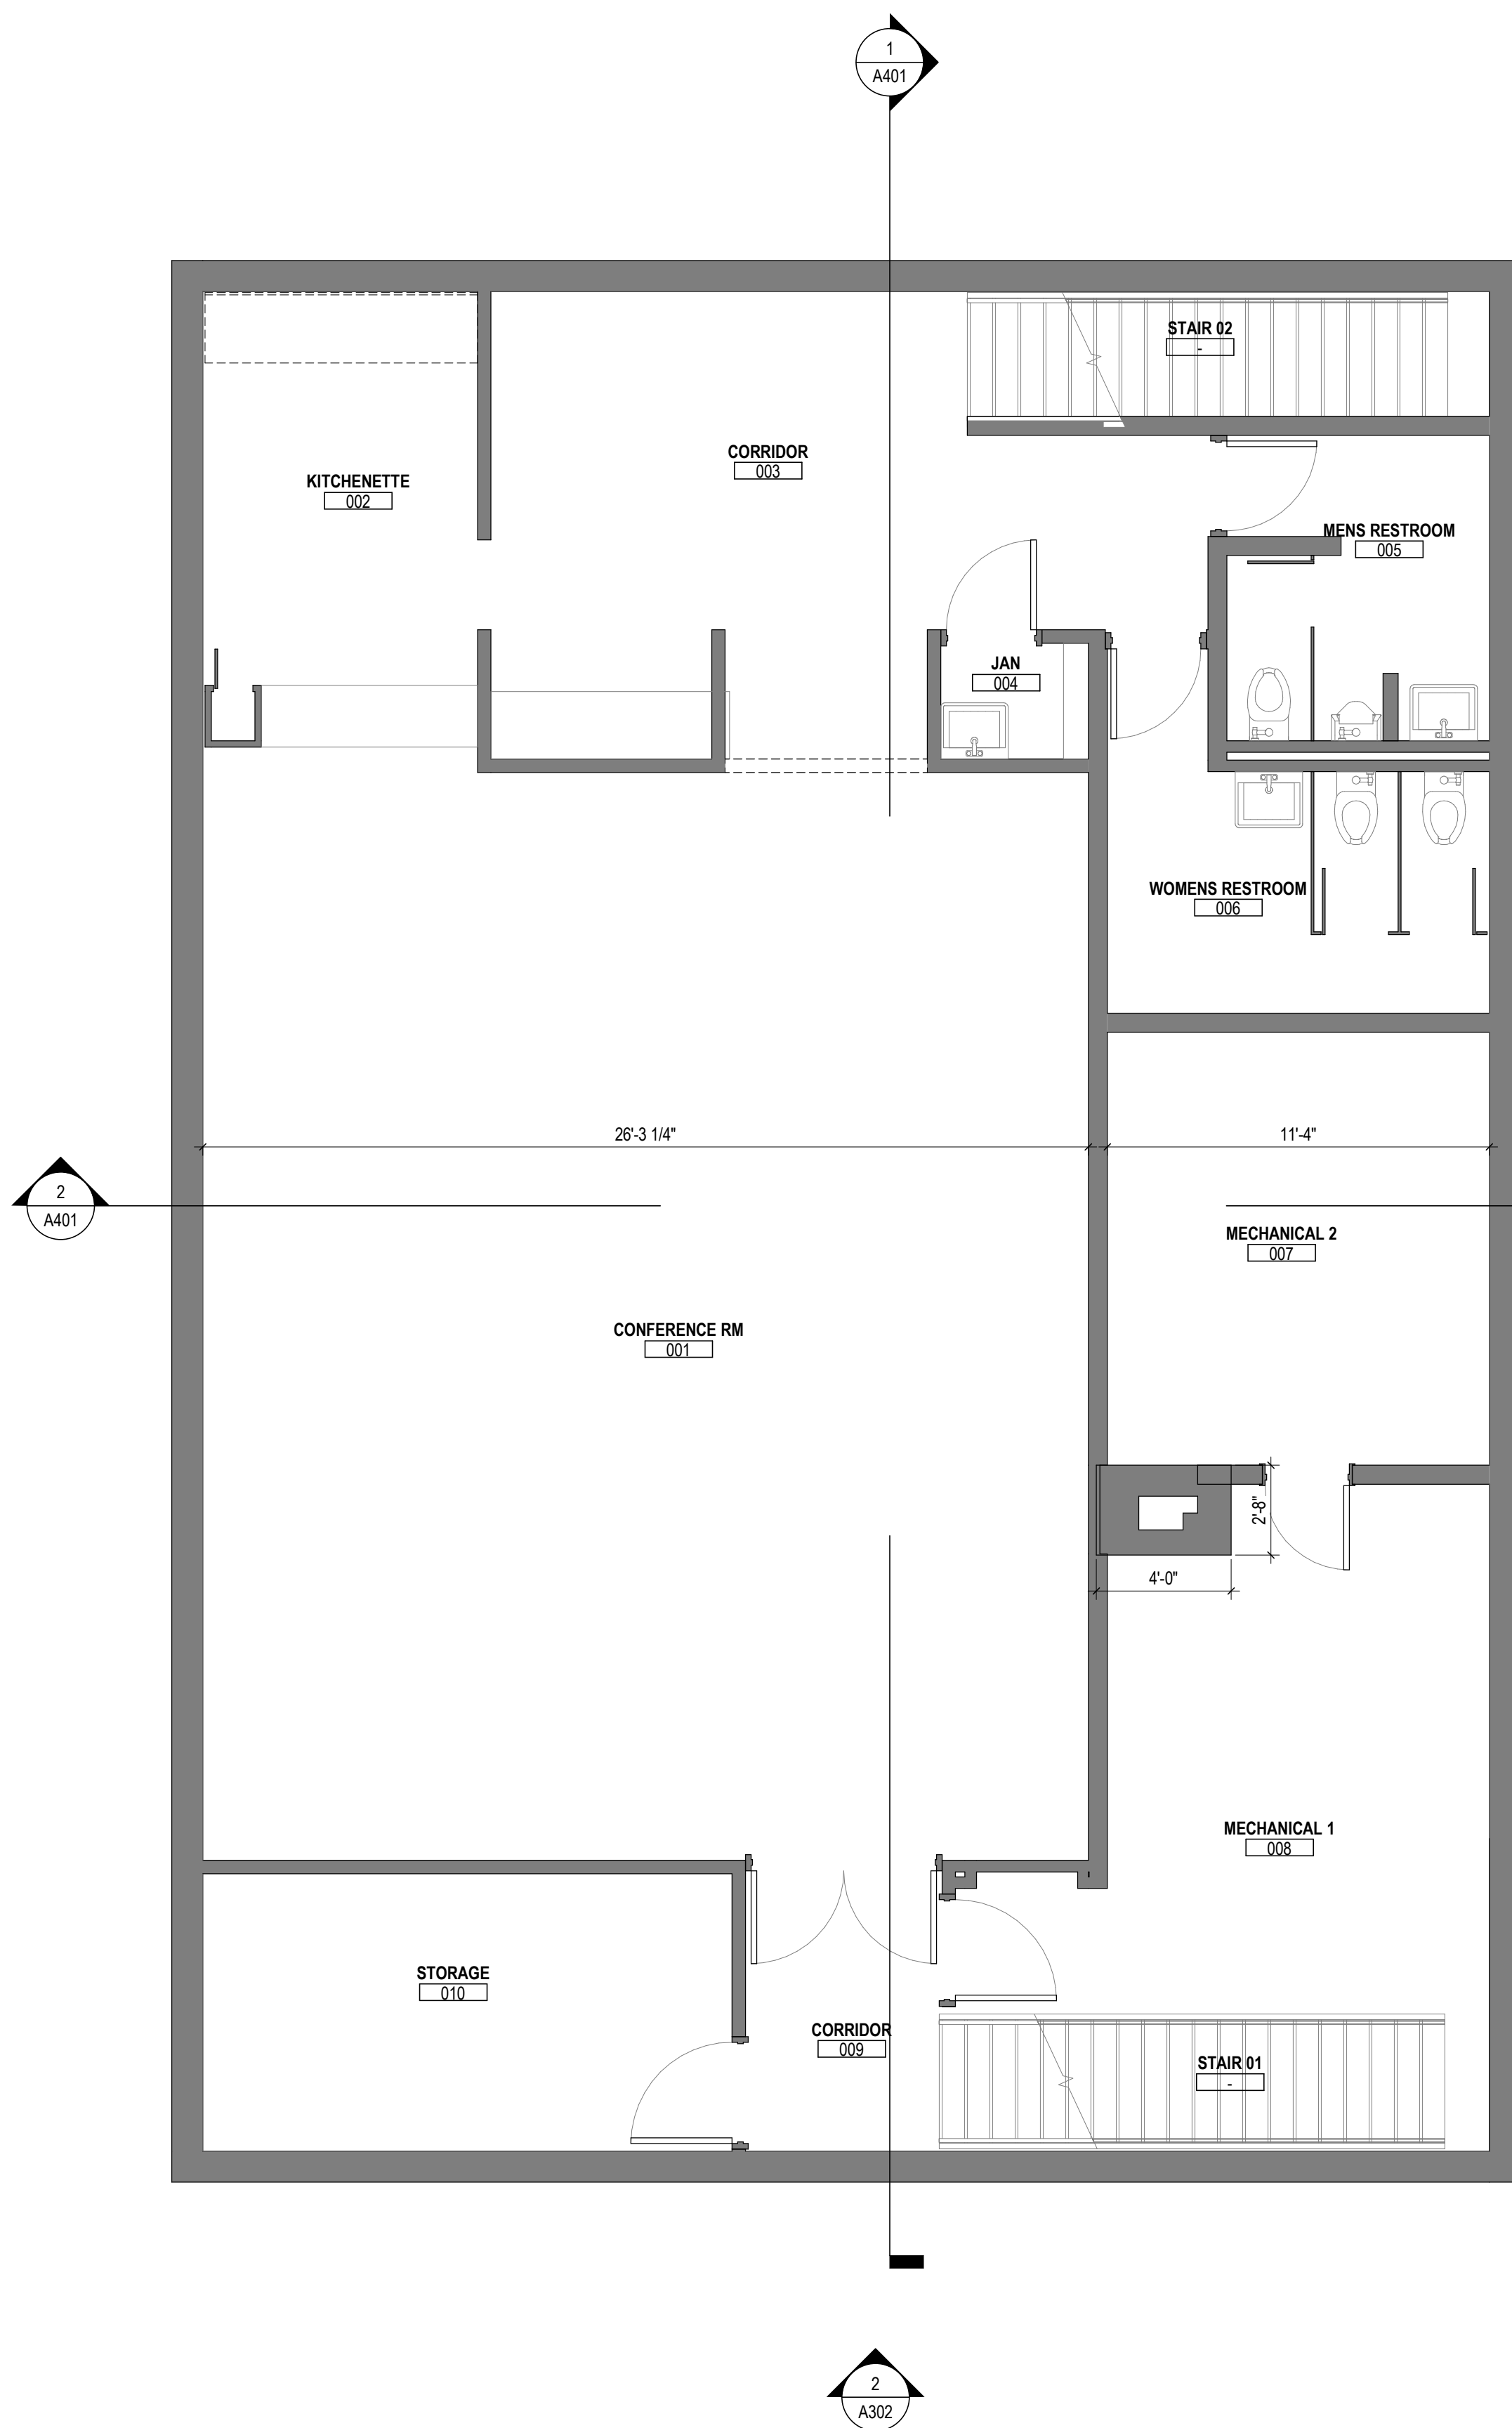

2 BASEMENT
 1/4" = 1'-0"

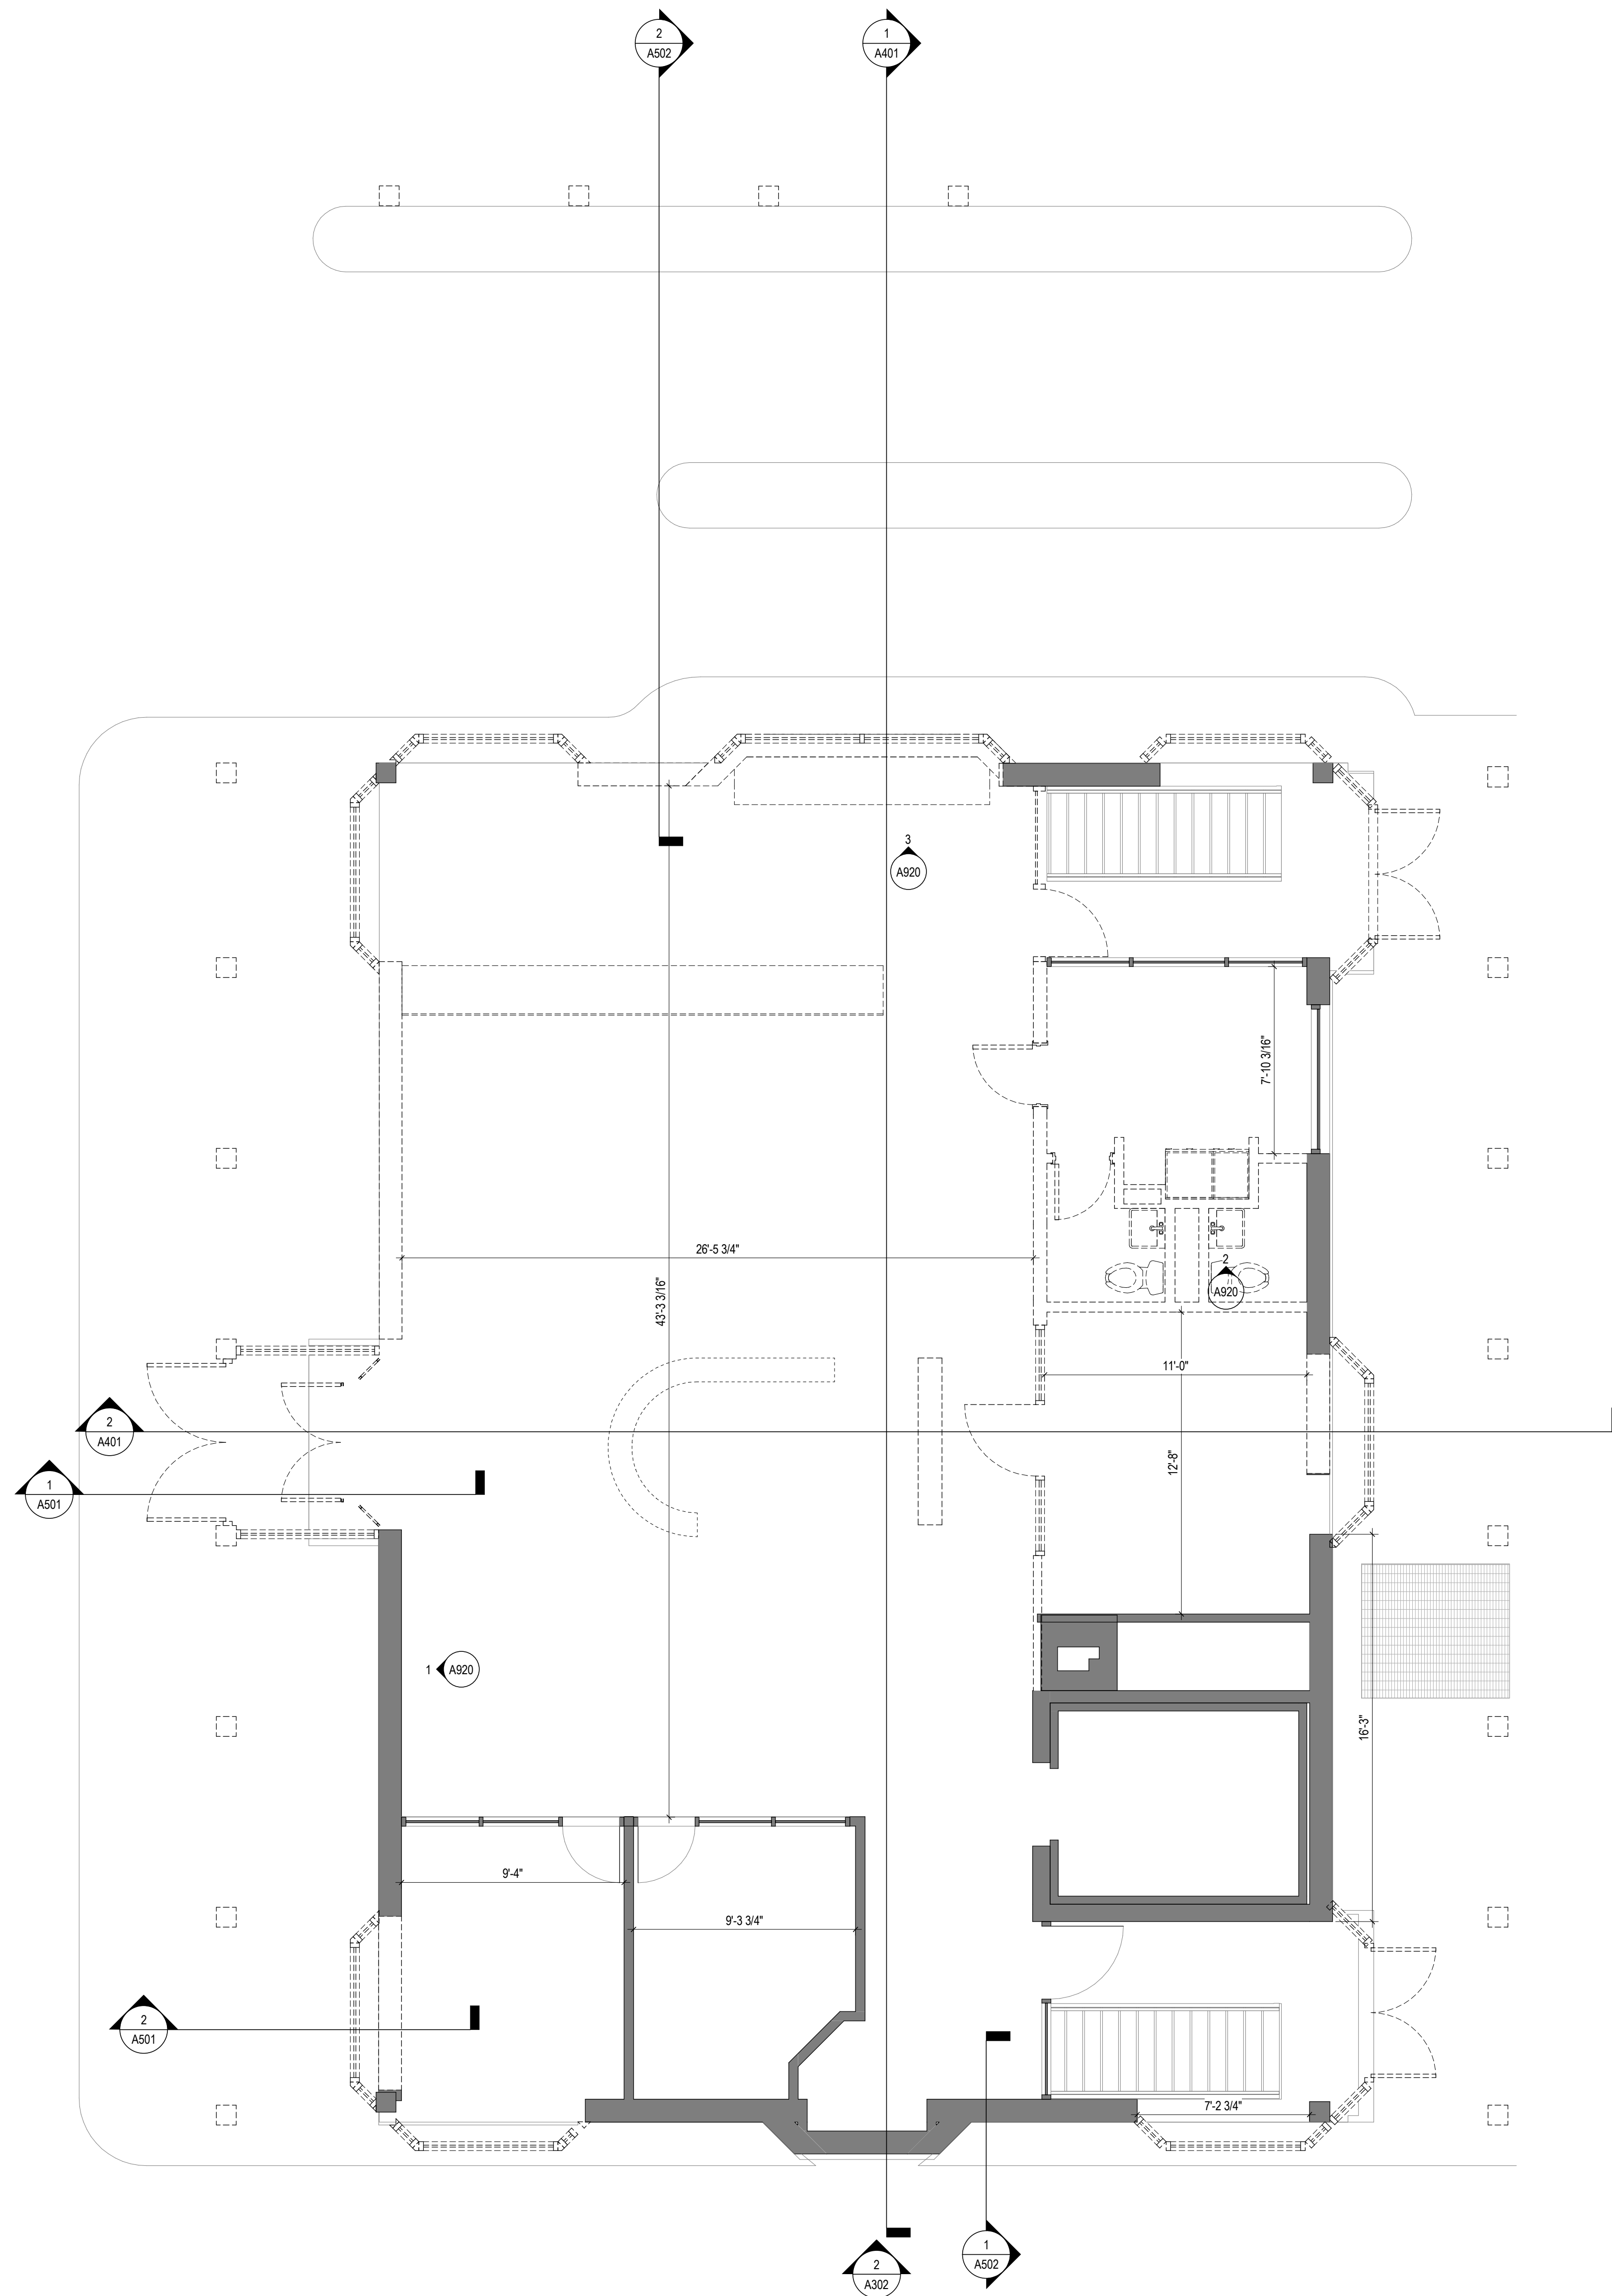

1 FIRST FLOOR
 1/4" = 1'-0"

GENERAL NOTES - DEMOLITION PLANS

1. X

DEMOLITION LEGEND

- XXX: ROOM NUMBER
- : CONSTRUCTION TO REMAIN
- : CONSTRUCTION TO BE REMOVED
- : DOOR TO REMAIN
- - -: DOOR TO BE REMOVED

#	DATE	CHANGE DESCRIPTION

RENOVATION OF HEARTLAND BANK DUBLIN
 6300 FRANTZ ROAD
 DUBLIN, OH 43017
 FOR
HEARTLAND BANK


MOODY-NOLAN
 300 SPRUCE STREET
 SUITE 300
 COLUMBUS, OHIO 43215
 PHONE: (614) 461-4664
 FAX: (614) 280-8881

DRAWING TITLE:

DEMO PLAN


PROGRESS DRAWING NOT FOR CONSTRUCTION	09/10/2020
	DRAWN BY: Author CHECKED BY: Checker
	20022
	AD101
PRELIMINARY DEVELOPMENT PLAN	

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3 SOUTH ELEVATION
1/4" = 1'-0"

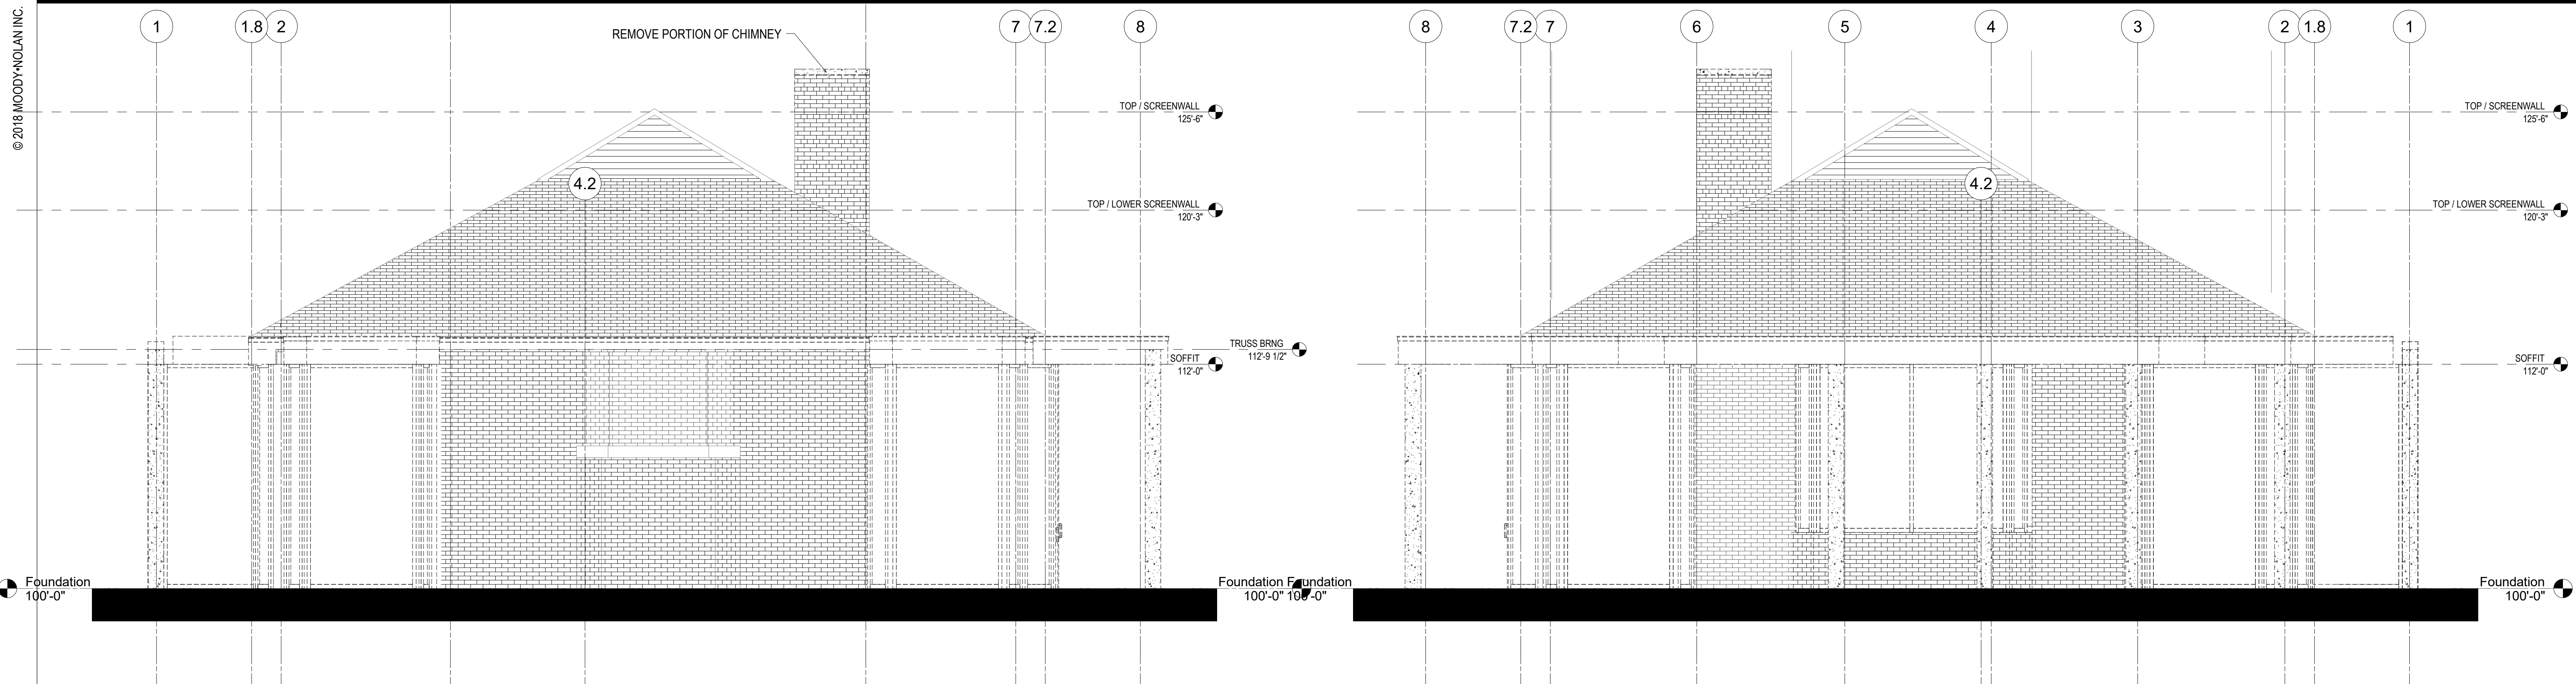2 NORTH ELEVATION
1/4" = 1'-0"



1 EAST ELEVATION
1/4" = 1'-0"

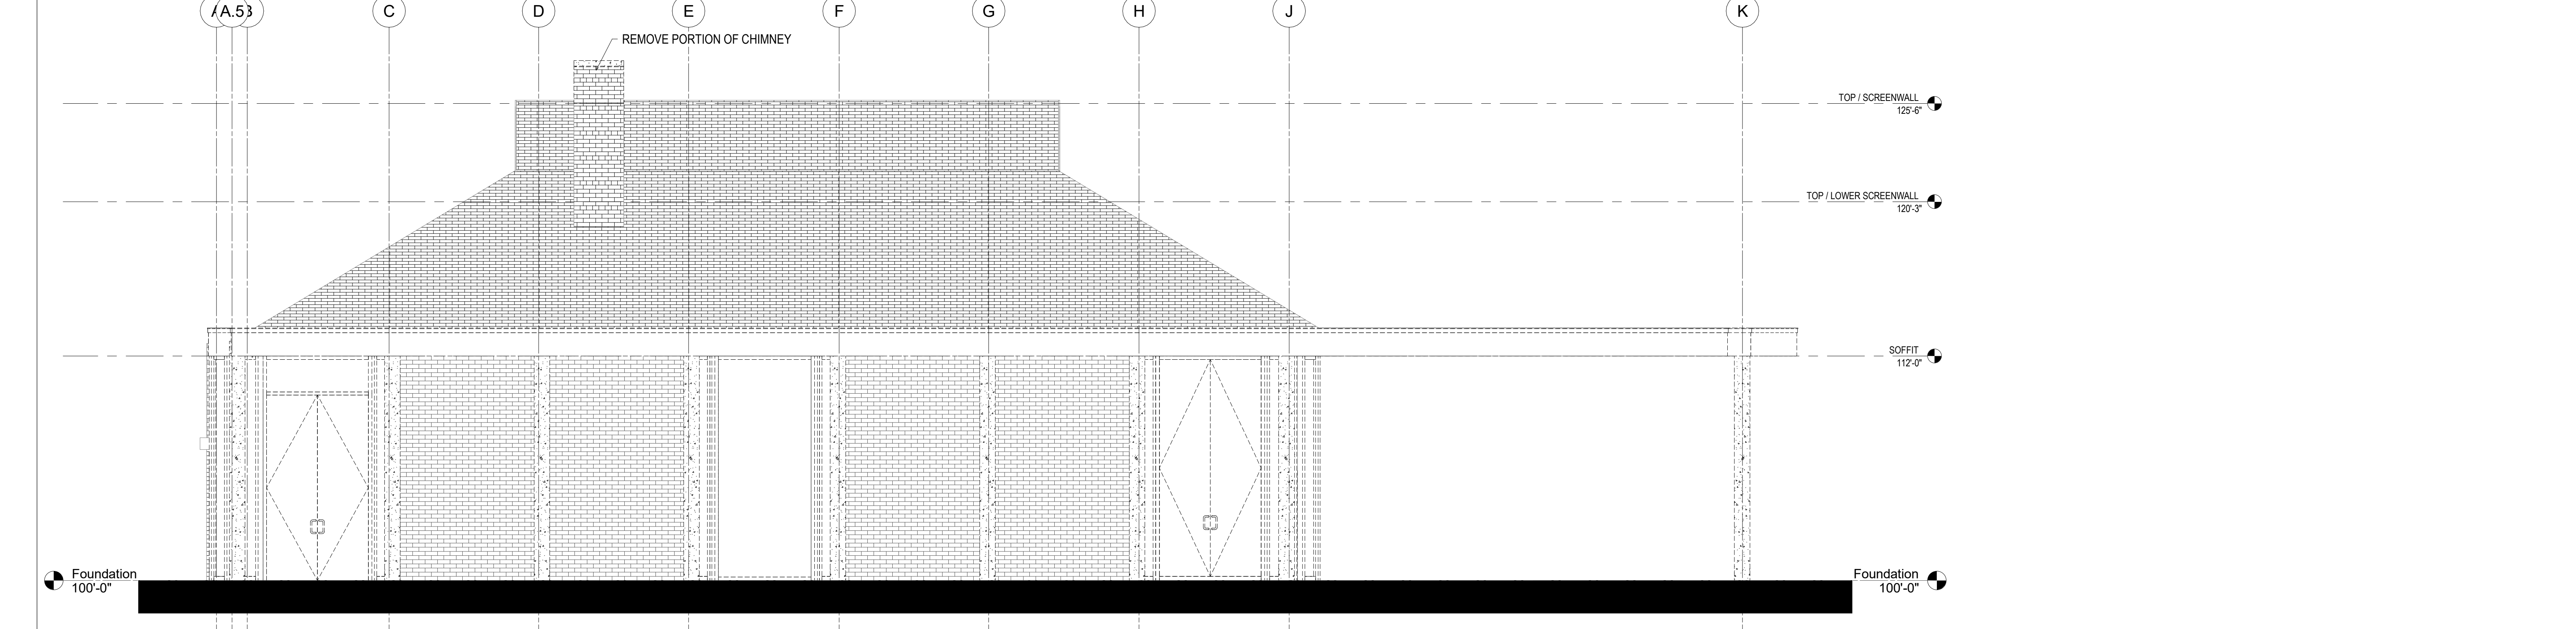4 WEST ELEVATION
1/4" = 1'-0"

GENERAL NOTES - DEMOLITION PLANS

1. X

DEMOLITION LEGEND

- XXX ROOM NUMBER
- CONSTRUCTION TO REMAIN
- - - CONSTRUCTION TO BE REMOVED
- ⊕ DOOR TO REMAIN
- ⊖ DOOR TO BE REMOVED

#	DATE	CHANGE DESCRIPTION


RENOVATION OF HEARTLAND BANK DUBLIN
5500 PRANTZ ROAD
DUBLIN, OH 43017
FOR HEARTLAND BANK

MOODY-NOLAN
300 SPRUCE STREET
SUITE 300
COLUMBUS, OHIO 43215
PHONE: (614) 461-4664
FAX: (614) 280-8881


DEMO ELEVATIONS

PROGRESS DRAWING NOT FOR CONSTRUCTION	09/10/2020
	DRAWN BY: Author CHECKED BY: Checker
	20022
AD102	
PRELIMINARY DEVELOPMENT PLAN	

PRINT DATE: 09/10/2020 11:19:40 AM
FILE INFO: C:\S\Local\Revit\Projects\2020\Projects\2022\Heartland Bank Dublin - ARCD - R04.dwg

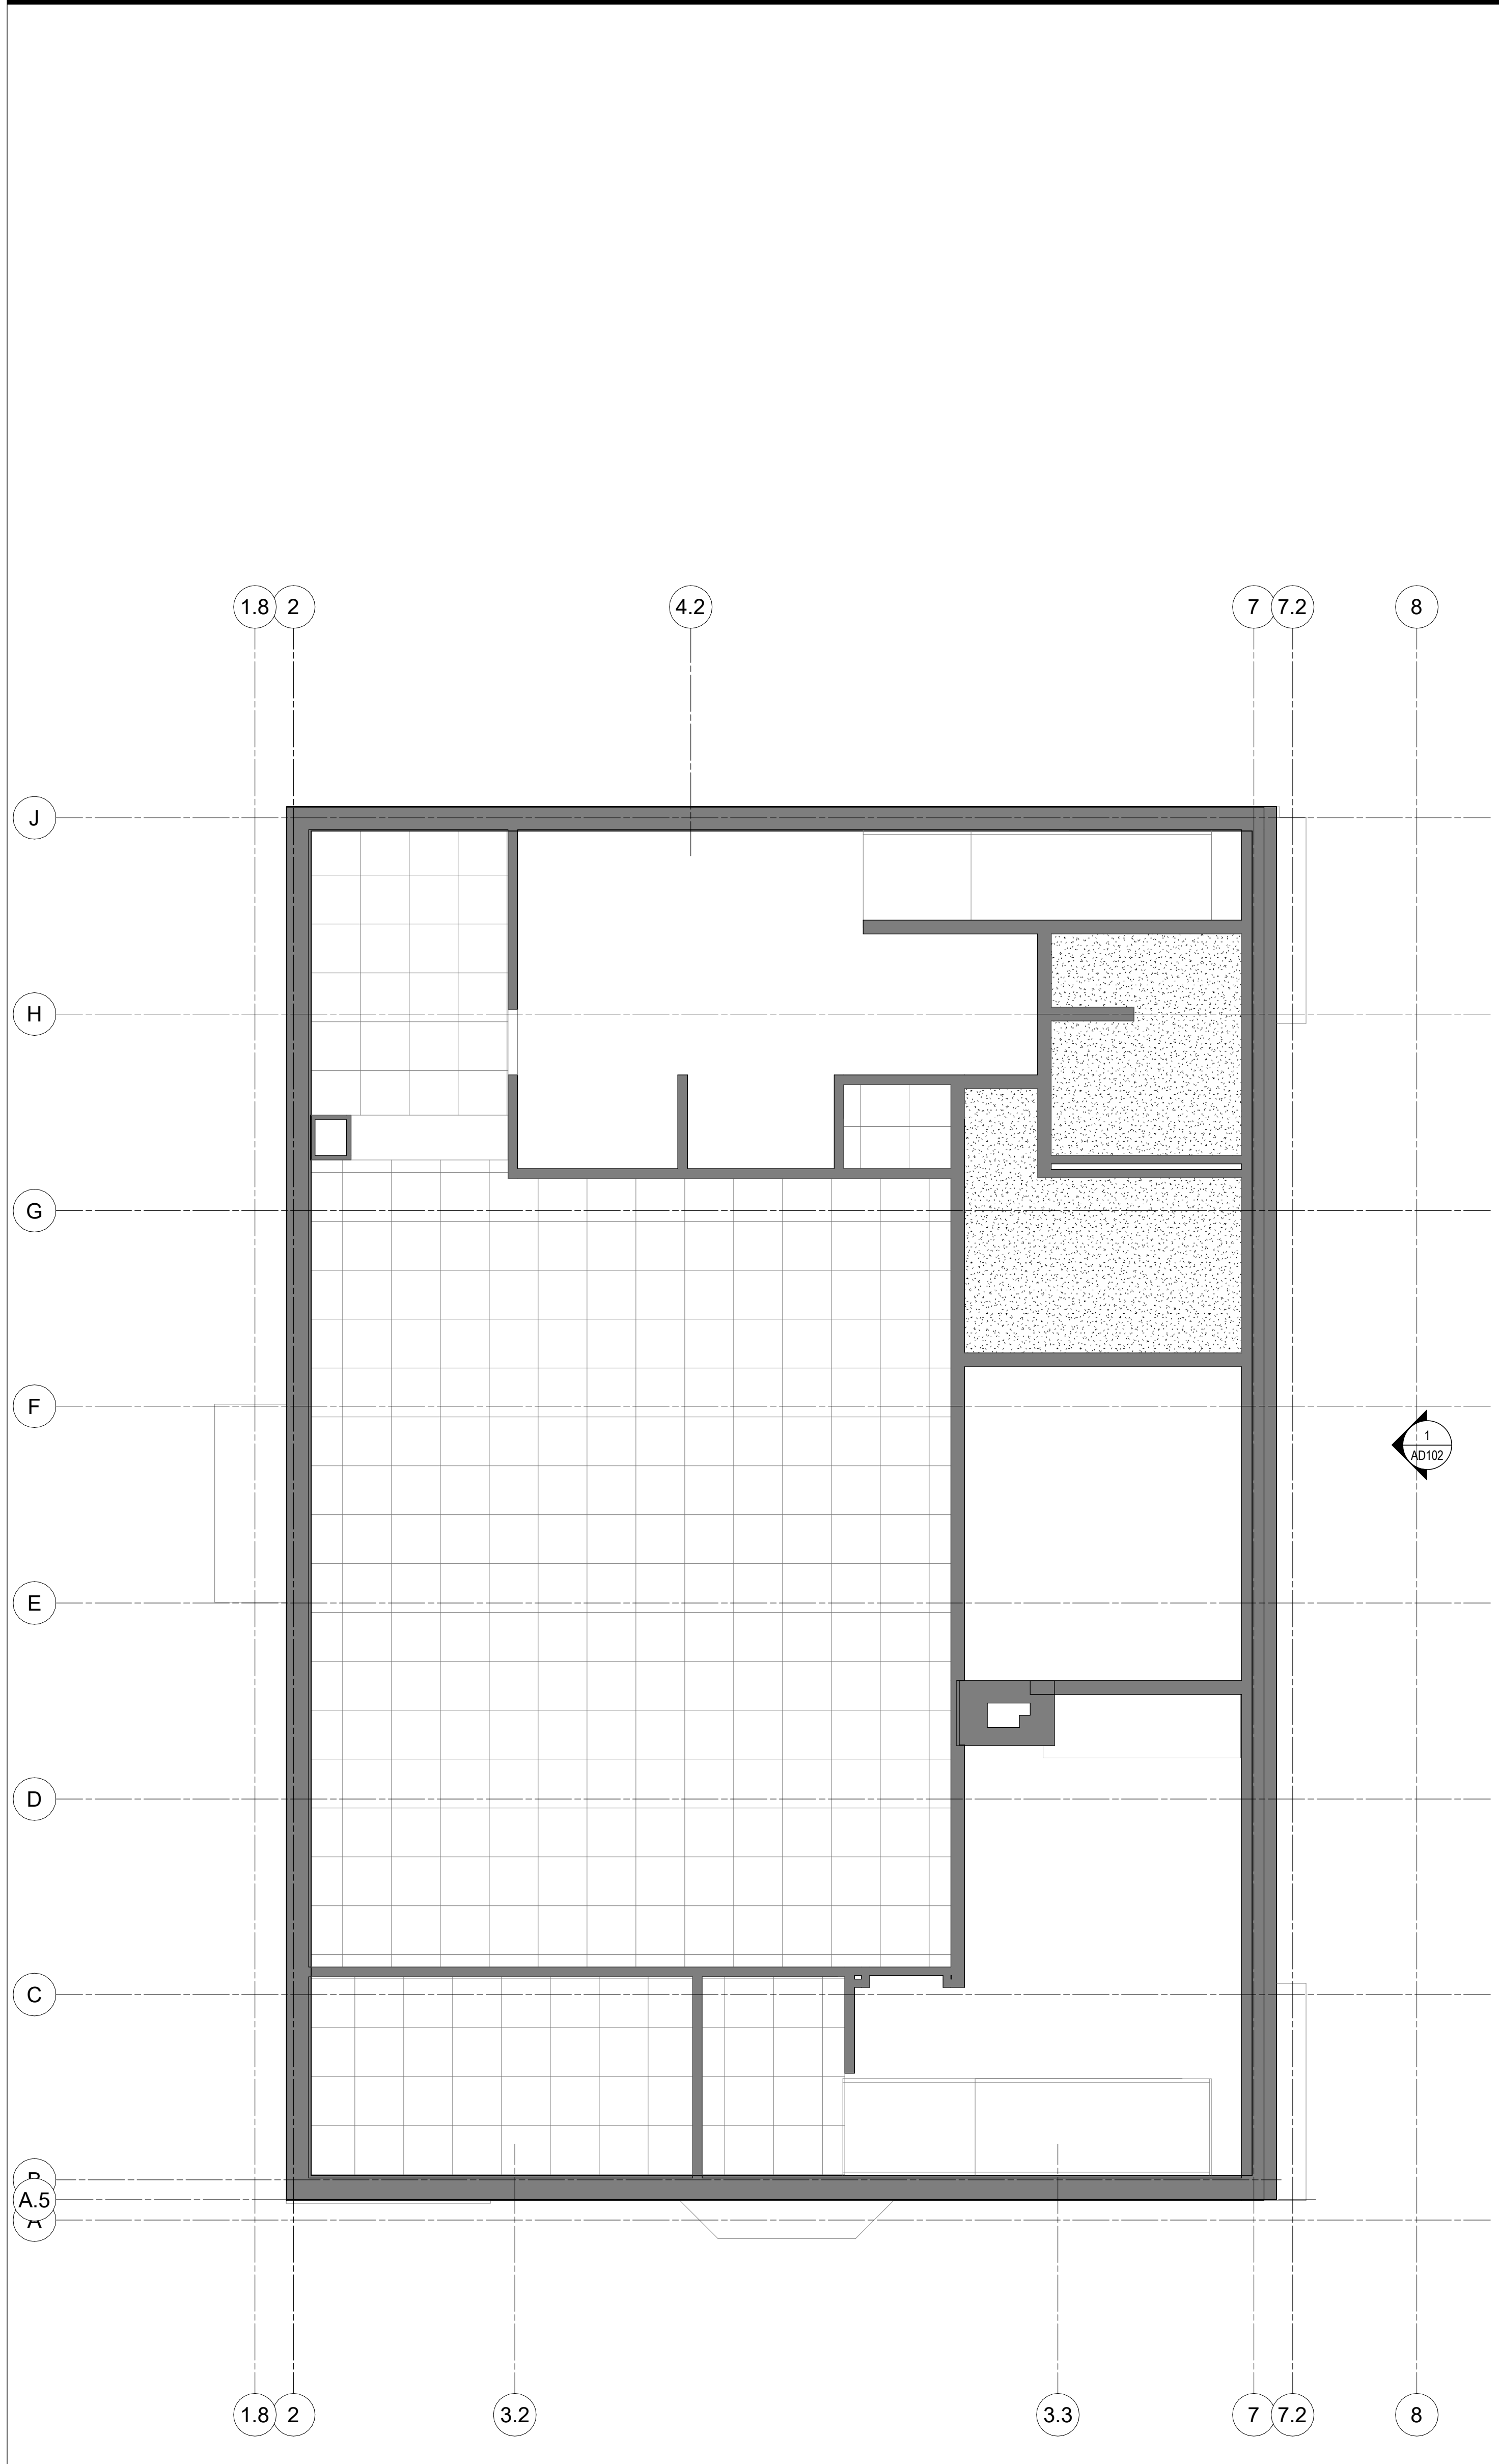

2 BASEMENT FLOOR DEMO RCP
 1/4" = 1'-0"

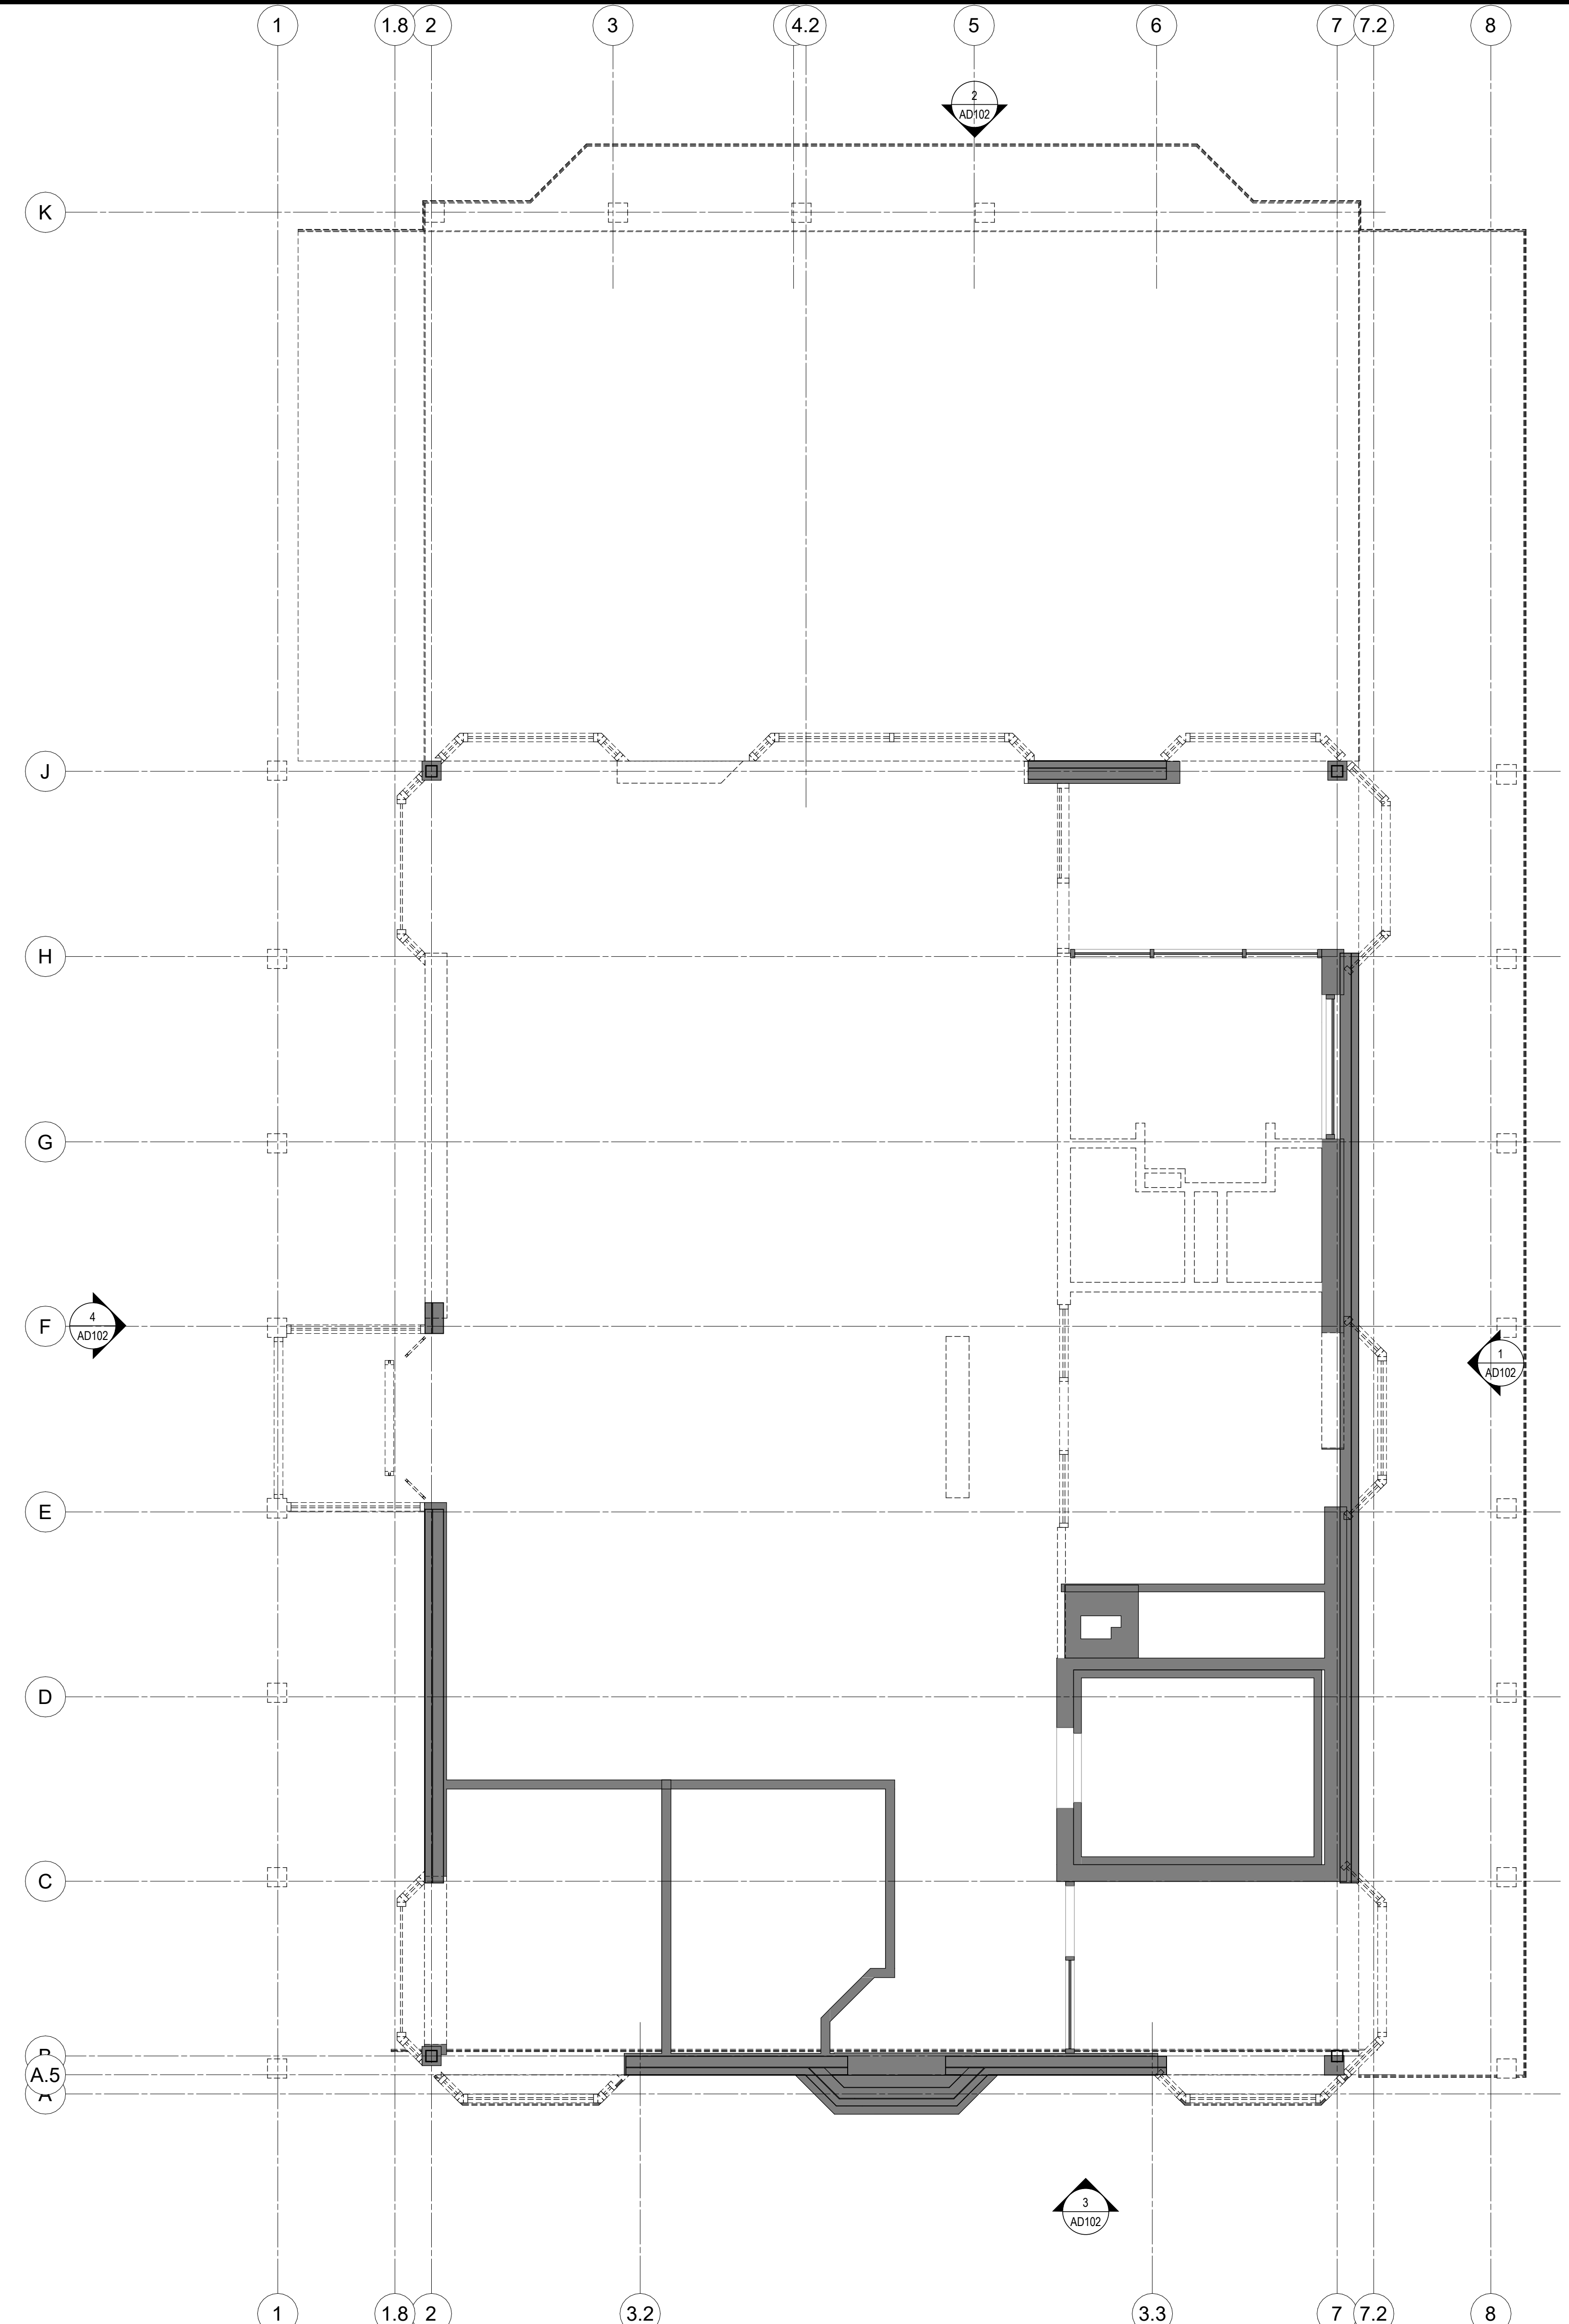

1 FIRST FLOOR DEMO RCP
 1/4" = 1'-0"

GENERAL NOTES - DEMOLITION PLANS

1. X

DEMOLITION LEGEND

- XXX ROOM NUMBER
- CONSTRUCTION TO REMAIN
- - - CONSTRUCTION TO BE REMOVED
- DOOR TO REMAIN
- - - DOOR TO BE REMOVED

#	DATE	CHANGE DESCRIPTION

RENOVATION OF HEARTLAND BANK DUBLIN
 5500 FRANTZ ROAD
 DUBLIN, OH 43017
 FOR
HEARTLAND BANK


MOODY-NOLAN
 300 SPRUCE STREET
 SUITE 300
 COLUMBUS, OHIO 43215
 PHONE: (614) 461-4664
 FAX: (614) 280-8881

DEMO RCP

PROGRESS DRAWING NOT FOR CONSTRUCTION	09/10/2020 DRAWN BY: Author CHECKED BY: Checker
	20022
	AD201 PRELIMINARY DEVELOPMENT PLAN

STATE RT. #33

FRANTZ ROAD

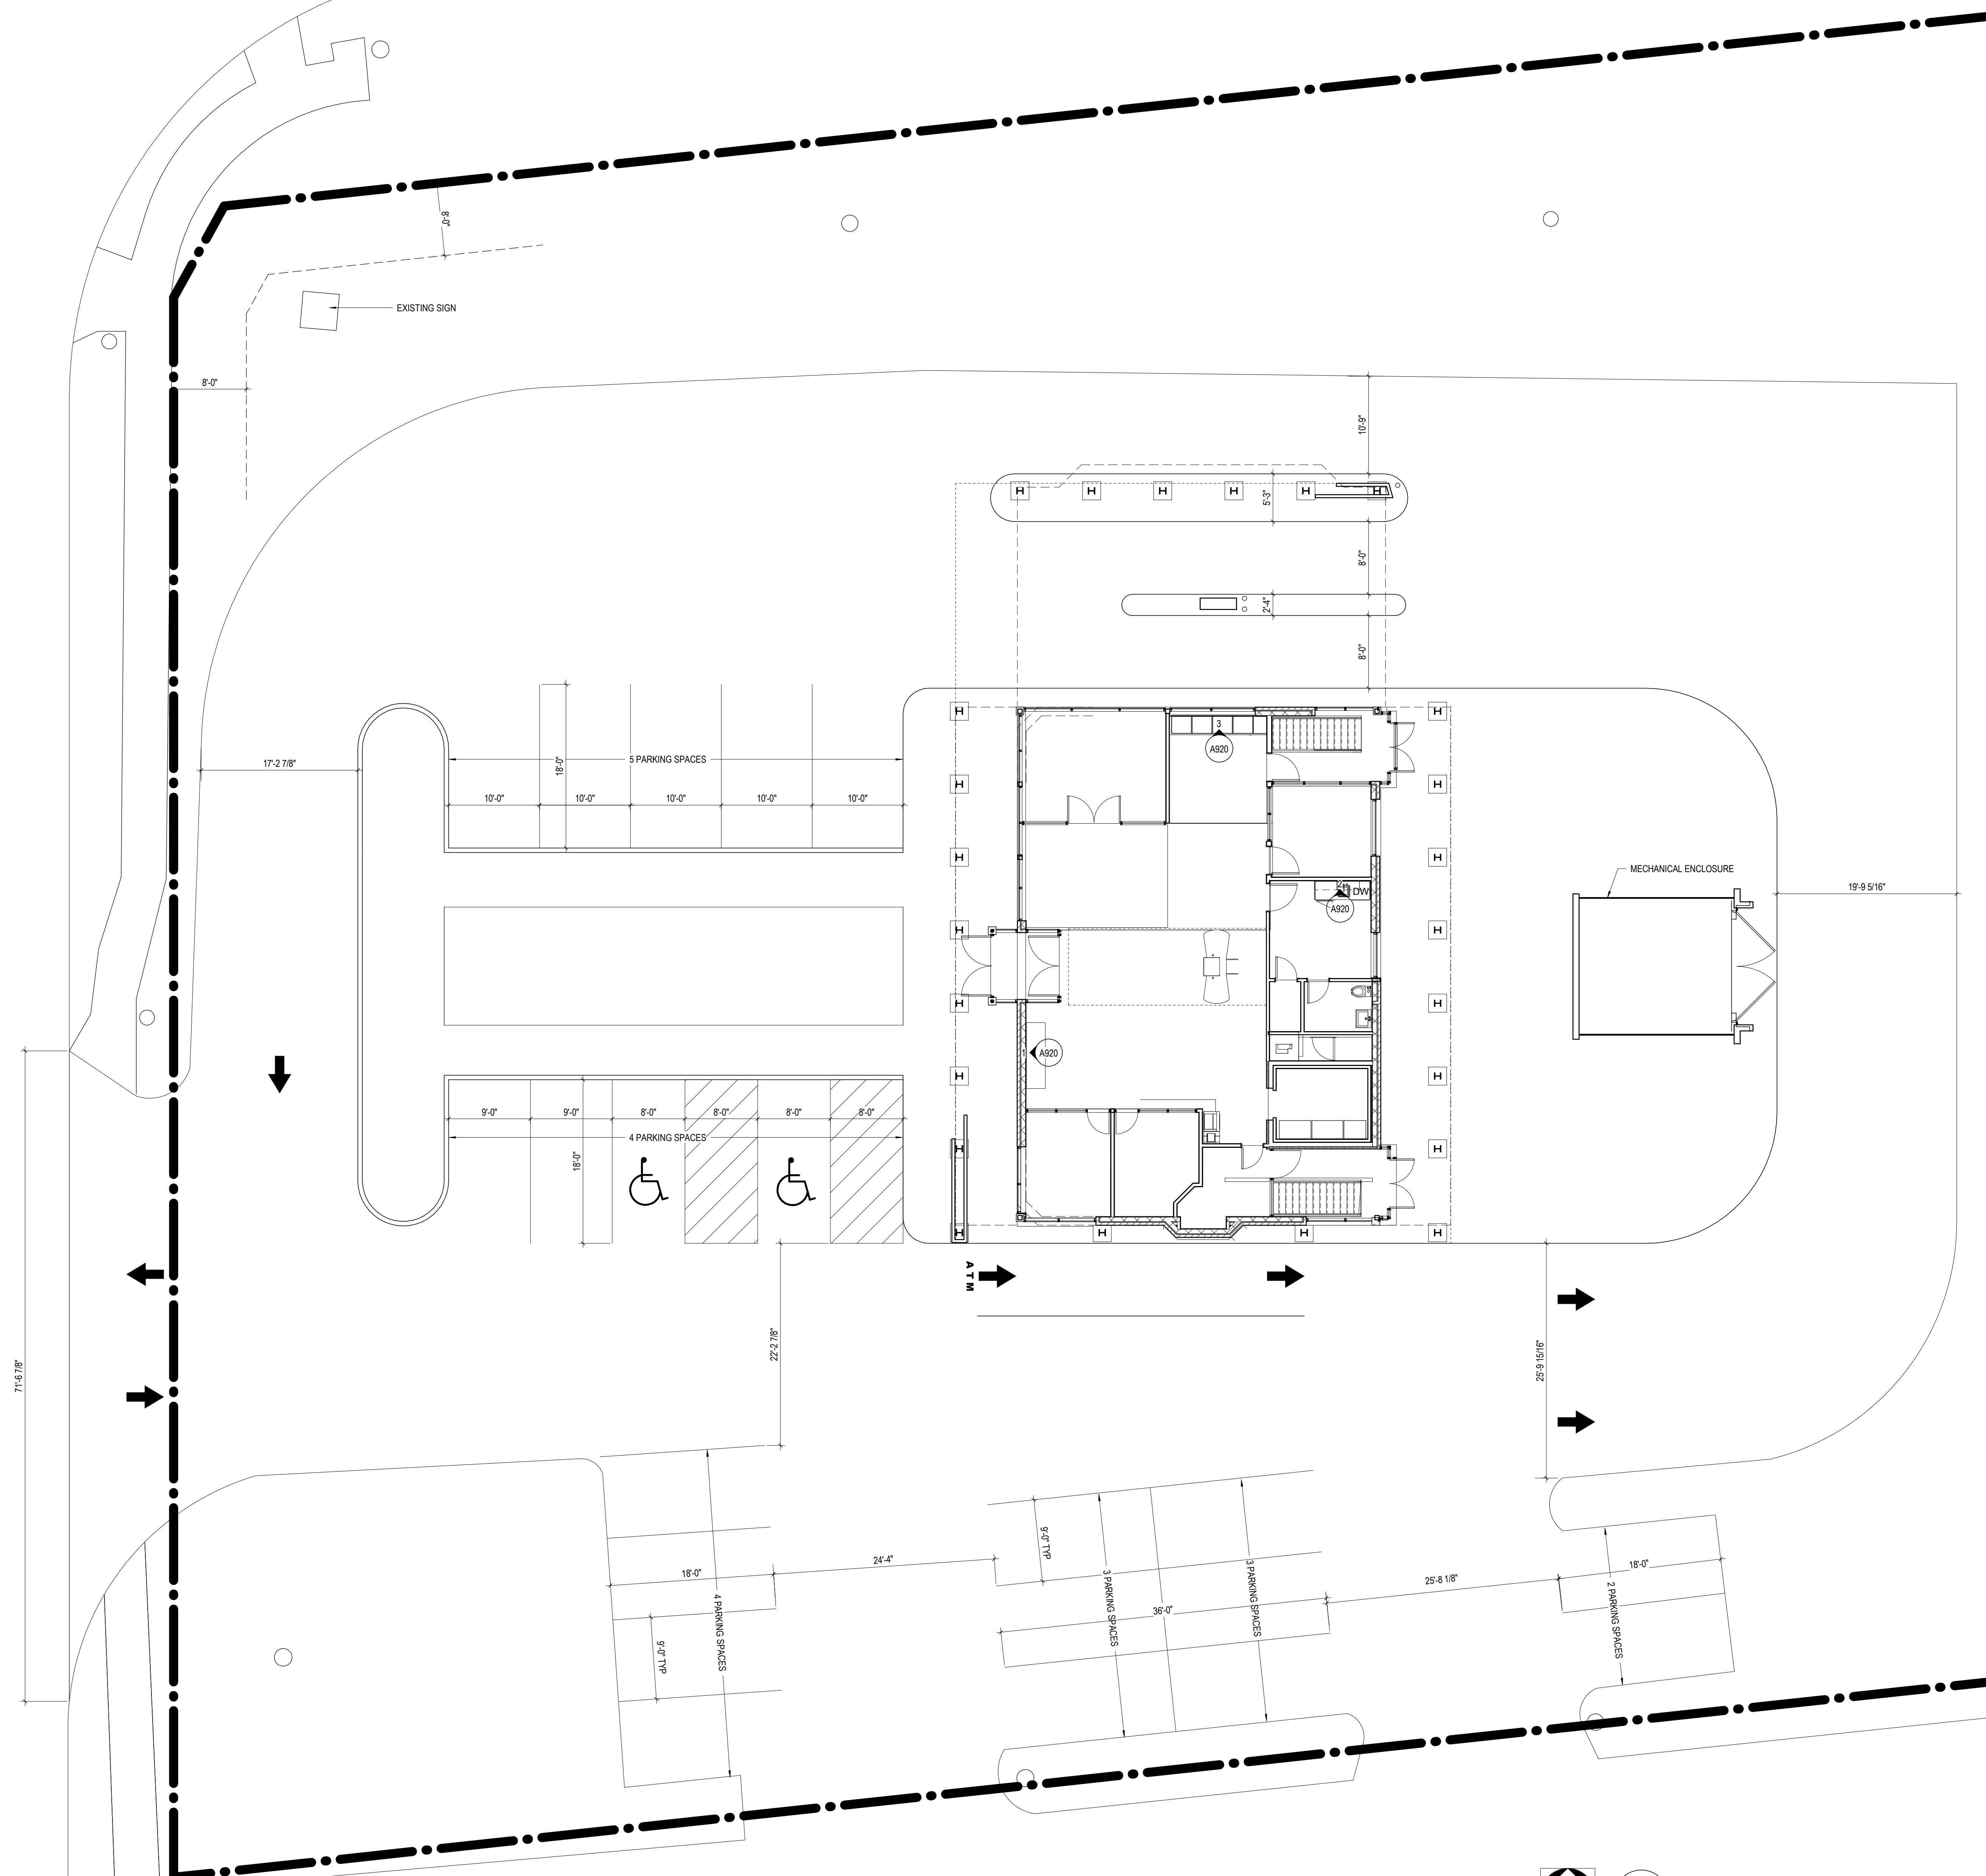

BASEMENT - 2,106 SF
 FIRST FLOOR - 2,330 SF
 TOTAL BUILDING - 4,436 SF
 TOTAL PARKING - 22 SPACES
 REQUIRED PARKING (4436/1000x2.5) - 12 SPACES

#	DATE	CHANGE DESCRIPTION


RENOVATION OF HEARTLAND BANK DUBLIN
 500 FRANTZ ROAD
 DUBLIN, OH 43017
 FOR
HEARTLAND BANK

MOODY-NOLAN
 300 SPRUCE STREET
 SUITE 300
 COLUMBUS, OHIO 43215
 PHONE: (614) 461-4664
 FAX: (614) 280-8881

DRAWING TITLE:
ARCHITECTURAL SITE PLAN

PROGRESS DRAWING NOT FOR CONSTRUCTION	09/10/2020
	DRAWN BY: Author CHECKED BY: Checker
	20022
A100	
PRELIMINARY DEVELOPMENT PLAN	

1 ARCHITECTURAL SITE PLAN
 1/8" = 1'-0"

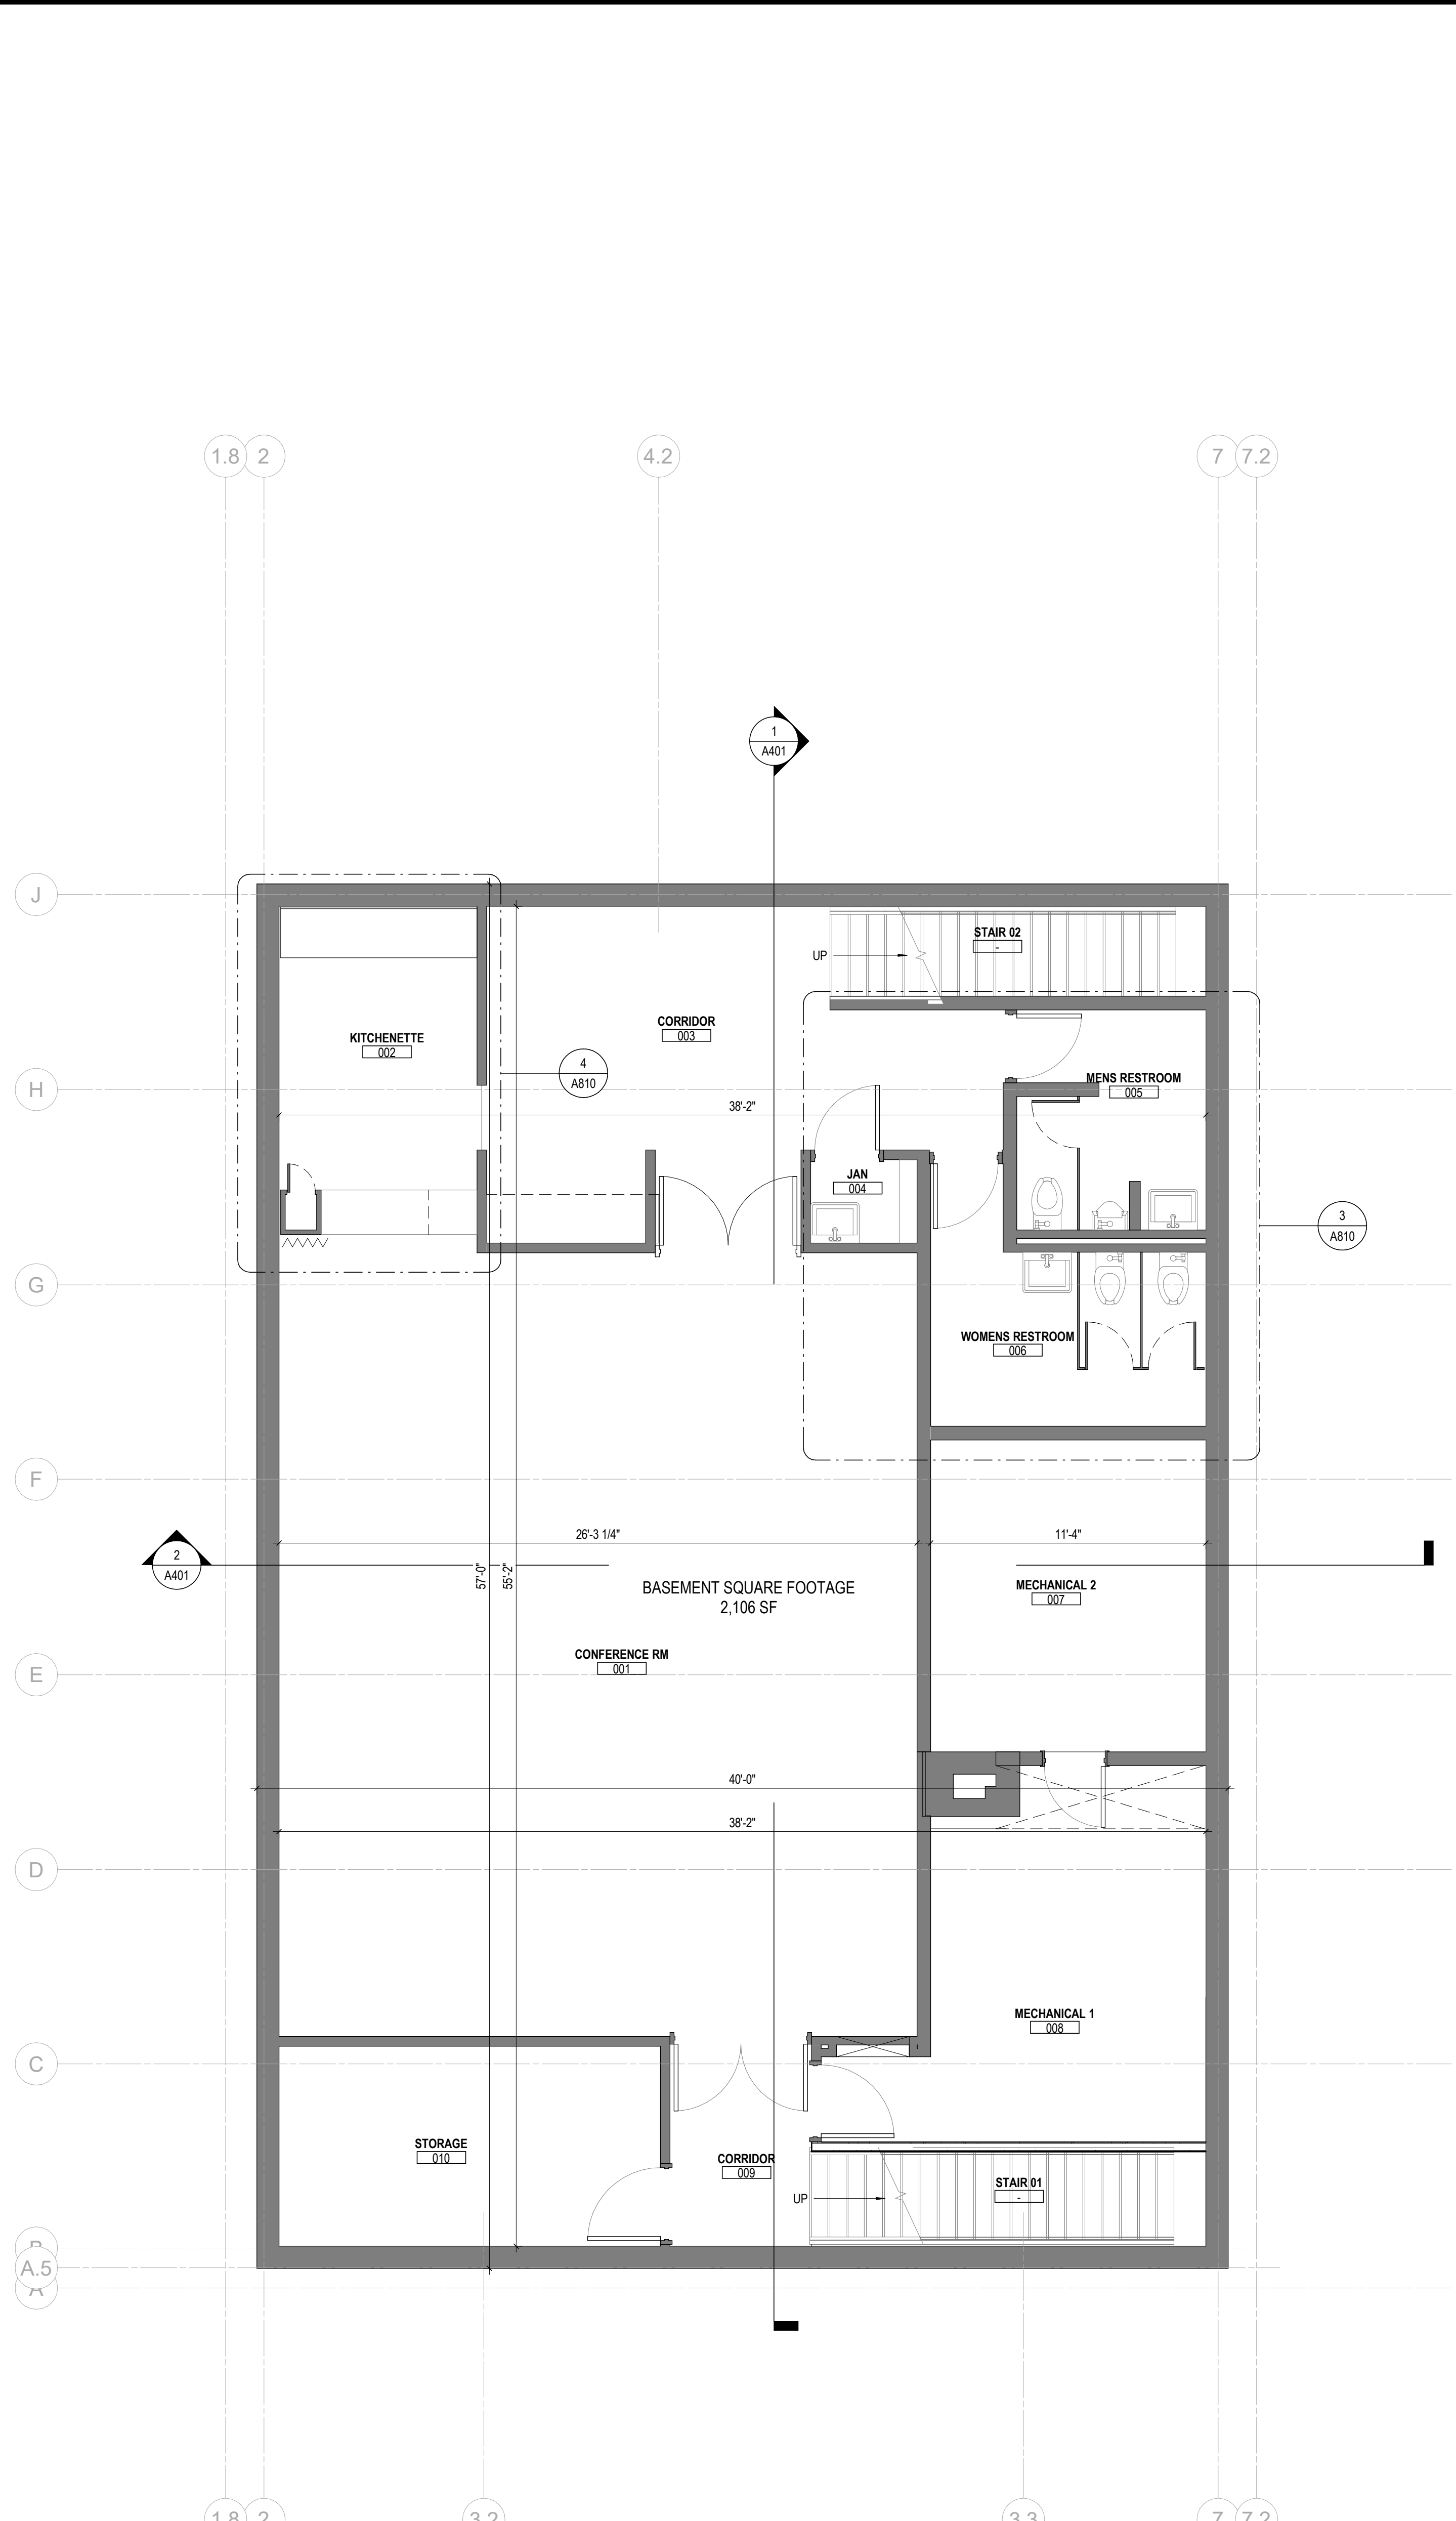

2 BASEMENT FLOOR PLAN
 1/4" = 1'-0"

FLOOR PLAN GENERAL NOTES

1. ALL DIMENSIONS ARE TO FACE OF WALL (UNLESS NOTED OTHERWISE).
2. SEE STRUCTURAL DRAWINGS FOR LOCATIONS OF ALL STEEL REINFORCING IN WALL & FLOOR CONSTRUCTION.
3. SEE FINISH SCHEDULE FOR ADDITIONAL INFORMATION OF LOCATIONS AND TYPES OF FINISH MATERIALS.
4. SEE ELEVATIONS AND STRUCTURAL DRAWINGS FOR LOCATIONS OF EXPANSION & CONTROL JOINTS. CONTRACTOR SHALL PROVIDE ADDITIONAL INTERIOR CONTROL JOINTS AS REQUIRED TO COMPLY WITH MAXIMUM SPACING REQUIREMENTS IN SPECIFICATIONS AND NATIONAL MASONRY INSTITUTE. SEE DETAILS ON **AXXX**.
5. MECHANICAL & ELECTRICAL EQUIPMENT SHALL BE ON HOUSEKEEPING PADS. PADS ARE TO BE PROVIDED BY THE TRADE SUPPLYING THE EQUIPMENT. SEE MECHANICAL AND ELECTRICAL DRAWINGS FOR ADDITIONAL INFORMATION. WORK TO BE COORDINATED THROUGH THE GENERAL TRADES CONTRACTOR. PADS 4" MIN. 4" THICK W/W.F.F., UNLESS NOTED OTHERWISE.

CODED NOTE LEGEND

- ① TBD
- ② TBD
- ③ TBD
- ④ TBD
- ⑤ TBD

RATED WALL LEGEND

- NON-RATED SMOKE RESISTIVE PARTITION TO DECK
- 1 HOUR SMOKE RESISTIVE PARTITION TO DECK
- 2 HOUR SMOKE RESISTIVE PARTITION TO DECK
- 3 HOUR SMOKE RESISTIVE PARTITION TO DECK
- 4 HOUR SMOKE RESISTIVE PARTITION TO DECK
- 1 HOUR FIRE RATED PARTITION TO DECK
- 2 HOUR FIRE RATED PARTITION TO DECK
- 3 HOUR FIRE RATED PARTITION TO DECK
- 4 HOUR FIRE RATED PARTITION TO DECK

KEYNOTE LEGEND


#	DATE	CHANGE DESCRIPTION

RENOVATION OF HEARTLAND BANK DUBLIN
 5500 PRANTZ ROAD
 DUBLIN, OH 43017
 FOR
HEARTLAND BANK

MOODY-NOLAN
 300 SPRUCE STREET
 SUITE 300
 COLUMBUS, OHIO 43215
 PHONE: (614) 461-4664
 FAX: (614) 280-8881

DRAWING TITLE:
BASEMENT FLOOR PLAN

PROGRESS DRAWING NOT FOR CONSTRUCTION	09/10/2020
	DRAWN BY: XXXX CHECKED BY: XXXX
	20022
	A101
	PRELIMINARY DEVELOPMENT PLAN

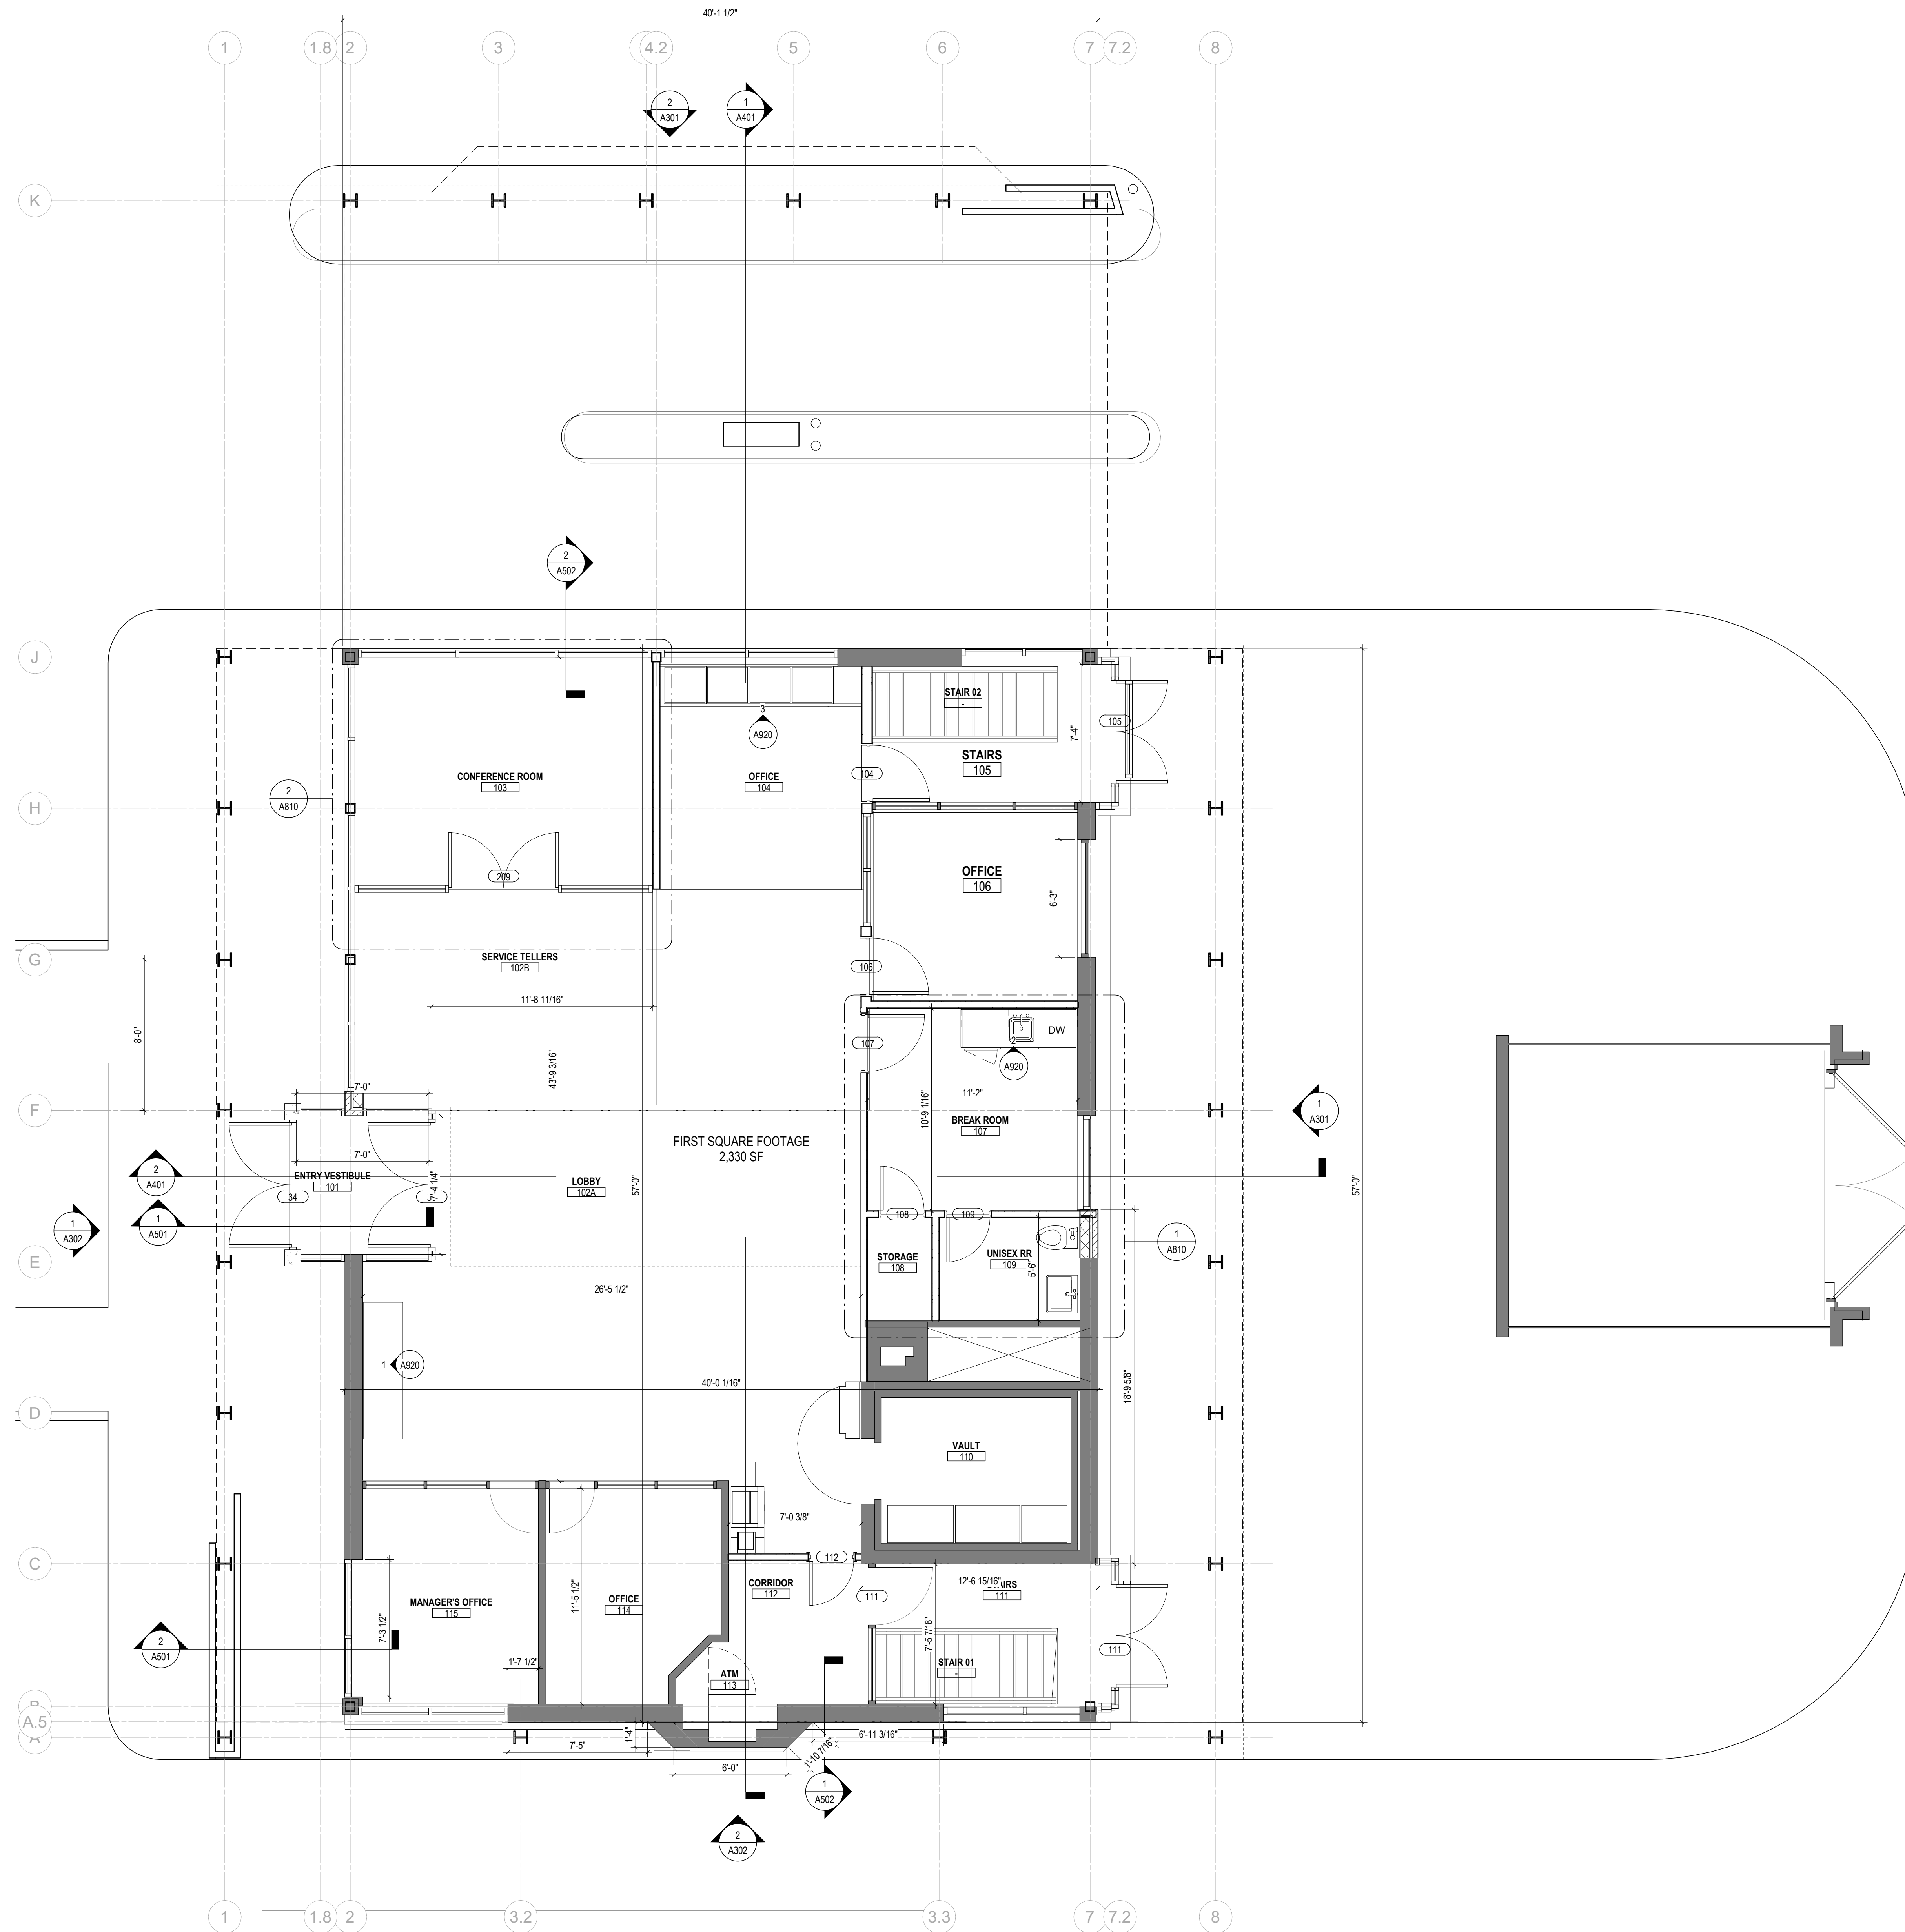

1 FIRST FLOOR PLAN
1/4" = 1'-0"


#	DATE	CHANGE DESCRIPTION

RENOVATION OF HEARTLAND BANK DUBLIN
6500 FRANTZ ROAD
DUBLIN, OH 43017
FOR
HEARTLAND BANK

MOODY-NOLAN
300 SPRUCE STREET
SUITE 300
COLUMBUS, OHIO 43215
PHONE: (614) 461-4664
FAX: (614) 280-8881

DRAWING TITLE:
FIRST FLOOR PLAN

PROGRESS DRAWING NOT FOR CONSTRUCTION	09/10/2020
	DRAWN BY: Author CHECKED BY: Checker
	20022
A102	
PRELIMINARY DEVELOPMENT PLAN	

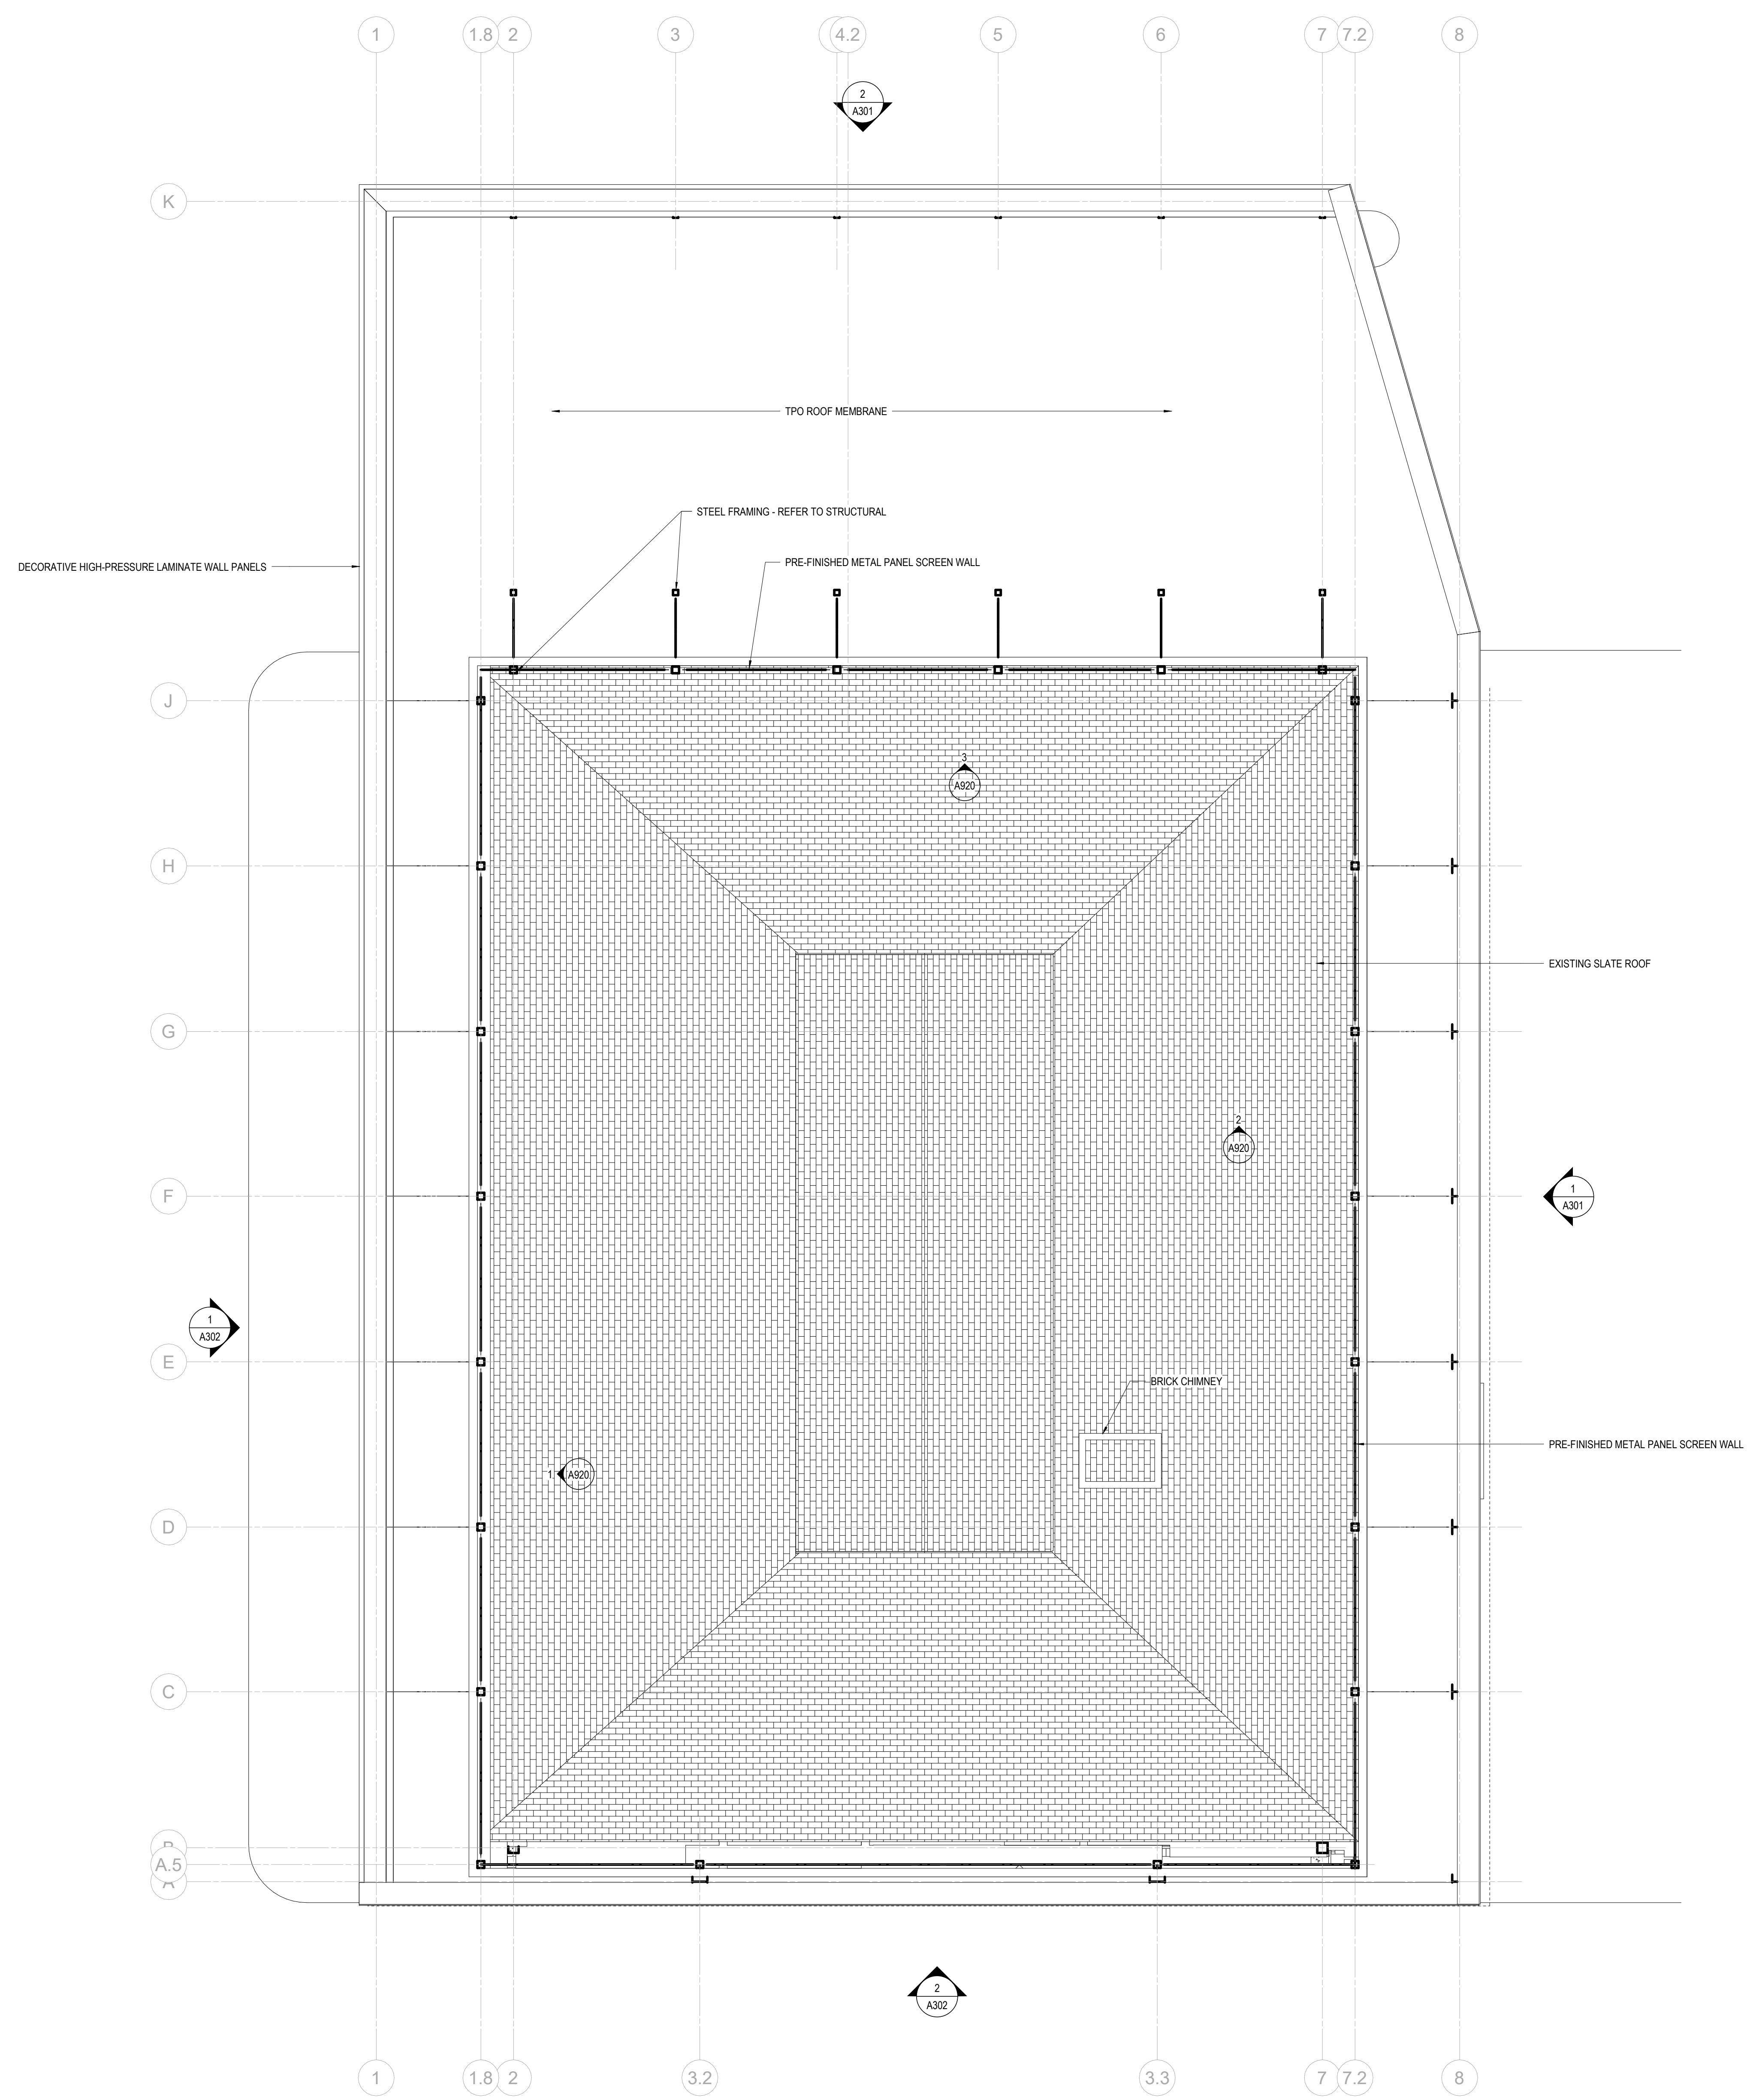

1 ROOF PLAN
 1/4" = 1'-0"

ROOF PLAN GENERAL NOTES

1. X

KEYNOTE LEGEND

#	DATE	CHANGE DESCRIPTION

RENOVATION OF HEARTLAND BANK DUBLIN
 CLIENT LOGO IF AVAILABLE
 6500 FRANTZ ROAD
 DUBLIN, OH 43017
 for
HEARTLAND BANK


MOODY•NOLAN
 300 Spruce Street
 Suite 300
 Columbus, Ohio 43215
 Phone: (614) 461-4664
 Fax: (614) 280-8881

PROGRESS DRAWING
 NOT FOR CONSTRUCTION


Dwg. Coord.: Author Tech. Coord.: Checker 2022

ROOF PLAN
 PRELIMINARY DEVELOPMENT PLAN

A103
 09/10/2020

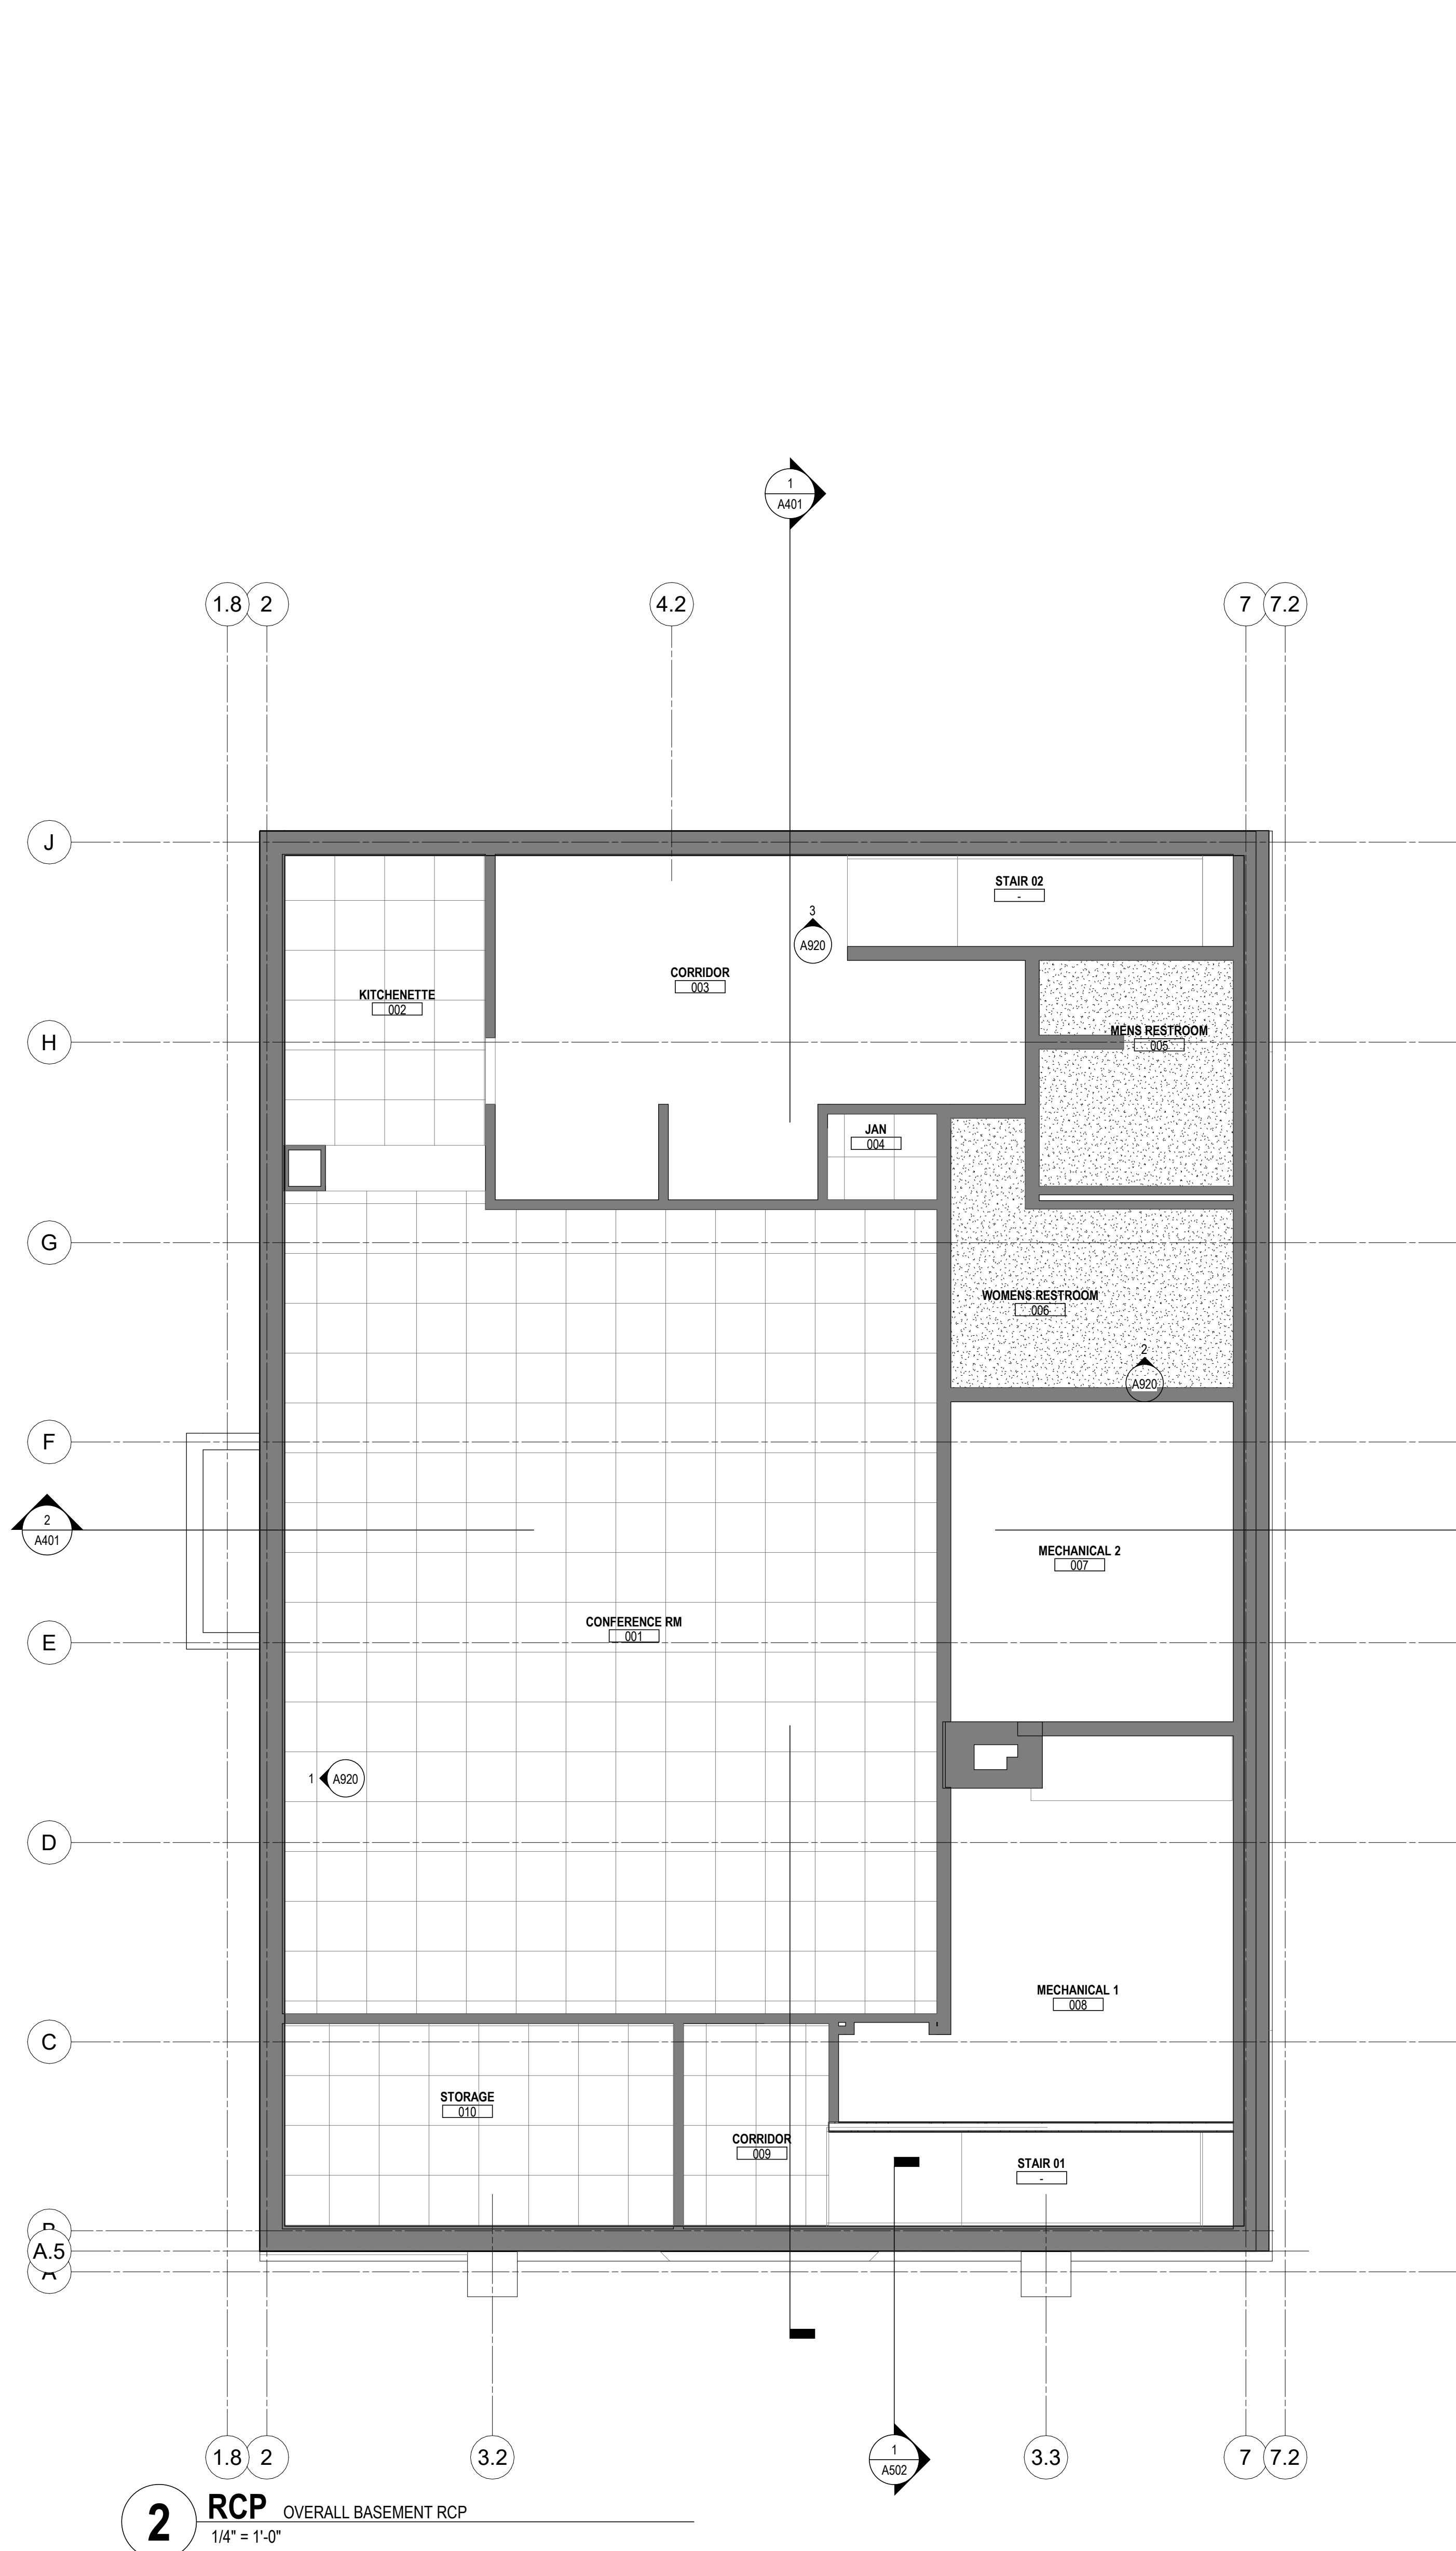

2 RCP OVERALL BASEMENT RCP
 1/4" = 1'-0"

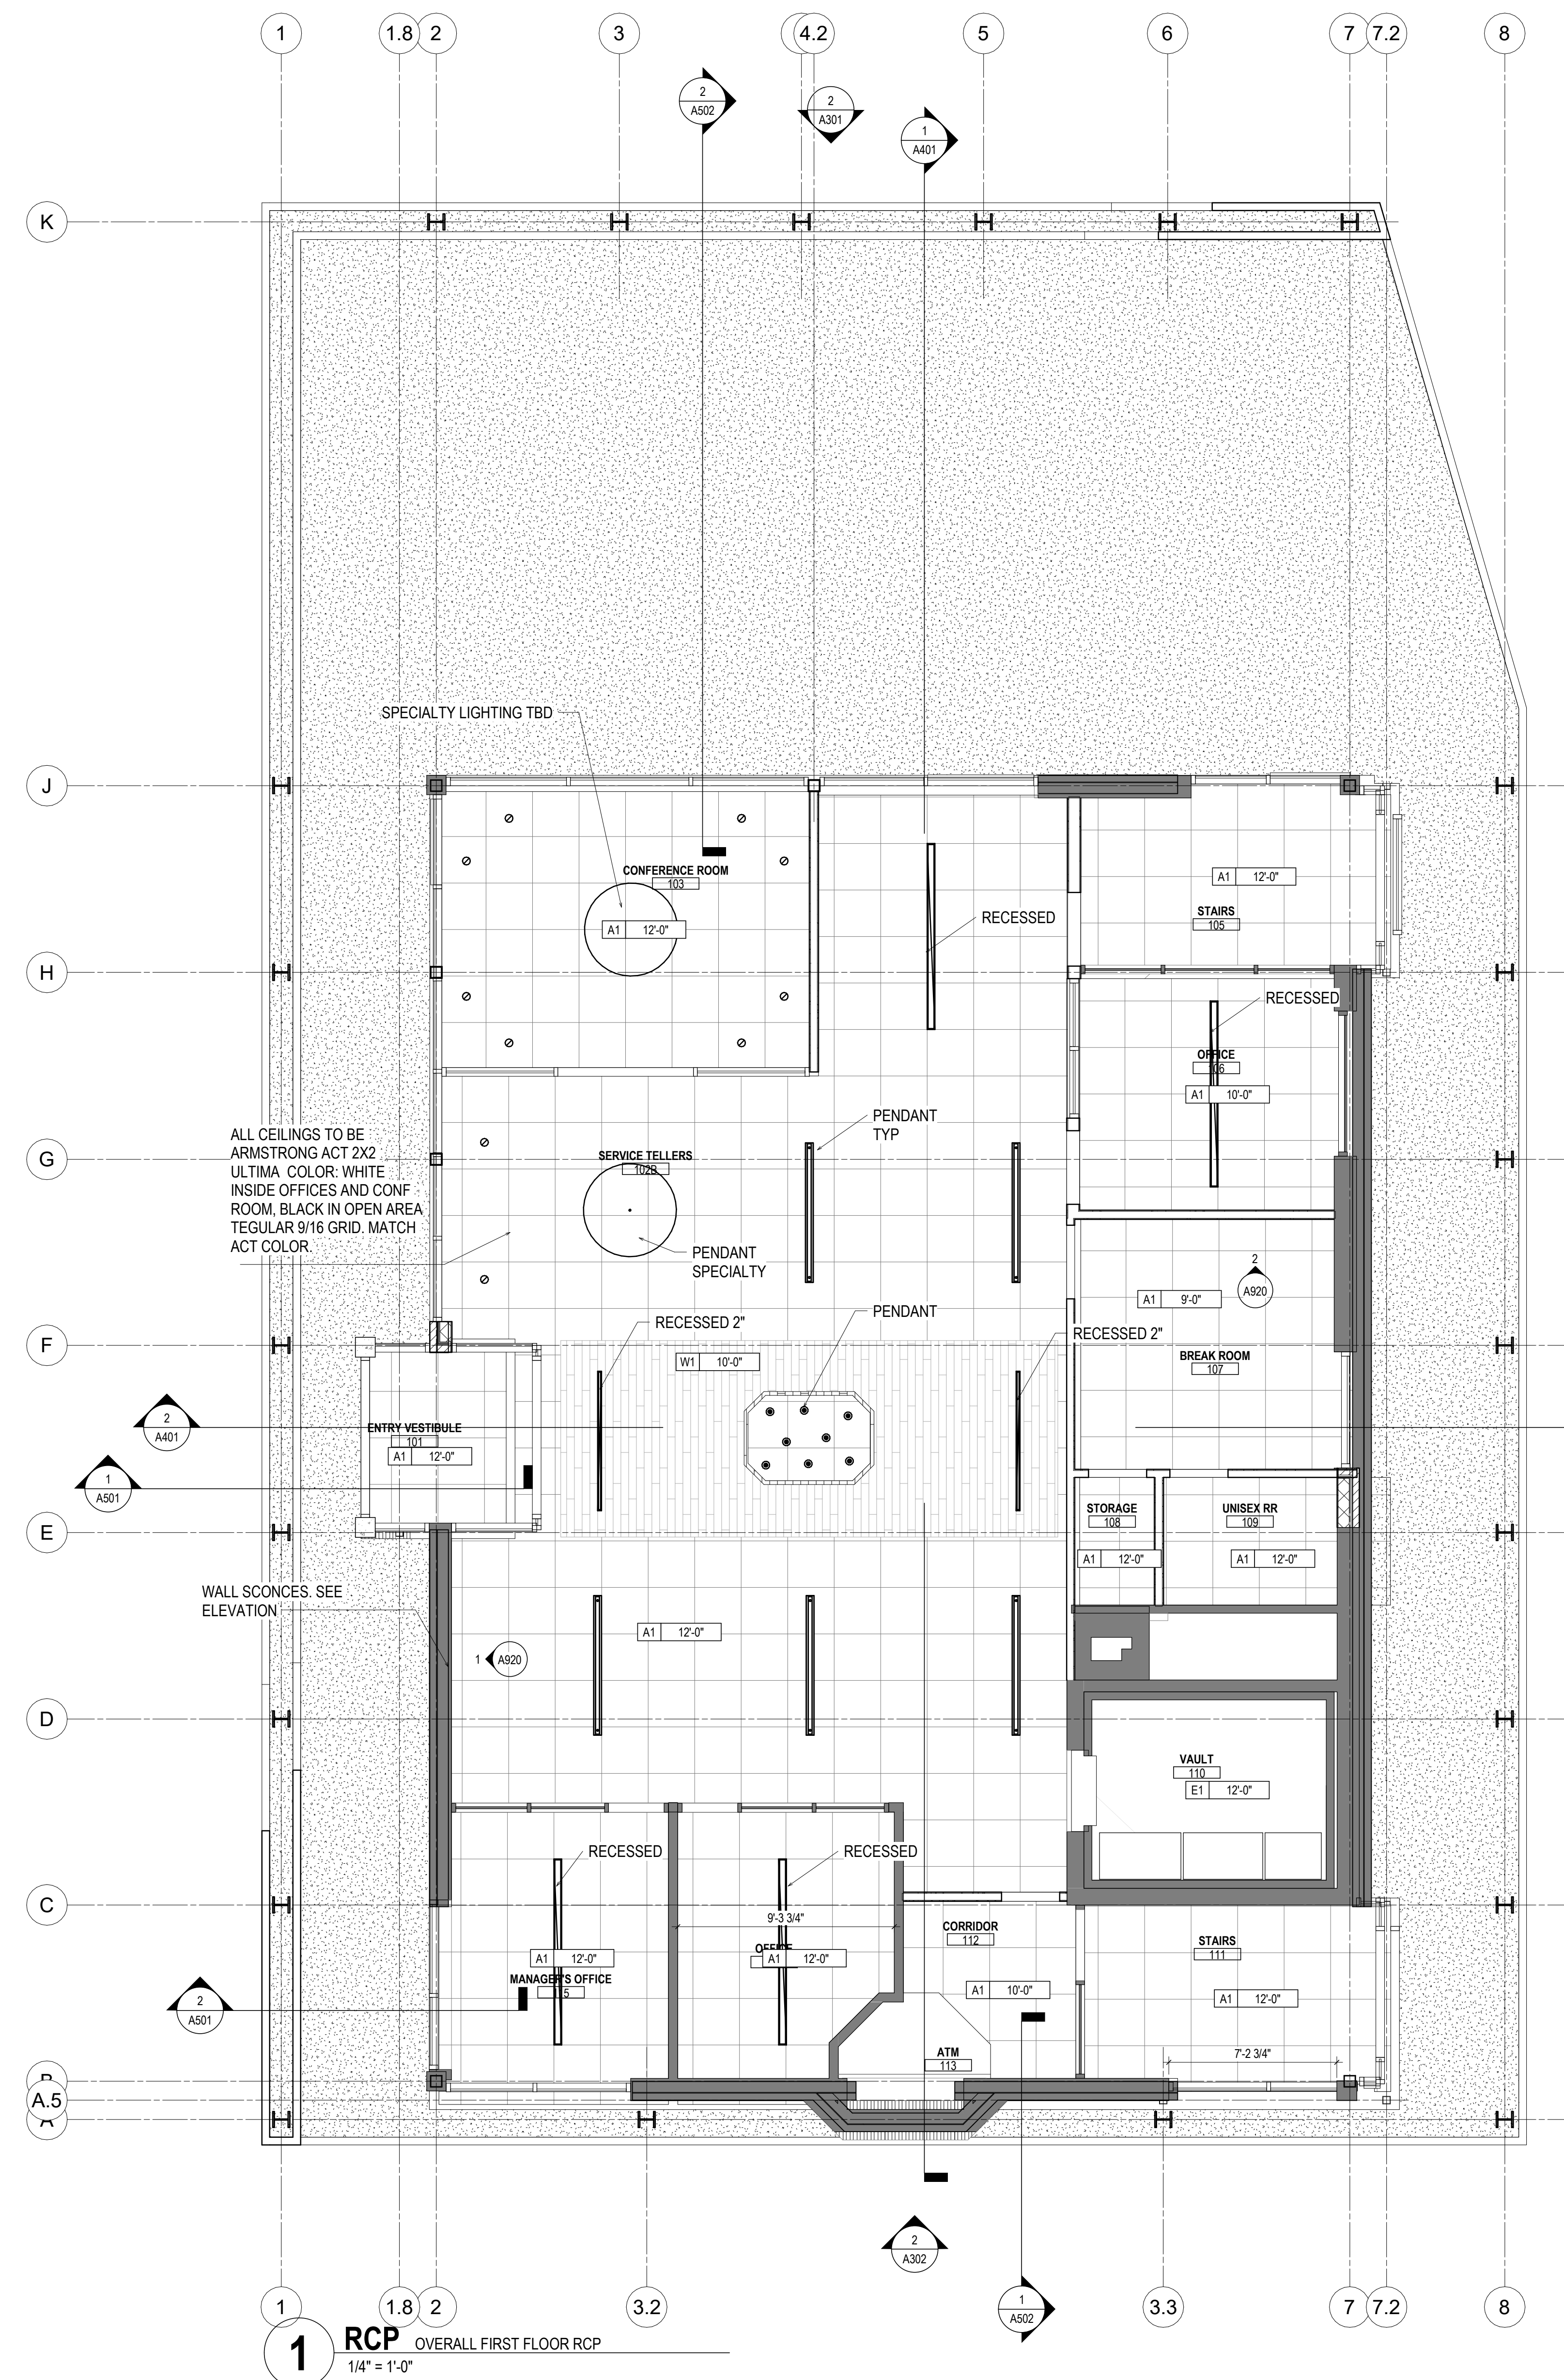

1 RCP OVERALL FIRST FLOOR RCP
 1/4" = 1'-0"

- RCP GENERAL NOTES**
1. PAINT DESIGNATED FOR EXPOSED OVERHEAD STRUCTURE IS TO INCLUDE ALL EXPOSED COMPONENTS INCLUDING (BUT NOT EXCLUSIVE TO) DECKING, STRUCTURAL MEMBERS, MECHANICAL AND ELECTRICAL DELIVERY SYSTEMS, FIRE PROTECTION SYSTEMS (EXCLUDING SPRINKLER HEADS), AND ALL OTHER MISCELLANEOUS BUILDING SYSTEMS LOCATED OVERHEAD. EACH OF THE AFOREMENTIONED CATEGORIES IS TO INCLUDE ANY AND ALL ASSOCIATED SUPPORTS, FASTENERS, HANGERS, STRUTS, BRACES, BRACKETS, ETC.
 2. LIGHT FIXTURES SHOWN TO INDICATE PROPOSED FIXTURES & GENERAL DESIGN INTENT.
 3. FINISHED CEILING HEIGHTS ARE MARKED FROM TOP OF FINISH FLOOR (UNLESS NOTED OTHERWISE).
 4. COORDINATE LOCATION OF FIXTURES WITH MECHANICAL, ELECTRICAL, PLUMBING, FIRE SUPPRESSION AND TECHNOLOGY DRAWINGS. ANY CONFLICT BETWEEN TRADES, NOTIFY ARCHITECT PRIOR TO INSTALLATION.
 5. FACE OF BULKHEADS ARE TO ALIGN WITH FACE OF ADJACENT WALLS TO WHICH BULKHEADS ARE PARALLEL. UNLESS NOTED OTHERWISE OR DIMENSIONED.
 6. ALL GYPSUM BOARD SOFFITS & CEILINGS TO BE PAINTED FLAT CEILING WHITE (UNLESS NOTED OTHERWISE).
 7. ALL GYPSUM SOFFITS IN FOOD SERVICE AREAS TO BE PAINTED WITH A SATIN FINISH.
 8. PAINT DUCTWORK INSIDE AIR GRILLES FLAT BLACK.
 9. CEILING GRIDS ARE CENTERED ON ROOM, U.N.O. OR DIMENSIONED.
 10. WHERE EXIT SIGNS OCCUR OVER A DOOR OR PAIR OF DOORS, CENTER SIGN ON DOOR OPENING.
 11. ALL CEILING DEVICES TO BE CENTERED IN TILE, U.N.O.

- CODED NOTE LEGEND**
- ① ALIGN FEATURES
 - ② OPEN TO ABOVE
 - ③ TBD
 - ④ TBD
 - ⑤ TBD

- RCP LEGEND**
- A1 ACOUSTIC CEILING TYPE 1: 2x2 LAY-IN CEILING
 - A2 ACOUSTIC CEILING TYPE 2: 2x4 LAY-IN CEILING
 - E1 EXPOSED STRUCTURE ABOVE
 - G1 GYPSUM BOARD CEILING OR SOFFIT
 - 2x2 FLUORESCENT LIGHT FIXTURE (SHADING DENOTES EMERGENCY FIXTURE)
 - 2x4 FLUORESCENT LIGHT FIXTURE (SHADING DENOTES EMERGENCY FIXTURE)
 - 1x4 FLUORESCENT LIGHT FIXTURE (SHADING DENOTES EMERGENCY FIXTURE)
 - 1x8 FLUORESCENT LIGHT FIXTURE (SHADING DENOTES EMERGENCY FIXTURE)
 - RECESSED CAN LIGHT
 - SURFACE MOUNTED LIGHT
 - LINEAR COVE LIGHT
 - EXIT LIGHT WITH DIRECTIONAL ARROW
 - EXIT LIGHT
 - SUPPLY DIFFUSER
 - LINEAR DIFFUSER
 - EXHAUST/RETURN GRILLE
 - SPEAKER
 - XX | XX'-XX" CEILING TAG WITH HEIGHT

NOTE: COORDINATE ARCHITECTURAL REFLECTED CEILING PLANS WITH THE MECHANICAL AND ELECTRICAL DRAWINGS FOR NUMBER OF AND LOCATIONS OF AND TYPES OF FIXTURES AND GRILLES. NOT ALL ITEMS SHOWN ON LEGEND MAY BE PRESENT IN PROJECT.

KEYNOTE LEGEND

KEY VALUE	KEYNOTE TEXT

RCP CEILING SCHEDULE

CEILING TYPE SCHEDULE	
TYPE	DESCRIPTION
#A1	DATE CHANGE DESCRIPTION
E1	
G1	
WT	WOOD PLANK


RENOVATION OF HEARTLAND BANK DUBLIN
 6300 FRANTZ ROAD
 DUBLIN, OH 43017
 FOR
HEARTLAND BANK

300 SPRUCE STREET
 SUITE 300
 COLUMBUS, OHIO 43215
 PHONE: (614) 461-4664
 FAX: (614) 280-8881


MOODY-NOLAN

DRAWING TITLE:
RCP - OVERALL

PROGRESS DRAWING NOT FOR CONSTRUCTION	09/10/2020 DRAWN BY: XXXX CHECKED BY: XXXX 20022 A201 PRELIMINARY DEVELOPMENT PLAN
---------------------------------------	---

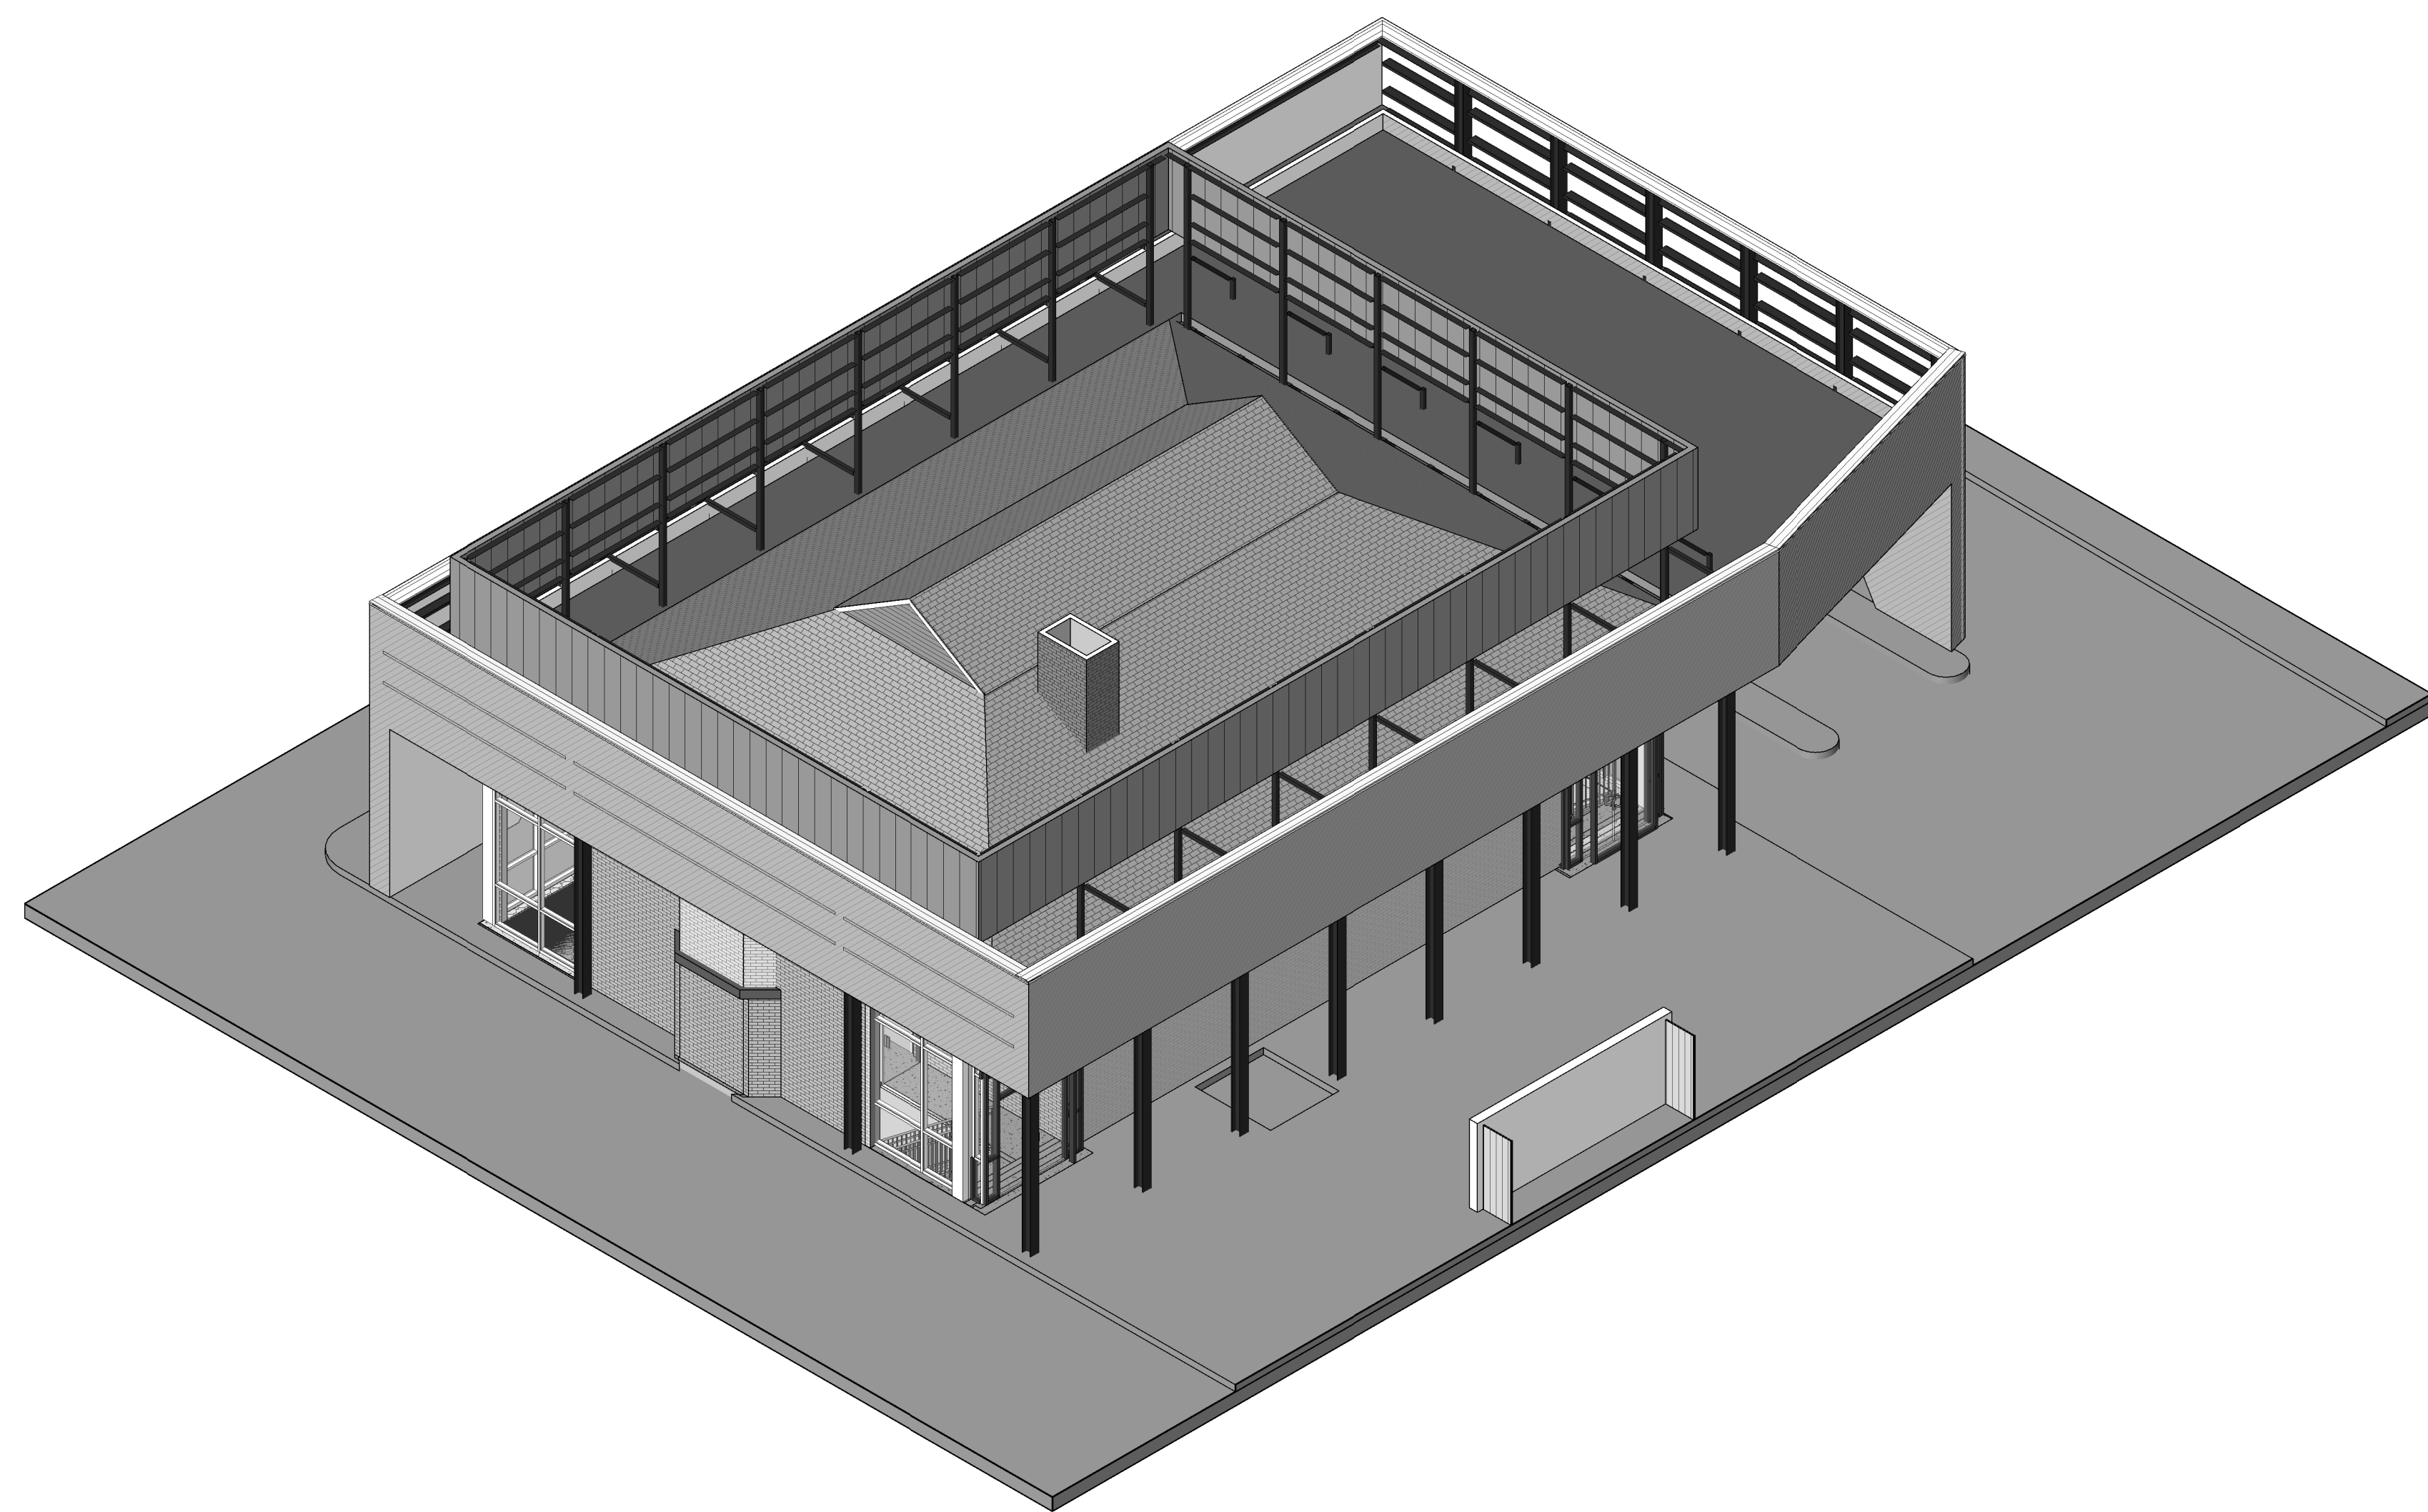

1 3D AXON - SE

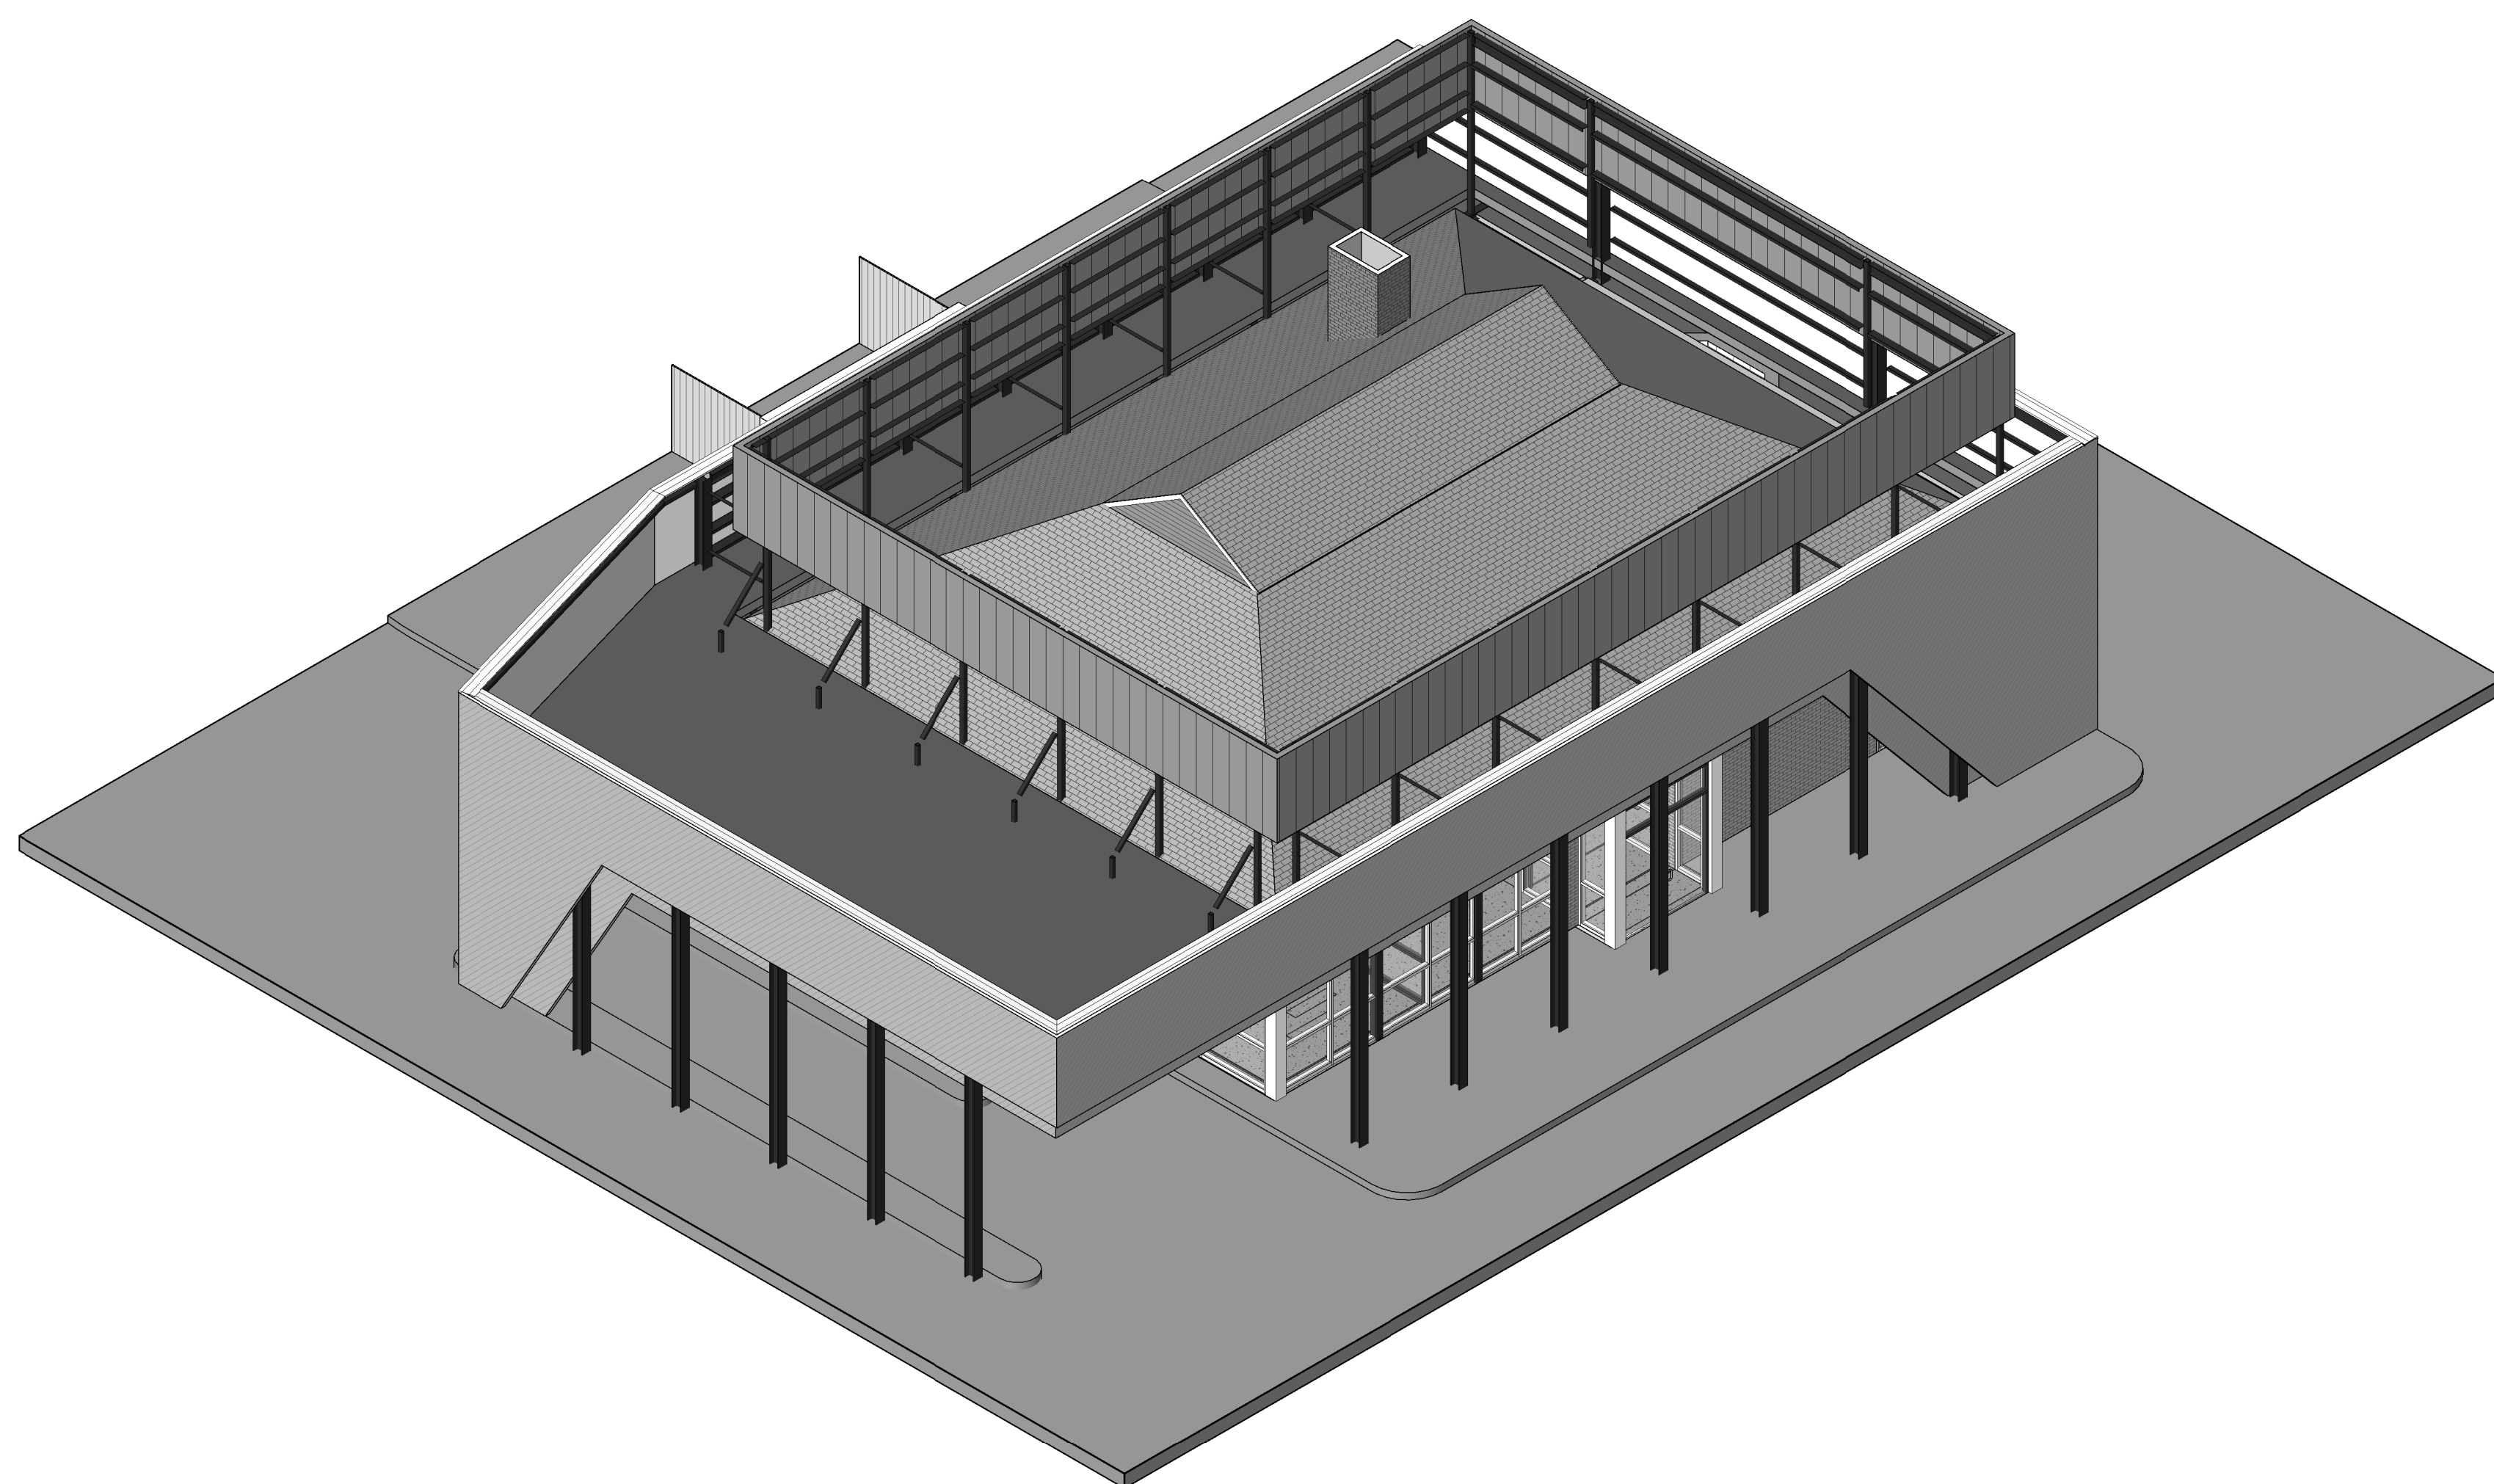

2 3D AXON - NW

#	DATE	CHANGE DESCRIPTION


RENOVATION OF HEARTLAND BANK DUBLIN
 6300 FRANTZ ROAD
 DUBLIN, OH 43017
 FOR
HEARTLAND BANK

MOODY-NOLAN
 300 SPRUCE STREET
 SUITE 300
 COLUMBUS, OHIO 43215
 PHONE: (614) 461-4664
 FAX: (614) 280-8881

DRAWING TITLE:

AXONOMETRIC VIEWS


PROGRESS DRAWING NOT FOR CONSTRUCTION	09/10/2020
	DRAWN BY: Author CHECKED BY: Checker
	20022
A300	
PRELIMINARY DEVELOPMENT PLAN	

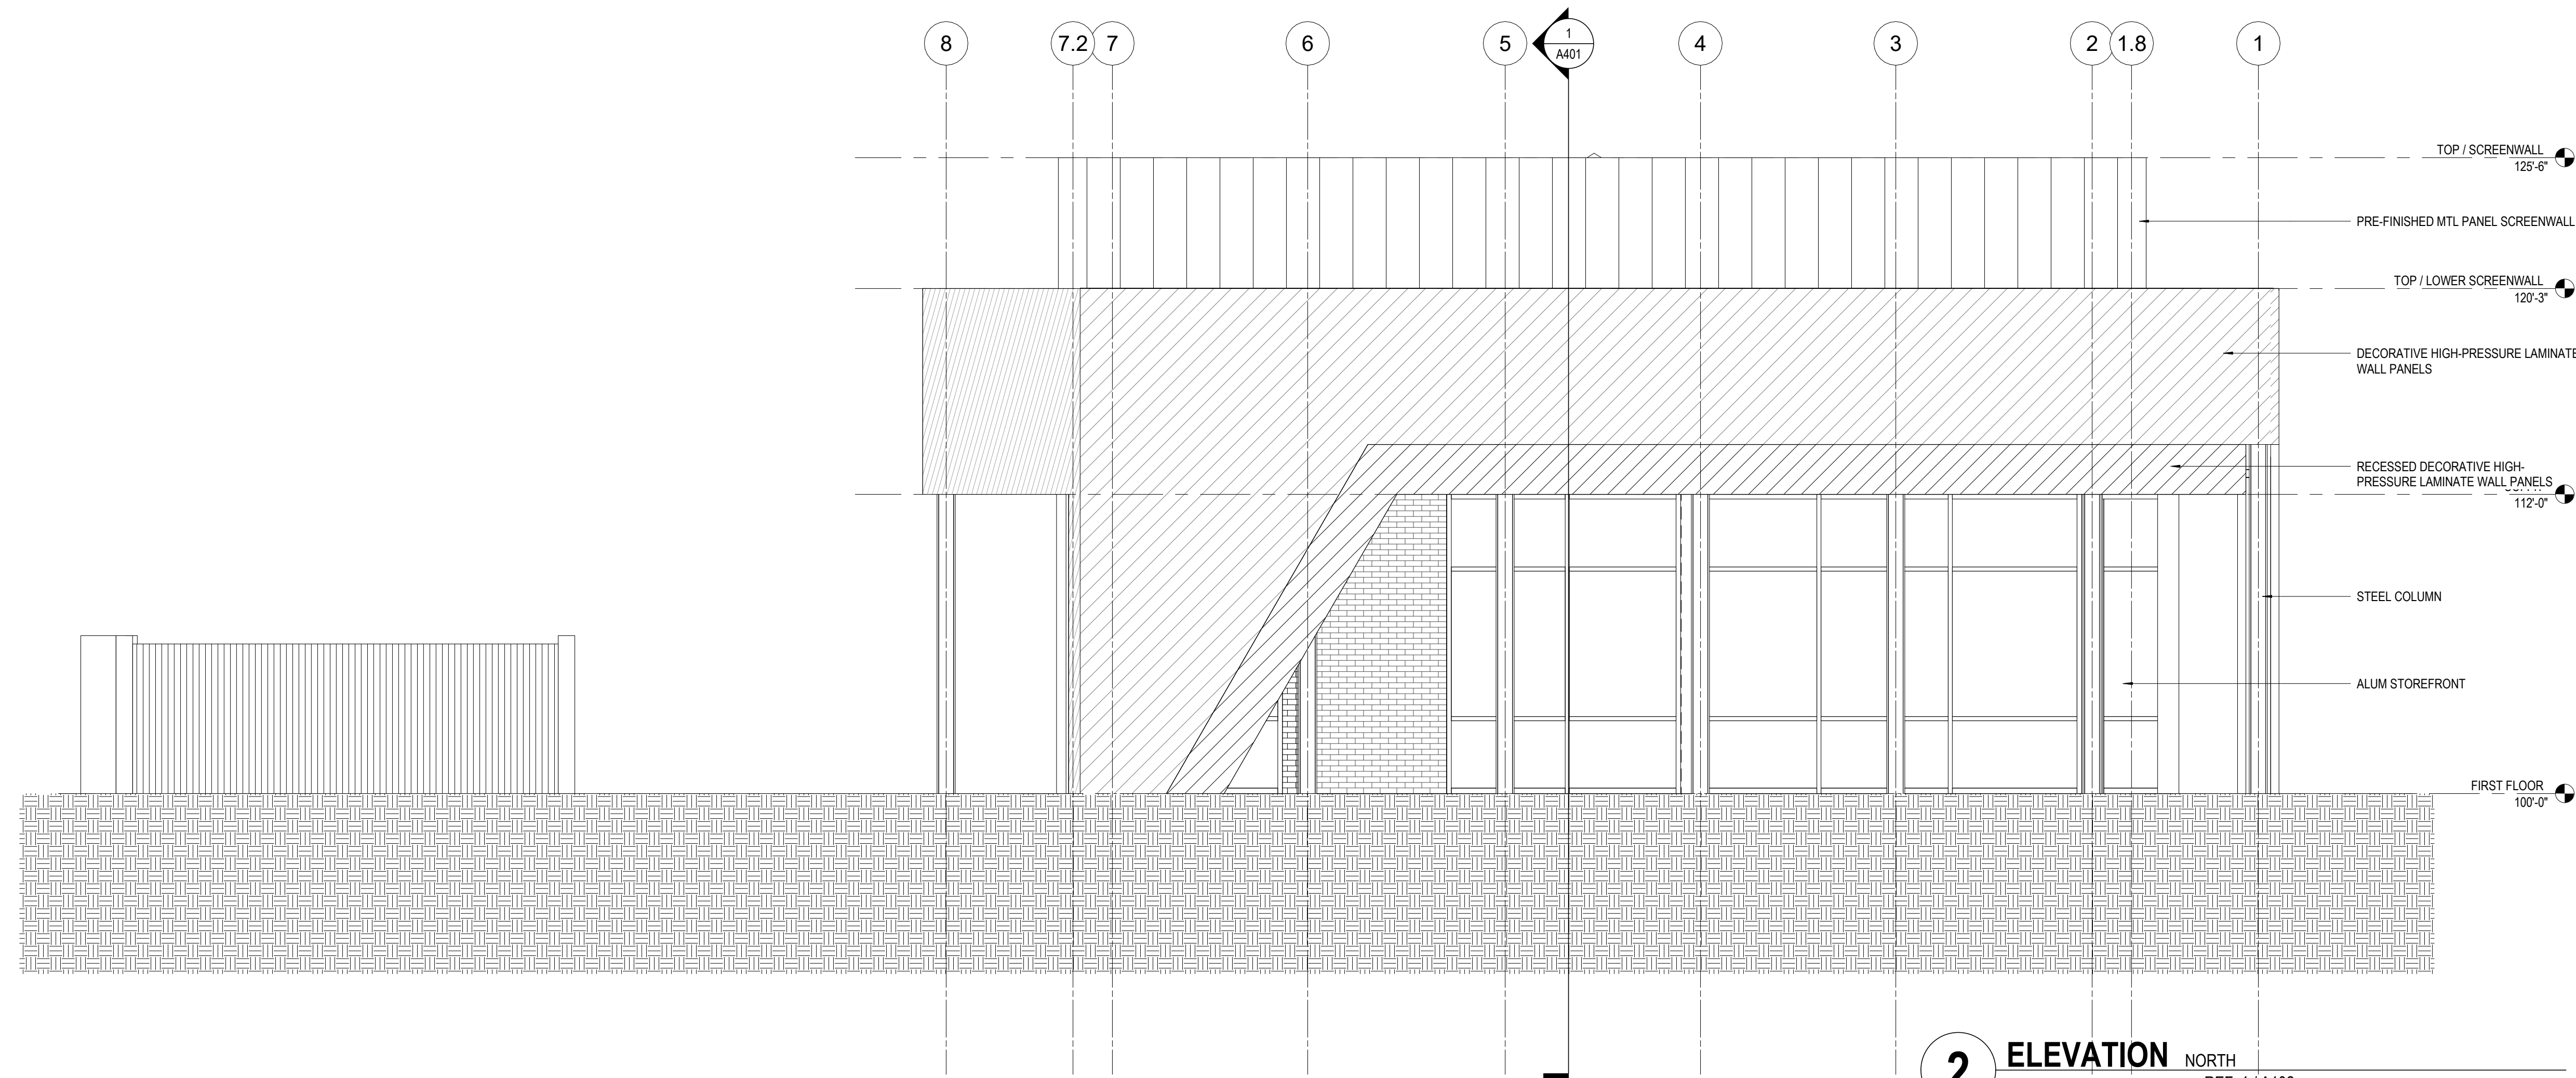

2 ELEVATION NORTH
1/4" = 1'-0" REF: 1 / A102

MATERIAL QUANTITIES - NORTH ELEVATION
 TOTAL - 1,262 SF
 BRICK - 108 SF (8.5%)
 STOREFRONT - 372 SF (29.5%)
 DECORATIVE HIGH-PRESSURE LAMINATE PANELS - 554 SF (43.9%)
 METAL SCREENWALL PANELS - 228 SF (18.1%)

TRANSPARENCY PERCENTAGES AT BUILDING
 NORTH ELEVATION - 372 SF GLAZING / 480 SF = 77.5%

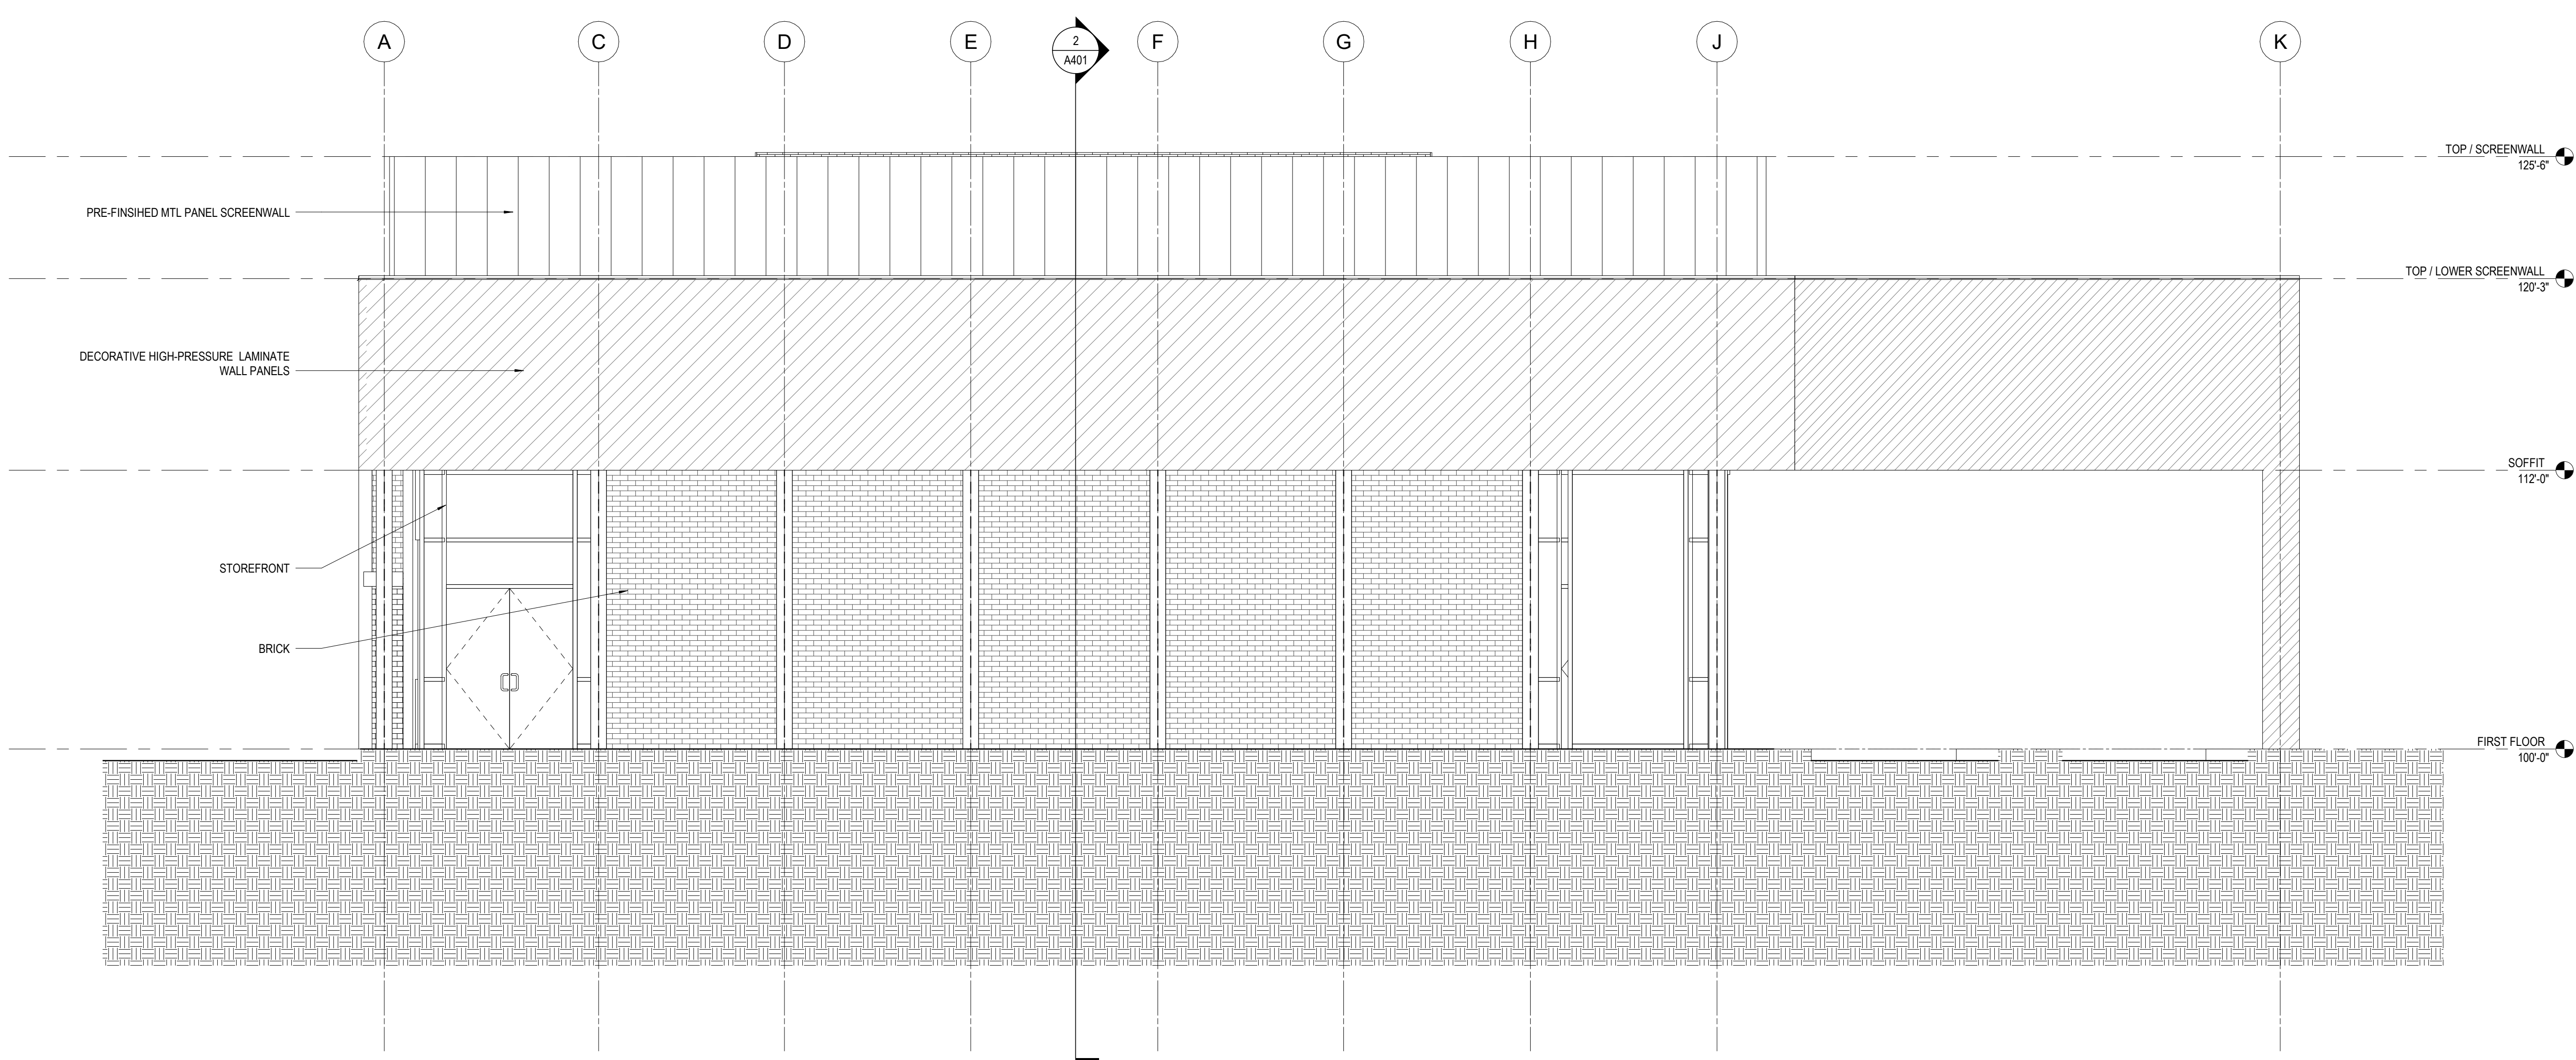

1 ELEVATION EAST
1/4" = 1'-0" REF: 1 / A102

MATERIAL QUANTITIES - EAST ELEVATION
 TOTAL - 1,692 SF
 BRICK - 370 SF (21.9%)
 STOREFRONT - 314 SF (18.5%)
 DECORATIVE HIGH-PRESSURE LAMINATE PANELS - 705 SF (41.6%)
 METAL SCREENWALL PANELS - 303 SF (18.0%)

TRANSPARENCY PERCENTAGES AT BUILDING
 EAST ELEVATION - 314 SF GLAZING / 684 SF = 45.9%

KEY VALUE	KEYNOTE TEXT
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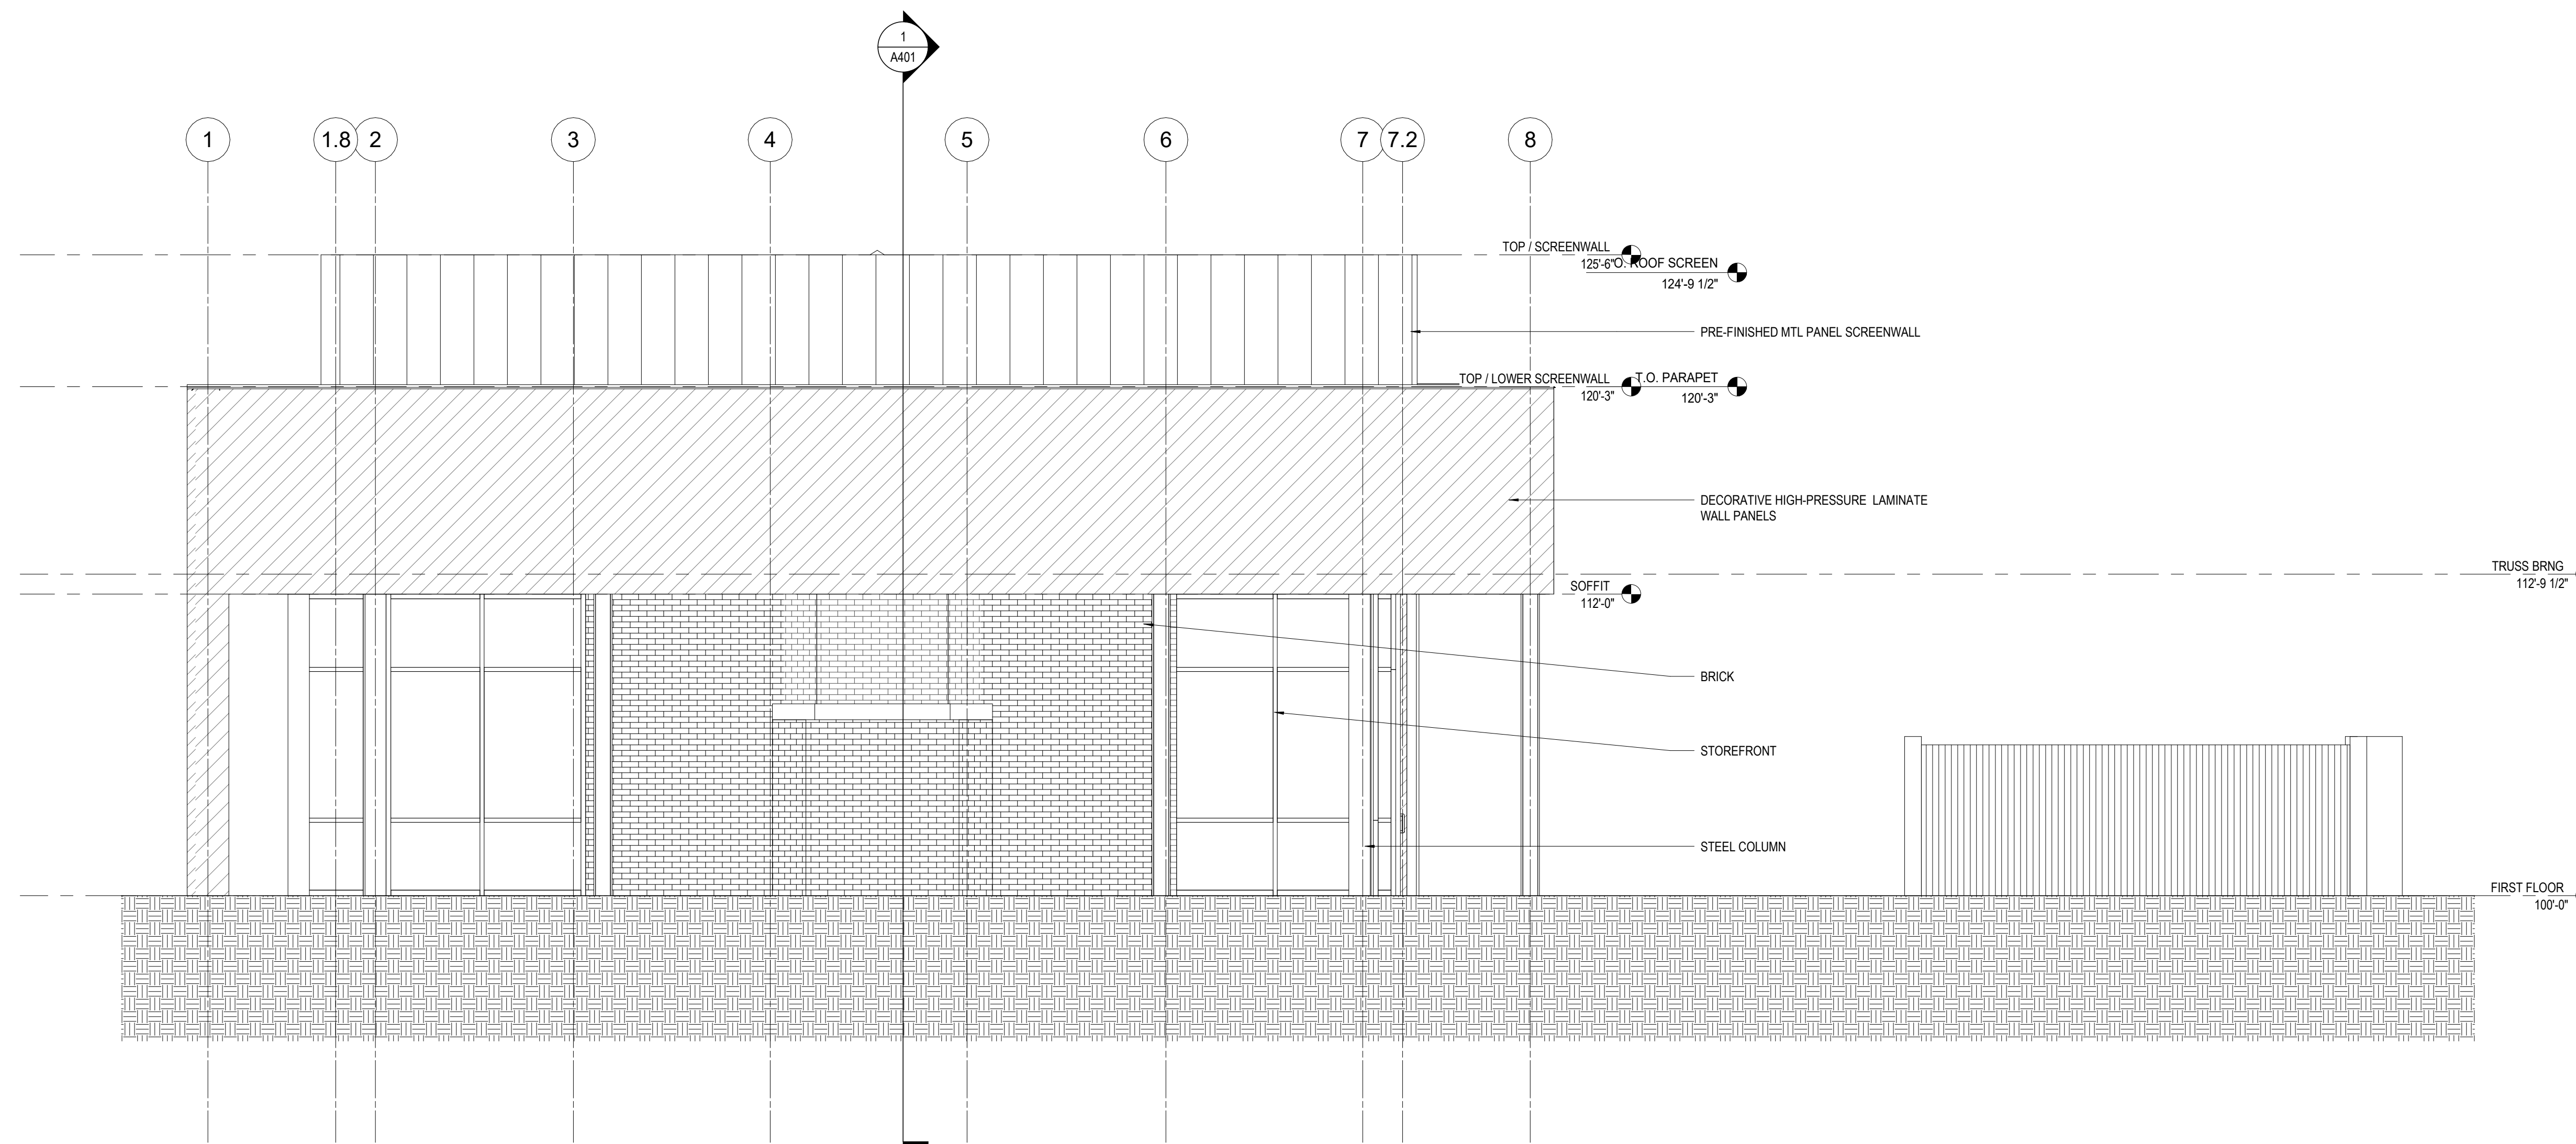
#	DATE	CHANGE DESCRIPTION
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RENOVATION OF HEARTLAND BANK DUBLIN
 5500 PRANTZ ROAD
 DUBLIN, OH 43017
 FOR
HEARTLAND BANK

MOODY-NOLAN
 300 SPRUCE STREET
 SUITE 300
 COLUMBUS, OHIO 43215
 PHONE: (614) 461-4664
 FAX: (614) 280-8881

DRAWING TITLE:
EXTERIOR ELEVATIONS - OVERALL


PROGRESS DRAWING NOT FOR CONSTRUCTION	09/10/2020
	DRAWN BY: XXXX CHECKED BY: XXXX
	20022
A301	
PRELIMINARY DEVELOPMENT PLAN	



2 ELEVATION SOUTH
1/4" = 1'-0" REF: 1 / A102

MATERIAL QUANTITIES - SOUTH ELEVATION
 TOTAL - 1,170 SF
 BRICK - 298 SF (25.5%)
 STOREFRONT - 182 SF (15.5%)
 DECORATIVE HIGH-PRESSURE LAMINATE PANELS - 462 SF (39.5%)
 METAL SCREENWALL PANELS - 228 SF (19.5%)

TRANSPARENCY PERCENTAGES AT BUILDING
 SOUTH ELEVATION - 182 SF GLAZING / 480 SF = 37.9%

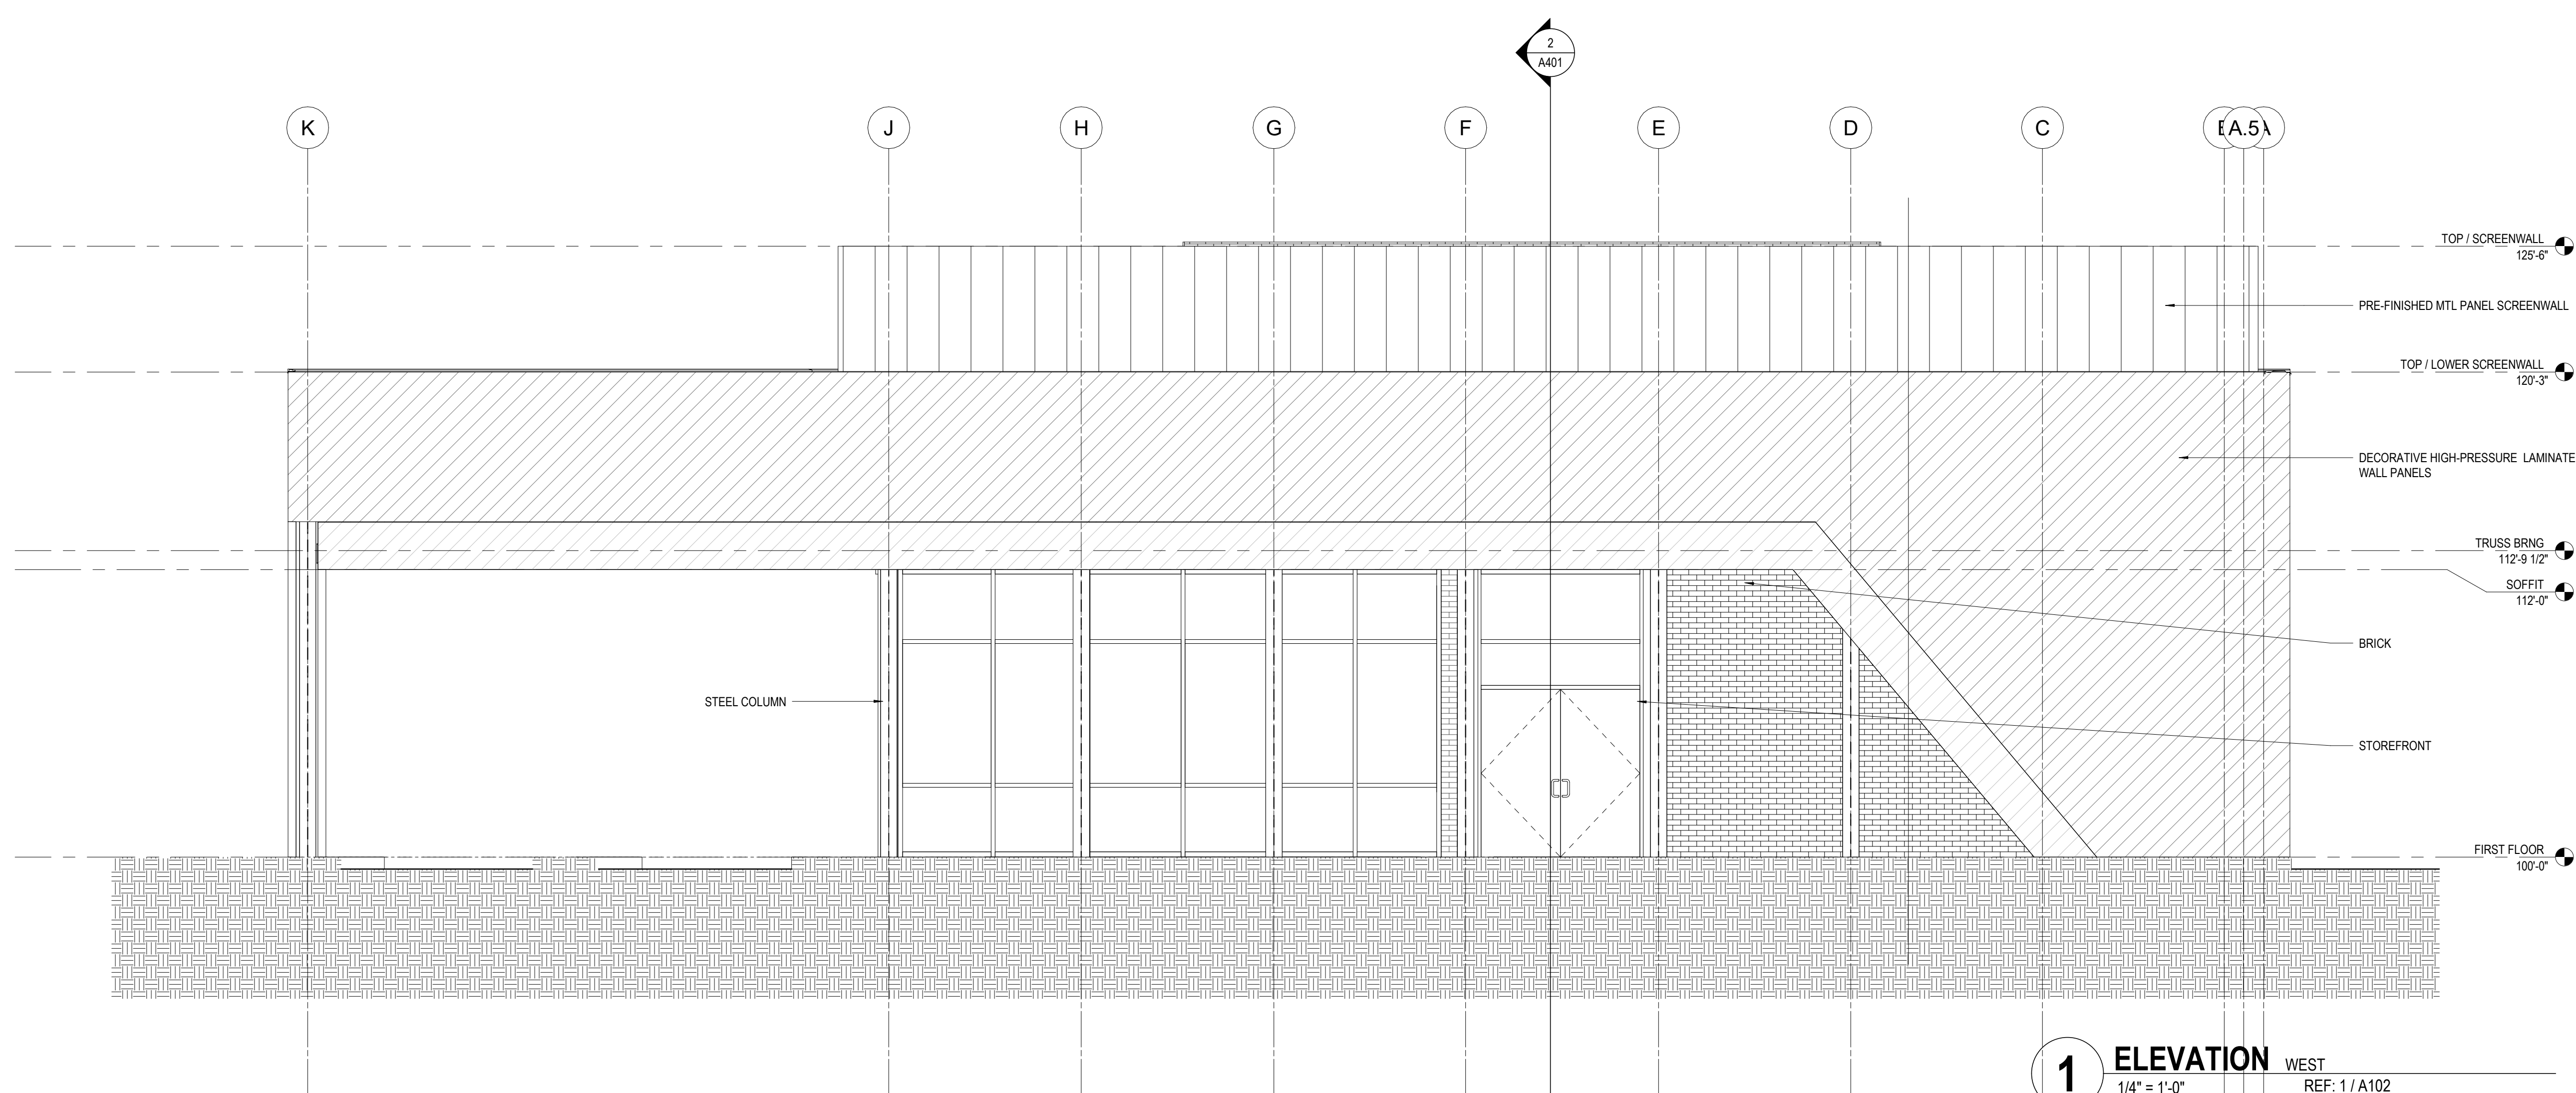

1 ELEVATION WEST
1/4" = 1'-0" REF: 1 / A102

MATERIAL QUANTITIES - EAST ELEVATION
 TOTAL - 1,861 SF
 BRICK - 248 SF (13.3%)
 STOREFRONT - 436 SF (23.4%)
 DECORATIVE HIGH-PRESSURE LAMINATE PANELS - 874 SF (47.0%)
 METAL SCREENWALL PANELS - 303 SF (16.3%)

TRANSPARENCY PERCENTAGES AT BUILDING
 WEST ELEVATION - 436 SF GLAZING / 684 SF = 63.7%


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RENOVATION OF HEARTLAND BANK DUBLIN
 5500 FRANTZ ROAD
 DUBLIN, OH 43017
 FOR HEARTLAND BANK


MOODY-NOLAN
 300 SPRUCE STREET
 SUITE 300
 COLUMBUS, OHIO 43215
 PHONE: (614) 461-4664
 FAX: (614) 280-8881

EXTERIOR ELEVATIONS - OVERALL

PROGRESS DRAWING NOT FOR CONSTRUCTION	09/10/2020	
	DRAWN BY: XXXX	CHECKED BY: XXXX
	20022	
	A302	
PRELIMINARY DEVELOPMENT PLAN		

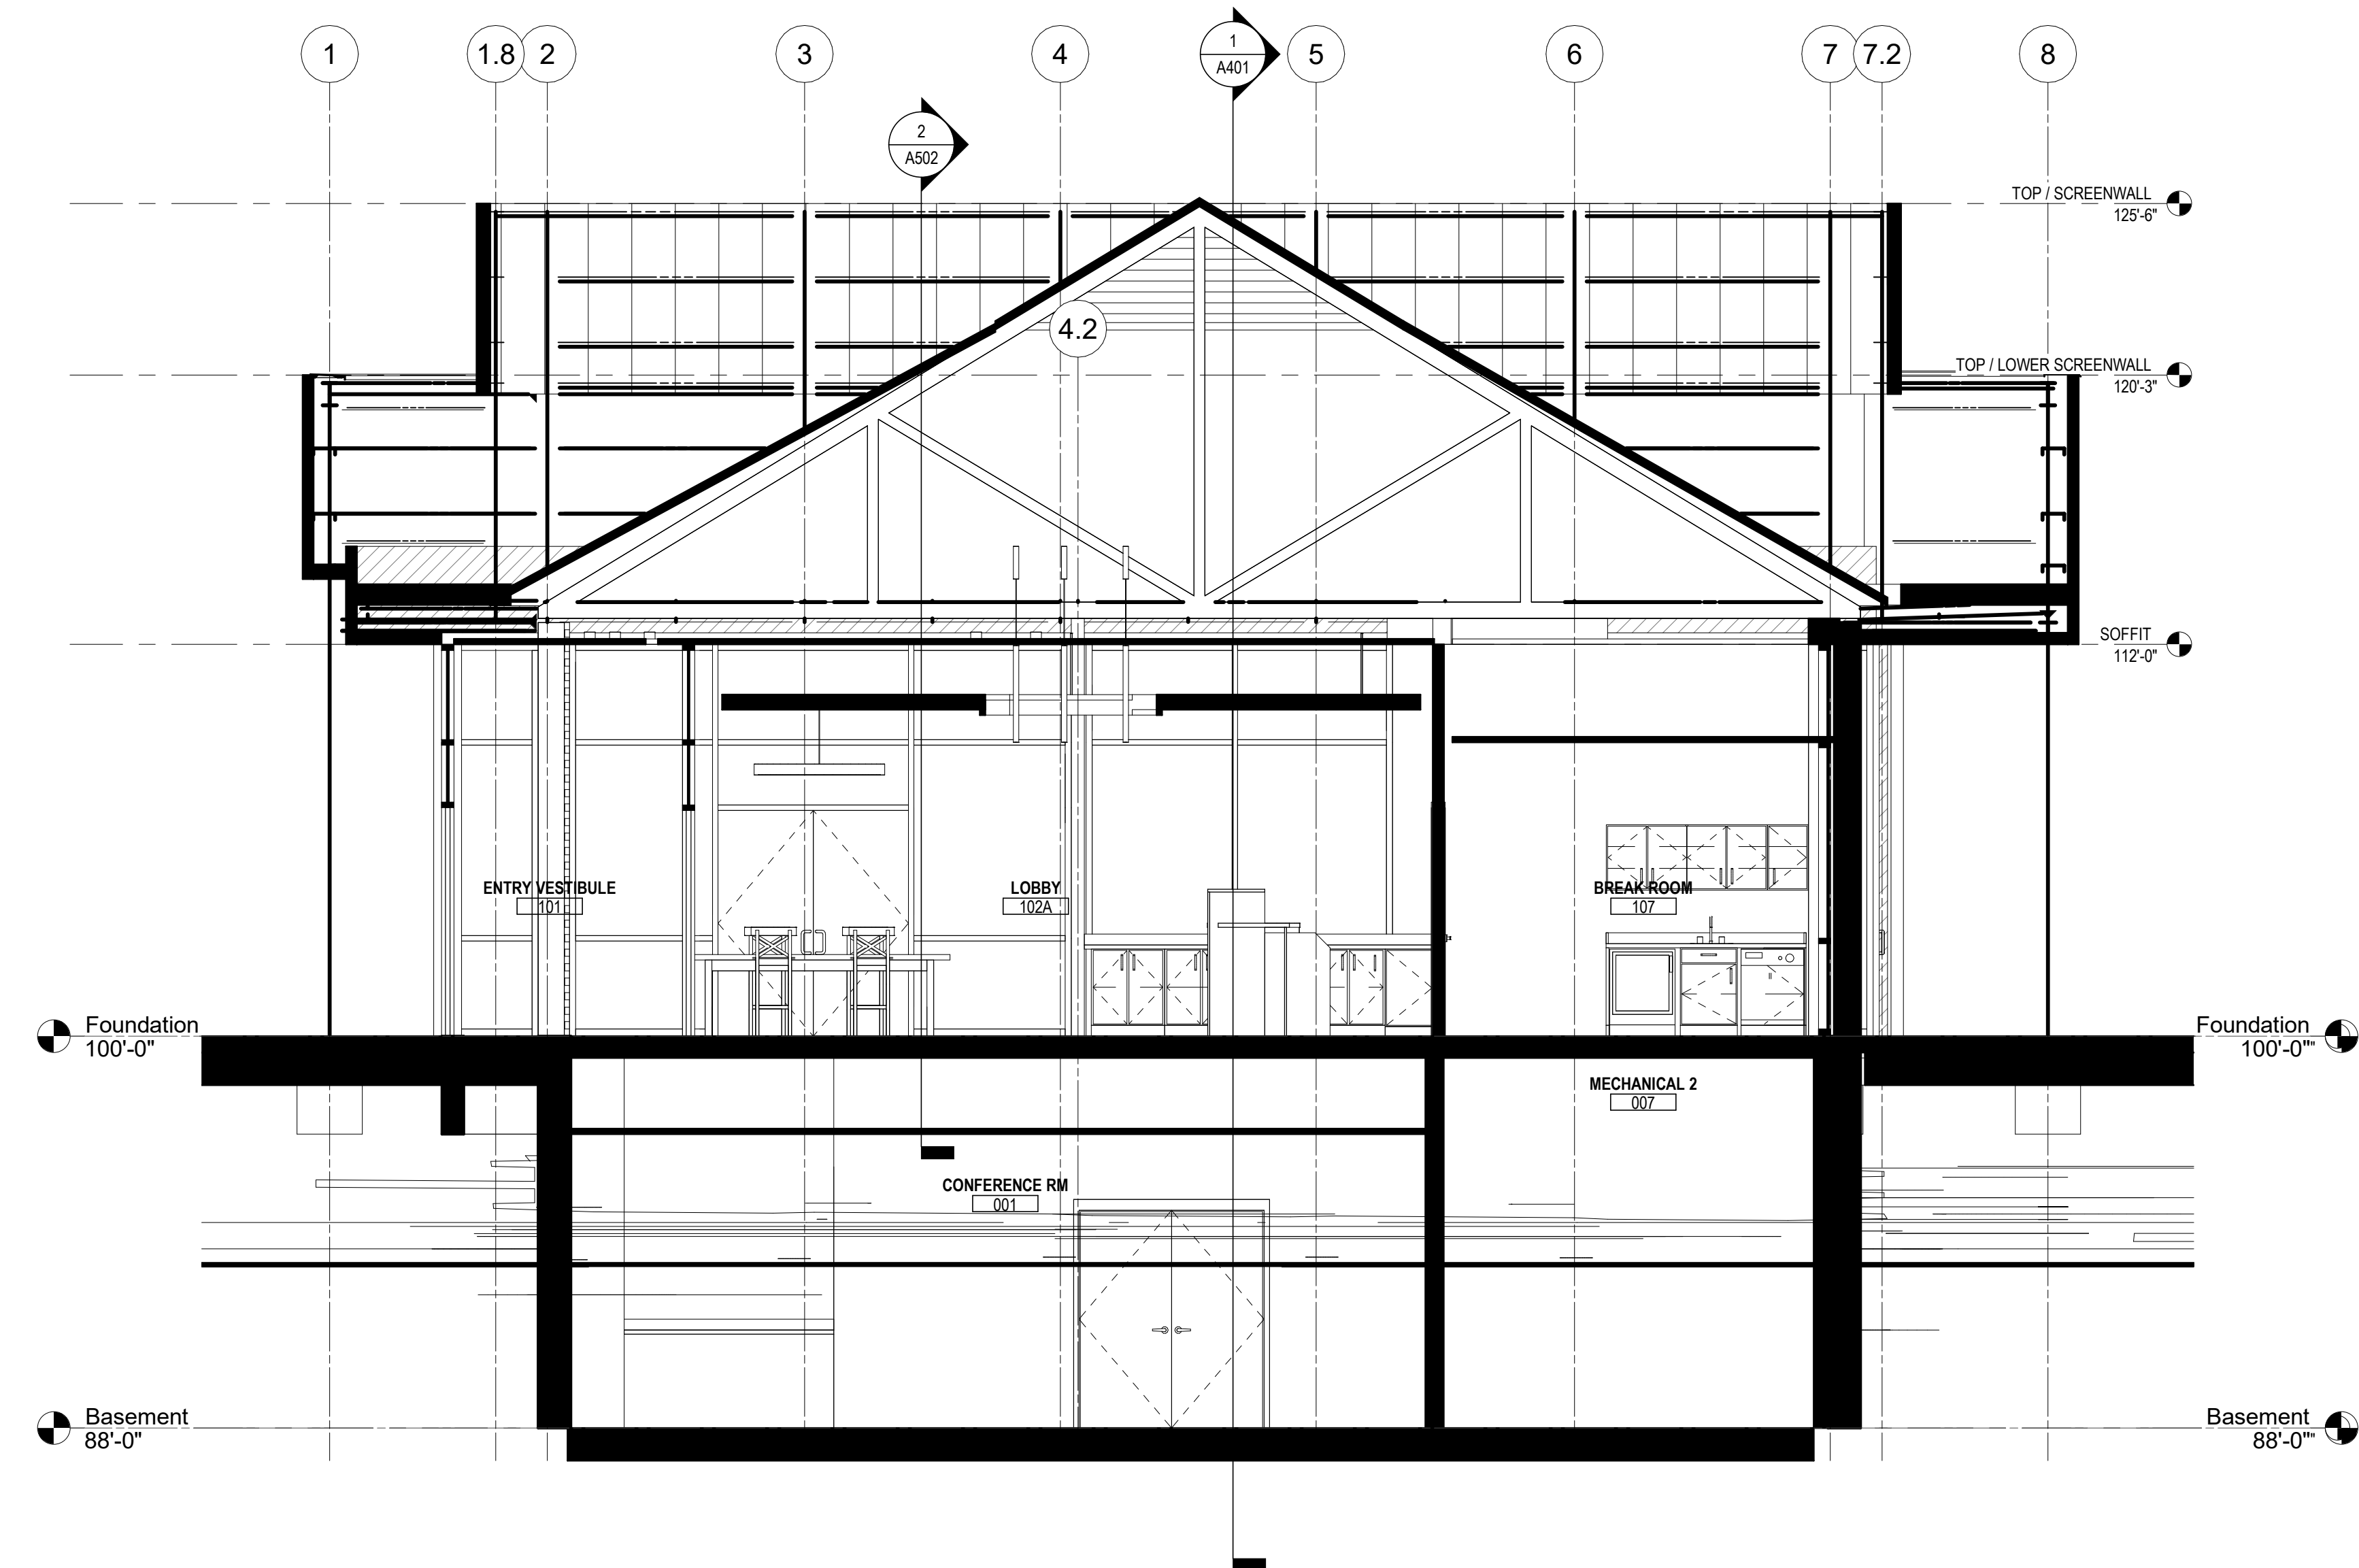

2 EAST-WEST BUILDING SECTION
1/4" = 1'-0"

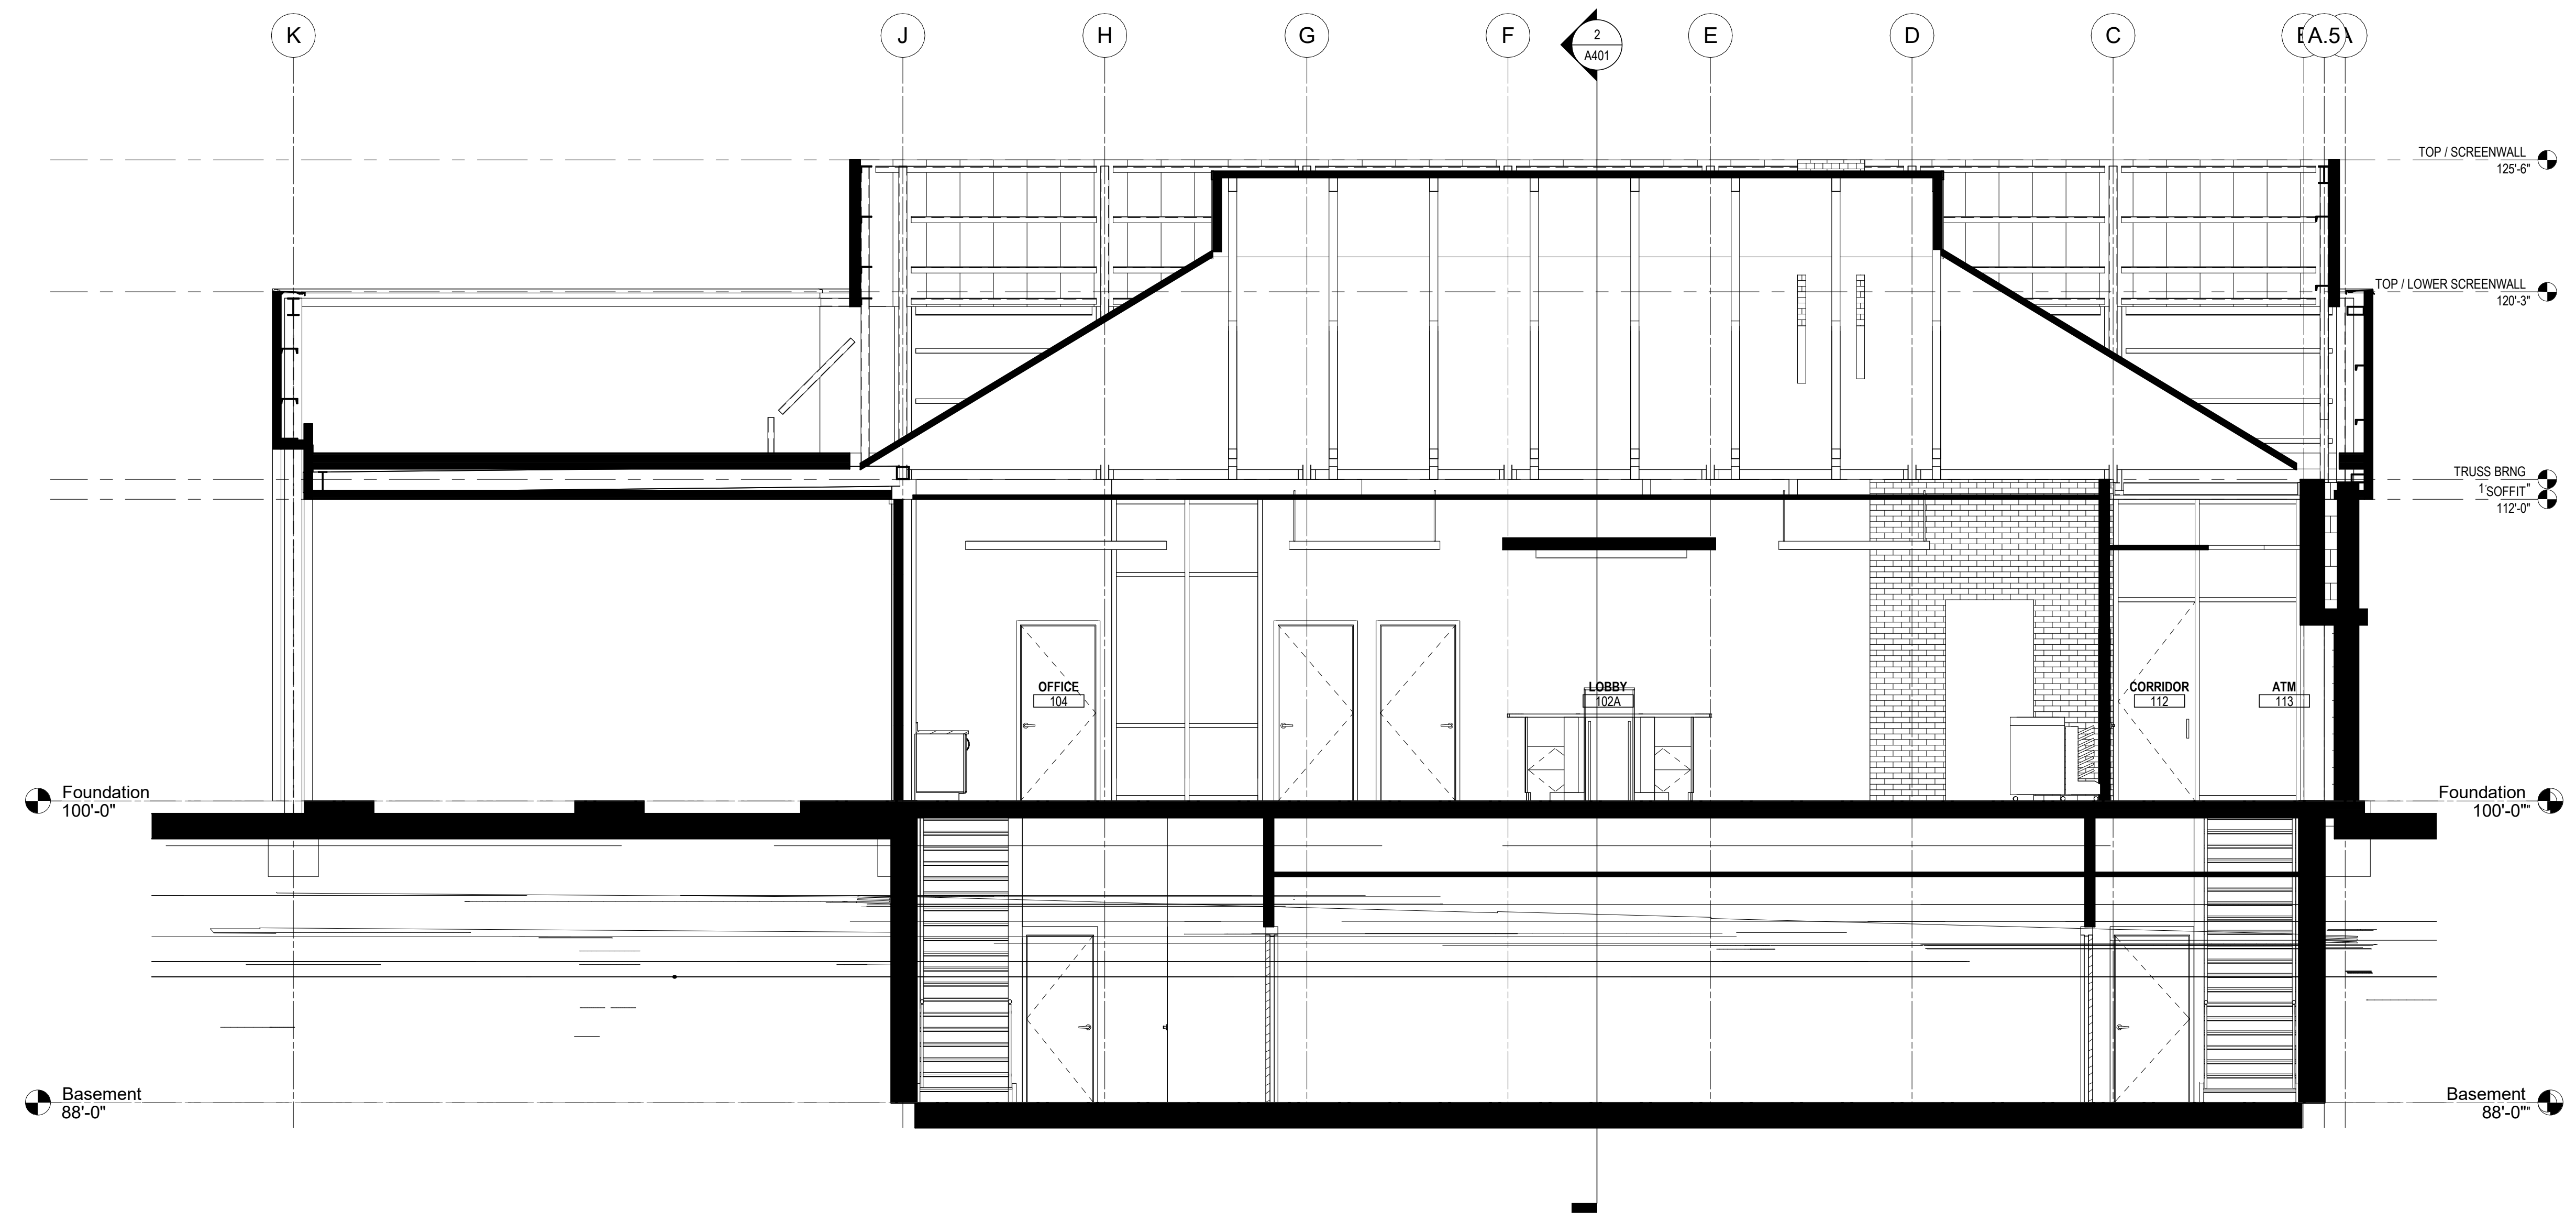

1 NORTH-SOUTH BUILDING SECTION
1/4" = 1'-0"

GENERAL NOTES - BUILDING SECTIONS

1. X

KEYNOTE LEGEND

KEY VALUE KEYNOTE TEXT


#	DATE	CHANGE DESCRIPTION

RENOVATION OF HEARTLAND BANK DUBLIN
6300 PRANTZ ROAD
DUBLIN, OH 43017
FOR
HEARTLAND BANK


MOODY-NOLAN
300 SPRUCE STREET
SUITE 300
COLUMBUS, OHIO 43215
PHONE: (614) 461-4664
FAX: (614) 280-8881

BUILDING SECTIONS

PROGRESS DRAWING NOT FOR CONSTRUCTION	09/10/2020	
	DRAWN BY: XXXX	CHECKED BY: XXXX
	20022	
	A401	
PRELIMINARY DEVELOPMENT PLAN		

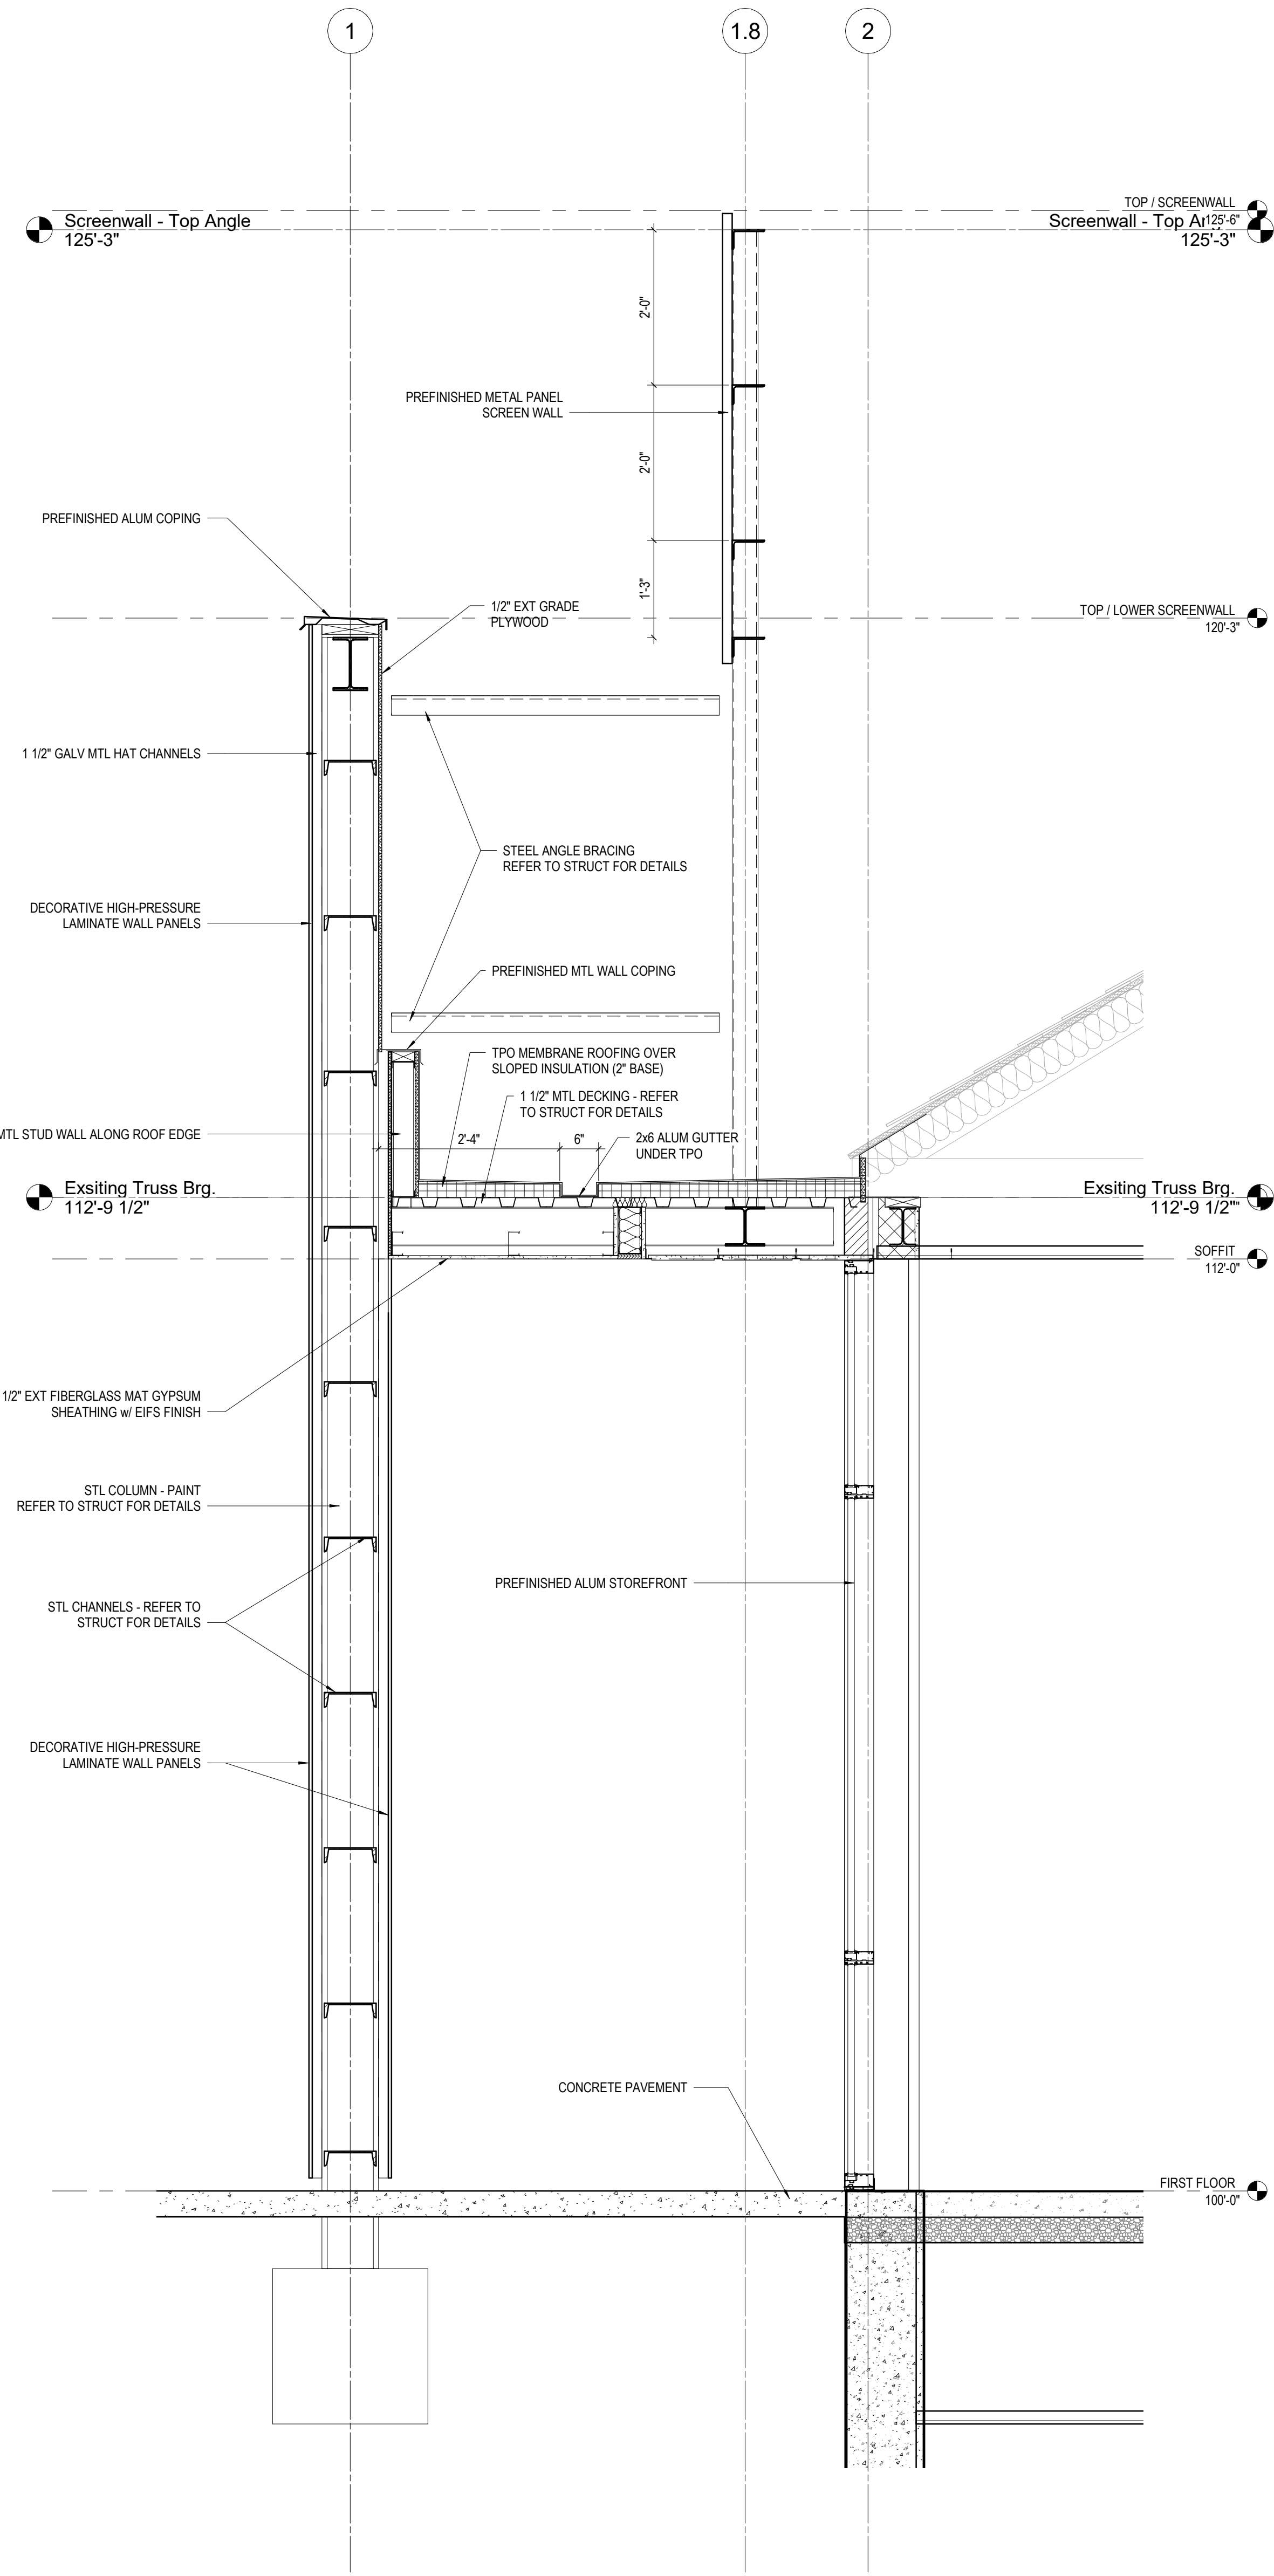

2 SECTION WEST DOUBLE WALL
3/4" = 1'-0"
REF: 1 / A10

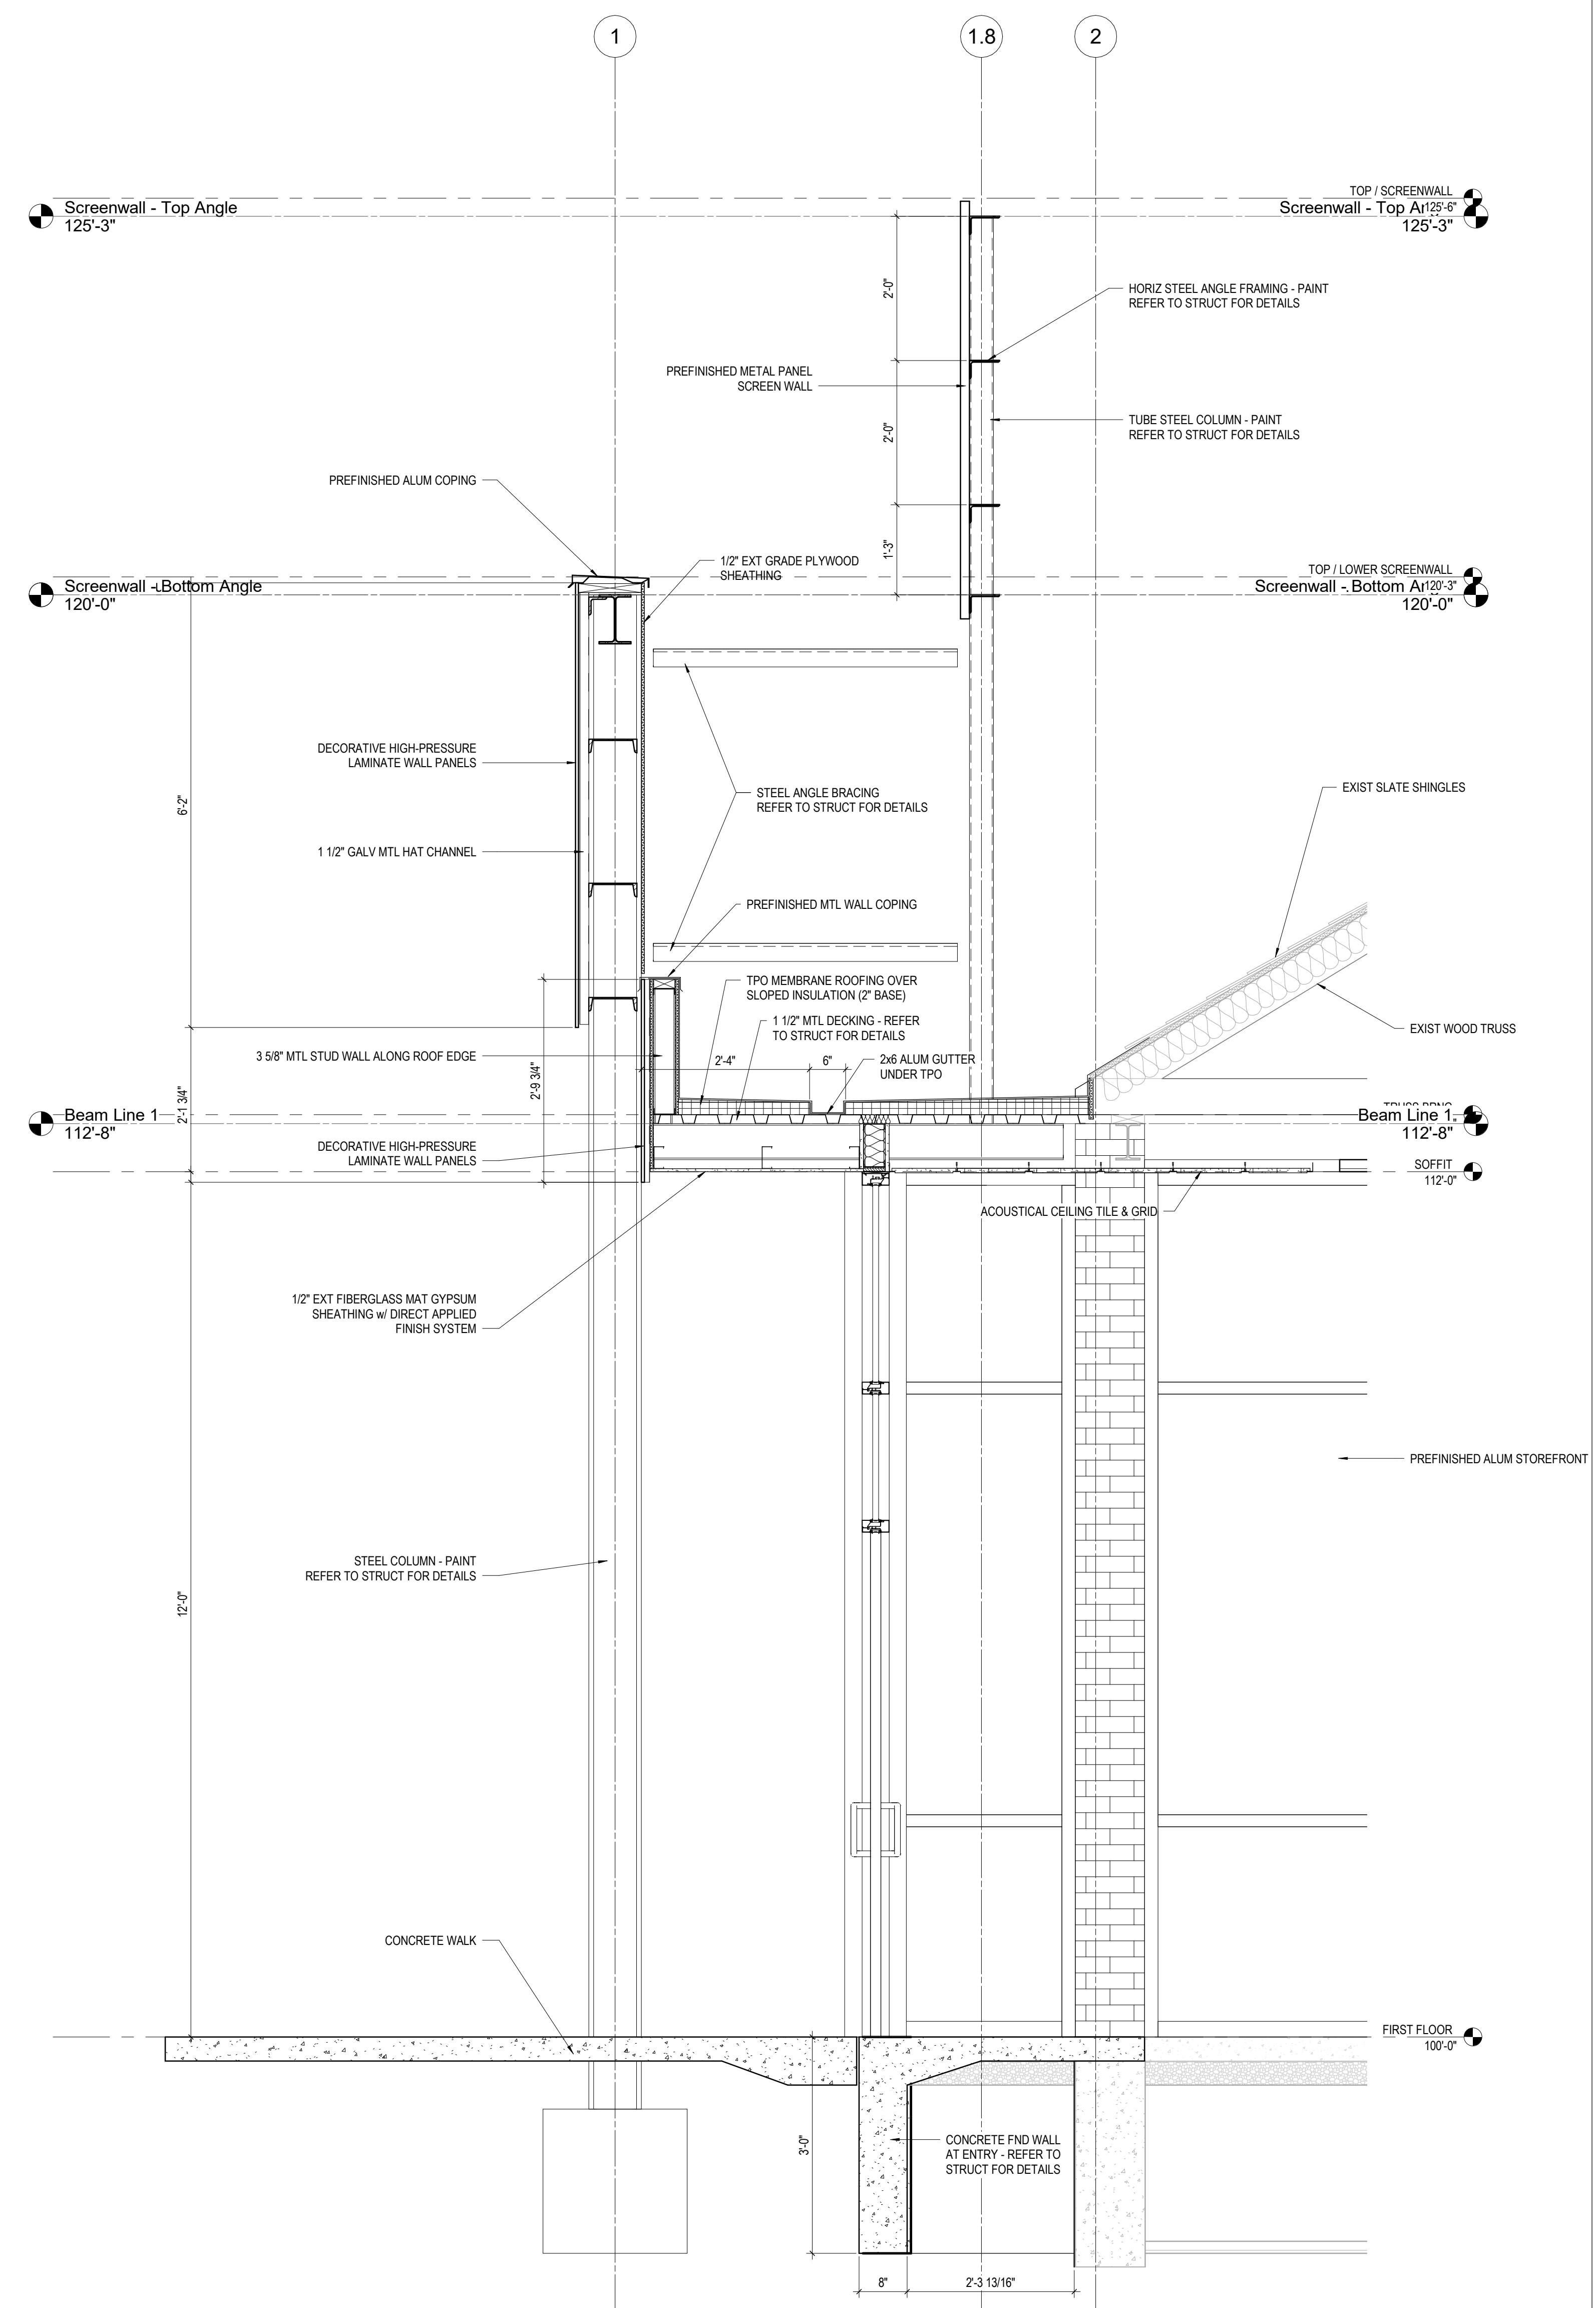

1 SECTION WEST MAIN ENTRY
3/4" = 1'-0"
REF: 1 / A10

GENERAL NOTES - WALL SECTIONS

1. X

KEYNOTE LEGEND

KEY VALUE	KEYNOTE TEXT
-----------	--------------

#	DATE	CHANGE DESCRIPTION


RENOVATION OF HEARTLAND BANK DUBLIN
5300 PRANTZ ROAD
DUBLIN, OH 43017
FOR
HEARTLAND BANK

MOODY-NOLAN
300 SPRUCE STREET
SUITE 300
COLUMBUS, OHIO 43215
PHONE: (614) 461-4664
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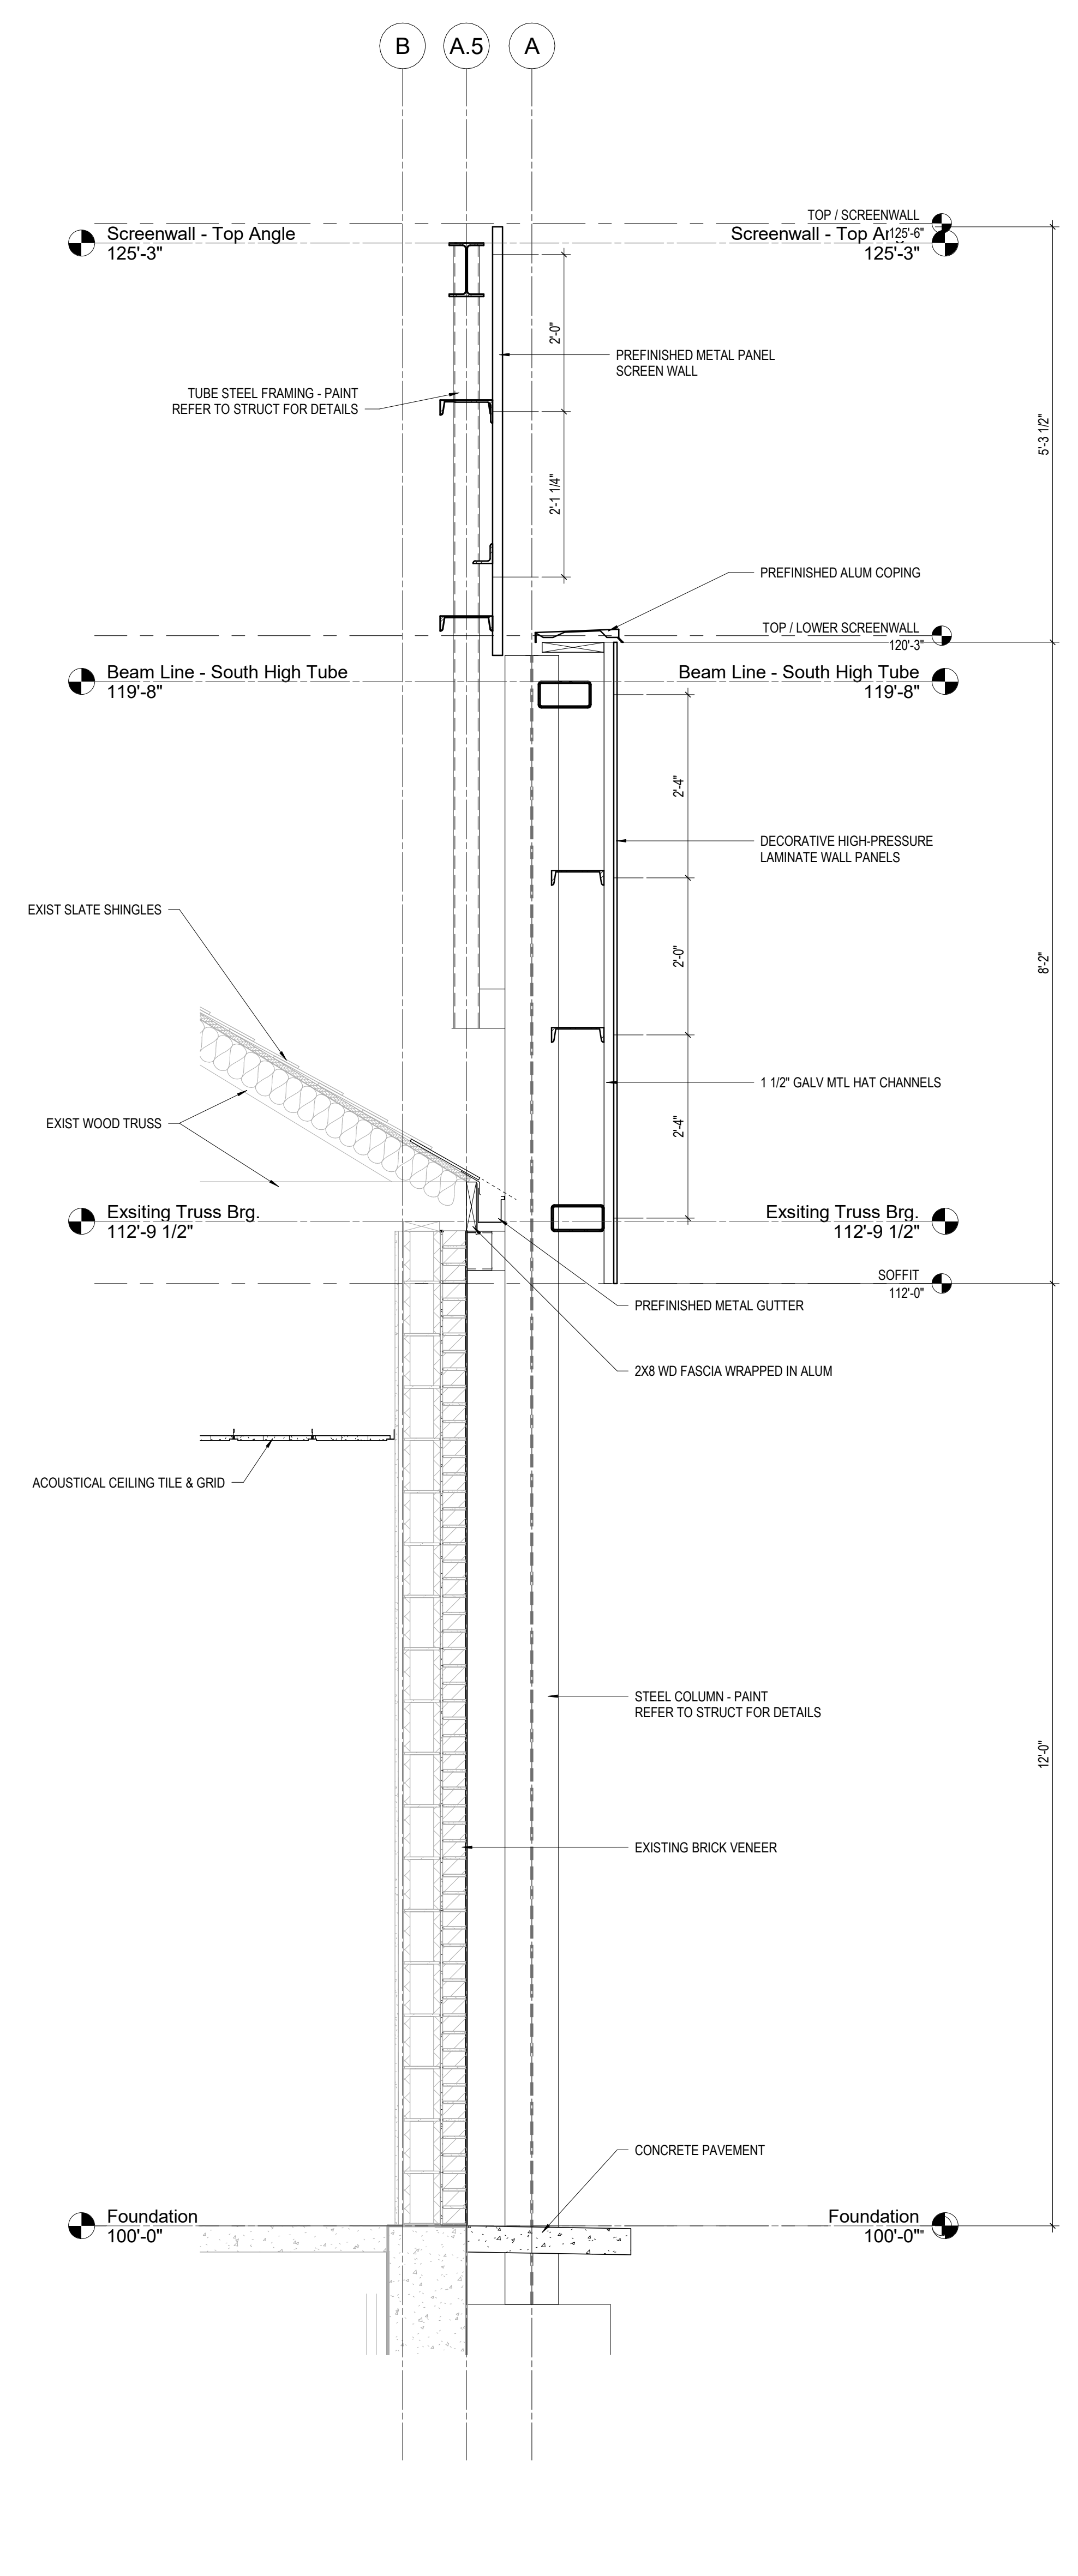
DRAWING TITLE:

WALL SECTIONS

PROGRESS DRAWING NOT FOR CONSTRUCTION	09/10/2020	DRAWN BY: XXXX	CHECKED BY: XXXX
	20022		
	A501		
PRELIMINARY DEVELOPMENT PLAN			

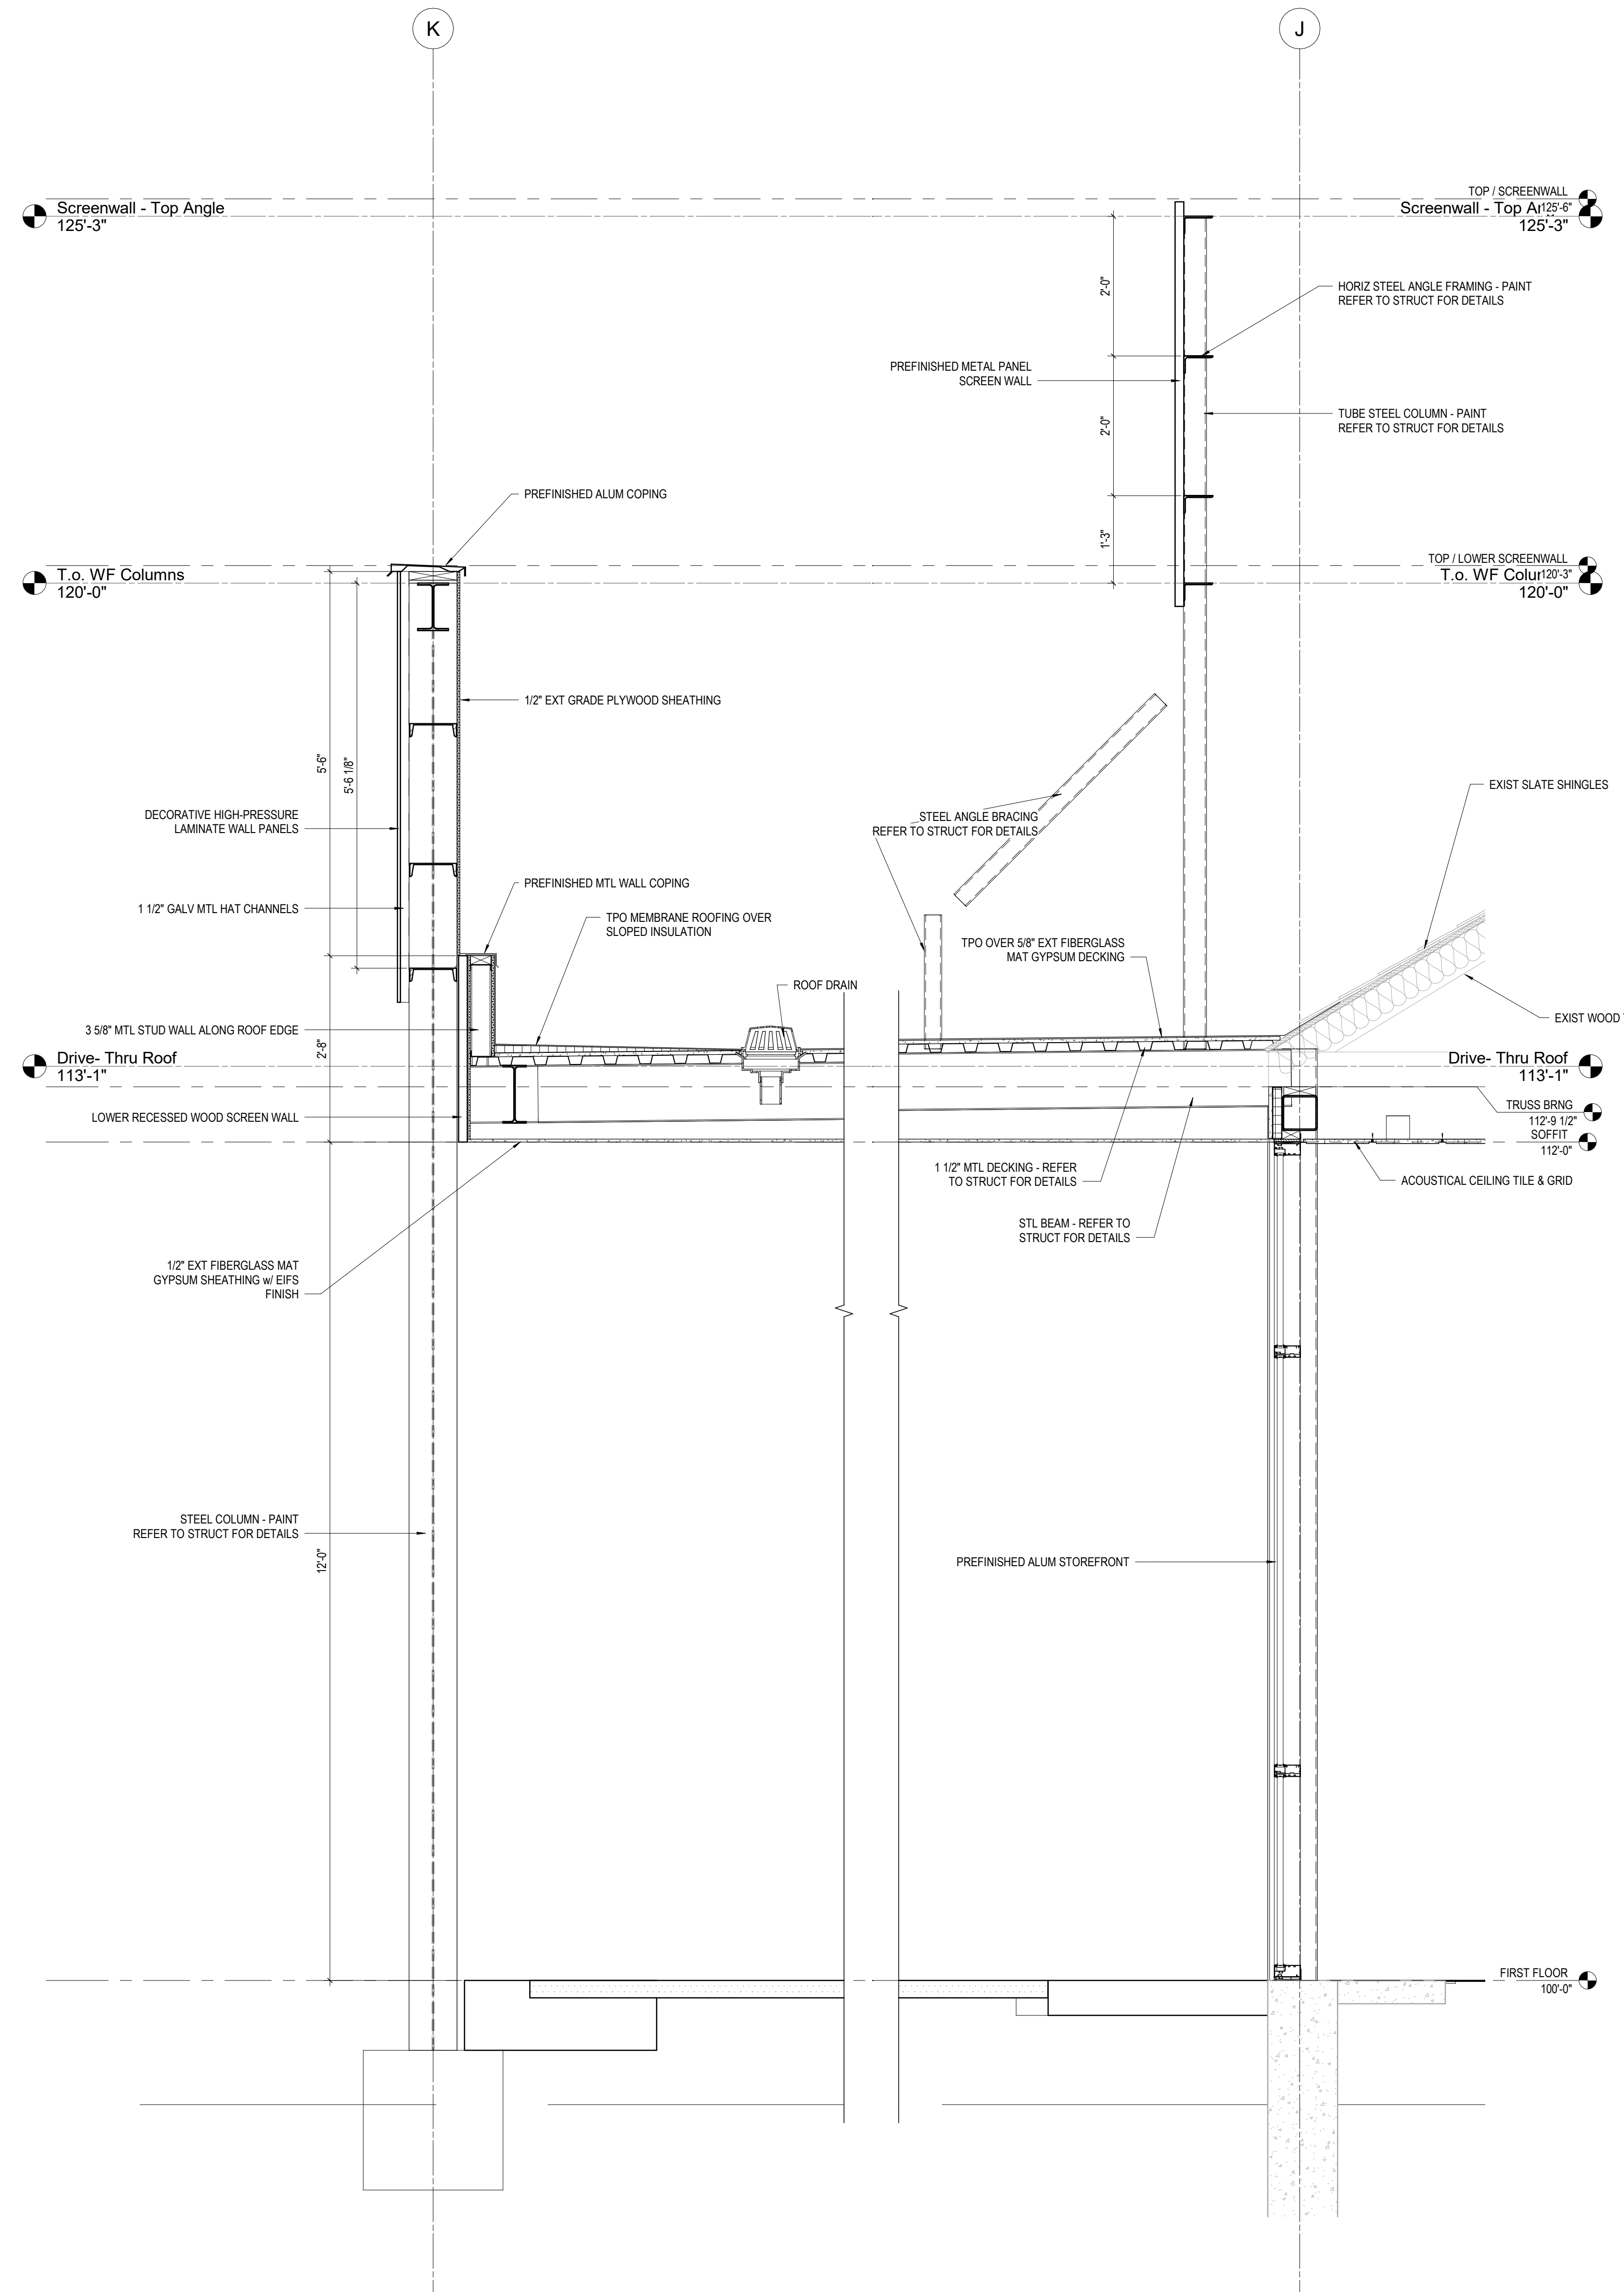

2 SECTION DRIVE-THRU
3/4" = 1'-0" REF: 1 / A102



1 SECTION SOUTH WALL
3/4" = 1'-0" REF: 1 / A102

GENERAL NOTES - WALL SECTIONS

1. X

KEYNOTE LEGEND

KEY VALUE	KEYNOTE TEXT
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#	DATE	CHANGE DESCRIPTION

RENOVATION OF HEARTLAND BANK DUBLIN
5000 PRANTZ ROAD
DUBLIN, OH 43017
FOR
HEARTLAND BANK


MOODY-NOLAN
300 SPRUCE STREET
SUITE 300
COLUMBUS, OHIO 43215
PHONE: (614) 461-4664
FAX: (614) 280-8881

WALL SECTIONS

09/10/2020
DRAWN BY: XXXX CHECKED BY: XXXX
20022
A502
PRELIMINARY DEVELOPMENT PLAN


PROGRESS DRAWING NOT FOR CONSTRUCTION

DOOR PANEL TYPE LEGEND

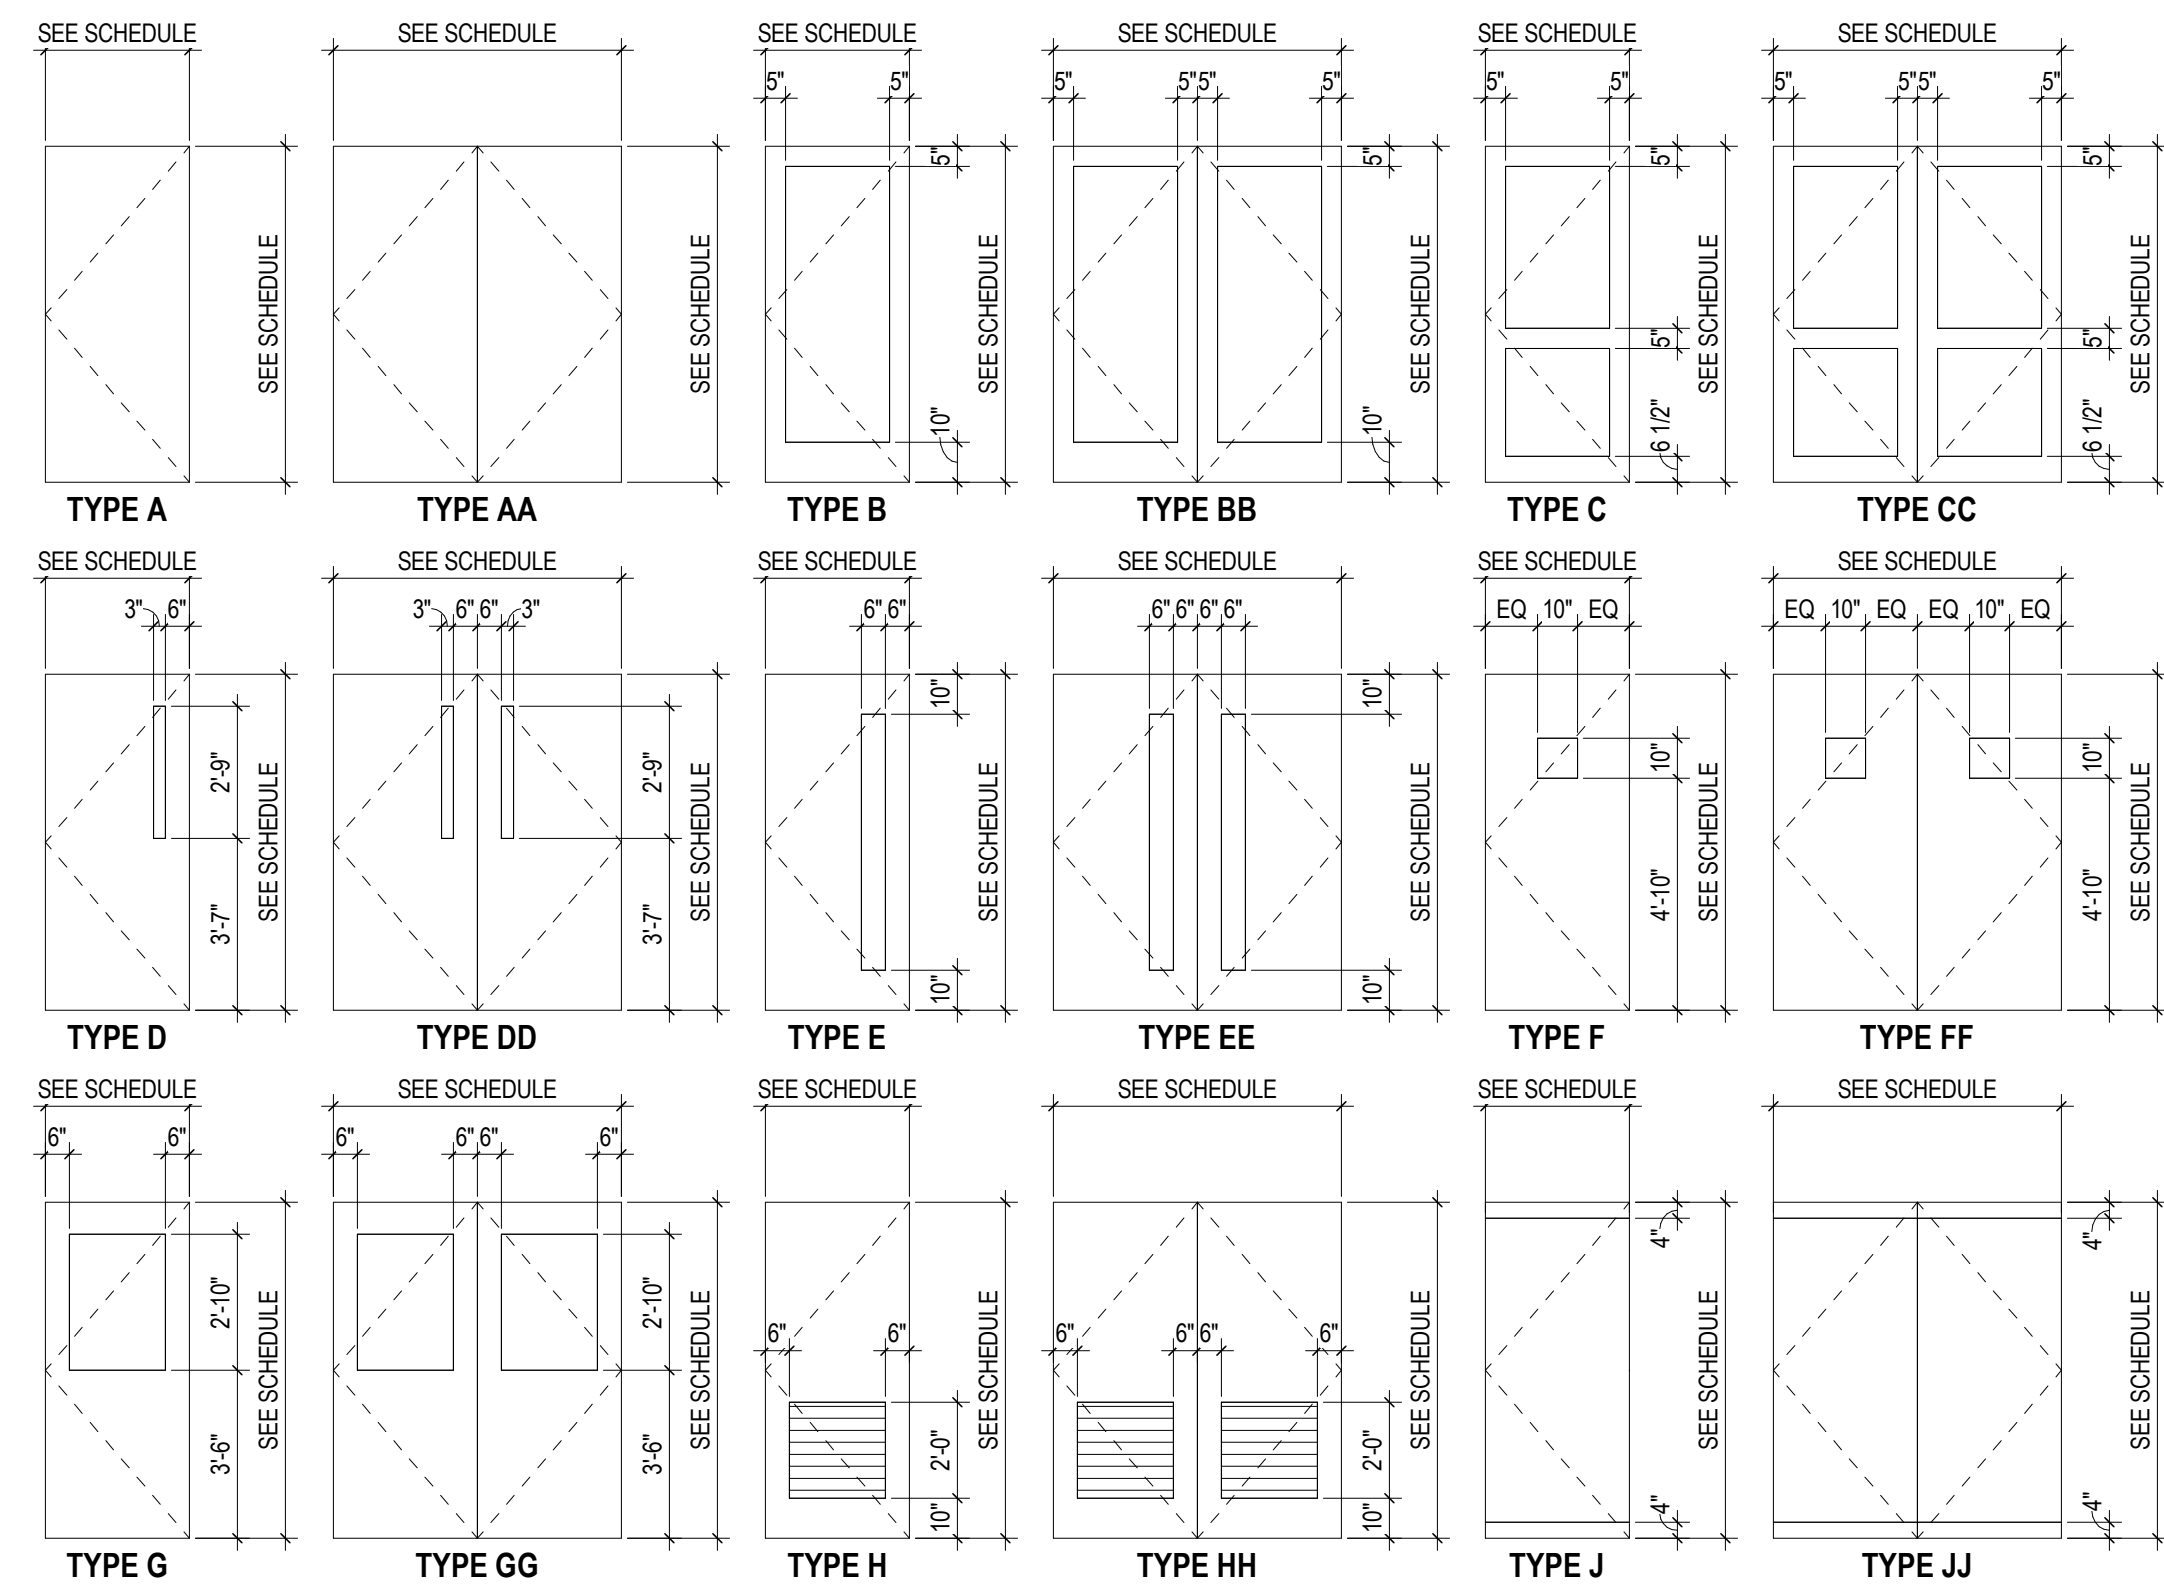


DOOR SCHEDULE													
NUMBER	ROOM NAME	DOOR				FRAME		FIRE RATING	HDW SET	DETAILS - SHEET AX,XX			REMARKS
		WIDTH	HEIGHT	MATERIAL	ELEV	MATERIAL	ELEV			HEAD	JAMB	SILL	
	BREAK ROOM	6'-7 1/2"	9'-11"										
	LOBBY	3'-0"	8'-0"										
	OFFICE	2'-4 1/8"	11'-9 3/4"										
	OFFICE	2'-10"	11'-9 1/2"										
	OFFICE	2'-4 3/4"	3'-2 3/4"										
	LOBBY	2'-4 3/4"	3'-2 3/4"										
	STAIRS	5'-5 5/16"	11'-7 1/8"										
6		4'-11 3/4"	9'-11"										
16	OFFICE	2'-4"	6'-8"		A								
18													
19	CORRIDOR	5'-8"	6'-8"		AA			4					
20	JAN	2'-8"	6'-8"		A			2					
21	MENS RESTROOM	2'-8"	6'-8"		A			2					
22	WOMENS RESTROOM	2'-8"	6'-8"		A			2					
23													
24	MECHANICAL 1	3'-0"	6'-8"		A			2					
25	CORRIDOR	5'-6"	6'-8"		AA			4					
26	STORAGE	3'-0"	6'-8"		A			2					
28		5'-5 5/16"	9'-11"										
30	OFFICE	3'-0"	6'-8"		A			1					
31		3'-0"	7'-0"		A			1					
32	STAR 02	2'-6"	7'-0"		A			1					
34		6'-7 1/2"	7'-0"										
36	ENTRY VESTIBULE	6'-7 1/2"	6'-11"										
39	BREAK ROOM	3'-0"	7'-0"		A			1					
104	STAIRS	3'-0"	7'-0"		A			1					
105		5'-5 1/2"	6'-11"										
106	OFFICE	3'-0"	7'-0"		A			1					
107	BREAK ROOM	3'-0"	7'-0"		A			1					
108	STORAGE	2'-4"	6'-8"		A			1					
109	UNISEX RR	2'-4"	6'-8"		A			1					
111	ATM	3'-0 3/4"	7'-11"										
111		5'-5 5/16"	6'-11"										
112	ATM	2'-4"	6'-8"		A			1					
113		12'-0"	6'-0"		AA			4					
209		5'-10"	6'-11"										
213	LOBBY	2'-6"	7'-0"		A			1					
219	MECHANICAL 1	2'-6"	7'-0"		A			1					


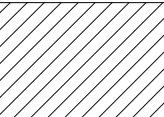
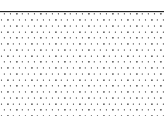
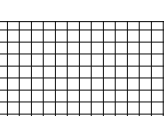
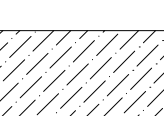
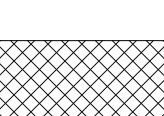
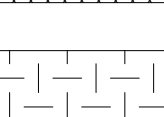
DOOR FRAME TYPE LEGEND

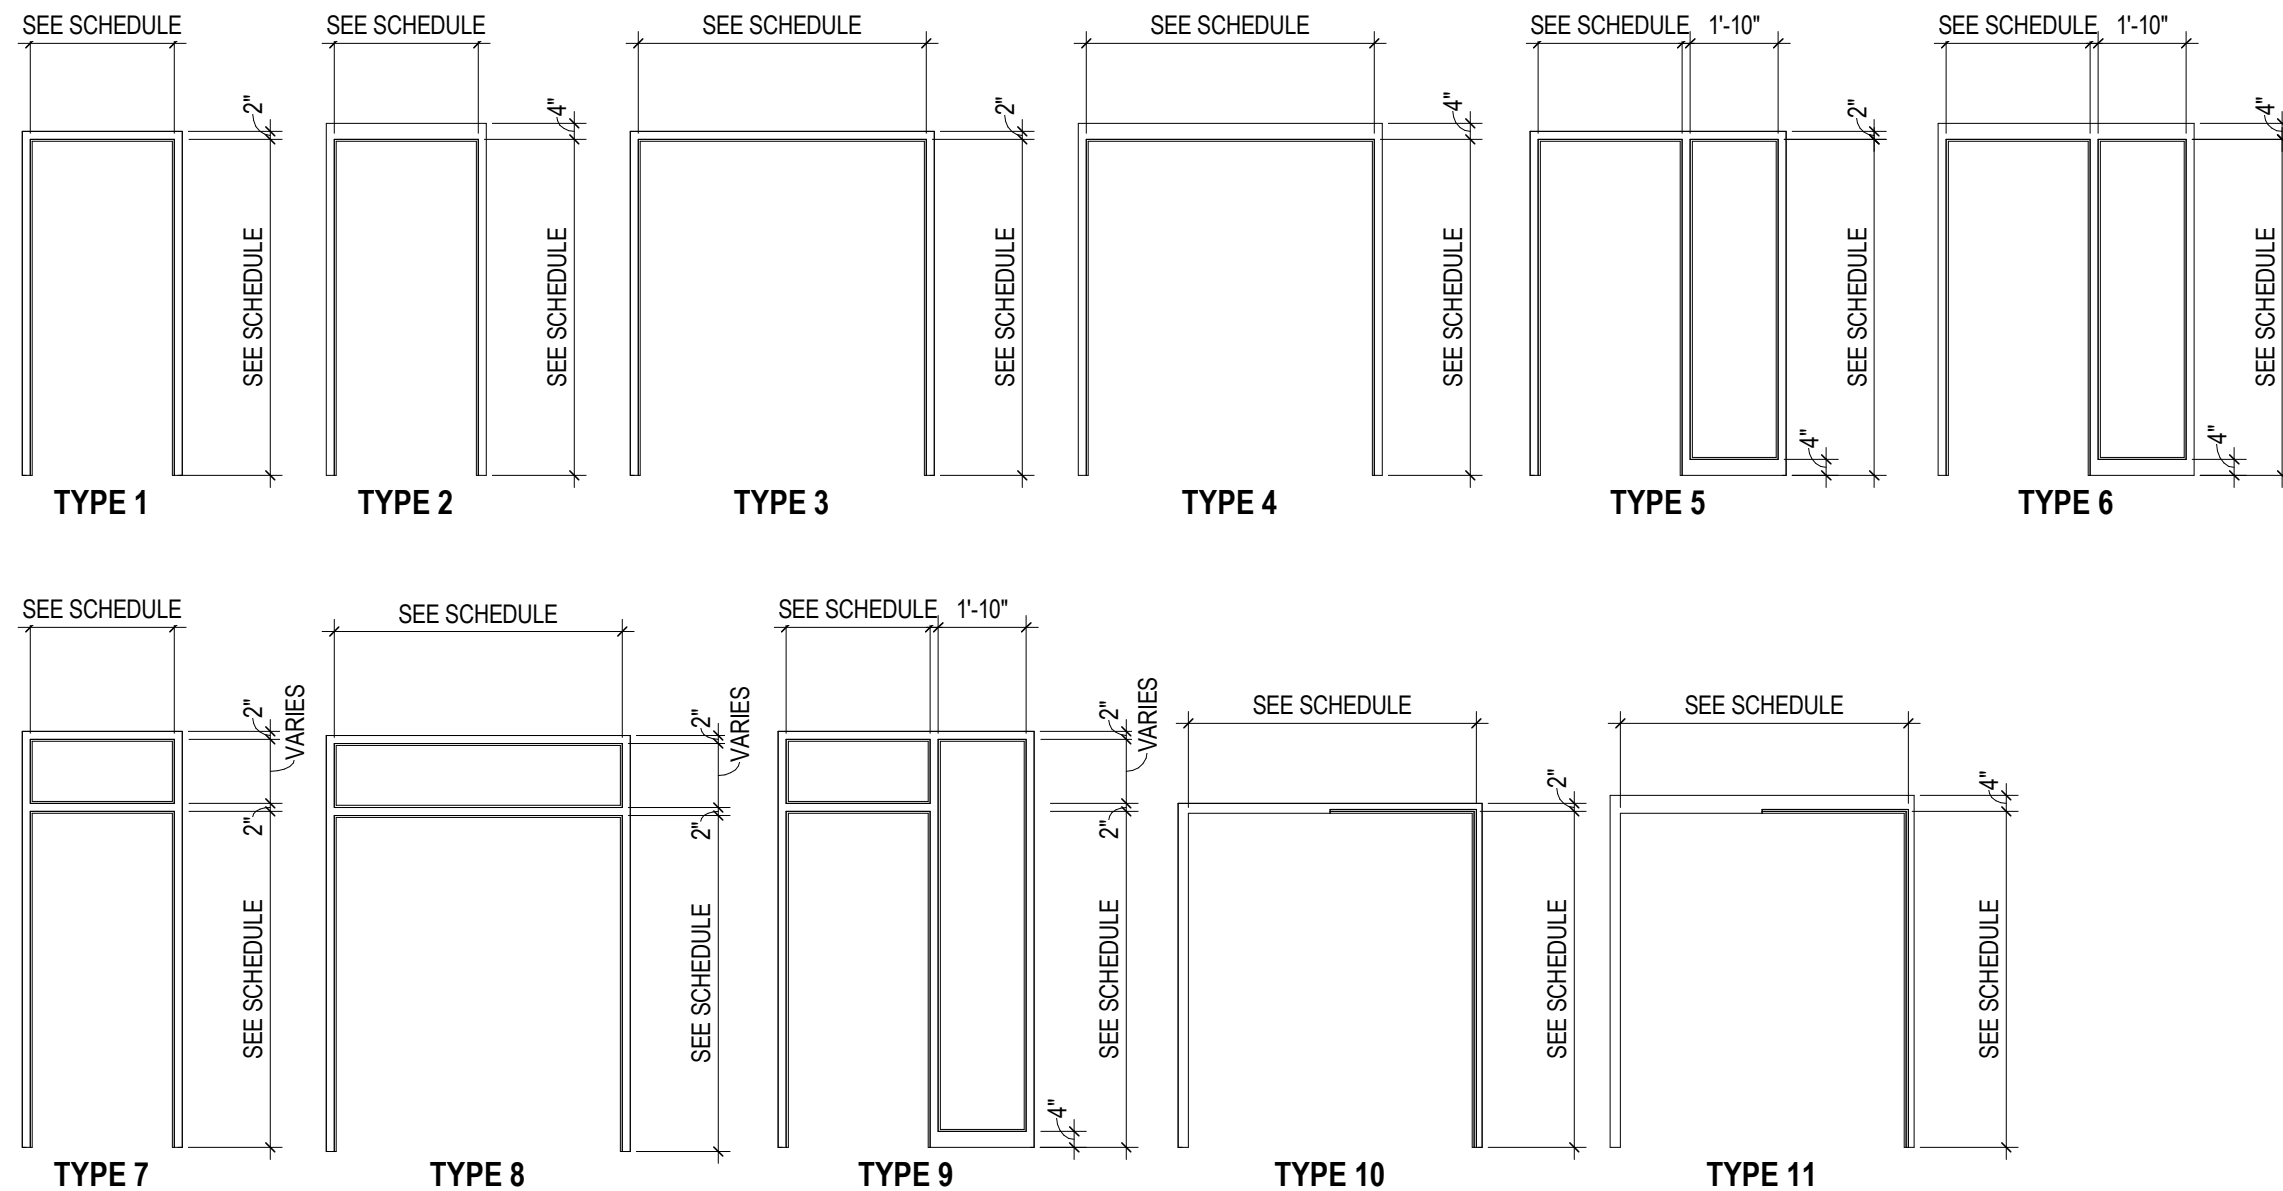

DOOR CLEARANCES

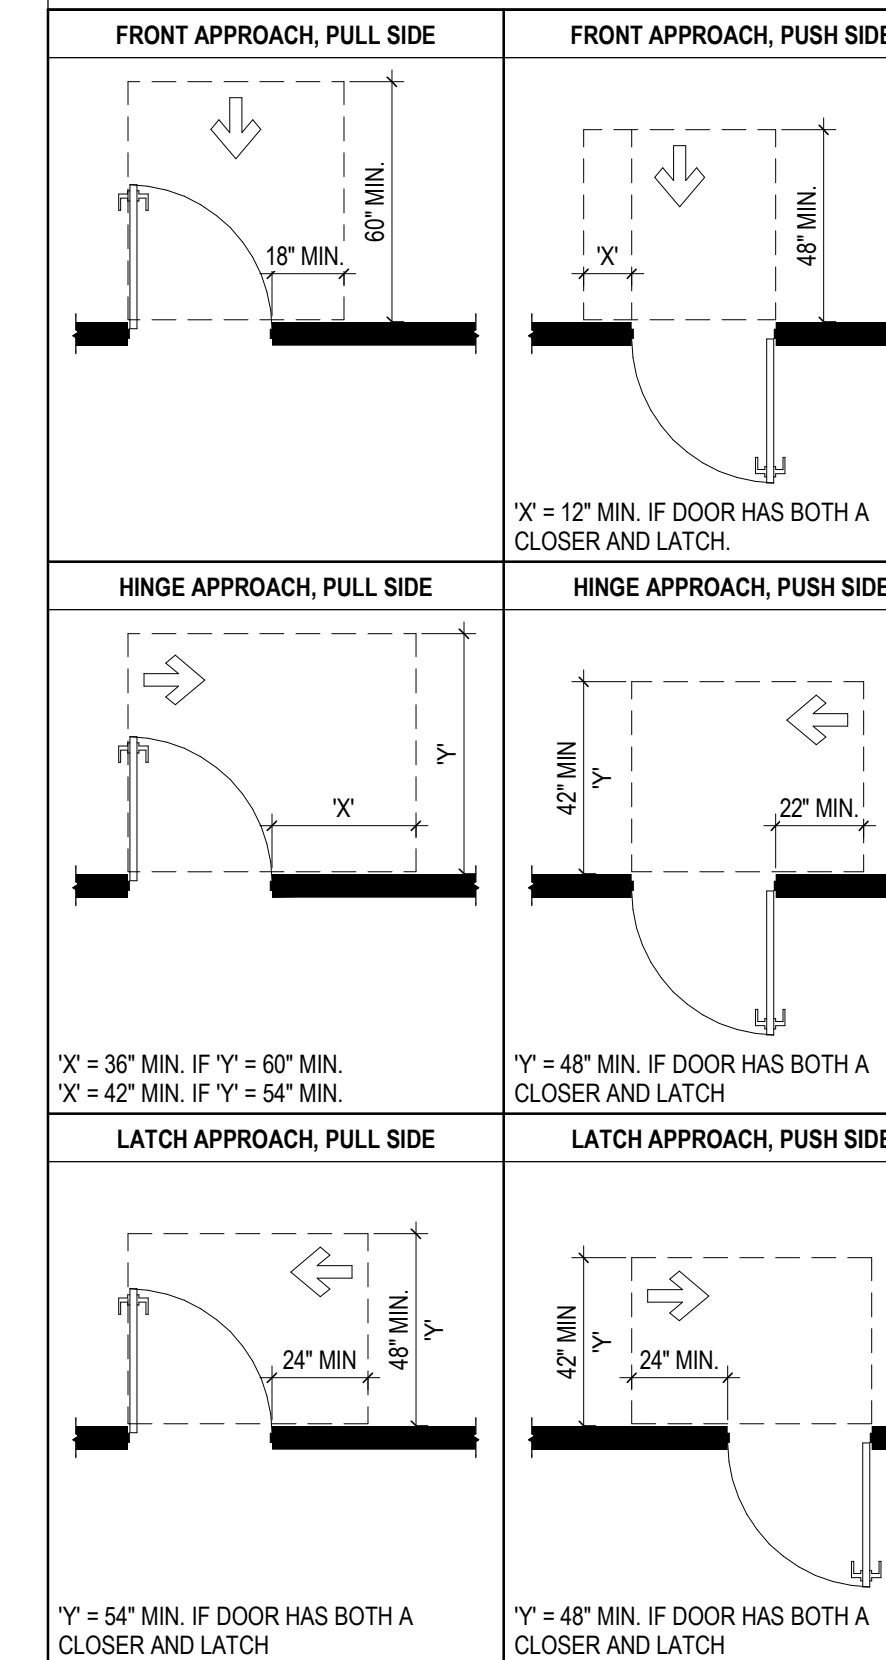

GLAZING TYPES

-  **GL-1** INTERIOR GLAZING (CLEAR TEMPERED)
-  **GL-2** INTERIOR GLAZING (CLEAR LAMINATED)
-  **GL-3** INTERIOR GLAZING (CERAMIC 45 MINUTE)
-  **GL-4** INTERIOR GLAZING (CERAMIC 60 MINUTE)
-  **GL-5** INTERIOR GLAZING (CERAMIC 90 MINUTE)
-  **GL-6** INTERIOR GLAZING (FROSTED)
-  **GL-7** INTERIOR GLAZING (GRIDDED)


#	DATE	CHANGE DESCRIPTION

RENOVATION OF HEARTLAND BANK DUBLIN
 8300 PRANTZ ROAD
 DUBLIN, OH 43017
 FOR
HEARTLAND BANK


 **MOODY-NOLAN**
 300 SPRUCE STREET
 SUITE 300
 COLUMBUS, OHIO 43215
 PHONE: (614) 461-4664
 FAX: (614) 280-8881

DOOR & WINDOW SCHEDULES


PROGRESS DRAWING NOT FOR CONSTRUCTION	09/10/2020	
	DRAWN BY: XXXX	CHECKED BY: XXXX
	20022	
	<h1>A701</h1> PRELIMINARY DEVELOPMENT PLAN	

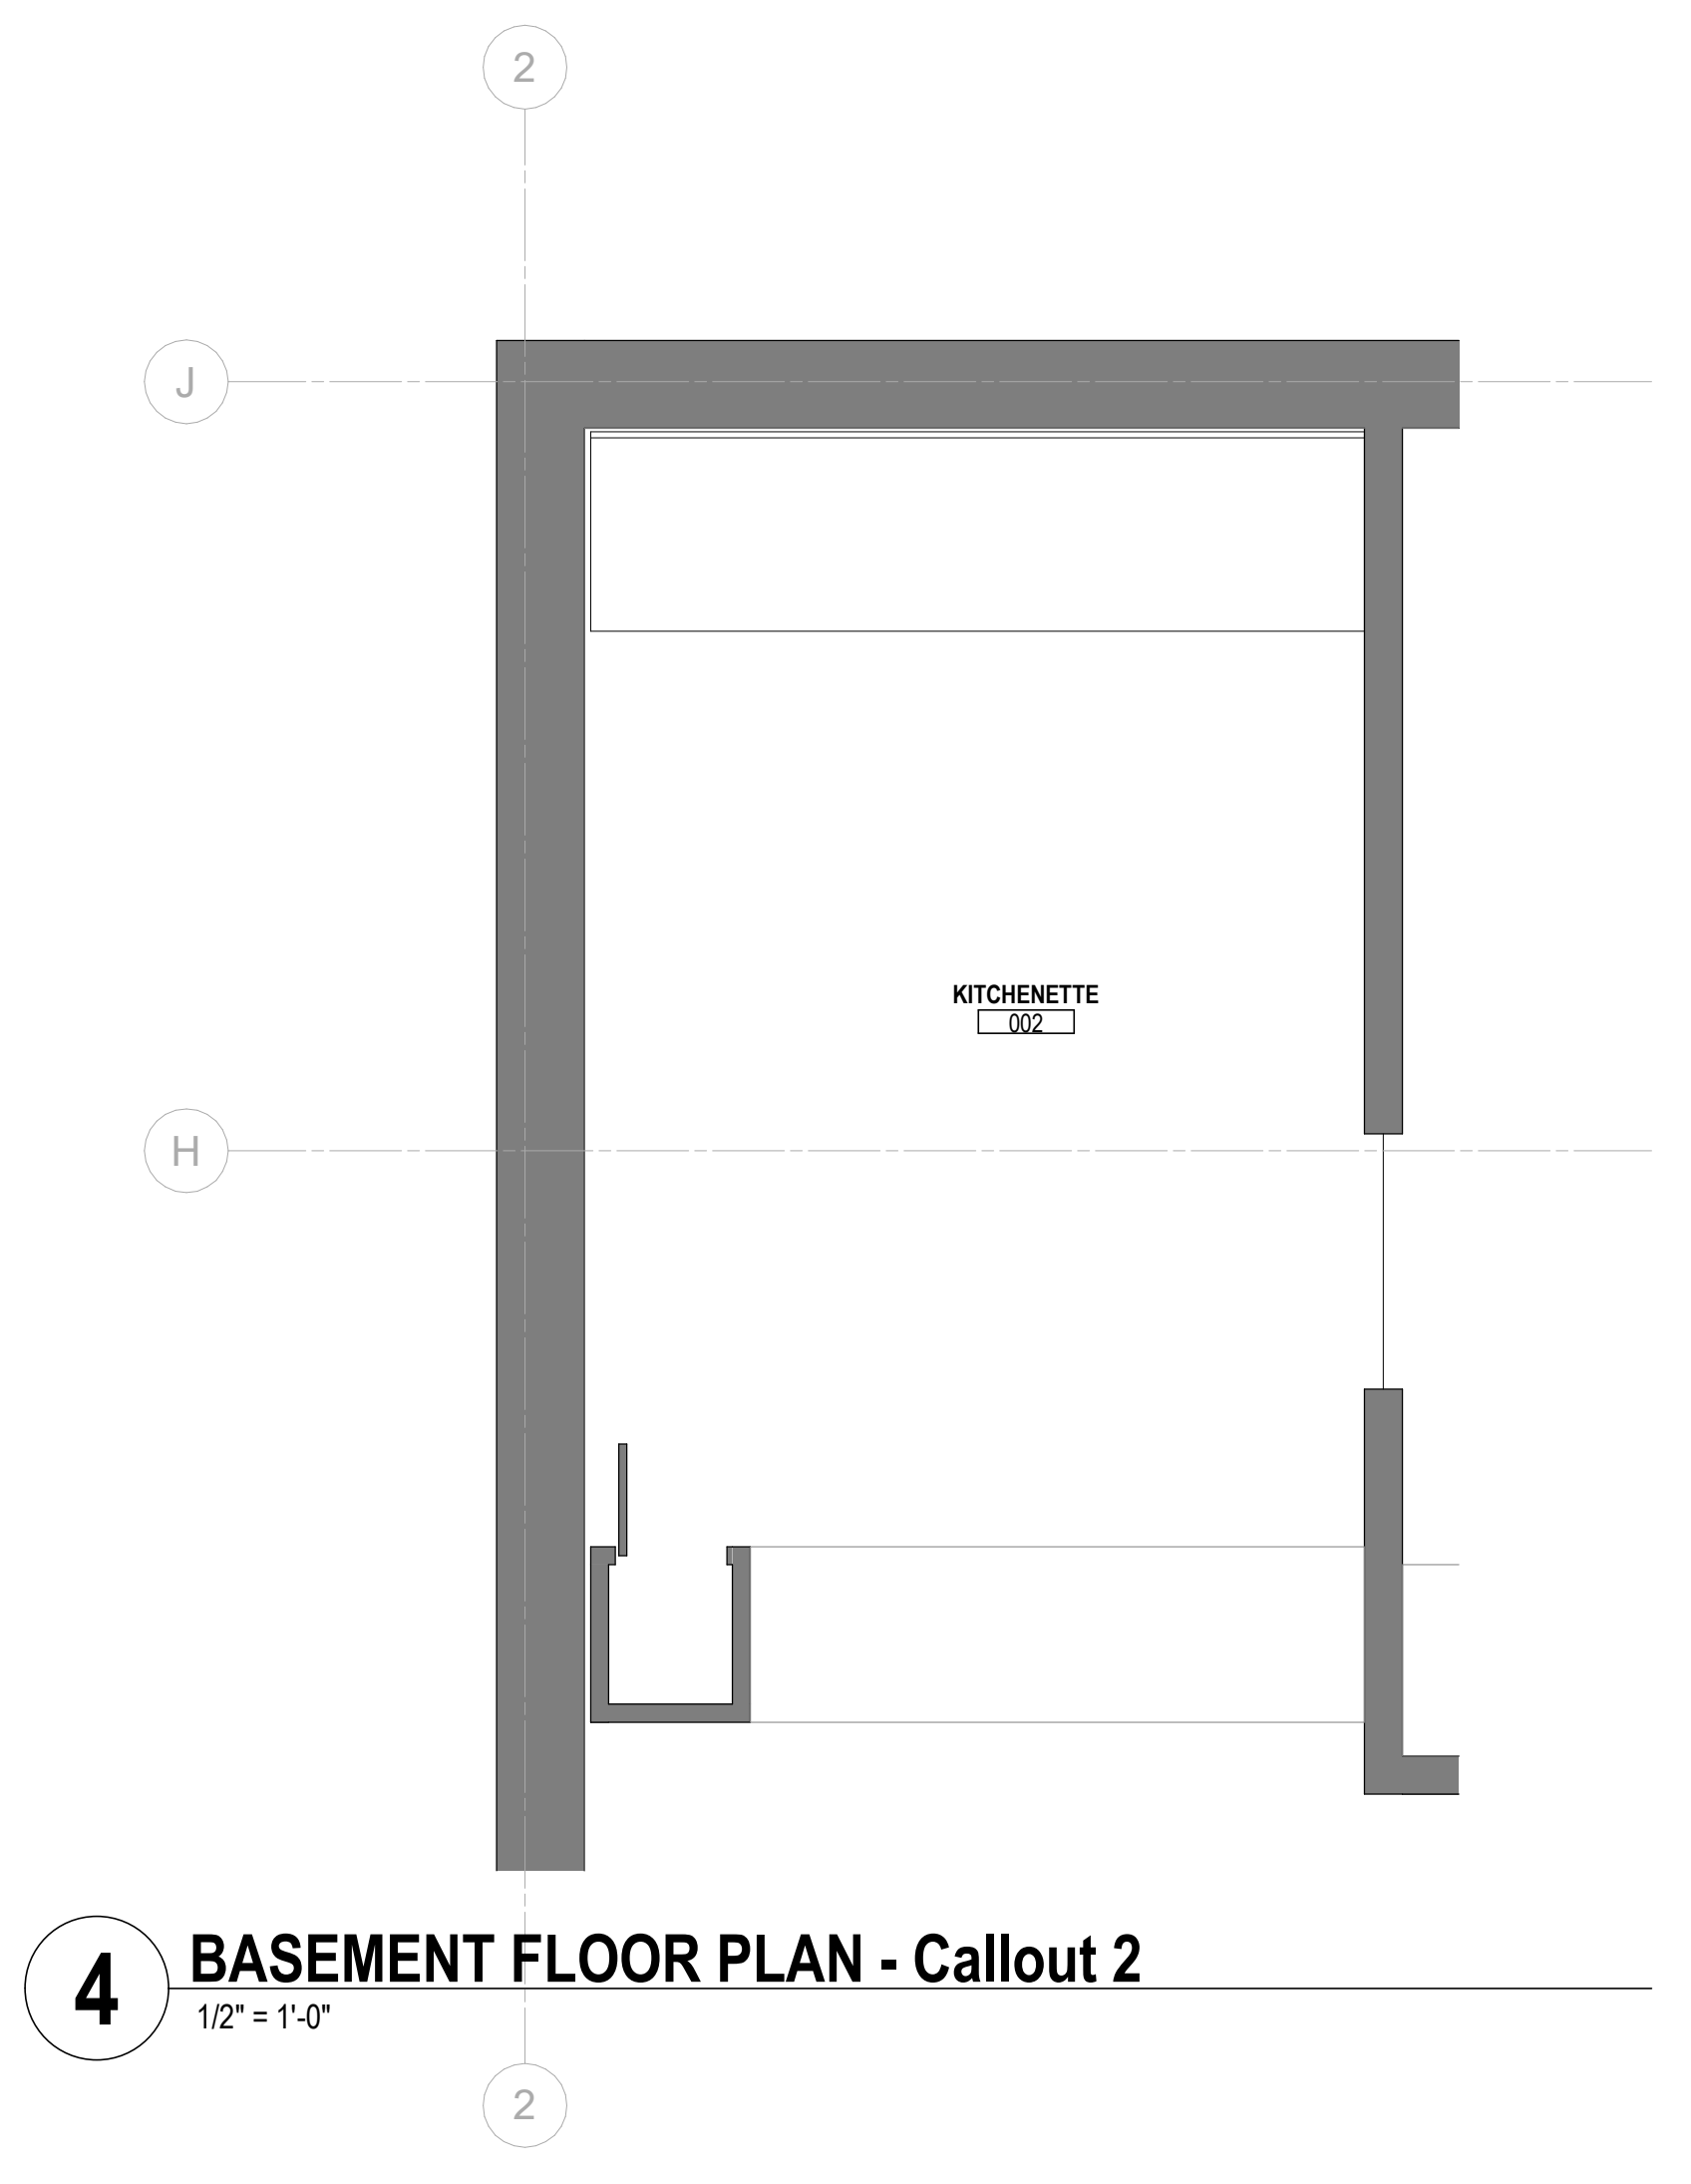


4 BASEMENT FLOOR PLAN - Callout 2
1/2" = 1'-0"

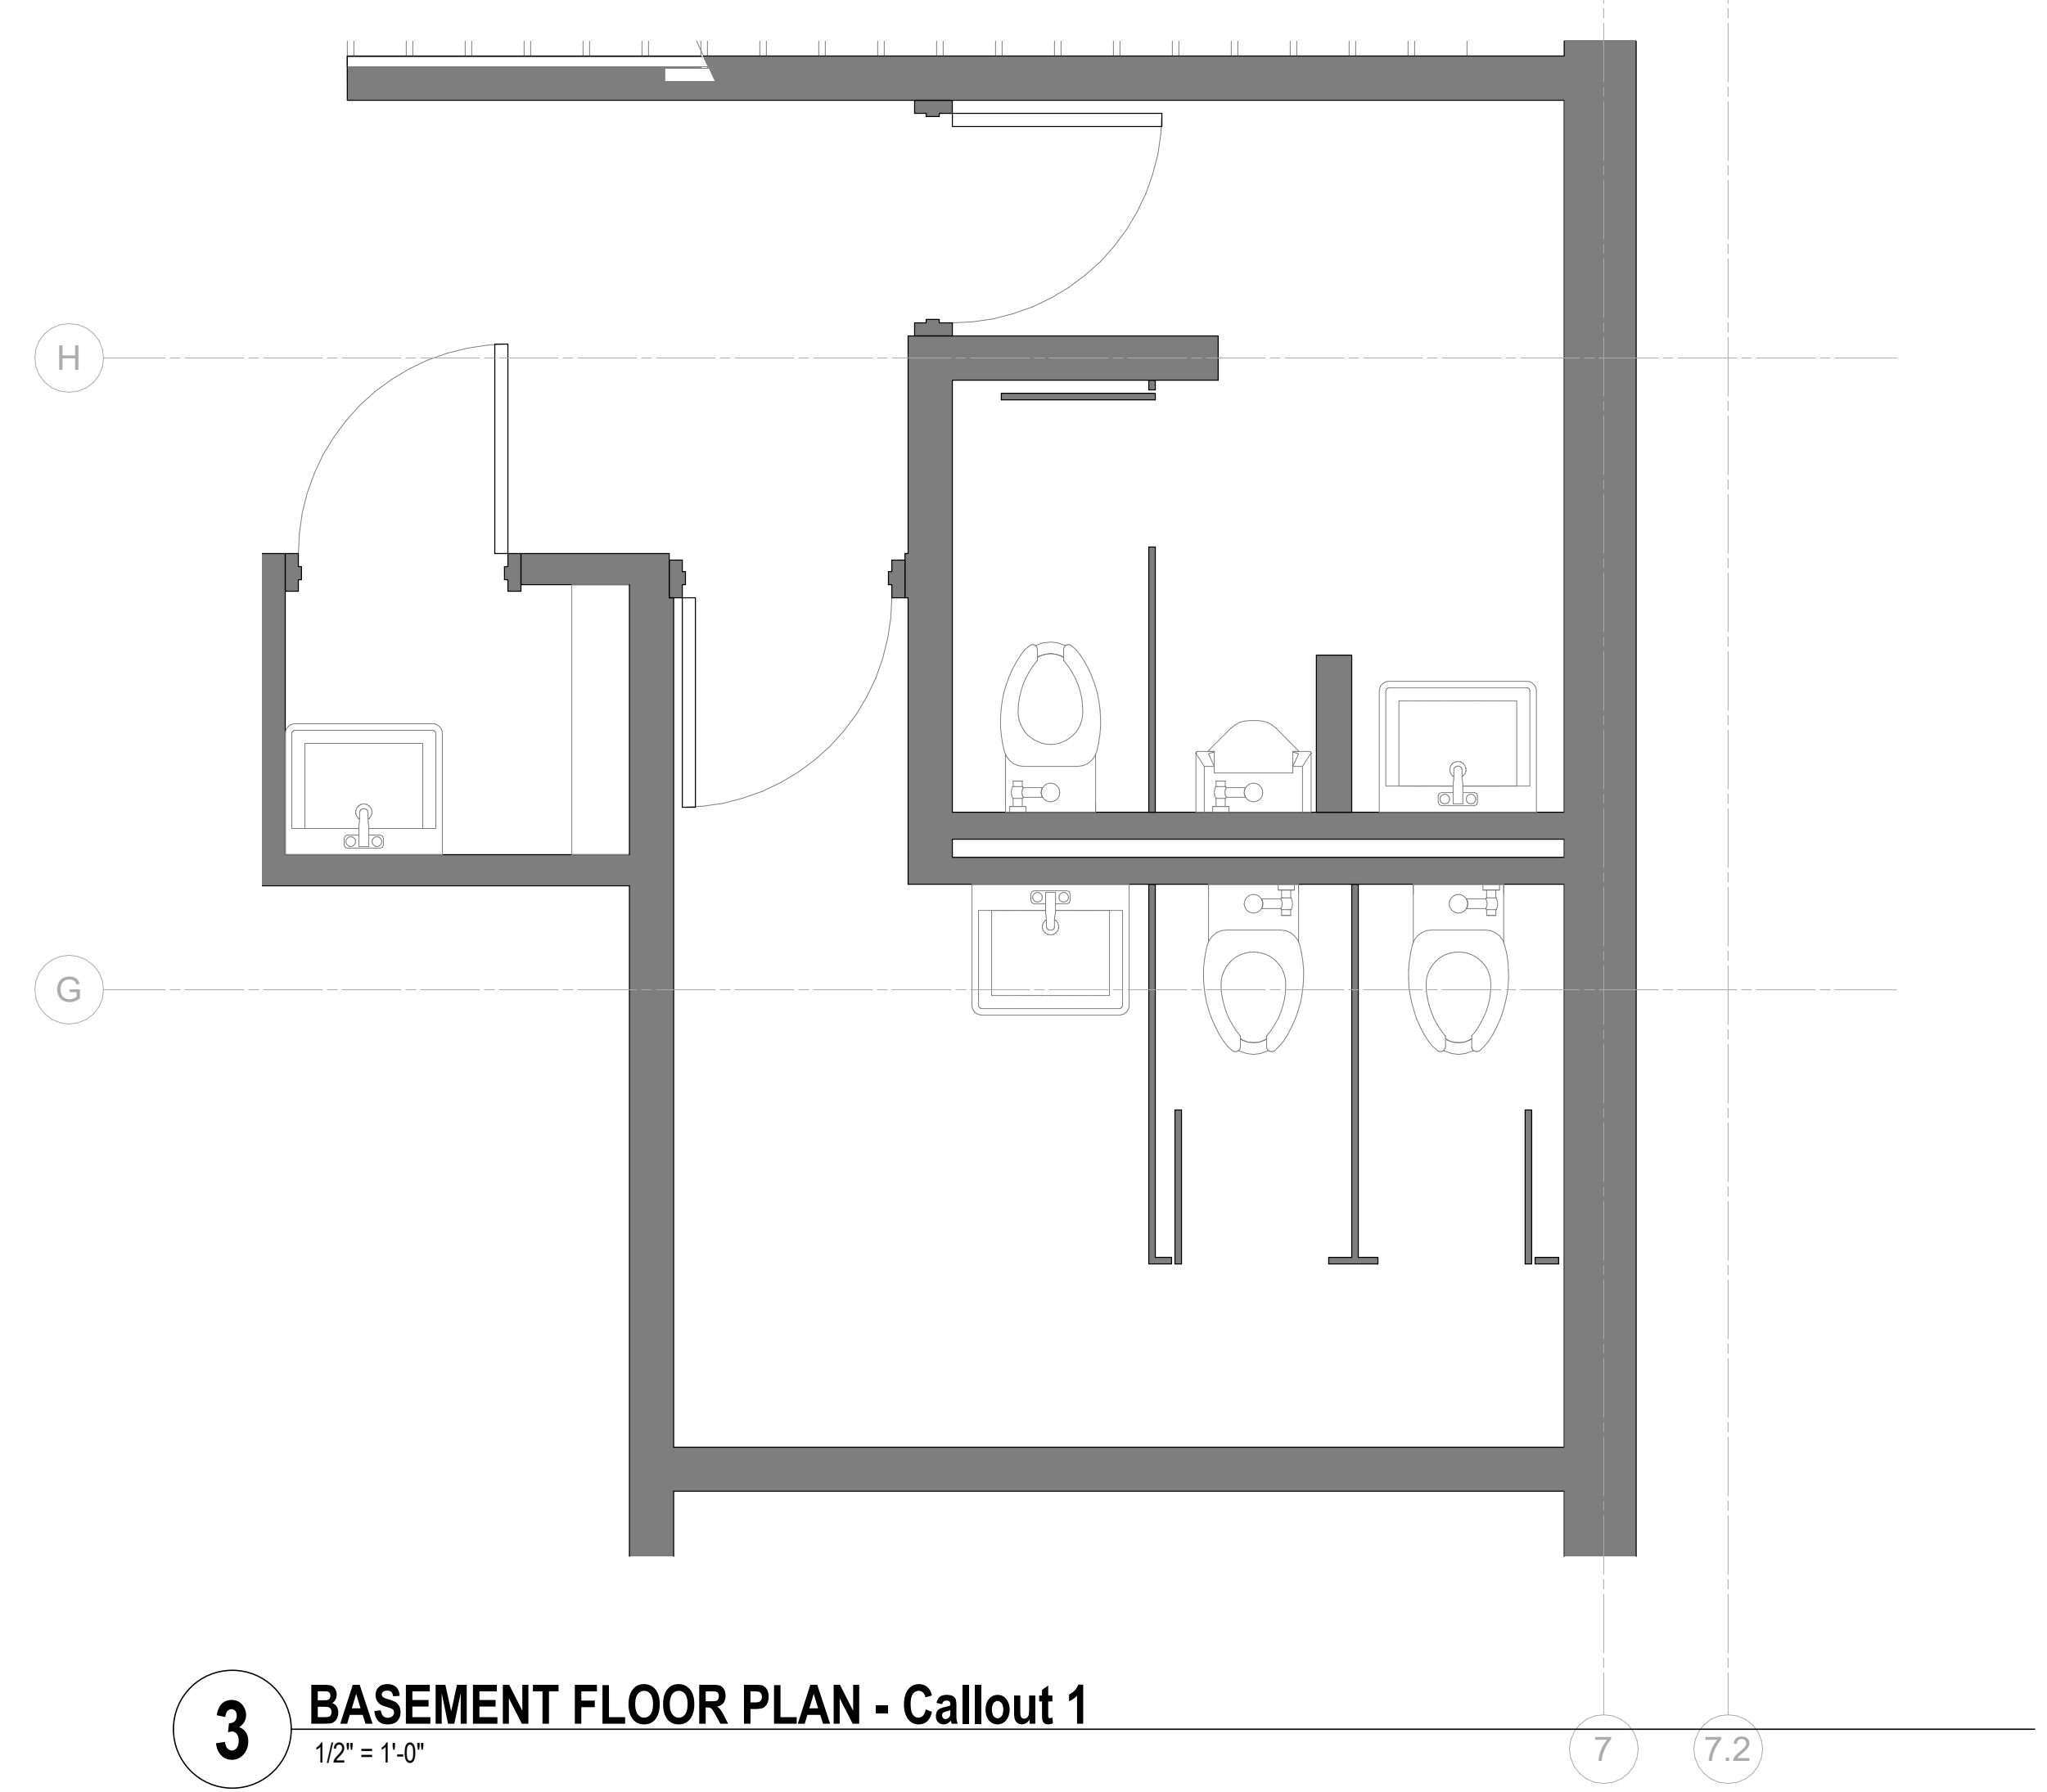

3 BASEMENT FLOOR PLAN - Callout 1
1/2" = 1'-0"

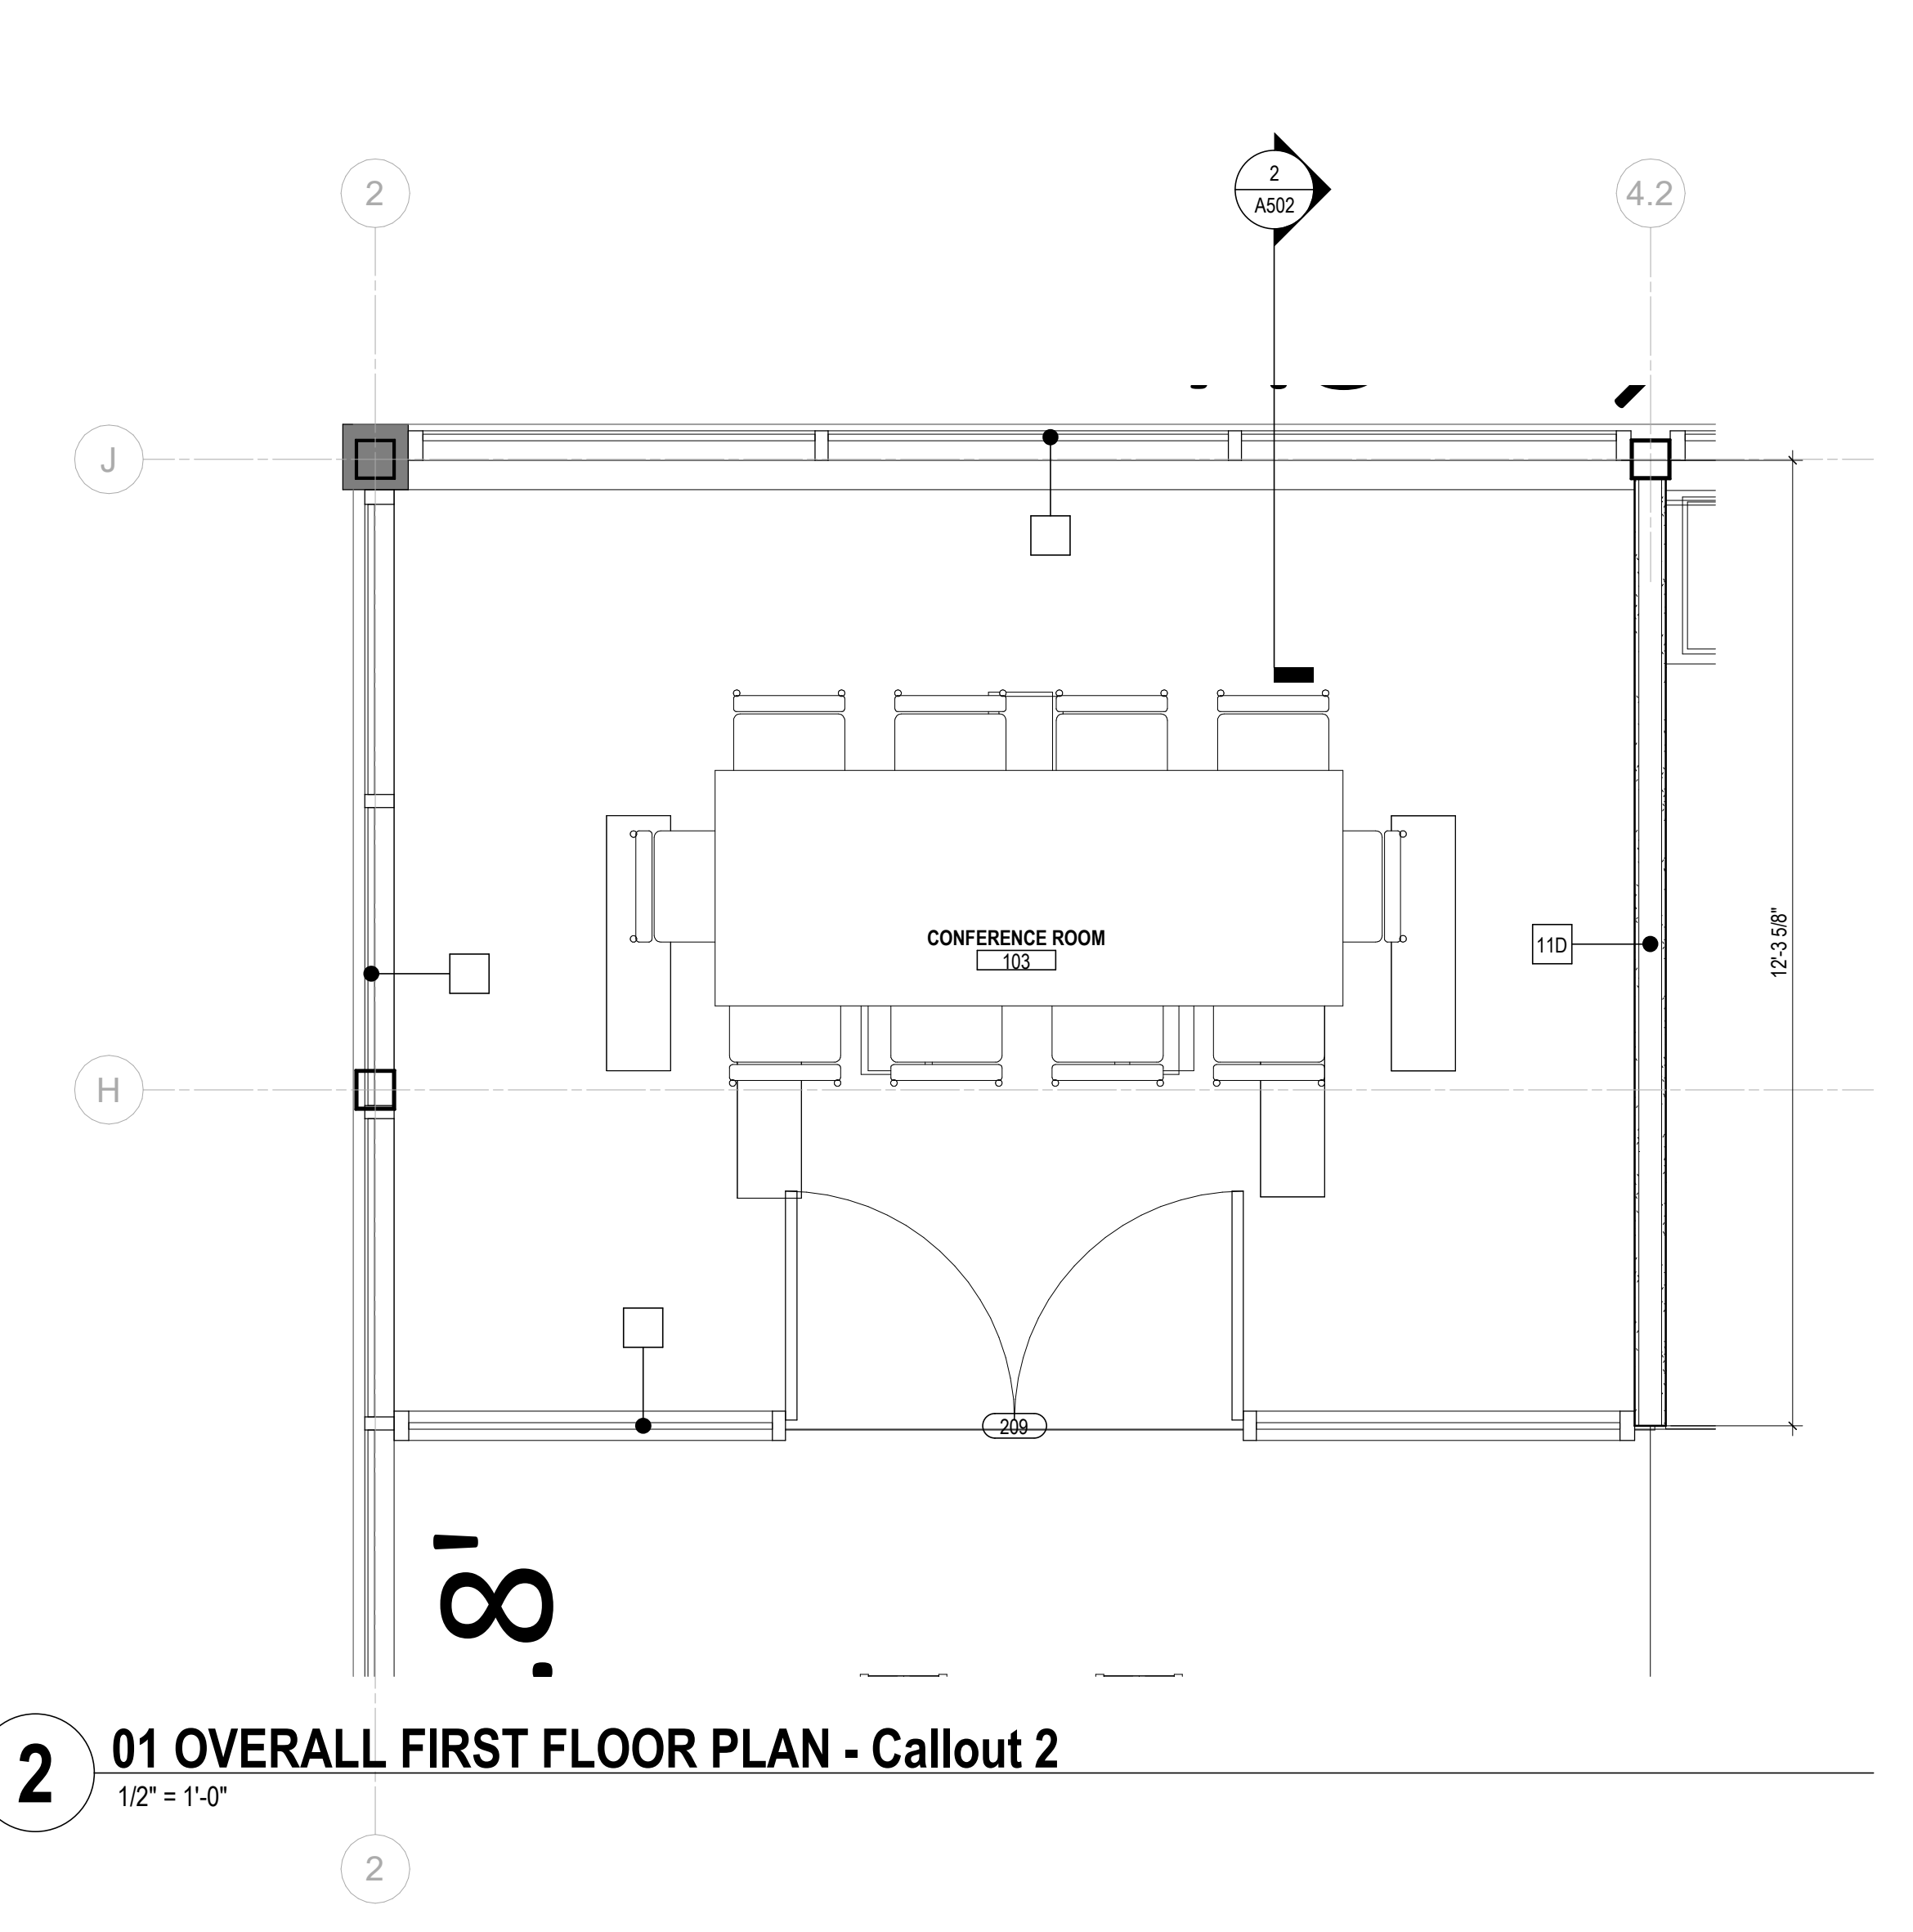

2 01 OVERALL FIRST FLOOR PLAN - Callout 2
1/2" = 1'-0"

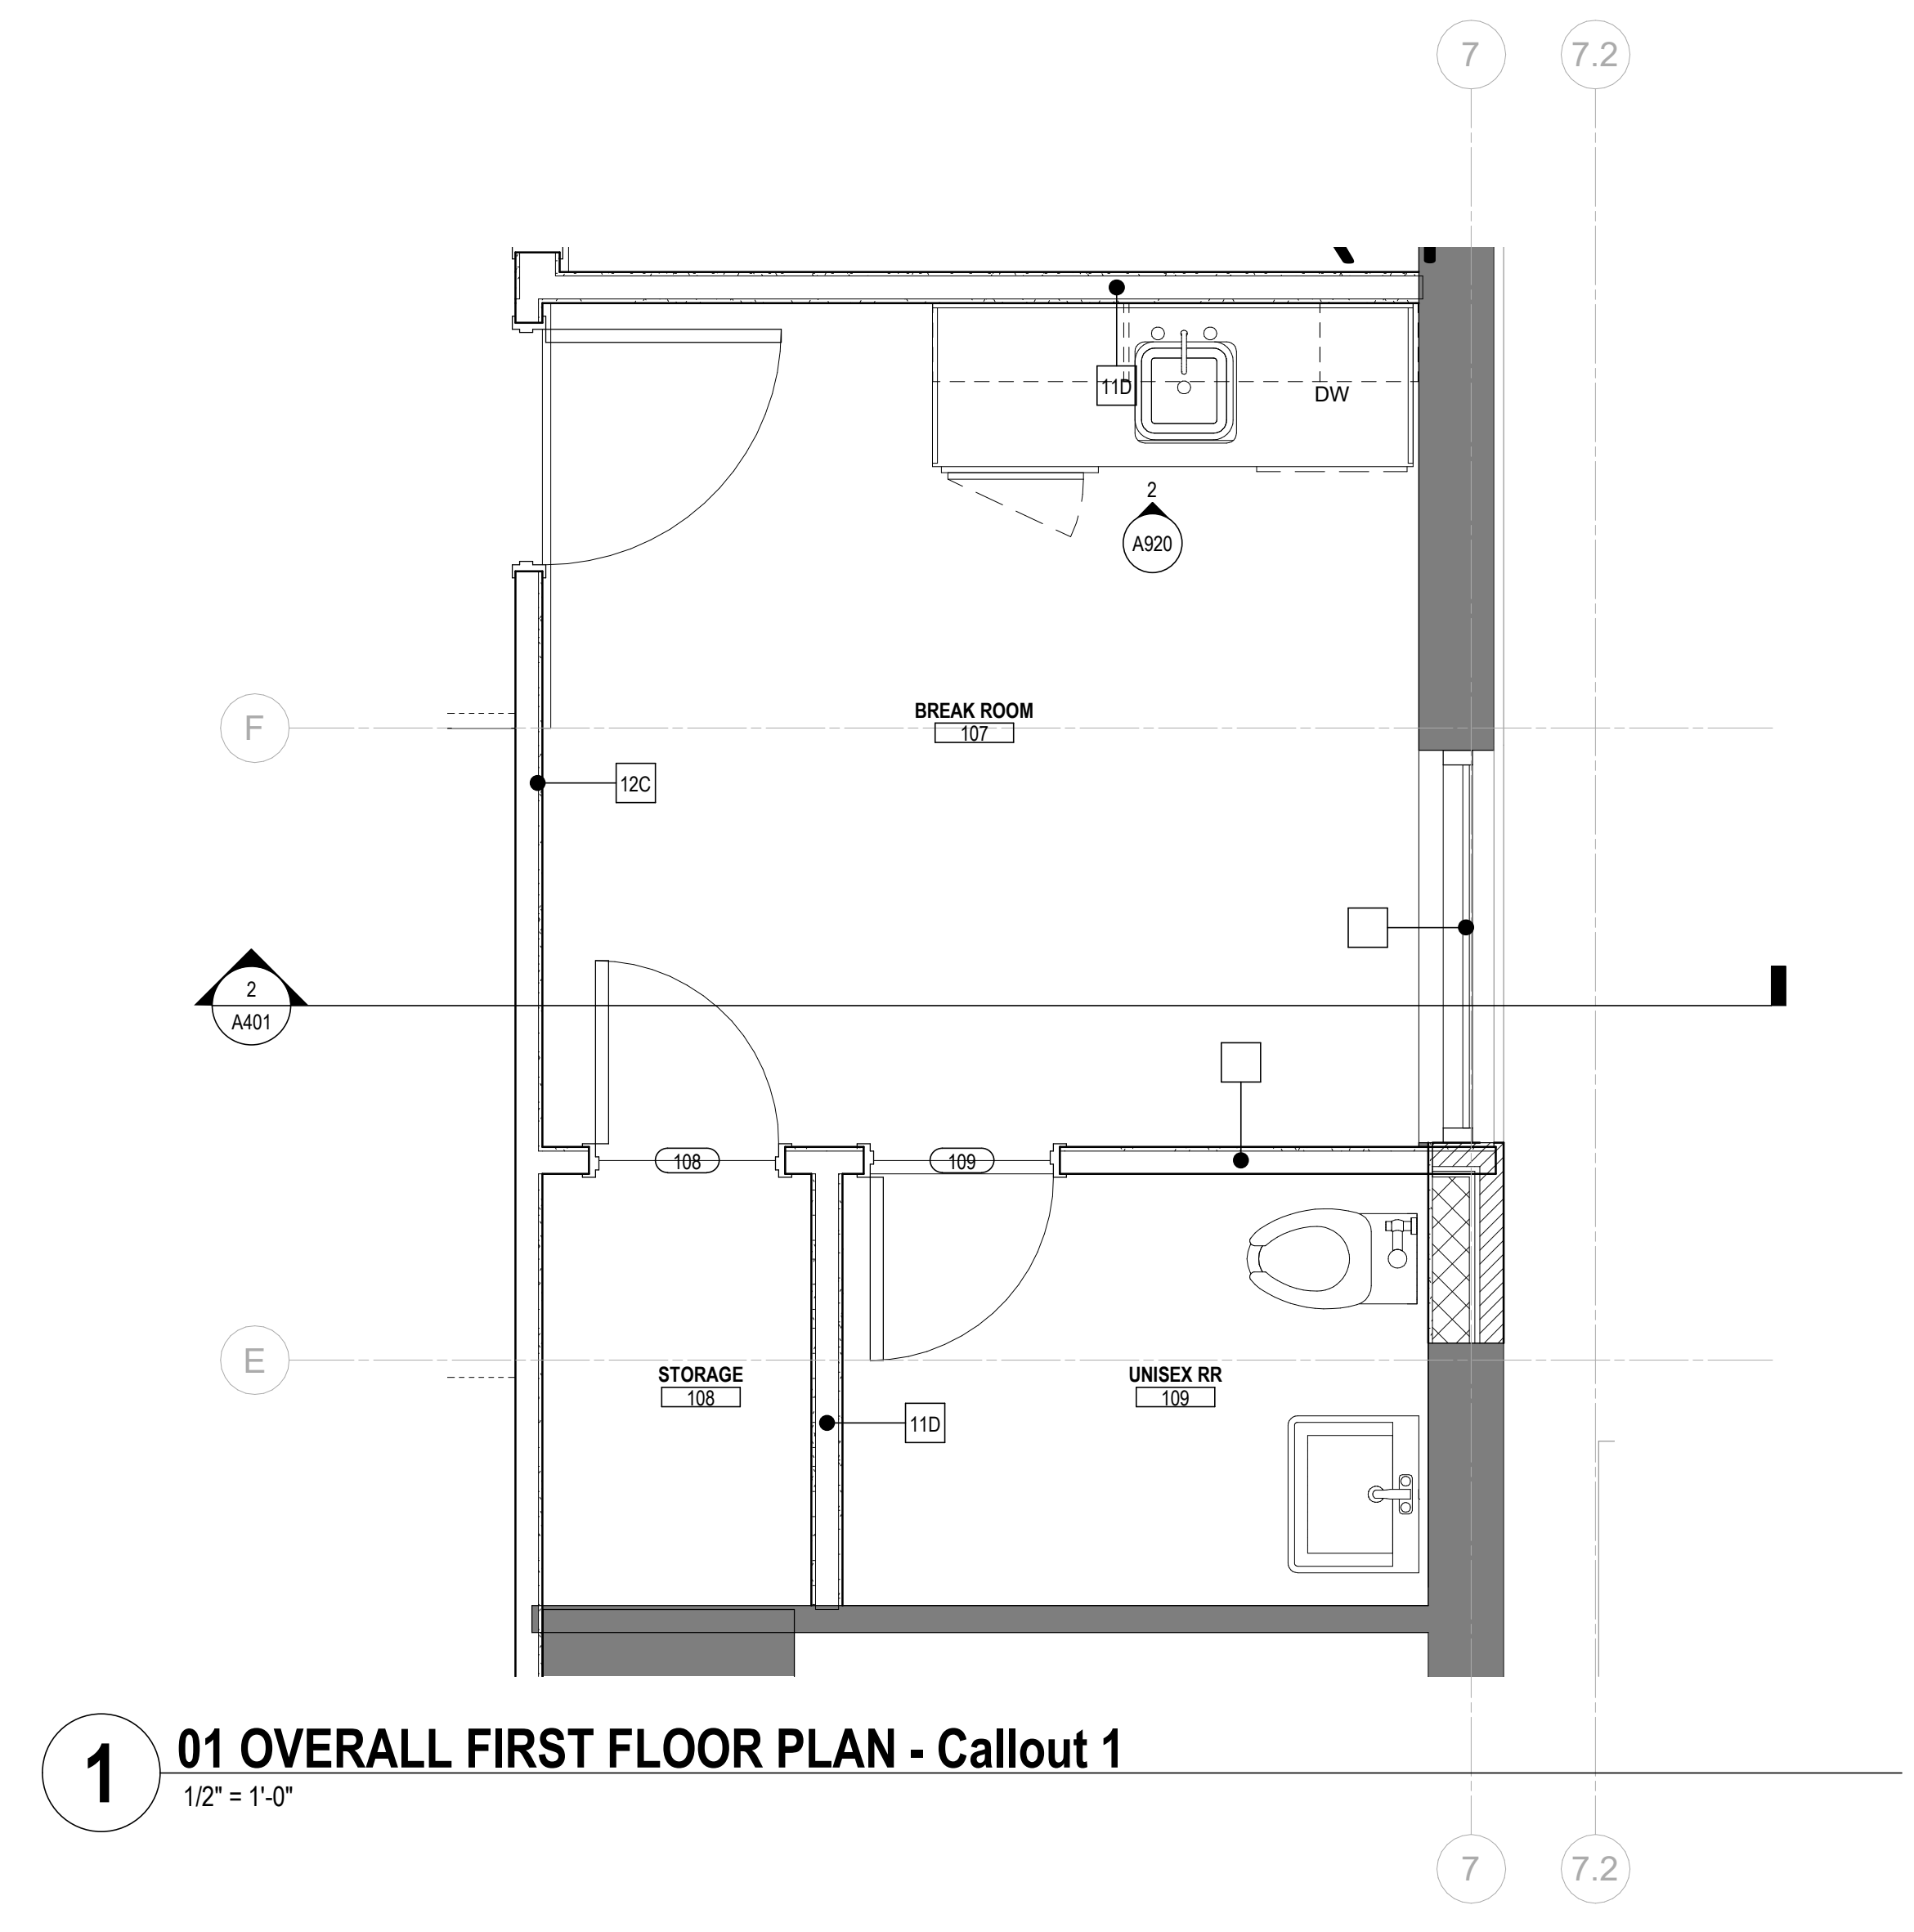

1 01 OVERALL FIRST FLOOR PLAN - Callout 1
1/2" = 1'-0"

GENERAL NOTES - ENLARGED PLANS

1. X

KEYNOTE LEGEND

KEY VALUE	KEYNOTE TEXT
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#	DATE	CHANGE DESCRIPTION

RENOVATION OF HEARTLAND BANK DUBLIN
5500 FRANTZ ROAD
DUBLIN, OH 43017
FOR
HEARTLAND BANK

MOODY-NOLAN
300 SPRUCE STREET
SUITE 300
COLUMBUS, OHIO 43215
PHONE: (614) 461-4664
FAX: (614) 280-8881

ENLARGED PLANS

PROGRESS DRAWING NOT FOR CONSTRUCTION	09/10/2020
	DRAWN BY: XXXX CHECKED BY: XXXX
	20022
A810	
PRELIMINARY DEVELOPMENT PLAN	

FINISH LEGEND

FLOORS

SC-1 SEALED CONCRETE 1 - SEE SPECS

Luxury Vinyl Tile
LVT-1 MOHAWK - LINEATE GRAY

Porcelain Tile Floor (PTF)

PTF-1: CAESAR ONE CEMENT 30X30 MATTE RECTIFIED USE GT-
PTF-2: CAESAR ONE CEMENT 12X24 MATTE RECTIFIED USE GT

Carpet (CR) *INSTALL 1/3 OFFSET ASHLAR

CR-1: INTERFACE - HUMAN NATURE COLLECTION - HN850 NICKEL
CR-2: INTERFACE - HUMAN NATURE COLLECTION - HN 810 NICKEL
CR-3: INTERFACE - HUMAN NATURE COLLECTION - CLEMENTINE
CR-4: INTERFACE - HUMAN NATURE COLLECTION - COBALT
CR-5: INTERFACE ABOVE BOARD COLOR: BIRCH

WALKOFF CARPET (WO)

WO-1: SHAW CONTRACT GROUP - STEPPIN OUT - BONJOUR II - COLOR: 31957

BASE

Rubber Base (RB) *RB-1 ON ALL ROOMS U.N.O.

RB-1: TARKETT - 3" MILLWORK OBLIQUE PROFILE BASE - STRAIGHT - COLOR: MOONROCK

Porcelain Tile Base (PTB)

PTB-1 TO MATCH PTF-1

WALLS

Reclaimed Wood Wall and Ceiling - (WD)

WD-1: OLDE WOOD - DISTRESSED COLLECTION - ANTIQUE BARN SIDING - CREME

Ceramic Wall Tile (CT)

CT-1: COLOR BY NUMBER - 3X6 WHITE - GT-2
CT-2: DALTILE RETRO ROUNDS MOSAIC COBALT BLUE USE GT-3
CT-3: DALTILE - SEASON WOOD - COLORBODY PORCELAIN 12X48 - COLOR: SNOW PINE (INSTALL 1/3 OFFSET RUNNING BOND) USE GT-1

*ALL TILE WALLS TO BE FULL HEIGHT FLOOR TO CEILING, U.N.O.

Paint (PT)

* PAINT ALL WALLS PT-1 U.N.O.
PT-1: BENJAMIN MORE: SUPER WHITE PM-1
PT-2: SHERWIN WILLIAMS: LAZY GRAY SW624
PT-3: BENJAMIN MORE: CHELSEA GRAY

Vinyl Wallcovering (WC)

WC-1: DL DODCH- STACY GARCIA HIGHLIGHTS COLOR: COBALT
WC-2: MINARMI - HITOH COLOR: MIMOSA

MISCELLANEOUS

Plastic Laminate (PL) *INSTALL PATETRN VERTICAL U.N.O.

PL-1: WILSONART: ASIAN NIGHT
PL-2: WILSONART SHADOW ZEPHYR MATTE FINISH

Solid Surface (SS)

SS-1: CORIAN: GLACIER WHITE
SS-2: SILESTONE COLOR: WHITE STORM

Grout (GT) *USE GT-1 U.N.O.

GT-1: BOSTIK - COLOR: BUFF H188
GT-2: BOSTIK - COLOR: CHAR BLACK H139
GT-3: BOSTIK BRIGHT WHITE H177

Floor Transition Strip

Schuler/SCHIERE - METAL TRANSITION STRIP BETWEEN PORCELAIN TILE AND CARPET.

Corner Guards (CG)

USE STAINLESS STEEL CORNER GUARDS, 8" HIGH PLACED ABOVE WALL BASE.

USE FRY REGLET WALL COVERING CORNER GUARD TRIM @ WALLCOVERING EXTERNAL CORNERS, FULL HEIGHT OF WALL

GENERAL NOTES - FINISH PLANS

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- PAINTED HOLLOW METAL DOORS AND FRAMES TO BE PAINTED TO MATCH ADJACENT WALL COLOR UNLESS NOTED OTHERWISE. MATERIAL FINISH AND COLOR INFORMATION FOR ALL OTHER DOORS AND FRAMES IS CONTAINED IN THE DOOR SCHEDULE AND ITS ASSOCIATED LEGENDS. IF WALLS ON OPPOSITE SIDES OF DOOR FRAME ARE DIFFERENT COLORS THE PAINT COLORS SHOULD BE SPLIT AT THE JAMB OF THE FRAME.
- ALL VERTICAL TRANSITIONS BETWEEN DIFFERING WALL FINISHES ARE TO BE MADE AT INSIDE CORNERS (UNLESS NOTED OTHERWISE).
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- WHERE RESILIENT BASE IS SPECIFIED (VINYL OR RUBBER) PROVIDE COVE PROFILE BASE AT ALL RESILIENT FLOORS AND STRAIGHT BASE FOR ALL CARPET AREAS (UNLESS OTHERWISE NOTED), HEIGHT AND COLOR TO BE AS INDICATED ON FINISH LEGEND.
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KEYNOTE LEGEND

#	DATE	CHANGE DESCRIPTION

RENOVATION OF HEARTLAND BANK DUBLIN
800 FRANTZ ROAD
DUBLIN, OH 43017
FOR
HEARTLAND BANK



300 SPRUCE STREET
SUITE 300
COLUMBUS, OHIO 43215
PHONE: (614) 461-4664
FAX: (614) 280-8881

DRAWING TITLE:


FINISH LEGEND

PROGRESS DRAWING NOT FOR CONSTRUCTION	09/10/2020	
	DRAWN BY: xxx	CHECKED BY: xxx
	2022	
A900		
PRELIMINARY DEVELOPMENT PLAN		

2 BASEMENT - FINISH PLAN
 1/4" = 1'-0"

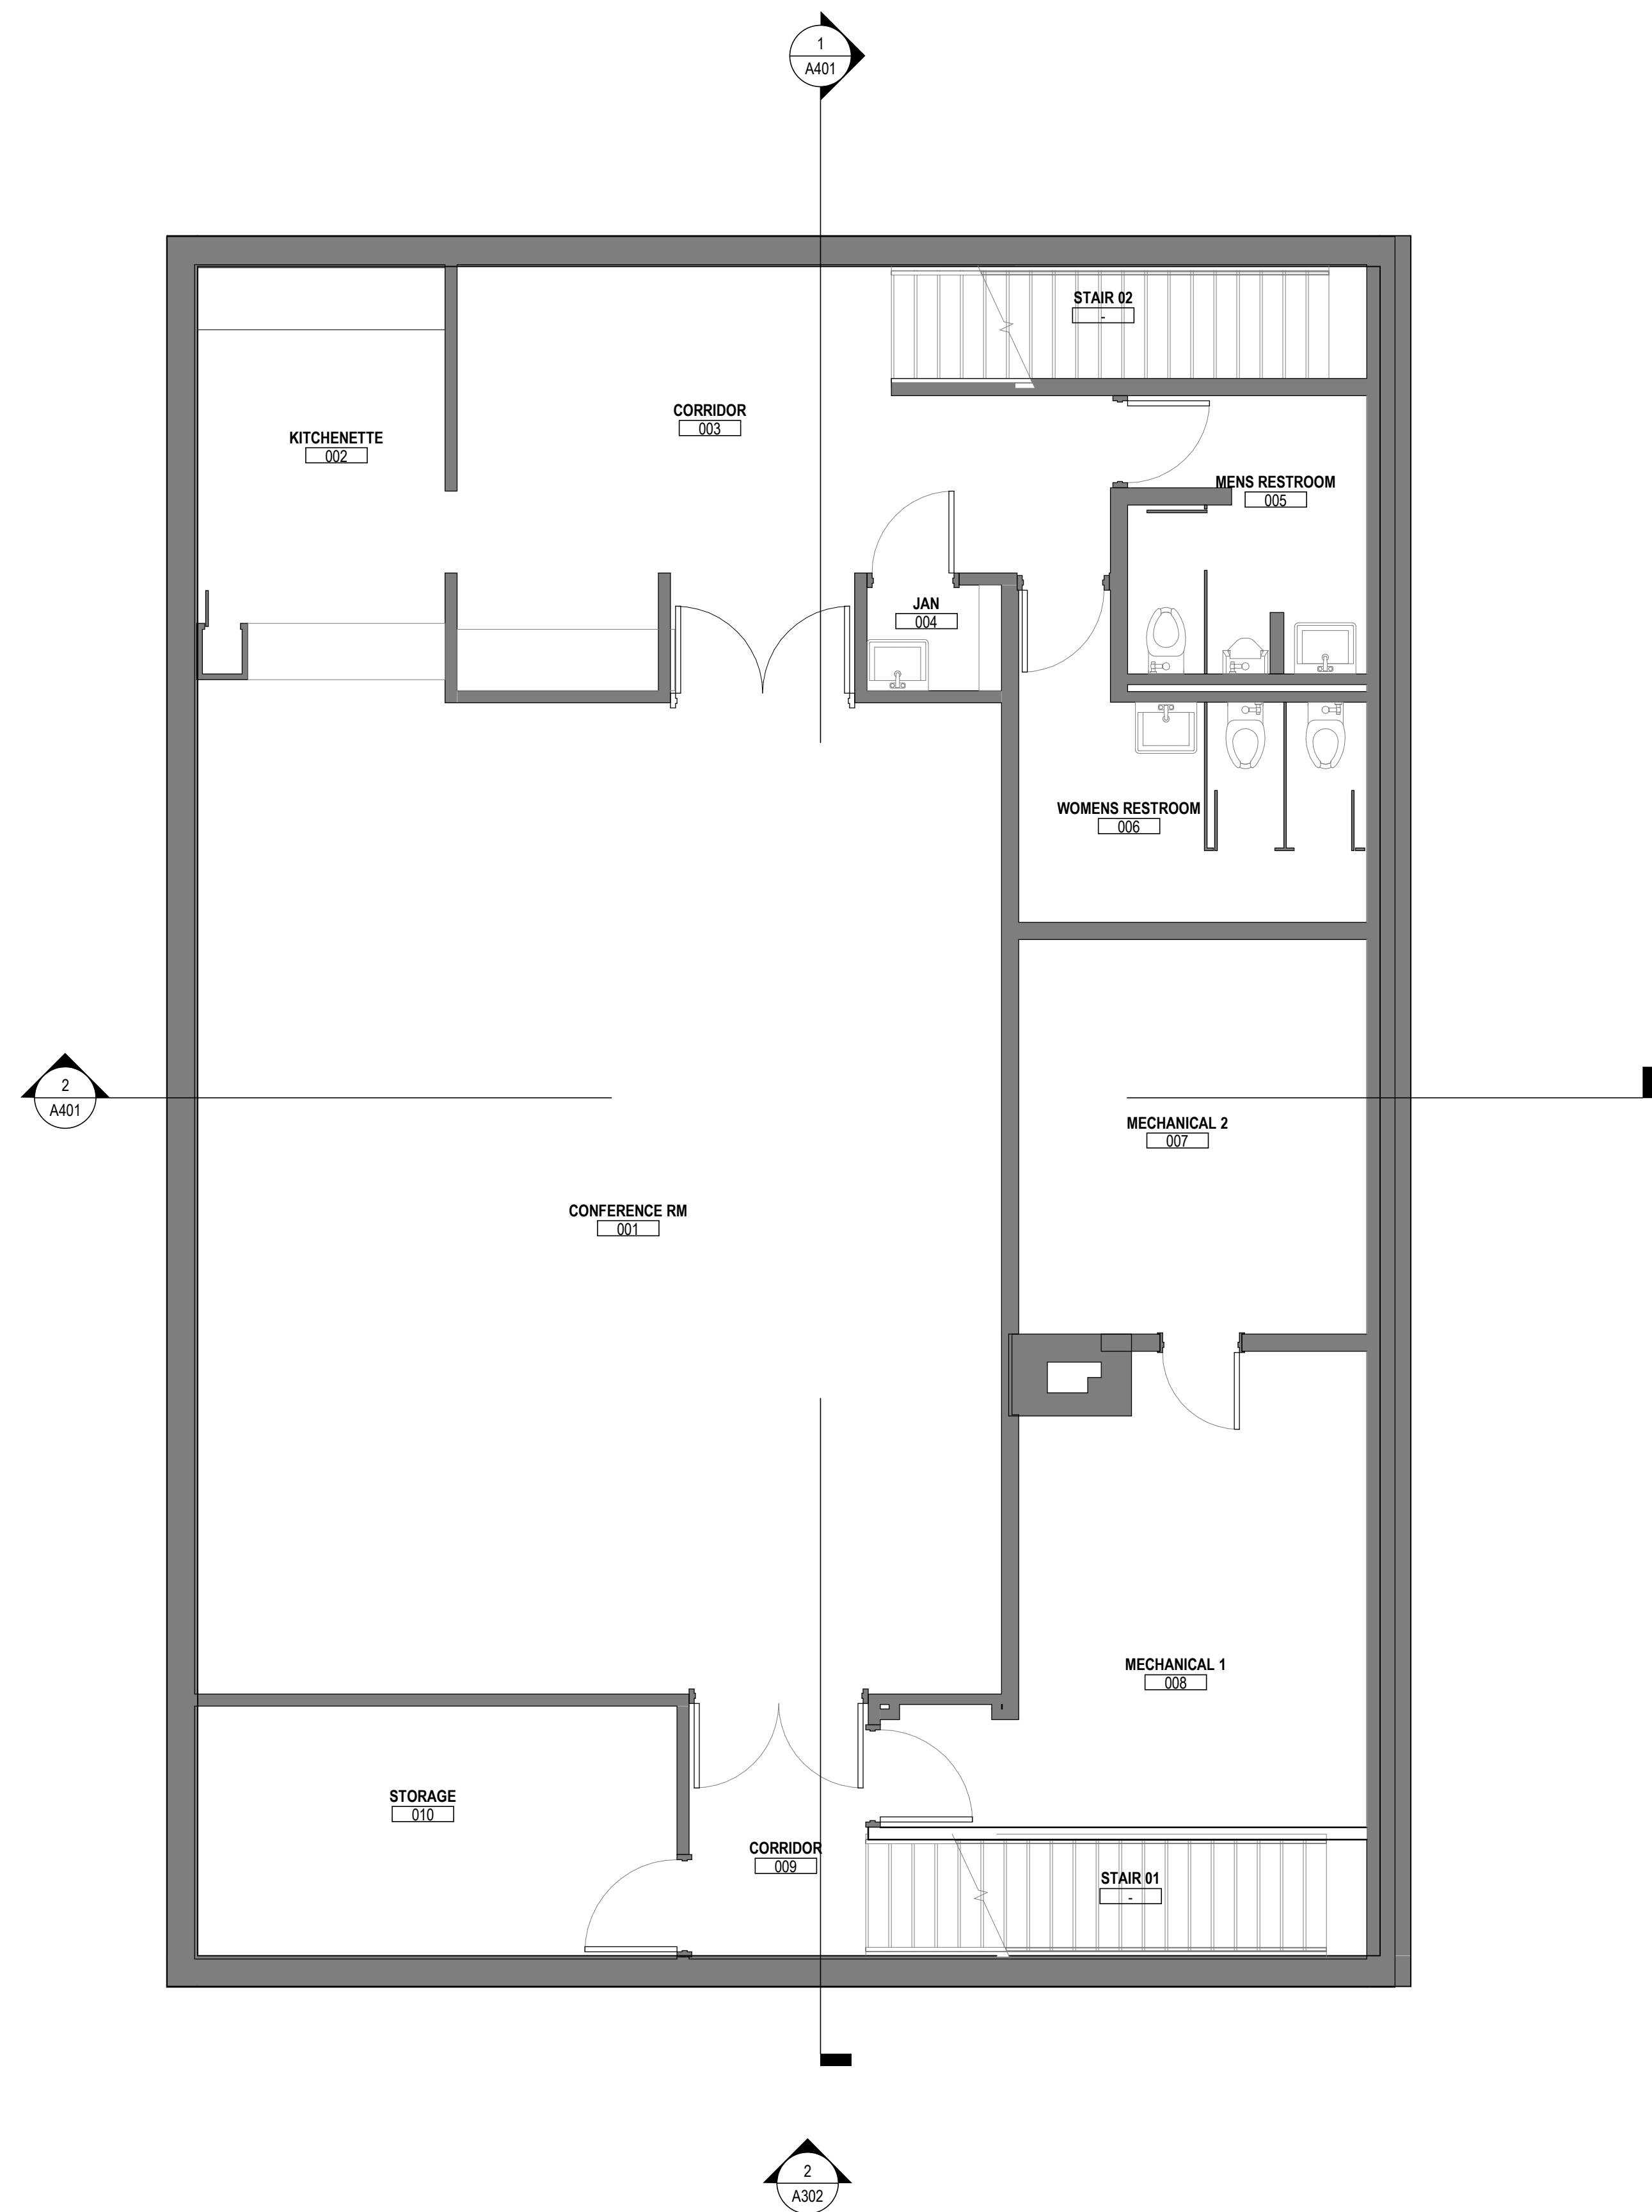

1 FIRST FLOOR - FINISH PLAN
 1/4" = 1'-0"

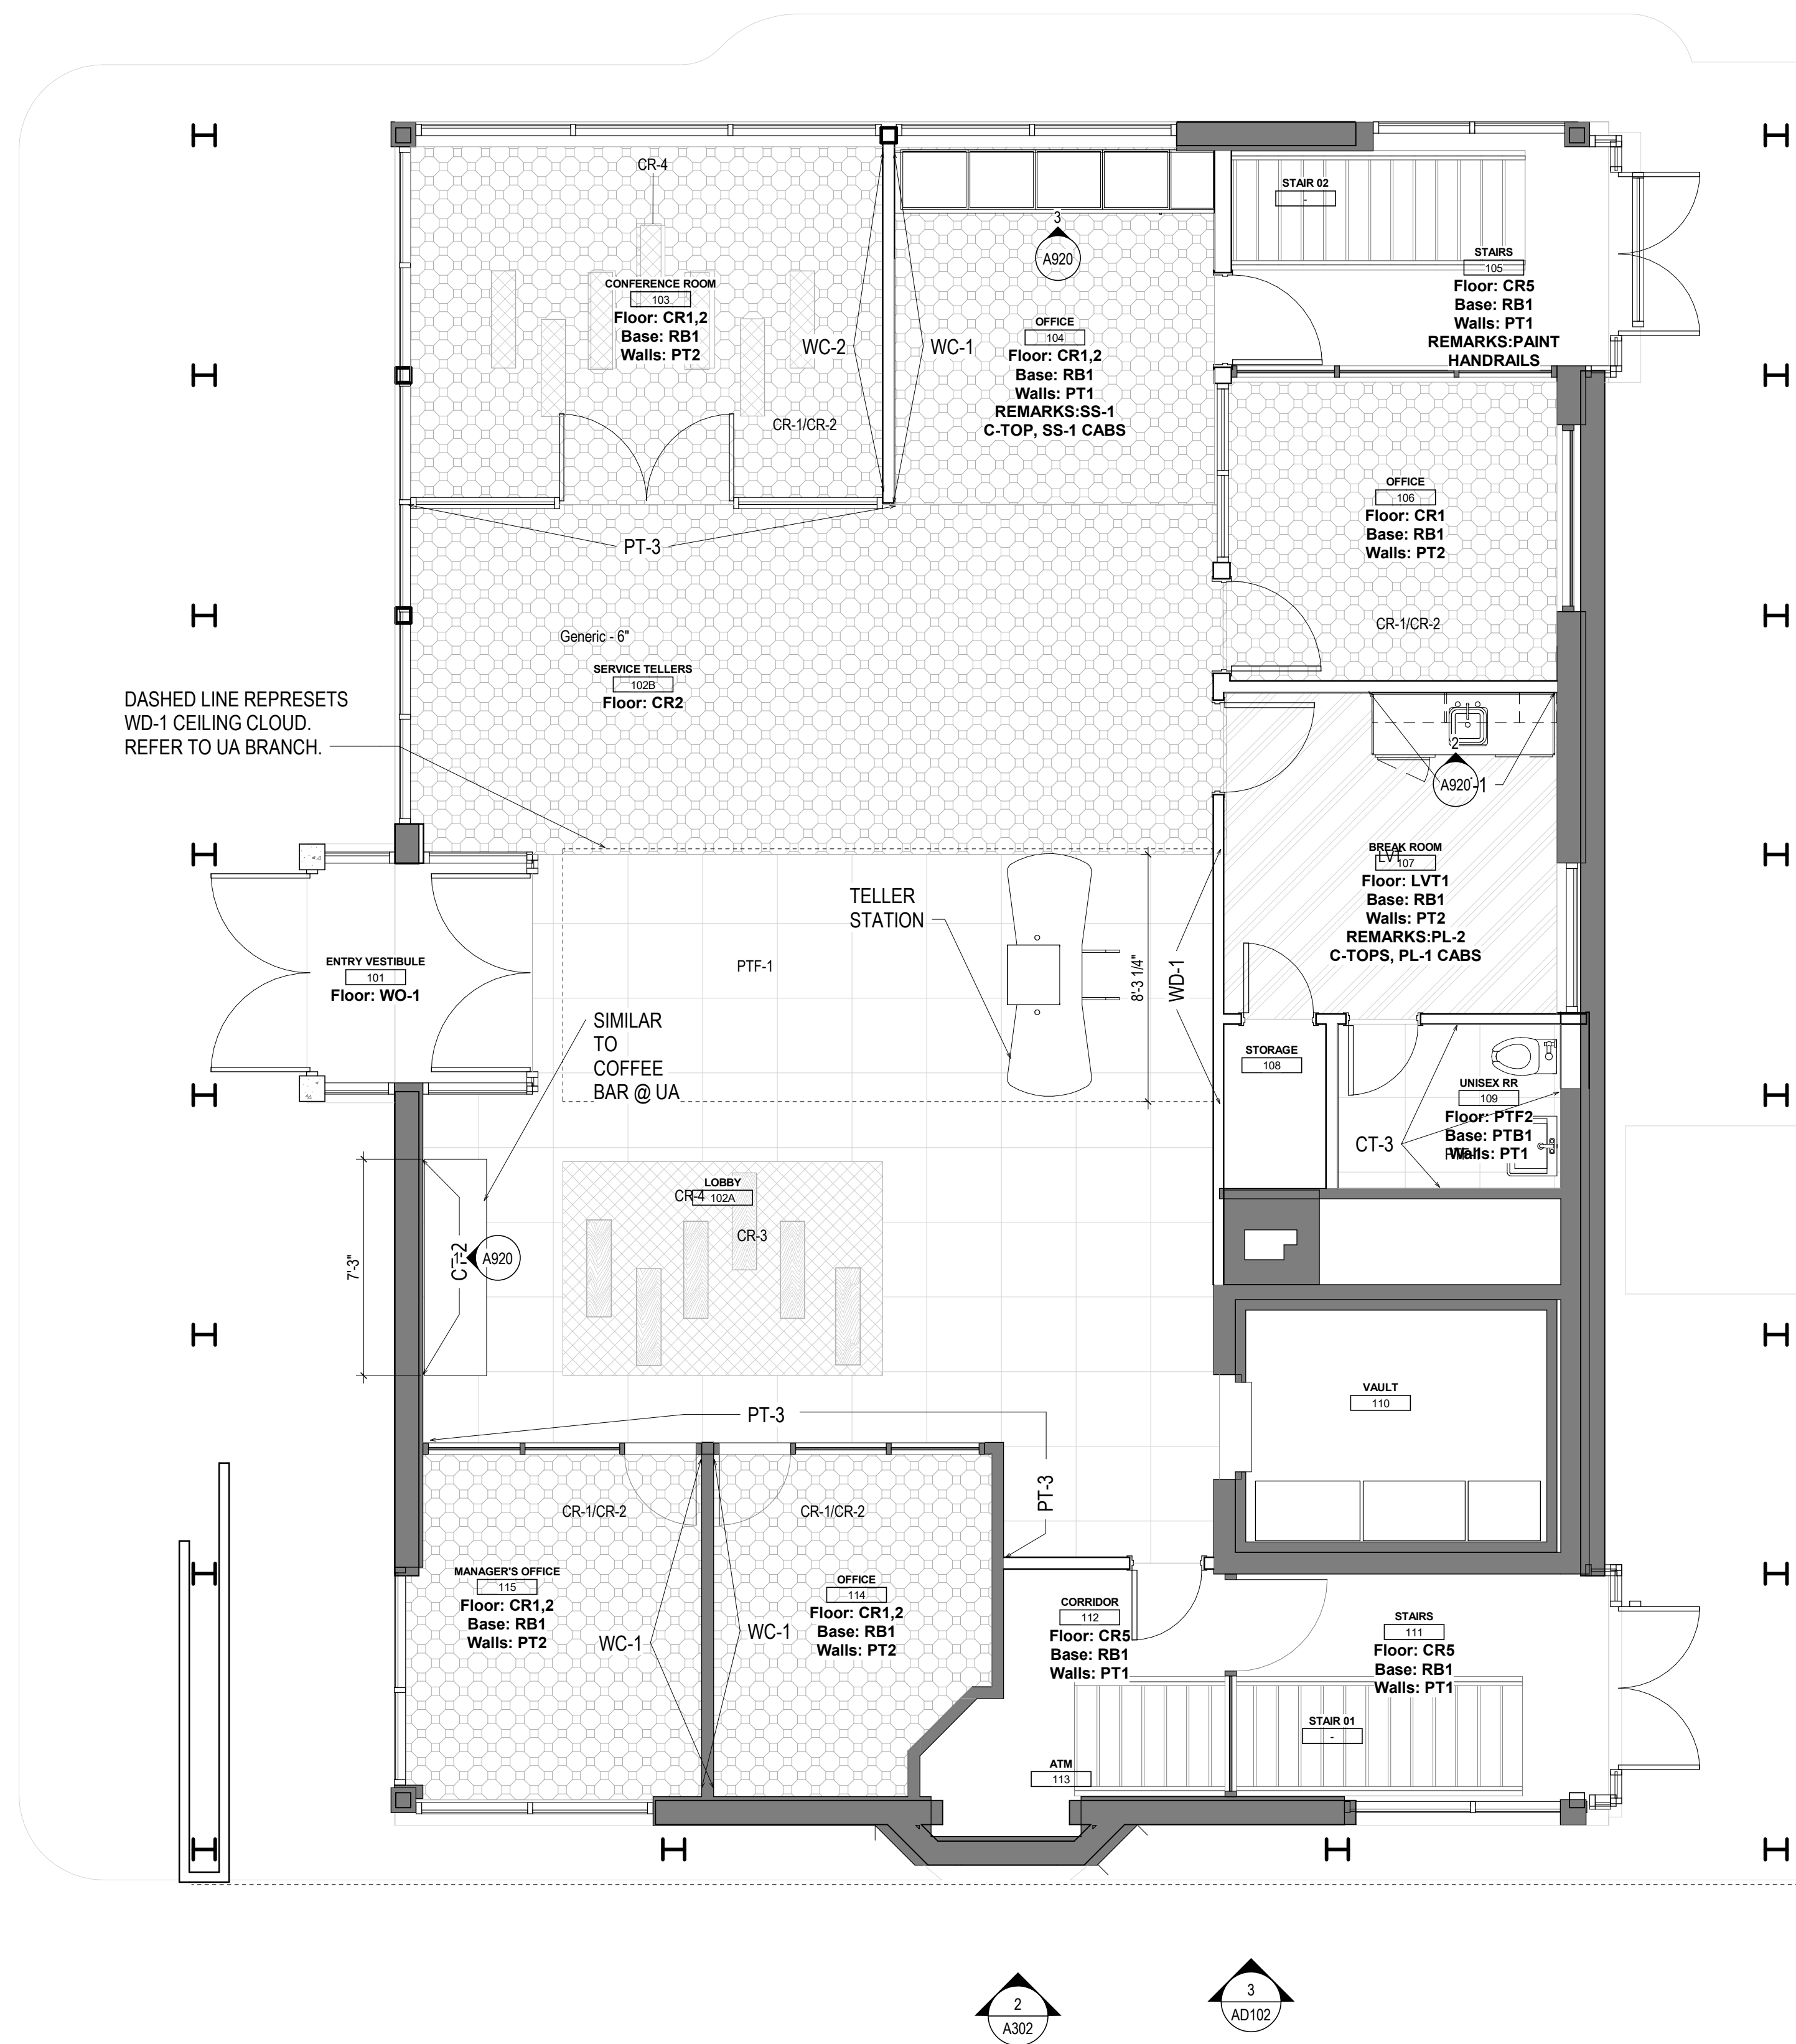

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KEYNOTE LEGEND

#	DATE	CHANGE DESCRIPTION


RENOVATION OF HEARTLAND BANK DUBLIN
 5000 PRANTZ ROAD
 DUBLIN, OH 43017
 FOR
HEARTLAND BANK

MOODY-NOLAN
 300 SPRUCE STREET
 SUITE 300
 COLUMBUS, OHIO 43215
 PHONE: (614) 461-4664
 FAX: (614) 280-8881


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FIRST FLOOR FINISH PLAN


PROGRESS DRAWING NOT FOR CONSTRUCTION	09/10/2020
	DRAWN BY: xxx CHECKED BY: xxx
	20022
A901	
PRELIMINARY DEVELOPMENT PLAN	

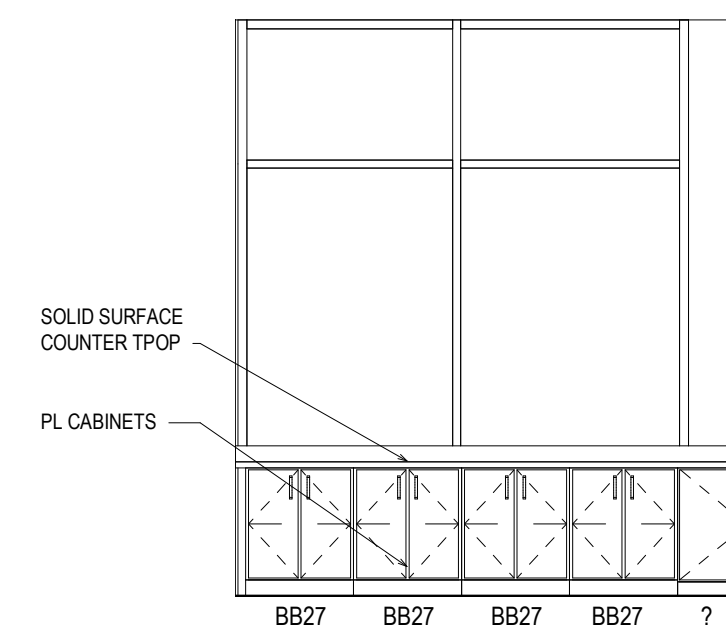

3 ELEVATION OFFICE
 1/4" = 1'-0" REF: 1 / A10

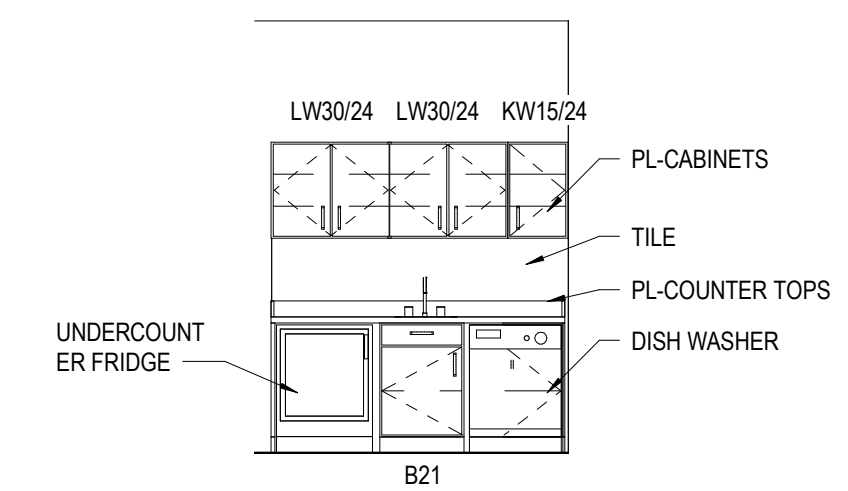

2 ELEVATION BREAKROOM
 1/4" = 1'-0" REF: 1 / A10

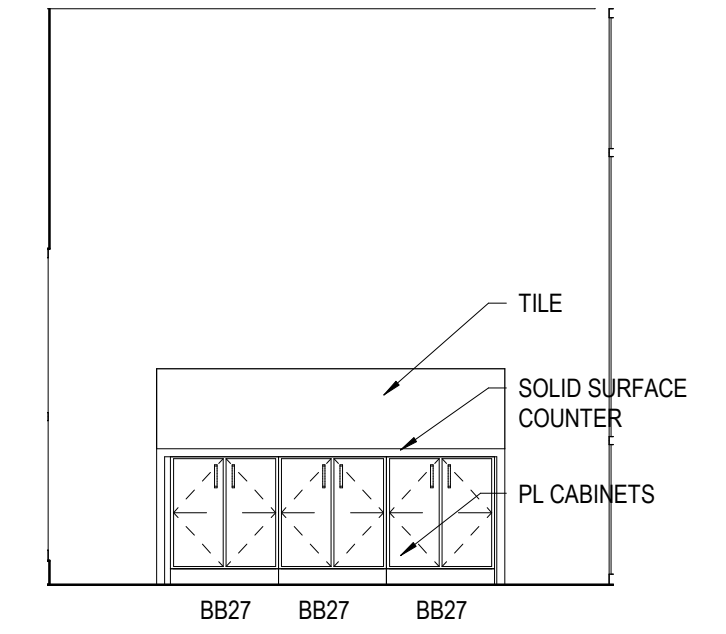

1 ELEVATION COFFEE BAR
 1/4" = 1'-0" REF: 1 / A10

#	DATE	CHANGE DESCRIPTION

RENOVATION OF HEARTLAND BANK DUBLIN
 5300 FRANTZ ROAD
 DUBLIN, OH 43017
 FOR
HEARTLAND BANK

MOODY-NOLAN
 300 SPRUCE STREET
 SUITE 300
 COLUMBUS, OHIO 43215
 PHONE: (614) 461-4664
 FAX: (614) 280-8881

DRAWING TITLE:
INTERIOR ELEVATIONS

PROGRESS DRAWING NOT FOR CONSTRUCTION	09/10/2020
	DRAWN BY: XXXX CHECKED BY: XXXX
	20022
A920	
PRELIMINARY DEVELOPMENT PLAN	

ABBREVIATIONS

NOTE: NOT ALL ABBREVIATIONS MAY BE USED.

Table with 2 columns: Abbreviation and Description. Includes items like (A) EXISTING TO BE ABANDONED, (D) EXISTING TO BE DEMOLISHED, etc.

ABBREVIATIONS

NOTE: NOT ALL ABBREVIATIONS MAY BE USED.

Table with 2 columns: Abbreviation and Description. Includes items like IN INCHES, INV EL INVERT ELEVATION, etc.


SYMBOLS LIST

Table mapping PIPING symbols to descriptions: EXISTING TO REMAIN (E), EXISTING TO BE DEMOLISHED (D), DOMESTIC HOT WATER (HW), etc.


Table mapping DESCRIPTION, 2D SYMBOL, and 3D SYMBOL (PLAN VIEW, SECTION VIEW) for various plumbing fixtures like DROP, RISE, TEE, CAP, etc.

GENERAL NOTES:

- 1. PROVIDE NEW DOMESTIC WATER, SANITARY WASTE, STORM DRAINAGE, NATURAL GAS FOR THIS BUILDING. PROVIDE ALL NECESSARY COMPONENTS FOR FULLY OPERATIONAL SYSTEM.
2. ALL FLOOR PENETRATIONS TO BE SEALED WATER TIGHT AND COMPLETELY PACKED WITH FIRE STOP MATERIAL BY TRADE CONTRACTORS.
3. THESE DRAWINGS ARE DIAGRAMMATIC IN NATURE AND ARE NOT INTENDED TO SHOW THE EXACT LOCATION OF COMPONENTS...

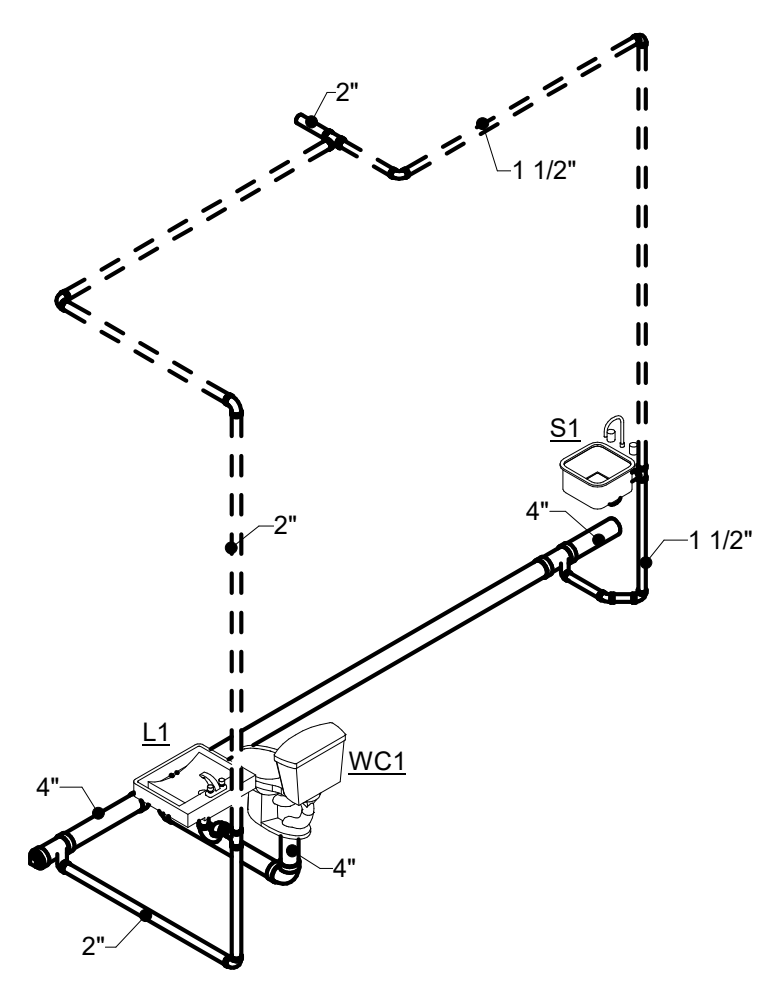

1 DETAIL DIAGRAM - STACK A

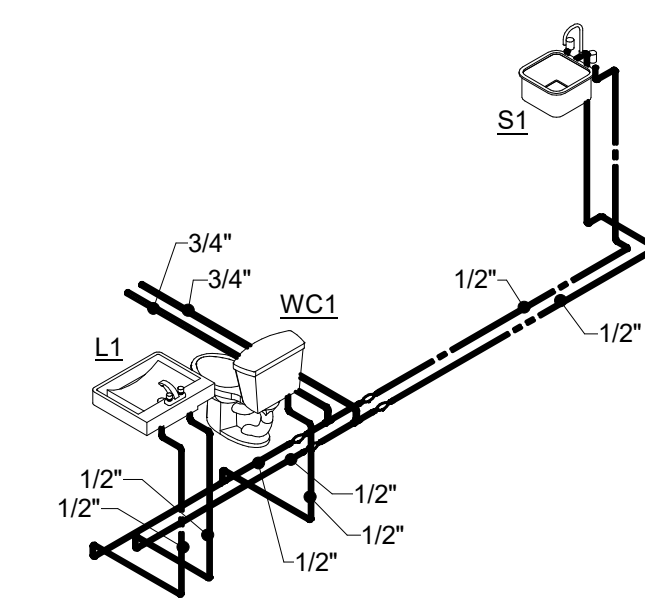

2 DETAIL DIAGRAM - RISER 1

PLUMBING FIXTURE SCHEDULE

Table with columns: TAG, FIXTURE DESCRIPTION, MANUFACTURER, MODEL #. Lists items like WC1 (Water Closet), L1 (Lavatory), S1 (Sink) with detailed specifications.

PUMP SCHEDULE

Table with columns: TAG, VOLT, PHASE, HP, GPM, FEET OF HEAD, MANUFACTURER, MODEL #, NOTES. Lists pump models SE1 and SP1.

WATER HAMMER ARRESTOR SCHEDULE

Table with columns: TAG, INLET PIPE SIZE, FIXTURE UNIT RATING, REMARKS. Lists arrestor models A through F.

PLUMBING FIXTURE ROUGH-IN SCHEDULE

Table with columns: FIXTURE, WASTE, TRAP, VENT, COLD, HOT. Lists rough-in dimensions for fixtures WC1, L1, S1.


NOTES:
1. INSTALL ARRESTOR IN UPRIGHT POSITION BEFORE LAST FLUSH VALVED FIXTURE AND ON MAIN COLD WATER PIPE HEADER.
2. INSTALL SHUT-OFF VALVE BEFORE ARRESTOR.

MOODY-NOLAN logo and contact information for Renovation of Heartland Bank Dublin, including address and phone numbers.

GENERAL INFORMATION - PLUMBING

Project information including drawing title 'GENERAL INFORMATION - PLUMBING', drawing number 'P-001', date '09/10/2020', and 'PRELIMINARY DEVELOPMENT PLAN'.

- CODED NOTES:**
- EXISTING SINK, FAUCET, TRIM AND ASSOCIATED PIPING TO BE REMOVED. EXISTING HOT & COLD WATER AND SANITARY TO BE CAPPED IN WALL.
 - EXISTING LAVATORY, FAUCET, TRIM AND ASSOCIATED PIPING TO BE REMOVED. EXISTING HOT & COLD WATER, SANITARY AND VENT PIPING BE REMOVED BACK INTO CHASE.
 - EXISTING SINK, FAUCET, TRIM AND ASSOCIATED PIPING TO BE REMOVED. EXISTING HOT & COLD WATER, SANITARY AND VENT PIPING BE REMOVED BACK INTO CHASE.
 - EXISTING WATER CLOSET, TRIM AND ASSOCIATED PIPING TO BE REMOVED. EXISTING HOT & COLD WATER AND VENT PIPING BE REMOVED BACK INTO CHASE. EXISTING SANITARY PIPING TO BE REMOVED TO FLOOR BELOW.
 - EXISTING HOT & COLD WATER AND SANITARY PIPING TO BE REMOVED TO FLOOR BELOW. EXISTING VENT PIPING TO BE REMOVED TO VENT THROUGH ROOF. EXISTING VENT THROUGH ROOF TO REMAIN.
 - EXISTING 40 GALLON GAS-FIRED WATER HEATER TO REMAIN.
 - EXISTING SEWAGE EJECTOR PUMPS, CONTROLS AND LID TO BE REMOVED. EXISTING BASIN TO REMAIN. EXISTING PIPING TO REMAIN.
 - EXISTING SUMP PUMPS, CONTROLS AND LID TO BE REMOVED. EXISTING BASIN TO REMAIN. EXISTING PIPING TO REMAIN.
 - EXISTING ACCUMULATOR TANK AND ASSOCIATED PIPING TO BE REMOVED.
 - EXISTING BOILER BEING REMOVED. DISCONNECT EXISTING GAS LINE AND PROVIDE TEMPORARY CAP.

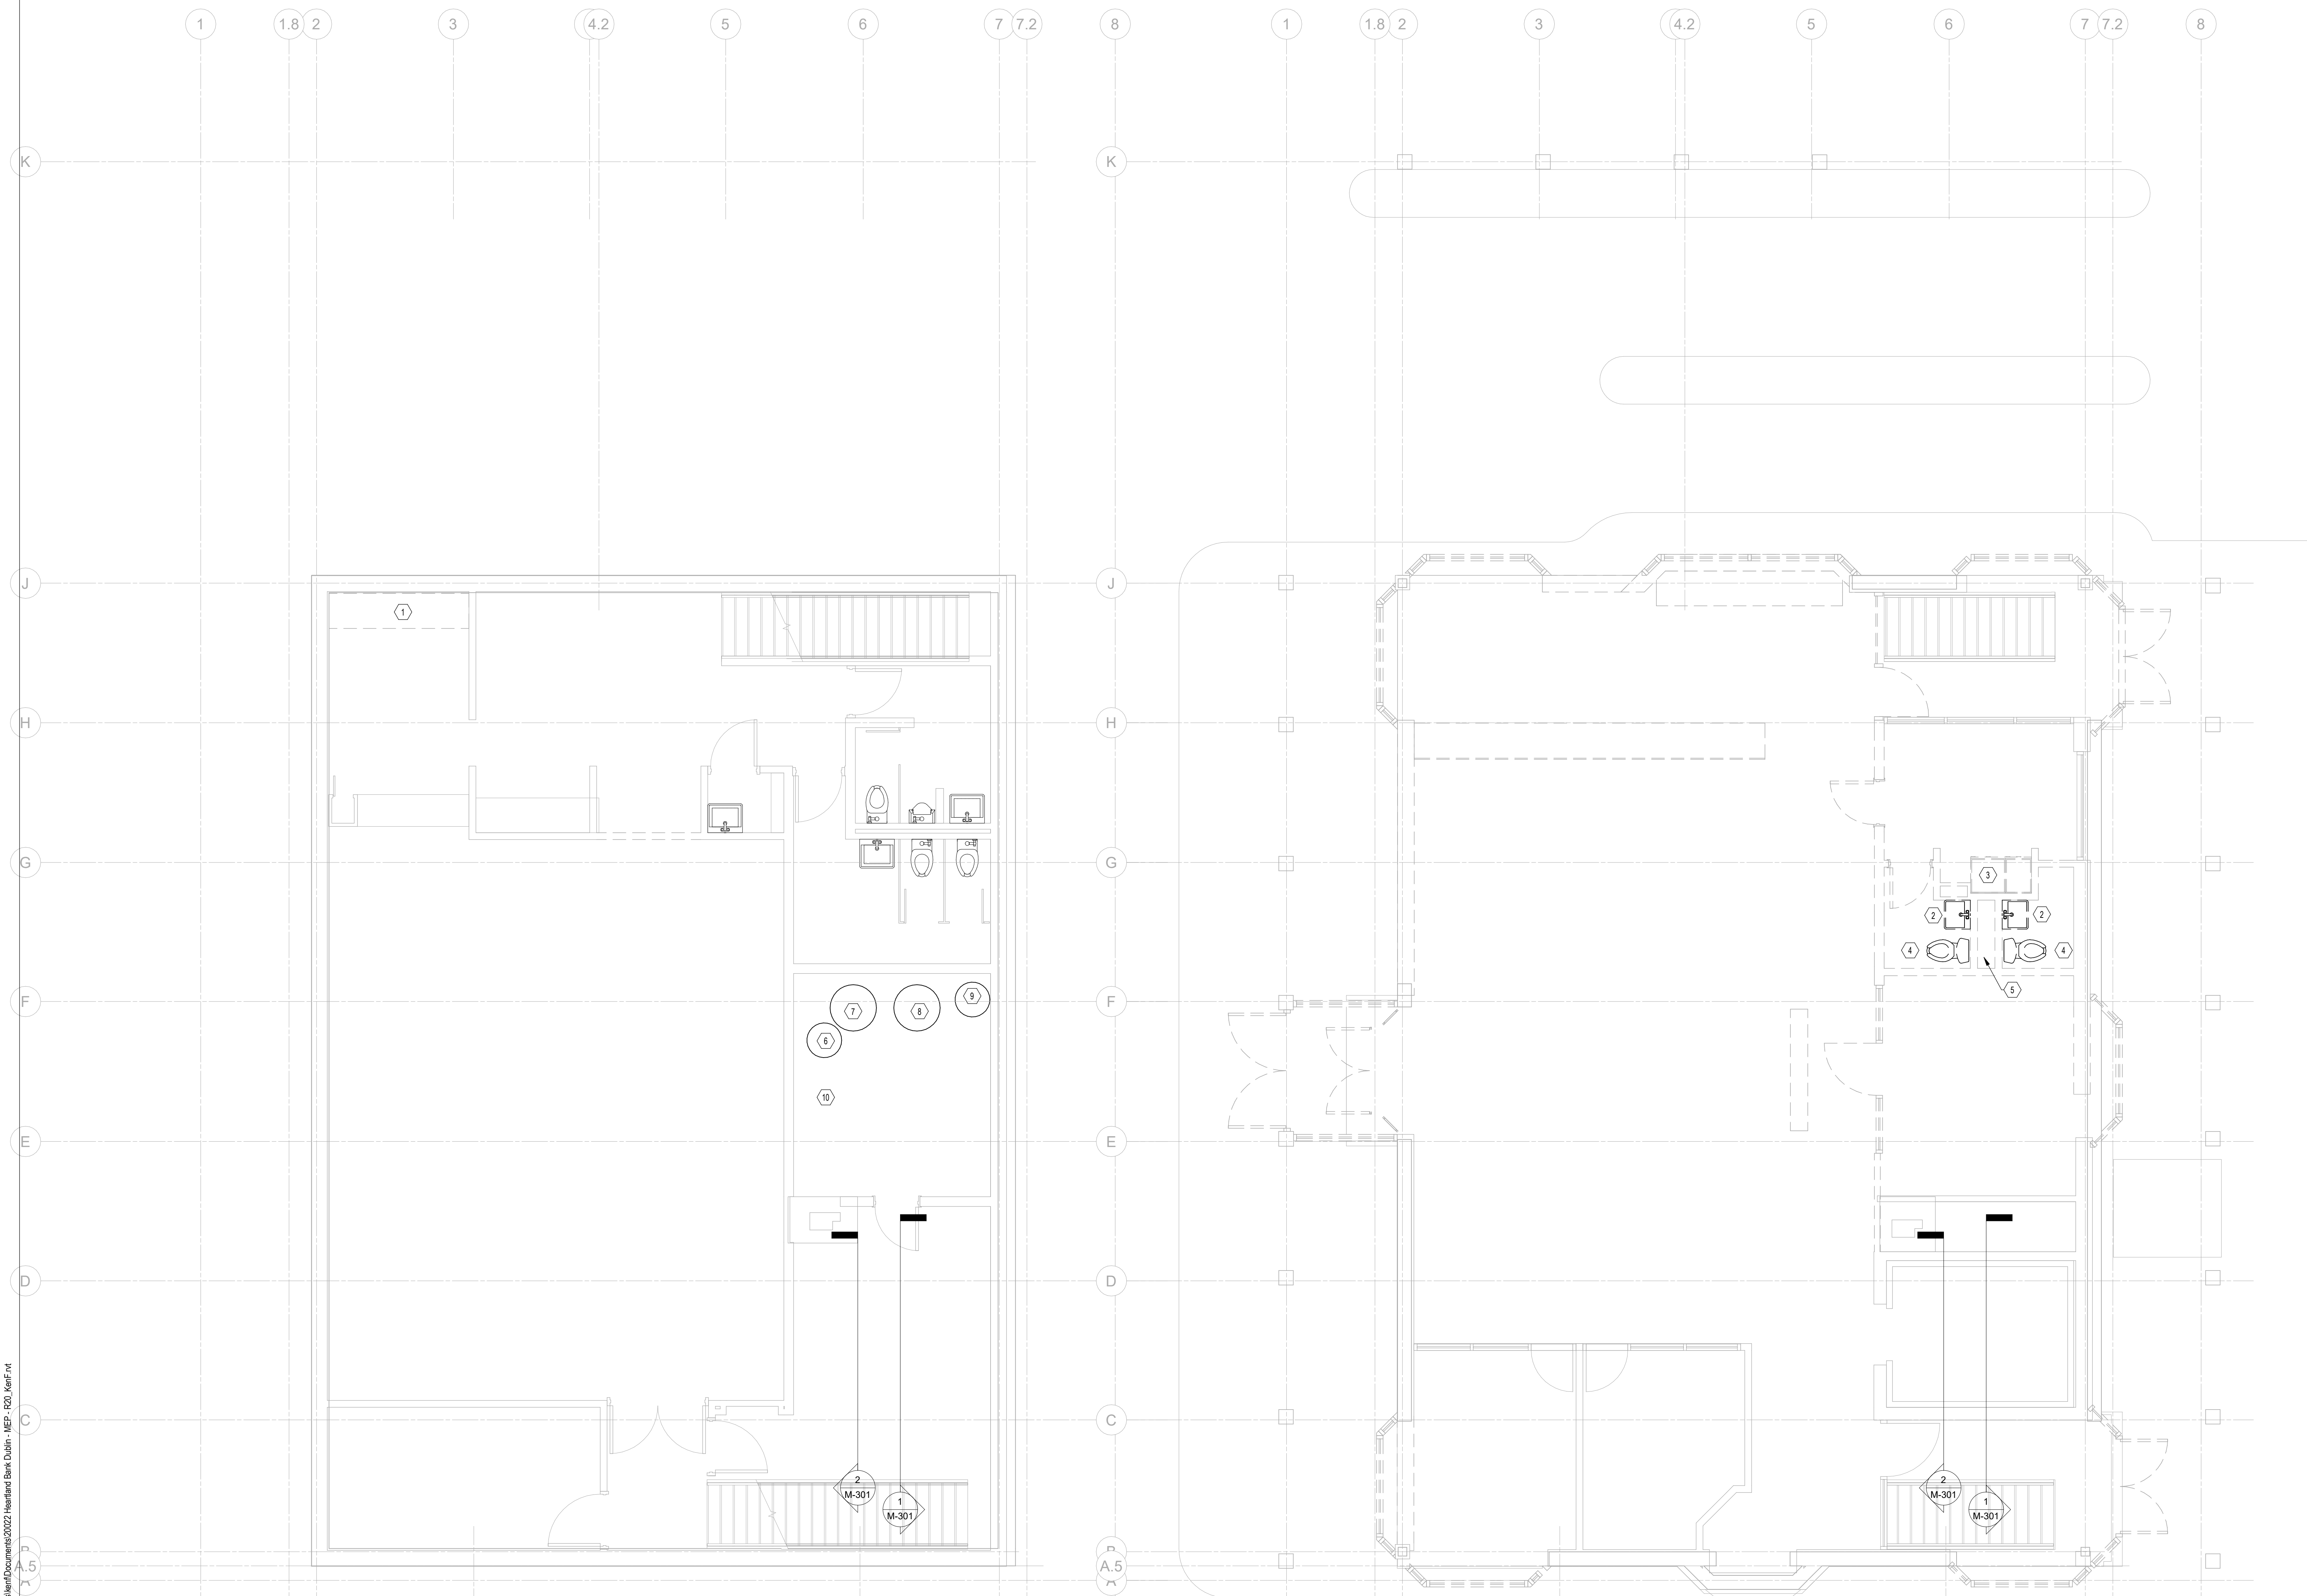

1 PLAN BASEMENT FLOOR PLAN - PLUMBING - DEMOLITION
1/4" = 1'-0"

2 PLAN FIRST FLOOR PLAN - PLUMBING - DEMOLITION
1/4" = 1'-0"

#	DATE	CHANGE DESCRIPTION


RENOVATION OF HEARTLAND BANK DUBLIN
6500 FRANTZ ROAD
DUBLIN, OH 43017
FOR
HEARTLAND BANK

MOODY-NOLAN
300 SPRUCE STREET
SUITE 300
COLUMBUS, OHIO 43215
PHONE: (614) 461-4664
FAX: (614) 280-8881

DRAWING TITLE:
FLOOR PLANS - PLUMBING - DEMOLITION

PROGRESS DRAWING NOT FOR CONSTRUCTION	09/10/2020
	DRAWN BY: Author CHECKED BY: Checker
	20022
PD101	
PRELIMINARY DEVELOPMENT PLAN	

- CODED NOTES:**
- EXISTING 40 GALLON GAS-FIRED WATER HEATER TO REMAIN.
 - CONNECT 3/4" HW, 3/4" CW AND 1" G TO EXISTING TO EXISTING 3/4" HW, 3/4" CW AND GAS IN THIS AREA.
 - CONNECT 3" PUMP DISCHARGE TO EXISTING SANITARY PIPING.
 - CONNECT 3" PUMP DISCHARGE TO EXISTING STORM PIPING.
 - CONNECT 4" SAN TO EXISTING 4" SAN IN THIS AREA.
 - CONNECT 3/4" G TO HVAC EQUIPMENT. PROVIDE SHUT-OFF AND DIRT LEG. MAKE FINAL CONNECTION.
 - CONNECT 2" V TO EXISTING VENT IN THIS AREA.
 - EXTEND 1/2" HW FROM SINK SUPPLY TO DISHWASHER. EXTEND DRAIN FROM DISHWASHER TO CONNECTION ABOVE SINK TRAP. MAKE FINAL CONNECTION.

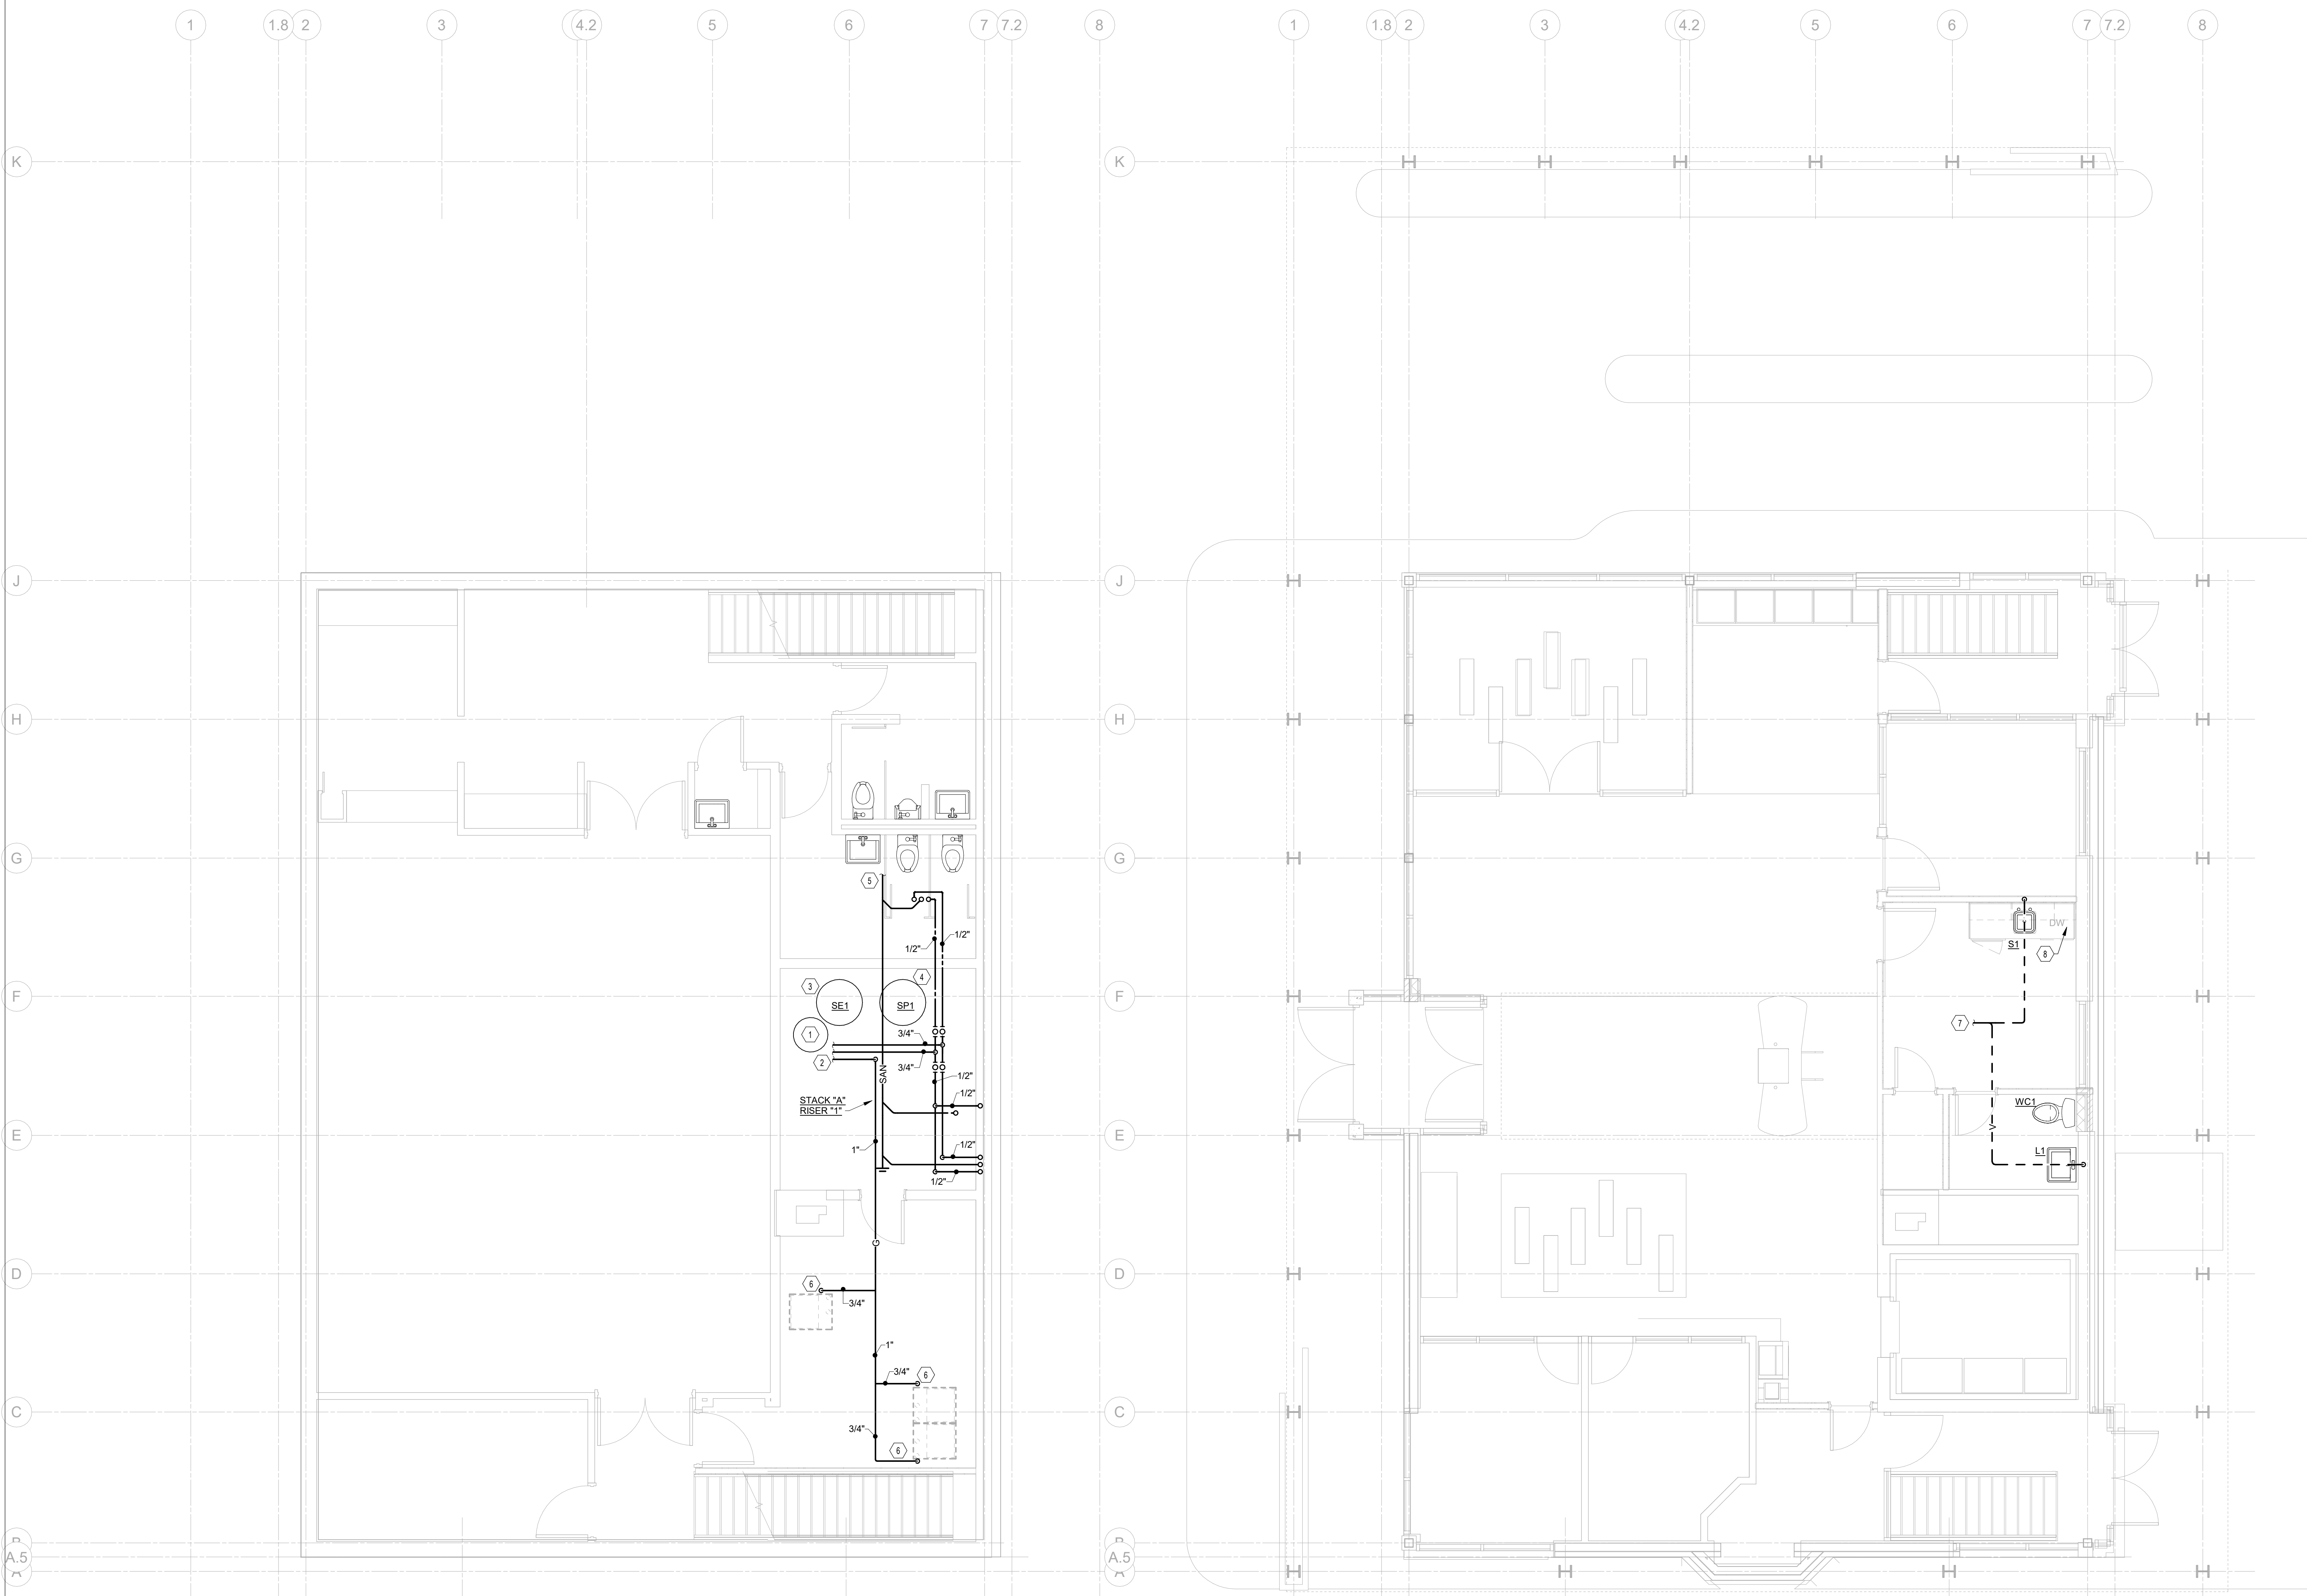

1 PLAN BASEMENT FLOOR PLAN - PLUMBING
1/4" = 1'-0"

2 PLAN FIRST FLOOR PLAN - PLUMBING
1/4" = 1'-0"

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FLOOR PLANS - PLUMBING

PROGRESS DRAWING NOT FOR CONSTRUCTION	09/10/2020
	DRAWN BY: Author CHECKED BY: Checker
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P-101	
PRELIMINARY DEVELOPMENT PLAN	

ABBREVIATIONS

NOTE: NOT ALL ABBREVIATIONS MAY BE USED.

(A)	EXISTING TO BE ABANDONED
(D)	EXISTING TO BE DEMOLISHED
(E)	EXISTING TO REMAIN
(F)	FUTURE
(R)	EXISTING TO BE RELOCATED
AAV	AUTOMATIC AIR VENT
AFF	ABOVE FINISHED FLOOR
AMB	AMBIENT
APD	AIR PRESSURE DROP
A/E	ARCHITECT/ENGINEER
BAS	BUILDING AUTOMATION SYSTEM
BFP	BACKFLOW PREVENTOR
BLDG	BUILDING
BOB	BOTTOM OF BEAM
BOD	BOTTOM OF DUCT
BOP	BOTTOM OF PIPE
BOS	BOTTOM OF STRUCTURE
CL	CENTER LINE
CO	CLEAN OUT
DB	DRY BULB
DIA	DIAMETER
DN	DOWN
EA	EXHAUST AIR
EAT	ENTERING AIR TEMPERATURE
EFF	EFFICIENCY
EG	ETHYLENE GLYCOL
ESP	EXTERNAL STATIC PRESSURE
EWT	ENTERING WATER TEMPERATURE
EXH	EXHAUST
FPI	FINS PER INCH
GTC	GENERAL TRADES CONTRACTOR
ID	INNER DIAMETER
LAT	LEAVING AIR TEMPERATURE
LWT	LEAVING WATER TEMPERATURE
MFR	MANUFACTURER
N/A	NOT APPLICABLE
NC	NORMALLY CLOSED
NO	NORMALLY OPEN
NTS	NOT TO SCALE
OA	OUTSIDE AIR
OD	OUTSIDE DIAMETER
PD	PRESSURE DROP
PRV	PRESSURE REDUCING VALVE
RA	RETURN AIR
REL	RELIEF AIR
SA	SUPPLY AIR
SCC	SENSIBLE COOLING CAPACITY
SP	STATIC PRESSURE
TCC	TOTAL COOLING CAPACITY
TCP	TEMPERATURE CONTROL PANEL
TSP	TOTAL STATIC PRESSURE
TYP	TYPICAL
UNO	UNLESS NOTED OTHERWISE
VFD	VARIABLE FREQUENCY DRIVE
WB	WET BULB
WG	WATER GAUGE
WPD	WATER PRESSURE DROP

SYMBOLS LIST

NOTE: NOT ALL SYMBOLS MAY BE USED.

LINE STYLES	DUCTWORK
NEW WORK (VISIBLE)	SUPPLY/O.A. DUCT RISE (SINGLE LINE)
NEW WORK (HIDDEN)	SUPPLY/O.A. DUCT RISE (DOUBLE LINE)
EXISTING WORK (VISIBLE)	SUPPLY/O.A. DUCT DROP (SINGLE LINE)
EXISTING WORK (HIDDEN)	SUPPLY/O.A. DUCT DROP (DOUBLE LINE)
EXISTING TO BE DEMOLISHED	
FUTURE	
PIPING	DUCTWORK
HEATING WATER SUPPLY	SUPPLY/O.A. DUCT DROP (DOUBLE LINE)
HEATING WATER RETURN	RETURN/EXHAUST RELIEF DUCT RISE (SINGLE LINE)
CHILLED WATER SUPPLY	RETURN/EXHAUST RELIEF DUCT RISE (DOUBLE LINE)
CHILLED WATER RETURN	RETURN/EXHAUST RELIEF DUCT DROP (SINGLE LINE)
CONDENSER WATER SUPPLY	RETURN/EXHAUST RELIEF DUCT DROP (DOUBLE LINE)
CONDENSER WATER RETURN	RETURN/EXHAUST RELIEF DUCT DROP (DOUBLE LINE)
COOLING COIL CONDENSATE	RETURN/EXHAUST RELIEF DUCT DROP (DOUBLE LINE)
REFRIGERANT SUCTION	RETURN/EXHAUST RELIEF DUCT DROP (DOUBLE LINE)
REFRIGERANT LIQUID	RETURN/EXHAUST RELIEF DUCT DROP (DOUBLE LINE)
HIGH PRESSURE STEAM	FLAT OVAL (DROP OR RISE)
HIGH PRESSURE STEAM CONDENSATE	HPC
LOW PRESSURE STEAM	LPS(#)
LOW PRESSURE STEAM CONDENSATE	LPC
PUMPED STEAM CONDENSATE	PSC
DOUBLE LINE FLEX DUCT	
SINGLE LINE FLEX DUCT	
PIPING (FITTINGS, VALVES, AND MISCELLANEOUS)	ACCESS DOOR
DROP	90 DEGREE FITTING (WITH TURNING VANES)
RISE	
TEE	
CAP	
REDUCER	
FLOW ARROW	
PUMP	
2-WAY CONTROL VALVE	
3-WAY CONTROL VALVE	
BUTTERFLY VALVE	
BALL VALVE	
CHECK VALVE	
COMBINATION BALANCE/SHUT-OFF VALVE	
TRIPLE DUTY VALVE	
GATE VALVE	
PLUG VALVE	
GLOBE VALVE	
PRESSURE RELIEF VALVE	
PRESSURE REDUCING VALVE	
STRAINER	
DRAIN VALVE WITH HOSE END ADAPTER	
UNION	
AUTOMATIC AIR VENT	
MANUAL AIR VENT	
THERMOMETER	
PRESSURE GAUGE (WITH STOPCOCK)	
PRESSURE/TEMPERATURE TEST PLUG	
FLOW SENSOR	
PRESSURE SENSOR	
TEMPERATURE SENSOR	
STEAM TRAP	
METER	
FLEXIBLE CONNECTION	
HEAT TRACED PIPE	
PIPE ANCHOR	
PIPE GUIDE	
EXPANSION JOINT	
	DIFFUSER
	SIDEWALL GRILLE/REGISTER/DIFFUSER
	GRILLE/REGISTER
	VOLUME DAMPER
	FIRE DAMPER WITH ACCESS DOOR
	SMOKE DAMPER WITH ACCESS DOOR
	COMB. FIRE/SMOKE DAMPER WITH ACCESS DOOR
	BACKDRAFT DAMPER
	MOTORIZED DAMPER WITH ACCESS DOOR
	AIR FLOW ARROW
	THERMOSTAT (MOUNT 48" AFF TO CENTER UNO)
	HUMIDISTAT (MOUNT 48" AFF TO CENTER UNO)
	MISCELLANEOUS SENSOR
	CO SENSOR
	CO 2 SENSOR
	CONNECT TO EXISTING
	TERMINAL BOX

- GENERAL NOTES:
- THESE NOTES APPLY TO ALL DIVISION 23 DRAWINGS.
 - ALL HVAC WORK SHALL BE PERFORMED IN ACCORDANCE WITH LOCAL, STATE, AND NATIONAL CODES.
 - CONTRACTOR SHALL PROVIDE ALL MATERIALS, LABOR, FEES, AND PERMITS FOR A COMPLETE INSTALLATION. CONTRACTOR SHALL COMPLY WITH ALL GENERAL CONDITIONS LISTED ON THE ARCHITECTURAL DRAWINGS.
 - IN CASE OF DIFFERENCE BETWEEN BUILDING CODES, SPECIFICATIONS, INDUSTRY STANDARDS, UTILITY COMPANY REGULATIONS, FIRE INSURANCE CARRIER'S REQUIREMENTS, AND CONTRACT DOCUMENTS, THE MOST STRINGENT SHALL GOVERN. PROMPTLY NOTIFY THE ENGINEER IN WRITING OF ANY SUCH DIFFERENCE.
 - CONTRACTOR SHALL BE RESPONSIBLE FOR THE COMPLETE FUNCTIONALITY OF THE HVAC SYSTEM INCLUDING ELECTRICAL AND CONTROL ITEMS ASSOCIATED WITH THE MECHANICAL EQUIPMENT.
 - THE DRAWINGS ARE DIAGRAMMATIC AND SHALL NOT BE SCALED TO DETERMINE EXACT LOCATION OF MECHANICAL, PLUMBING, AND EQUIPMENT. DRAWINGS ARE BASED ON "AS-BUILT" DRAWINGS AND LIMITED FIELD OBSERVATIONS. FOR PURPOSES OF CLEARNESS AND LEGIBILITY, SIZE AND LOCATION OF EQUIPMENT ARE SHOWN TO SCALE WHEREVER POSSIBLE.
 - IN THE EVENT OF A CONFLICT OCCURS BETWEEN THE REQUIREMENTS OF THE CONTRACT DOCUMENTS AND THE ACTUAL FIELD CONDITIONS THE CONTRACTOR SHALL ADVISE ENGINEER IN WRITING PRIOR TO PROCEEDING WITH WORK. THE CONTRACTOR SHALL BEAR ALL COSTS ASSOCIATED WITH RESTORING, RELOCATING OR EQUIPMENT, SYSTEMS, PIPING, ETC. FROM FAILURE TO PROPERLY COORDINATE INSTALLATION AND NOT ADVISING IN WRITING OF CONFLICT PRIOR TO PURCHASE AND/OR INSTALLATION.
 - NOT ALL EXISTING SYSTEMS ARE SHOWN TO AID DRAWING INTERPRETATION AND CLARITY.
 - CONTRACTOR IS TO MAINTAIN RECORDED "AS-BUILT" INFORMATION ON ALL EXISTING SERVICES UNCOVERED DURING CONSTRUCTION AND ALL NEW SERVICES BEING INSTALLED. "AS-BUILT" DRAWINGS SHALL BE MAINTAINED IN THE FIELD. THE "AS-BUILT'S" SHALL CAPTURE INFORMATION ON A CLEARLY MARKED IN COLOR PRINTED COPY OF CONTRACT DRAWING. RECORDED INFORMATION SHALL INCLUDE ROUTING AND INVERT ELEVATIONS. AT THE COMPLETION OF THE CONTRACT, THE CONTRACTOR SHALL PROVIDE ELECTRONIC (PDF FORMAT) OF RECORDED "AS-BUILT" INFORMATION TO THE ENGINEER.
 - THE CONTRACTOR SHALL BE RESPONSIBLE FOR START-UP OF ALL EQUIPMENT AND SYSTEMS INSTALLED, MODIFIED, OR REVISED BY THIS WORK PER MANUFACTURERS REQUIREMENTS AND/OR CONTRACT DOCUMENTS.
 - AT THE END OF CONSTRUCTION, CONTRACTOR SHALL PERFORM A COMPLETE AIR BALANCE FOR ALL EQUIPMENT AND SYSTEMS SHOWN, SCHEDULED OR OTHERWISE IDENTIFIED. CONTRACTOR SHALL INCLUDE TIME IN CONSTRUCTION SCHEDULE TO FULLY TEST AND BALANCE SYSTEMS PRIOR TO OWNER OCCUPANCY TO ASSURE ADJUSTMENTS CAN BE MADE TO MITIGATE COMFORT ISSUES FOR OCCUPANTS POST CONSTRUCTION.
 - UPON COMPLETION OF HVAC SYSTEMS, THE MECHANICAL CONTRACTOR SHALL INSTRUCT THE OWNER IN THE COMPLETE OPERATION OF THE SYSTEMS.
 - PRIOR TO AND DURING CONSTRUCTION, CONTRACTOR SHALL FULLY PROTECT THE AIR HANDLING AND DUCTWORK SYSTEMS. CONTRACTOR SHALL PROTECT EACH RETURN AIR GRILLE OPENING AND RETURN AIR DUCT WITH MINIMUM MERV 8 FILTER MEDIA. AIR HANDLING EQUIPMENT AND DUCTS COVERED WITH DRYWALL/CONSTRUCTION DUST SHALL BE CLEANED AT CONTRACTOR EXPENSE.
 - THE CONTRACTOR SHALL ENSURE THAT ALL MECHANICAL EQUIPMENT, DUCTWORK, PIPING, VALVES, AND ACCESS LOCATIONS HAVE CLEARANCES IN ACCORDANCE TO THE DRAWINGS AND THE MANUFACTURER'S REQUIREMENTS FOR FULL ACCESSIBILITY AND OPERATION OF MECHANICAL SYSTEMS.
 - THE CONTRACTOR SHALL PROVIDE ACCESS PANELS, IN WALLS OR CEILING, OR ACCESS DOORS, IN DUCTWORK, AS INDICATED OR REQUIRED FOR ACCESS TO CONCEALED MECHANICAL EQUIPMENT OR DEVICES.
 - CONTRACTOR SHALL BE RESPONSIBLE FOR PROTECTION AND SHALL REPAIR ADJACENT EXISTING AND/OR NEW SURFACES, AREAS, AND PROPERTY THAT MAY BE DAMAGED AS A RESULT OF DEMOLITION AND/OR NEW WORK.
 - UNLESS OTHERWISE INDICATED, ALL EQUIPMENT SHALL BE PROVIDED WITH A MINIMUM 4 INCH CONCRETE HOUSEKEEPING PAD SIZED TO SUIT EQUIPMENT.
 - COORDINATE THE LOCATION OF ALL UTILITY CONNECTION POINTS FOR EQUIPMENT WITH OTHER TRADES. COORDINATION INCLUDES ALLOWING PROPER CLEARANCE FOR ELECTRICAL DEVICES FURNISHED WITH EQUIPMENT INCLUDING CONTROLS, DISCONNECTS, VAV POWER CONTROL PANELS, VFD, ETC.
 - REFER TO ARCHITECTURAL REFLECTED CEILING PLANS FOR EXACT LOCATION OF CEILING DEVICES, INCLUDING CEILING MOUNTED FANS.
 - COORDINATE CLOSELY WITH OTHER TRADES IN LOCATING AND INSTALLING ALL SYSTEMS ABOVE SUSPENDED CEILINGS. SPECIFICALLY, COORDINATE LAYOUT WITH ELECTRICAL AND PLUMBING CONTRACTORS TO ALLOW SUFFICIENT ROOM FOR RECESSED LIGHT FIXTURES, FIRE SPRINKLER, AND PLUMBING VENTS WHERE APPLICABLE.
 - ANNULAR SPACE OF PIPE, CONDUIT, DUCT, AND OTHER SIMILAR PENETRATIONS OF FIRE RATED ASSEMBLIES SHALL BE FIRESTOPPED. IN ADDITION, PENETRATIONS THRU 4-HOUR RATED FLOORS SHALL ALSO BE FIRESTOPPED TO RETARD PASSAGE OF FIRE AND SMOKE. REFER TO FIRESTOPPING SPECIFICATION. REFER TO ARCHITECTURAL DRAWINGS FOR CONSTRUCTION, LAYOUT, AND FIRE RATINGS OF FLOORS, WALLS, PARTITIONS, AND OTHER BUILDING ELEMENTS.
 - ALL EXPOSED WIRING SHALL BE RUN IN CONDUIT, EXCEPT WHEN RUNNING THOUGH FINISHED SPACES THAT HAVE CEILING "CLOUDS".
 - THE CONTRACTOR SHALL PROVIDE ALL CUTTING, PATCHING, FINISHING, AND PENETRATIONS REQUIRED BY THE INSTALLATIONS. ALL FLOOR PENETRATIONS SHALL BE PATCHED AND SEALED TO BE WATER TIGHT. CUTTING OF BUILDING CONSTRUCTION MATERIALS SHALL CONFORM TO THE CHARACTERISTICS OF THE PARTICULAR MATERIAL INVOLVED AND SHALL NOT CREATE ANY STRUCTURAL WEAKNESS OR UNSIGHTLY APPEARANCE. REFINISH ANY SURFACE DISTURBED UNDER THIS WORK TO MATCH EXISTING, EXCEPT WHERE REFINISHING OF THAT SURFACE IS INCLUDED UNDER THE GENERAL TRADES CONTRACT.
 - PROVIDE ROOM TEMPERATURE THERMOSTATS FOR ALL UNITS. PREFERRED LOCATIONS ARE SHOWN ON THE PLANS. COORDINATE LOCATION OF THERMOSTATS AND OTHER WALL MOUNTED DEVICES WITH FURNITURE, WALL FRAMING, ELECTRICAL, OUTLETS AND DEVICES, AND TECHNOLOGY OUTLETS AND DEVICES PRIOR TO ROUGH-IN. PROVIDE THERMOSTATS WITH ROOM TEMPERATURE INDICATOR AND WITH SET POINT ADJUSTMENT.
 - ALL ROOF AND DECK PENETRATIONS SHALL BE COMPLETED DONE BY THE GENERAL TRADES CONTRACTOR. COORDINATE EXACT SIZE AND LOCATION WITH ARCHITECT AND STRUCTURAL ENGINEER.
 - COORDINATE EXACT LOCATION OF DIFFUSERS, GRILLES AND REGISTERS WITH AREA SMOKE DETECTORS, LIGHTS, AND ELECTRICAL DEVICES. AIR DEVICES SHALL NOT BE CLOSER THAN 3 FEET FROM AN AREA SMOKE DETECTOR.
 - BRANCH DUCT TO DIFFUSERS SHALL BE SAME SIZE AS DIFFUSER NECK UNLESS NOTED OTHERWISE. FLEXIBLE DUCT CONNECTION TO THE DIFFUSER SHALL BE NO MORE THAN 5 FEET IN LENGTH. FLEXIBLE DUCT SHALL NOT BE USED FOR ELBOW TO DIFFUSER WITH A FLEXFLOW SUPPORT ELBOW.
 - PROVIDE VOLUME DAMPERS AS SHOWN ON THE DRAWINGS, AS REQUIRED BY THE SPECIFICATIONS, AND SHOWN IN TYPICAL DETAILS. LOCATE VOLUME DAMPERS IN ACCESSIBLE LOCATIONS. A VOLUME DAMPER SHALL BE PROVIDED FOR EACH DIFFUSER AND GRILLE IN ORDER TO BALANCE EACH AIR DEVICE INDEPENDENTLY PER SPECIFIED CFM STATED ON DRAWINGS.
 - DUCTWORK DIMENSIONS SHOWN ON DRAWINGS ARE INSIDE CLEAR, UNLESS NOTED OTHERWISE.
 - PROVIDE STRAIGHT INLET AND OUTLET DUCTS PER THE LENGTH THE EQUIPMENT MANUFACTURER RECOMMENDS. FAN INLETS SHALL BE MINIMUM 3 DUCT DIAMETERS OF STRAIGHT DUCT. INSTALL AND SUPPORT MECHANICAL EQUIPMENT PER MANUFACTURERS RECOMMENDATIONS. PROVIDE FLEXIBLE CONNECTIONS AND VIBRATION ISOLATION FOR VIBRATING EQUIPMENT UNLESS NOTED OTHERWISE.
 - INSTALL AIRFOIL TURNING VANES IN ALL 90 DEGREE ELBOWS EXCEPT TRANSFER DUCTS AND OPEN RETURN AIR BOOTS.
 - CONTRACTOR SHALL COMPLY WITH SMACNA "HVAC DUCT CONSTRUCTION AND STANDARDS" AND OTHER APPLICABLE STANDARDS INCLUDED IN THE SPECIFICATIONS FOR THE CONSTRUCTION AND SUPPORT OF DUCTWORK, UNLESS OTHERWISE NOTED.
 - ALL DUCTS AND PIPES SHALL BE RUN ABOVE CEILING, WHERE NO CEILINGS ARE INSTALLED, INSTALL AS HIGH AS POSSIBLE TO STRUCTURE UNLESS NOTED OTHERWISE. IN GENERAL, KEEP DUCT AND PIPING MAINS NEXT TO UNDERSIDE OF STRUCTURE.
 - CHANGES IN HVAC DUCT AND PIPE ELEVATIONS SHALL BE PROVIDED AND BE COORDINATED WITH OTHER SYSTEMS INCLUDING, BUT NOT LIMITED TO, PLUMBING, FIRE PROTECTION, ELECTRICAL, AND BUILDING ELEMENTS SYSTEMS. OFFSET DUCTS INTO JOIST SPACE FOR WHERE SPACE ABOVE CEILING IS NOT SUFFICIENT FOR DUCTS TO CROSS OTHER DUCTS OR WORK OF OTHER CONTRACTORS.
 - DUCTWORK AND PIPING ON DRAWINGS DOES NOT INDICATE ALL REQUIRED OFFSETS AND FITTINGS. INCLUDE THESE OFFSETS AND FITTINGS TO COORDINATE WITH OTHER CONTRACTORS.
 - SECURELY FASTEN ALL PIPING AND DUCTWORK WITHIN STRUCTURES TO THE BUILDING CONSTRUCTION BY MEANS OF HANGERS, SUPPORTS, GUIDES, ANCHORS, AND SWAY BRACES TO MAINTAIN PIPE AND DUCTWORK ALIGNMENT, TO PREVENT SAGGING, AND TO PREVENT NOISE AND EXCESSIVE STRAIN ON PIPING AND DUCTWORK DUE TO MOVEMENT UNDER OPERATING CONDITIONS. SUPPORTS FOR ALL PIPING AND DUCTWORK SHALL BE IN ACCORDANCE WITH LATEST ANSI AND SMACNA STANDARDS.

- CONTRACTOR SHALL PROTECT THE PIPING AND DUCTWORK TO PREVENT ENTRY OF DIRT AND ANY OTHER FOREIGN MATERIAL DURING THE INSTALLATION.
- COLOR CODE AND LABEL PIPING AND DUCTWORK IN ACCORDANCE WITH SPECIFICATIONS.
- PROVIDE FLEXIBLE CONNECTIONS FOR ALL VIBRATING EQUIPMENT.
- INSTALL ALL PIPING IN LOCATIONS AND ELEVATIONS SUCH THAT COILS, TUBES, AND FILTERS CAN BE REMOVED AND REPLACED WITHOUT MAJOR PIPING REMOVAL. LOCATE VALVES IN APPROPRIATE PLACES TO ACCOMMODATE MAINTENANCE. MAINTAIN REQUIRED SERVICE ACCESS SPACE AT EQUIPMENT.
- ARRANGE ALL PIPING WITHIN STRUCTURES NEATLY ALONG WALLS AND/OR IN NEAT, HORIZONTAL GROUPS AND MAINTAIN REQUIRED SLOPES.
- PROVIDE A HANGER NOT MORE THAN 12 INCHES FROM THE POINT OF CHANGE OF DIRECTION OF A PIPE RUN IN BOTH HORIZONTAL AND VERTICAL PLANE.
- ALL WORK, EQUIPMENT AND MATERIALS SHALL BE PROTECTED AT ALL TIMES. ALL DUCT AND PIPE OPENING SHALL BE PROPERLY CAPPED OR PLUGGED DURING INSTALLATION.
- DEMOLITION OF ANY ITEM SHALL INCLUDE ALL ASSOCIATED ITEMS THIS INCLUDES, BUT IS NOT LIMITED TO: SUPPORTS, HANGERS, PADS, FASTENERS, INSERTS, SLEEVES, STRAPS, ATTACHMENTS, LEVELERS, AND ALL OTHER ITEMS FOR A COMPLETE DEMOLITION OF THE ITEM.
- ALL EQUIPMENT TO BE REMOVED SHALL BE DISPOSED OF BY THE CONTRACTOR IN ACCORDANCE WITH FEDERAL, STATE, AND LOCAL LAWS, ORDINANCES, RULES AND REGULATIONS.
- ALL EQUIPMENT TO BE REUSED OR RETURNED TO THE OWNER SHALL BE REMOVED SO AS TO NOT DAMAGE THE EQUIPMENT. MATERIAL OR AFFECT ITS REUSE. IF ANY EQUIPMENT OR MATERIAL IS DAMAGED BY THE CONTRACTOR, IT SHALL BE REPLACED BY THE CONTRACTOR, WITH NO EXPENSE TO THE OWNER.

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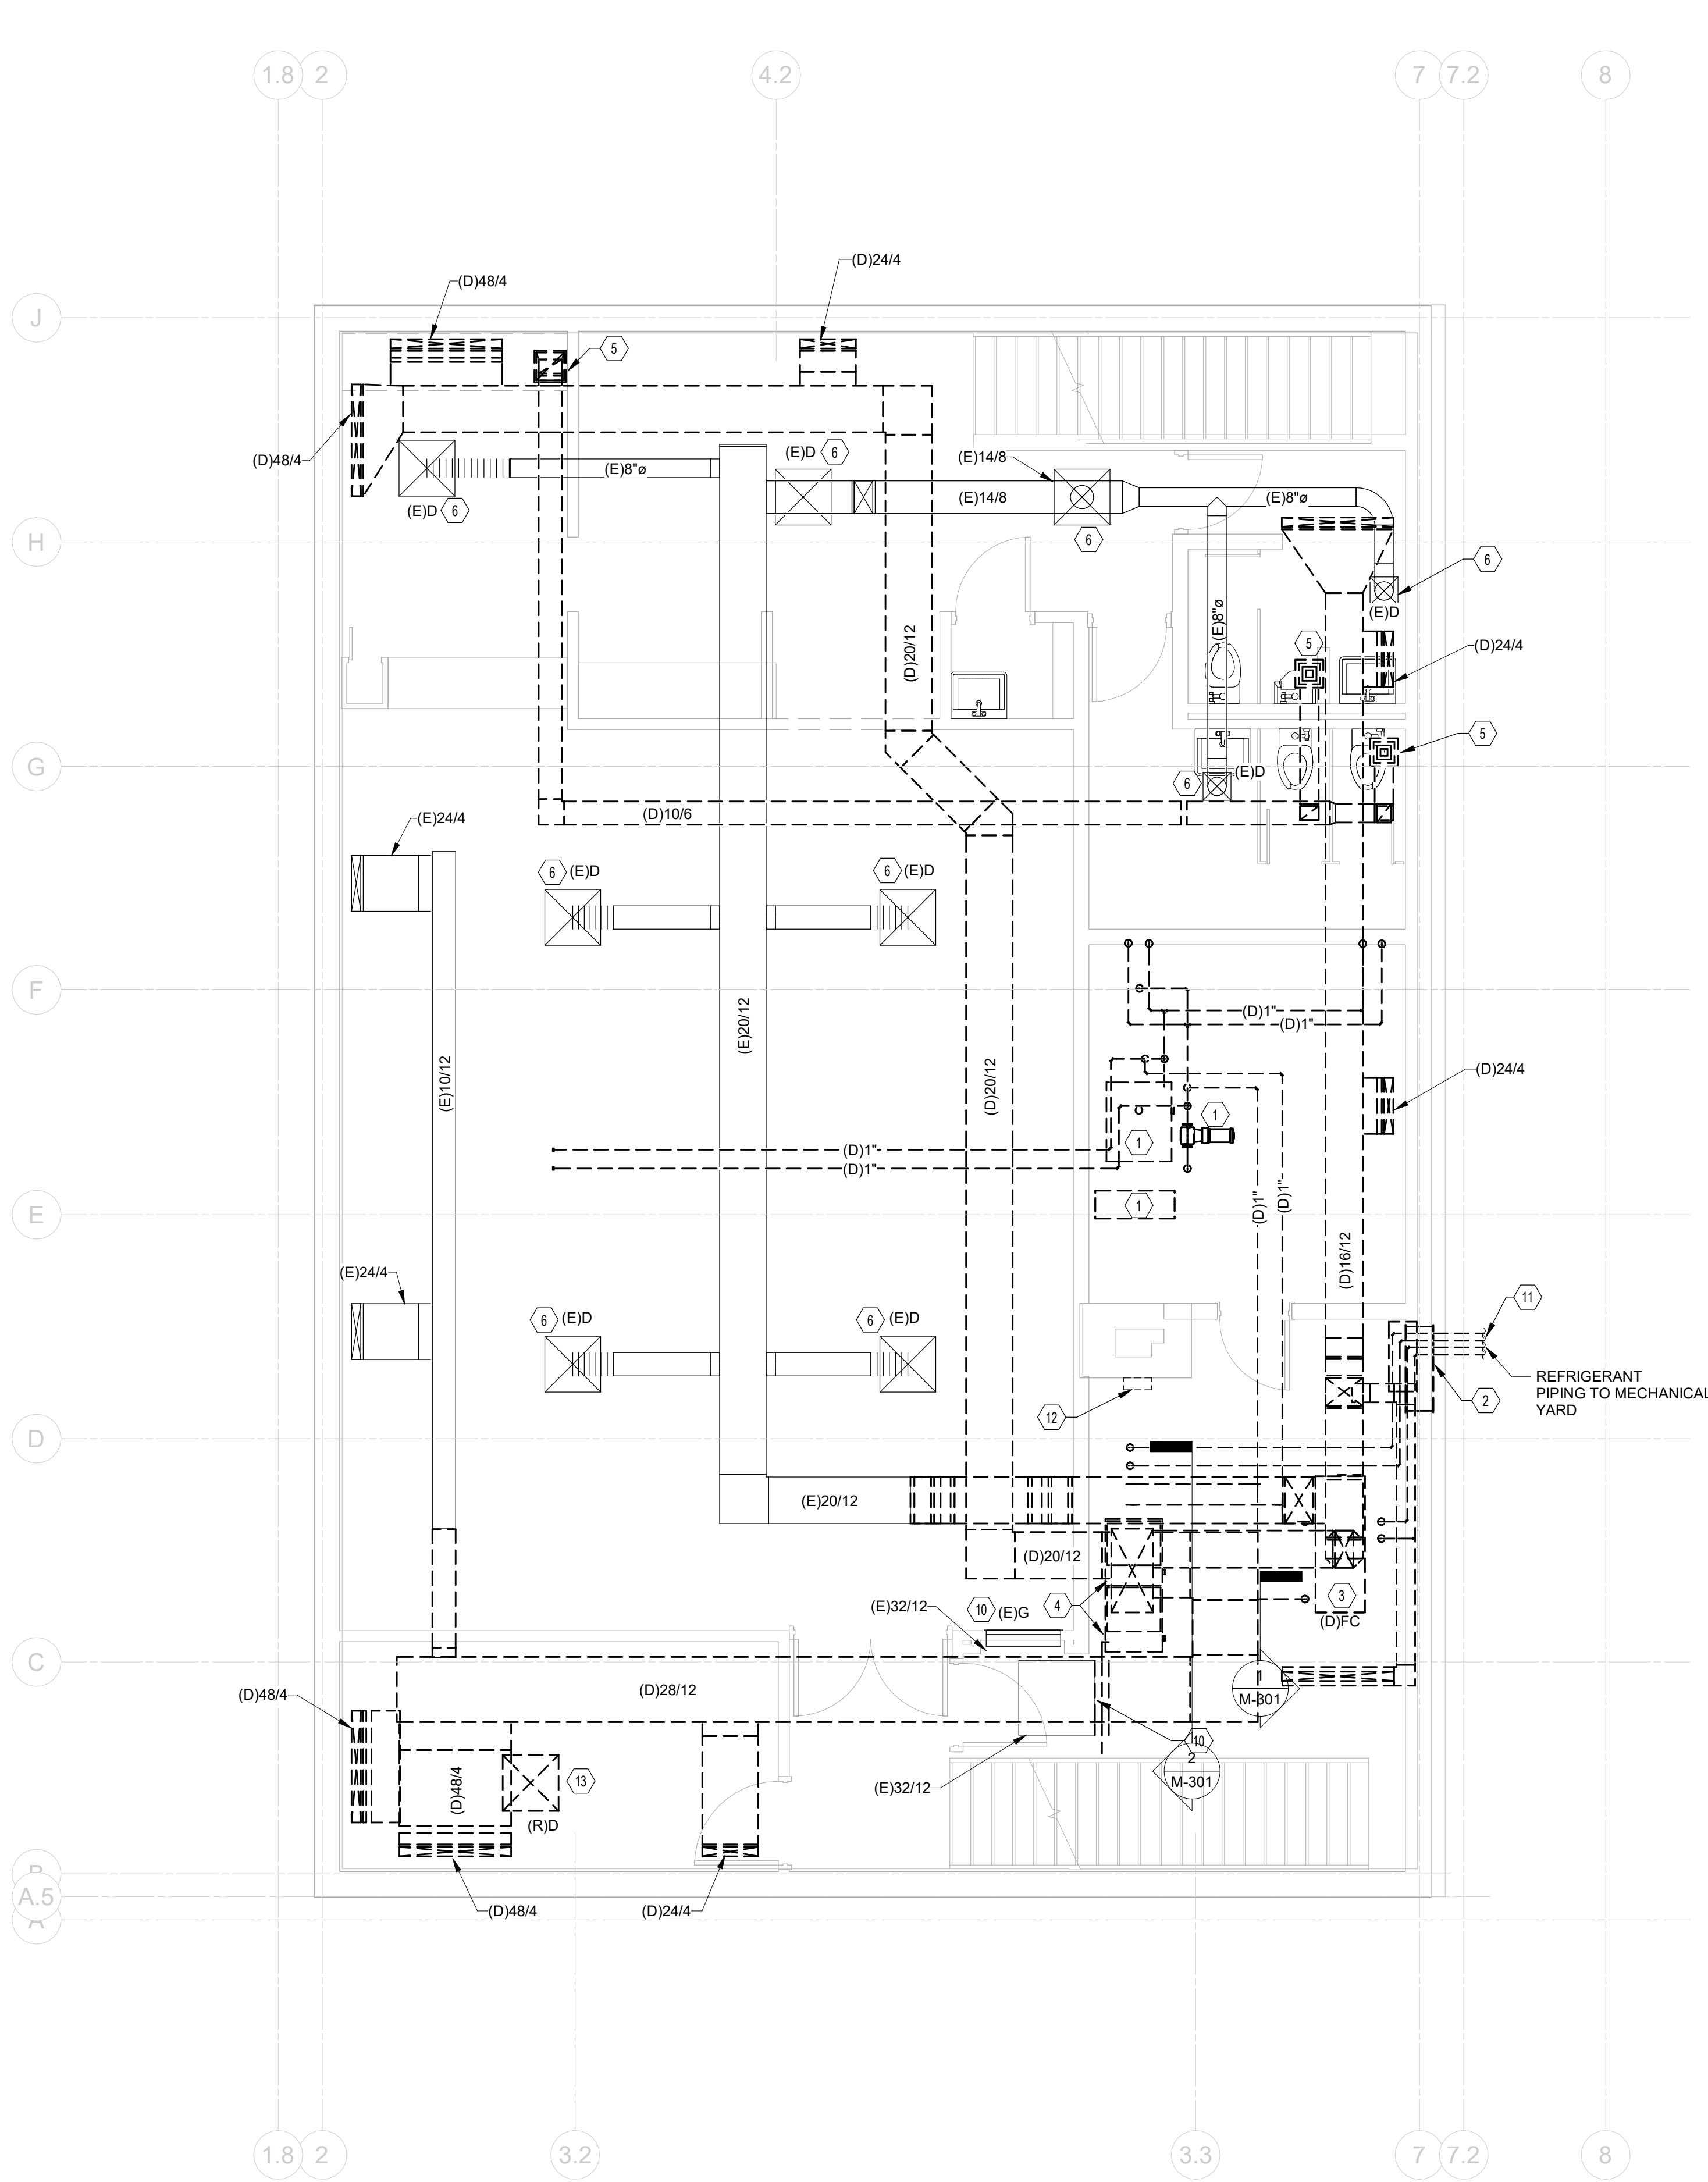
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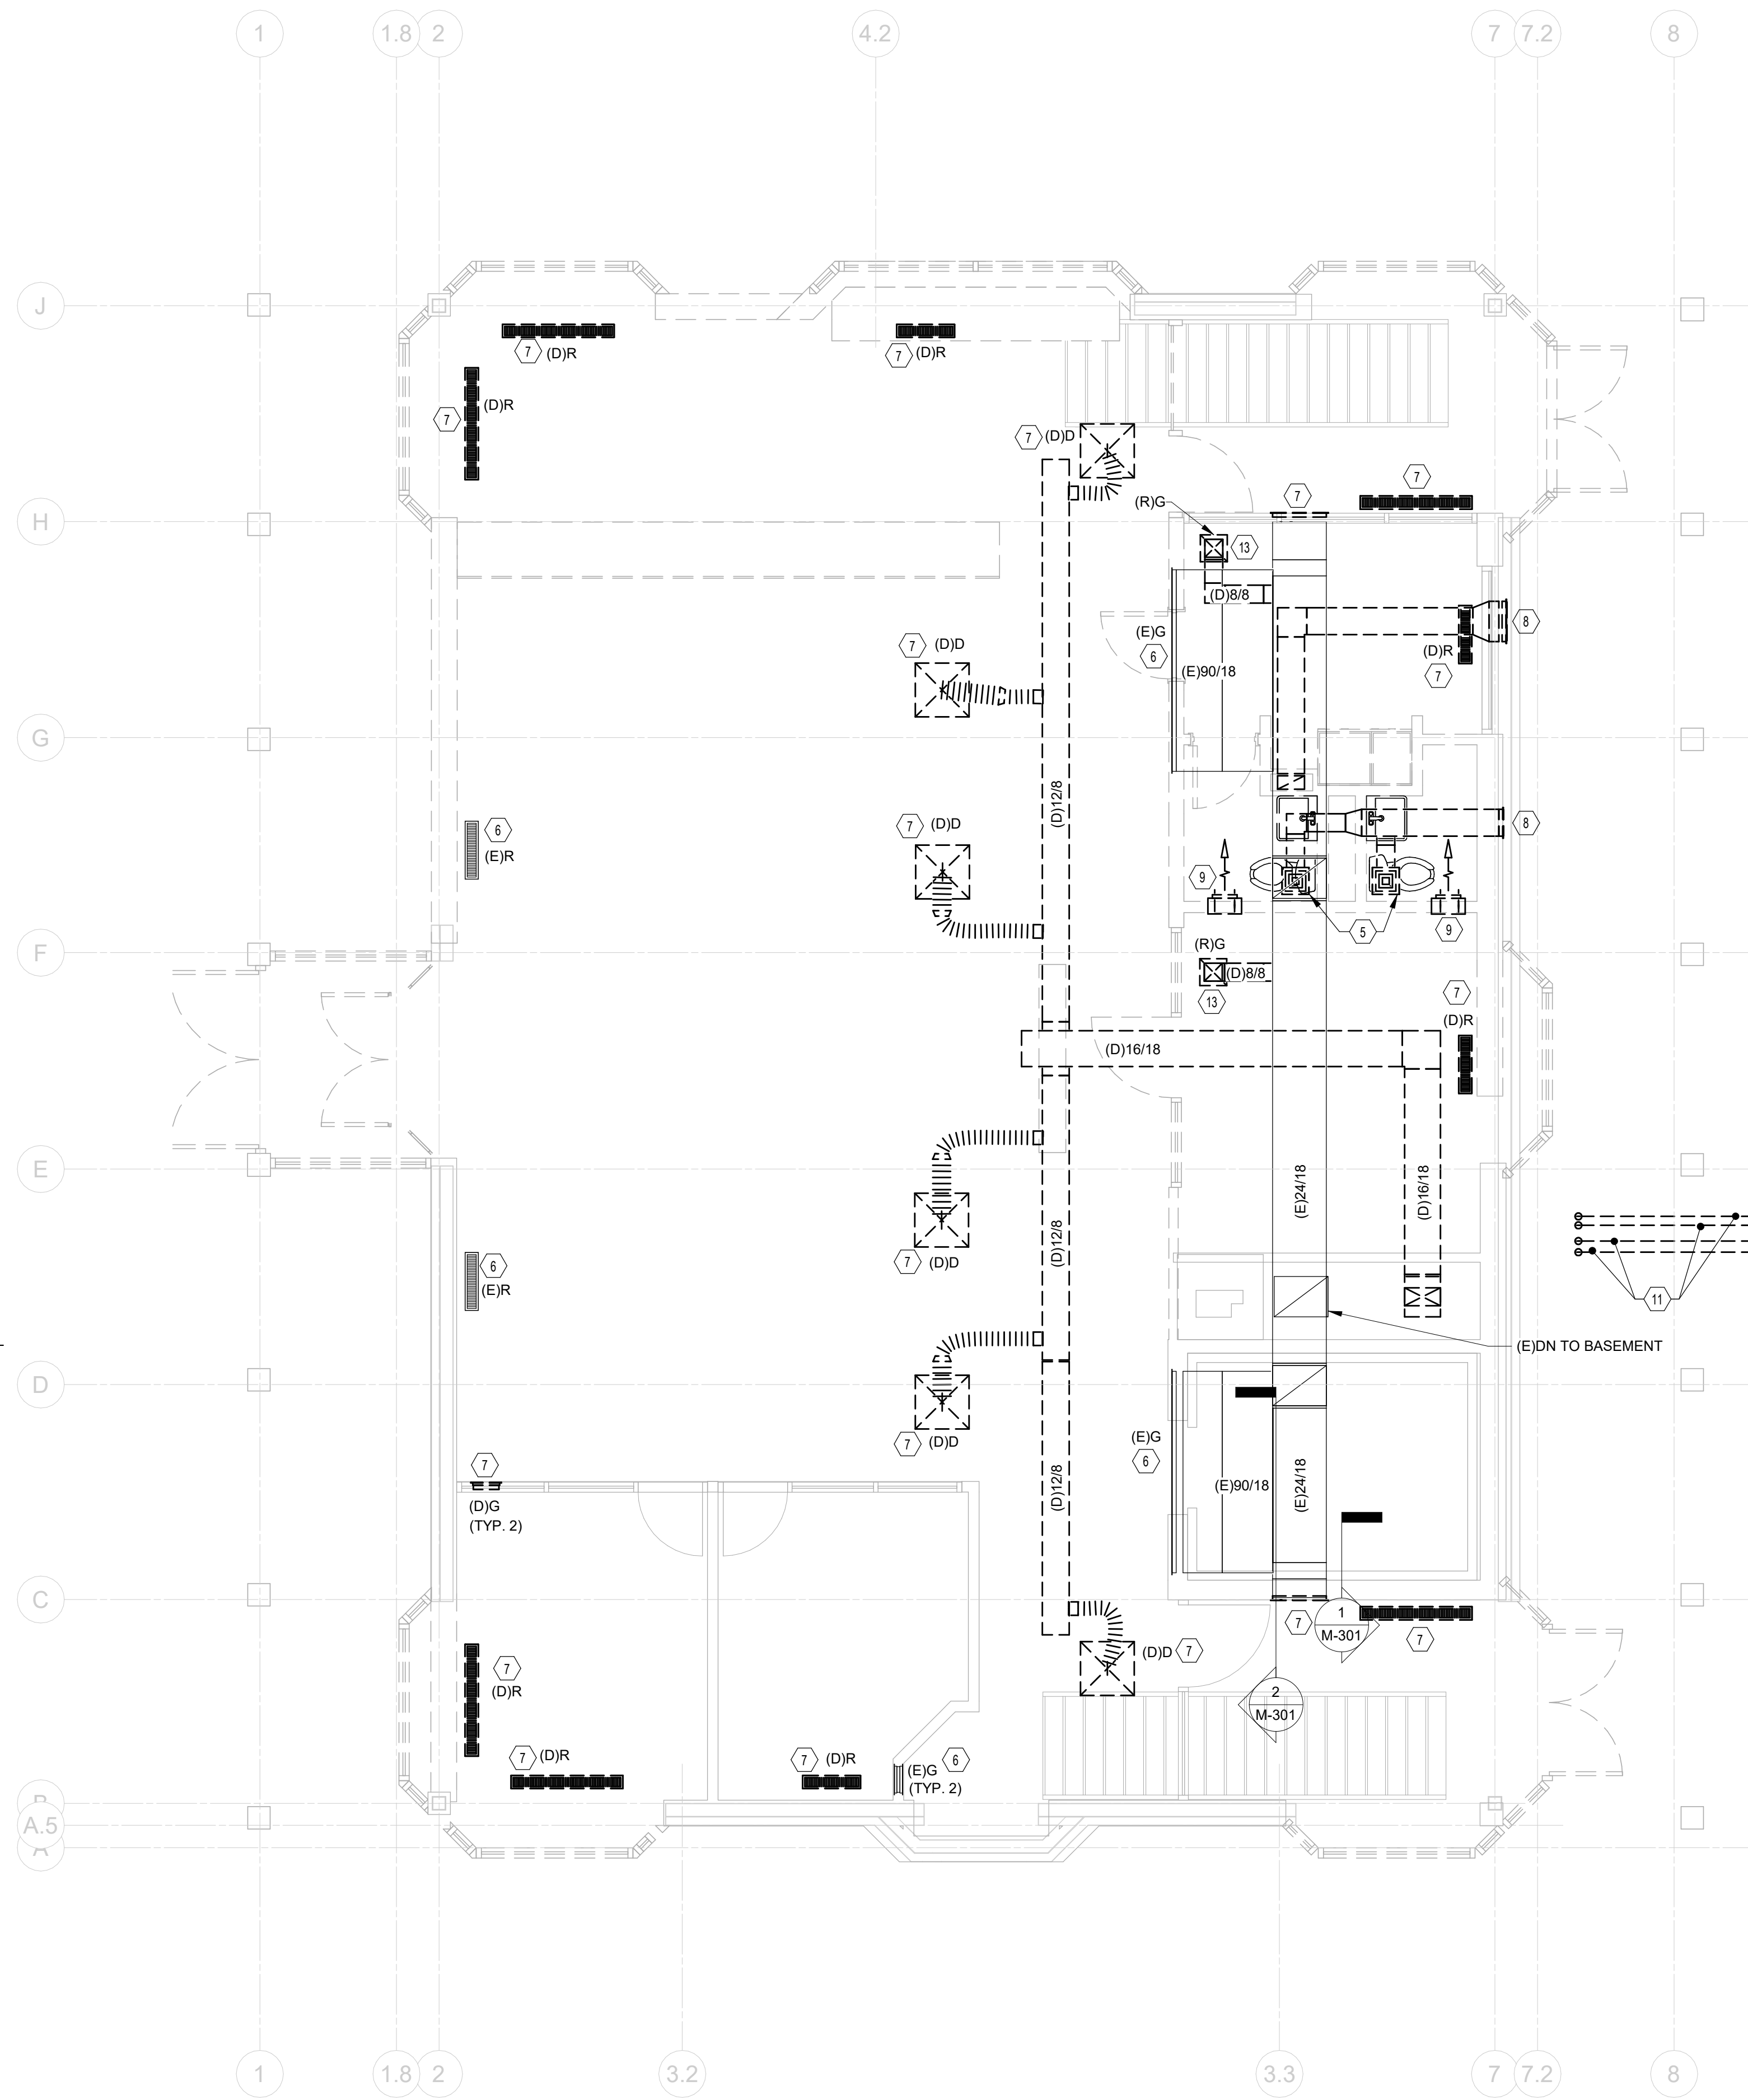
DRAWING TITLE:
GENERAL INFORMATION - MECHANICAL

PROGRESS DRAWING NOT FOR CONSTRUCTION	09/10/2020
	DRAWN BY: Author CHECKED BY: Checker
	2022
	M-001
	PRELIMINARY DEVELOPMENT PLAN

- CODED NOTES:**
1. DEMOLISH EXISTING BOILER, ASSOCIATED PIPING, IN-LINE PUMP, EXPANSION TANK AND ALL APPURTENANCES COMPLETE.
 2. DEMOLISH 6' H X 3' W OUTSIDE AIR LOUVER, DAMPER, AND ASSOCIATED DUCTWORK.
 3. DEMOLISH EXISTING FAN COIL UNITS, SUPPORTS, AND ALL APPURTENANCES COMPLETE.
 4. EXISTING TWINNED-FURNACES AND ASSOCIATED EVAPORATOR COILS TO BE REMOVED AND SALVAGED. RETURN TO OWNER.
 5. DEMOLISH EXISTING RESTROOM CABINET EXHAUST FAN.
 6. EXISTING AIR DEVICE TO REMAIN.
 7. DEMOLISH EXISTING AIR DEVICE.
 8. DEMOLISH EXISTING EXTERIOR SOFFIT EXHAUST VENTS, ASSOCIATED EXHAUST DUCTWORK, AND ALL APPURTENANCES COMPLETE.
 9. DEMOLISH EXISTING FINNED-TUBE HEATER AND ALL APPURTENANCES COMPLETE.
 10. EXISTING RETURN GRILLE AND ASSOCIATED DUCTWORK TO REMAIN. DEMOLISH ASSOCIATED PNEUMATIC DAMPER.
 11. DEMOLISH EXISTING REFRIGERANT PIPING, SUPPORTS, AND ALL APPURTENANCES COMPLETE.
 12. DEMOLISH EXISTING HVAC CONTROLS COMPLETE.
 13. RELOCATE EXISTING AIR DEVICE. REFER TO SHEET M-101 FOR NEW LOCATION.



1 PLAN BASEMENT FLOOR PLAN - MECHANICAL - DEMOLITION
1/4" = 1'-0"



2 PLAN FIRST FLOOR PLAN - MECHANICAL - DEMOLITION
1/4" = 1'-0"

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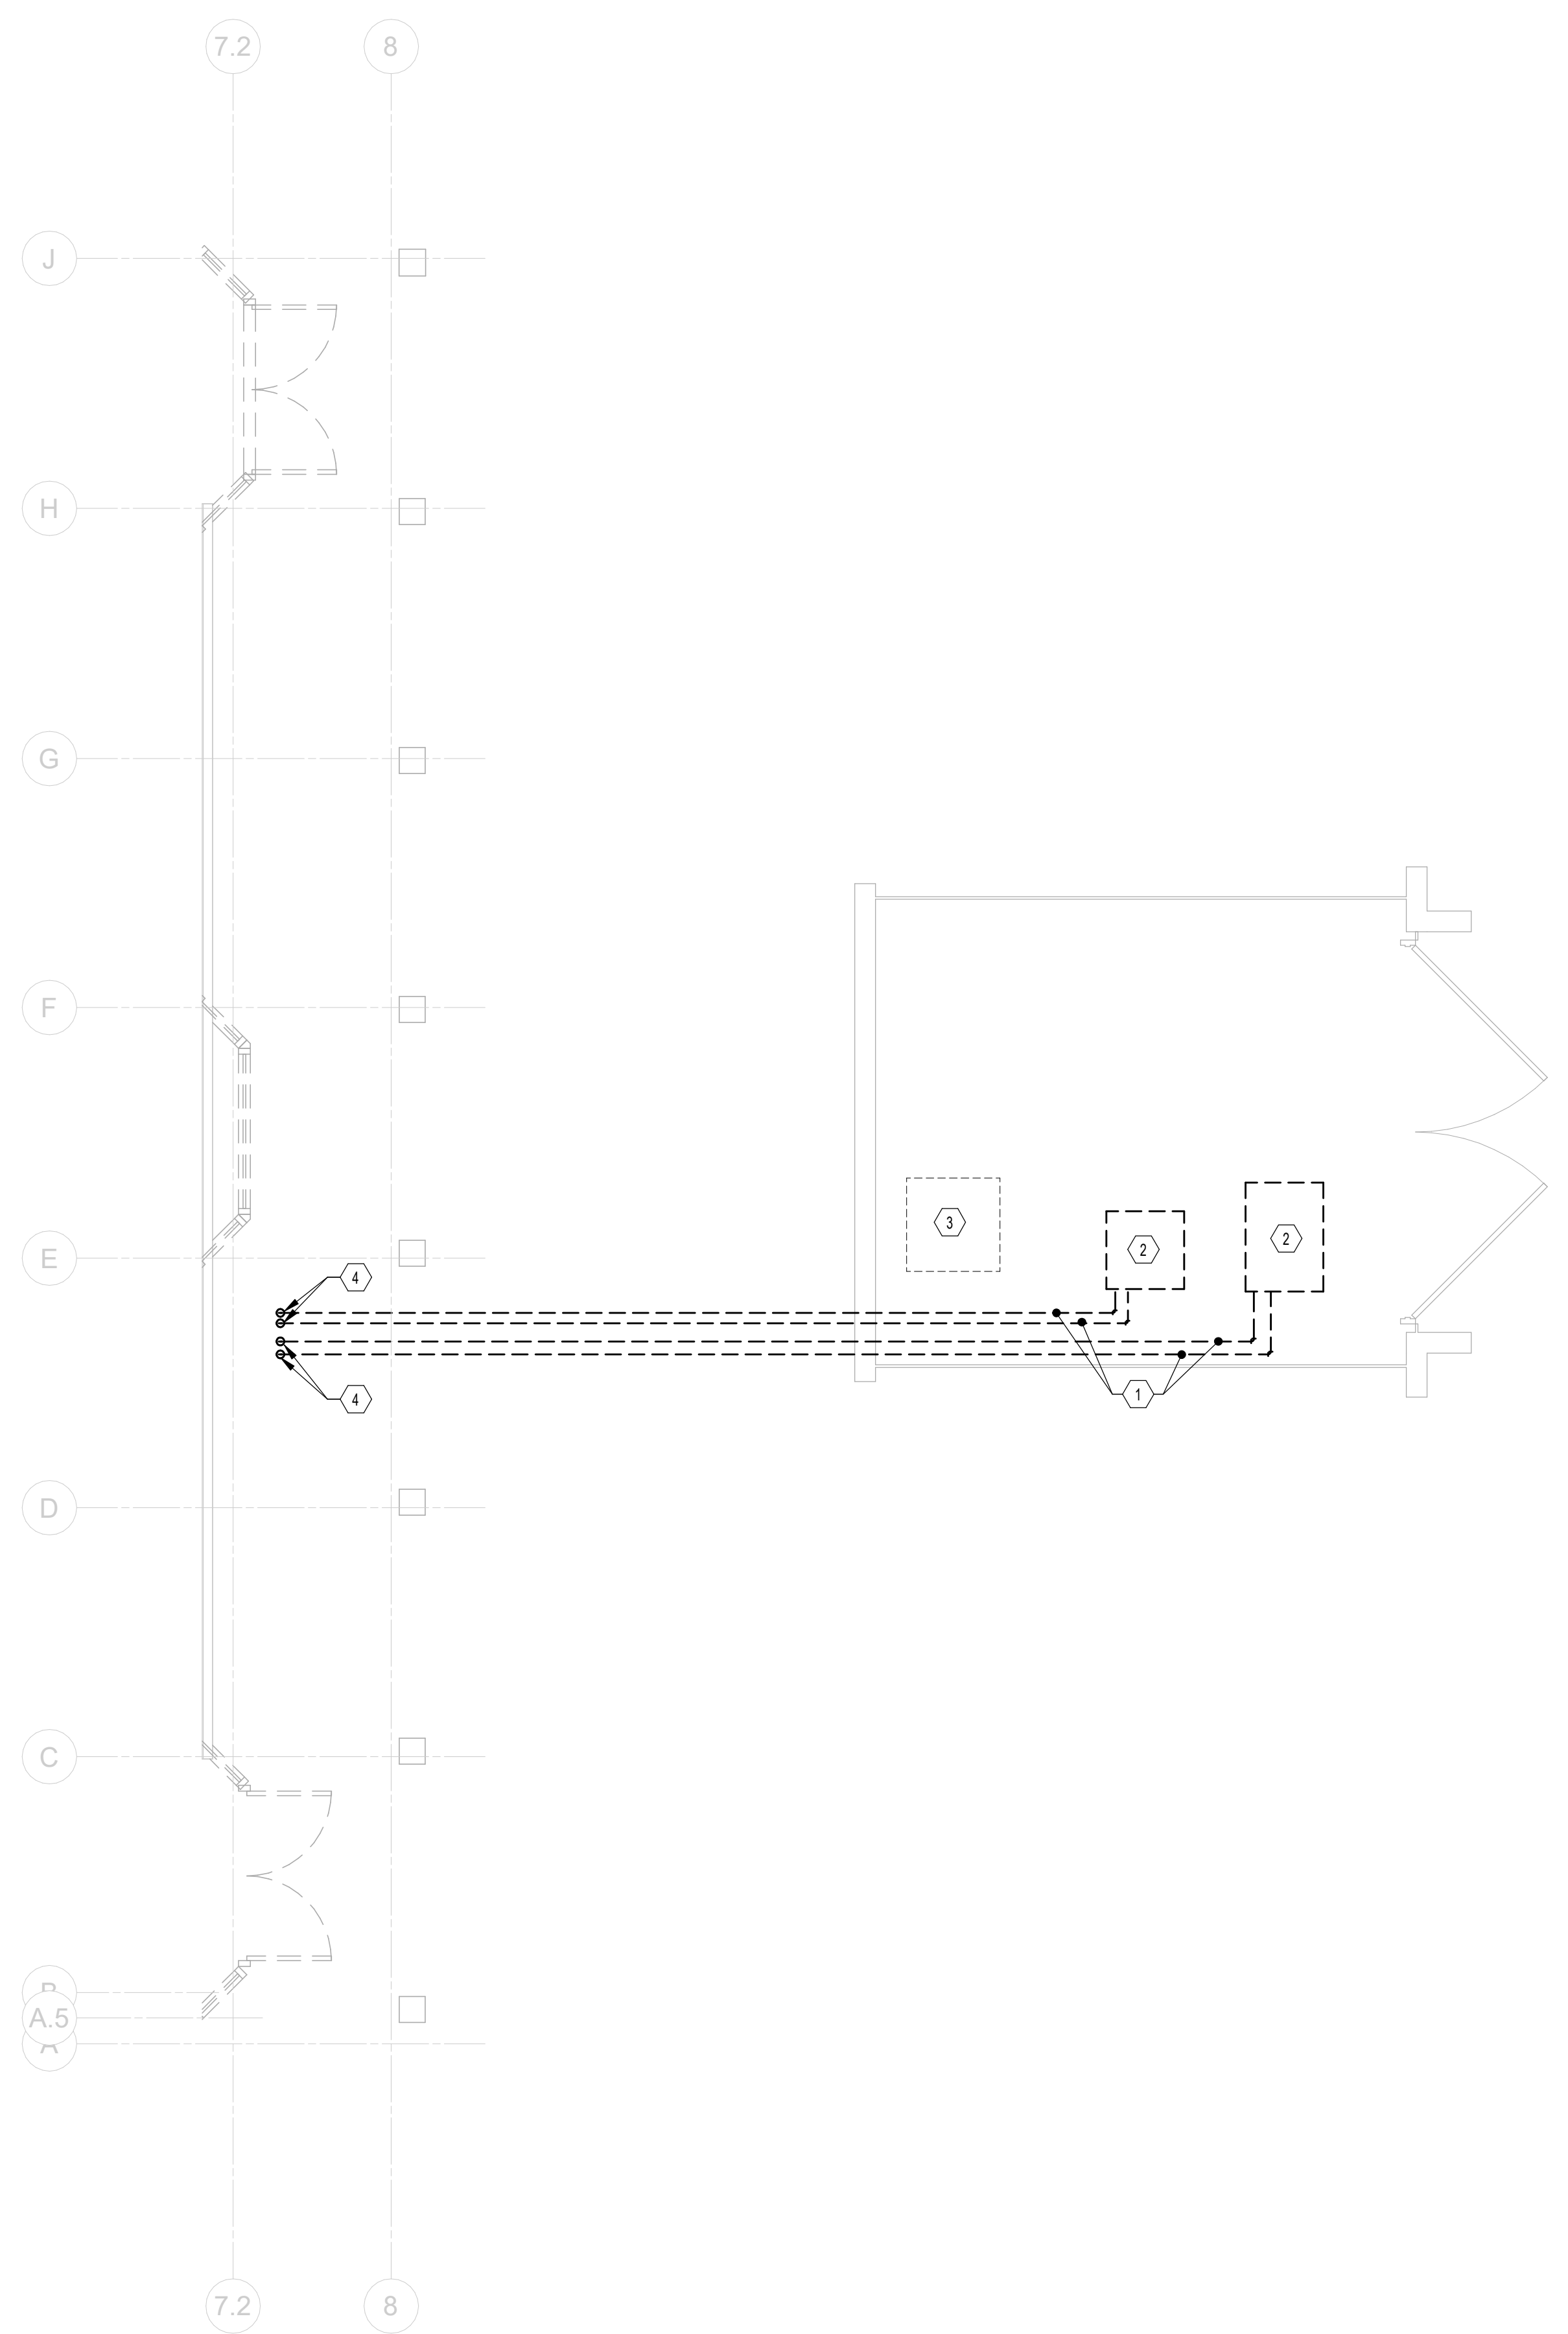
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FLOOR PLANS - MECHANICAL - DEMOLITION

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MD101	
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CODED NOTES:

1. DEMOLISH ABOVE AND BELOW GRADE REFRIGERANT PIPING, SUPPORTS, AND ALL APPURTENANCES COMPLETE.
2. REMOVE EXISTING CONDENSING UNIT AND SALVAGE. RETURN TO OWNER. DEMOLISH EXISTING ASSOCIATED CONCRETE PAD.
3. DEMOLISH EXISTING CONCRETE PAD COMPLETE.
4. REFER TO SHEET MD101 FOR CONTINUATION.



1 PLAN EQUIPMENT YARD PLAN - MECHANICAL - DEMOLITION
1/4" = 1'-0"

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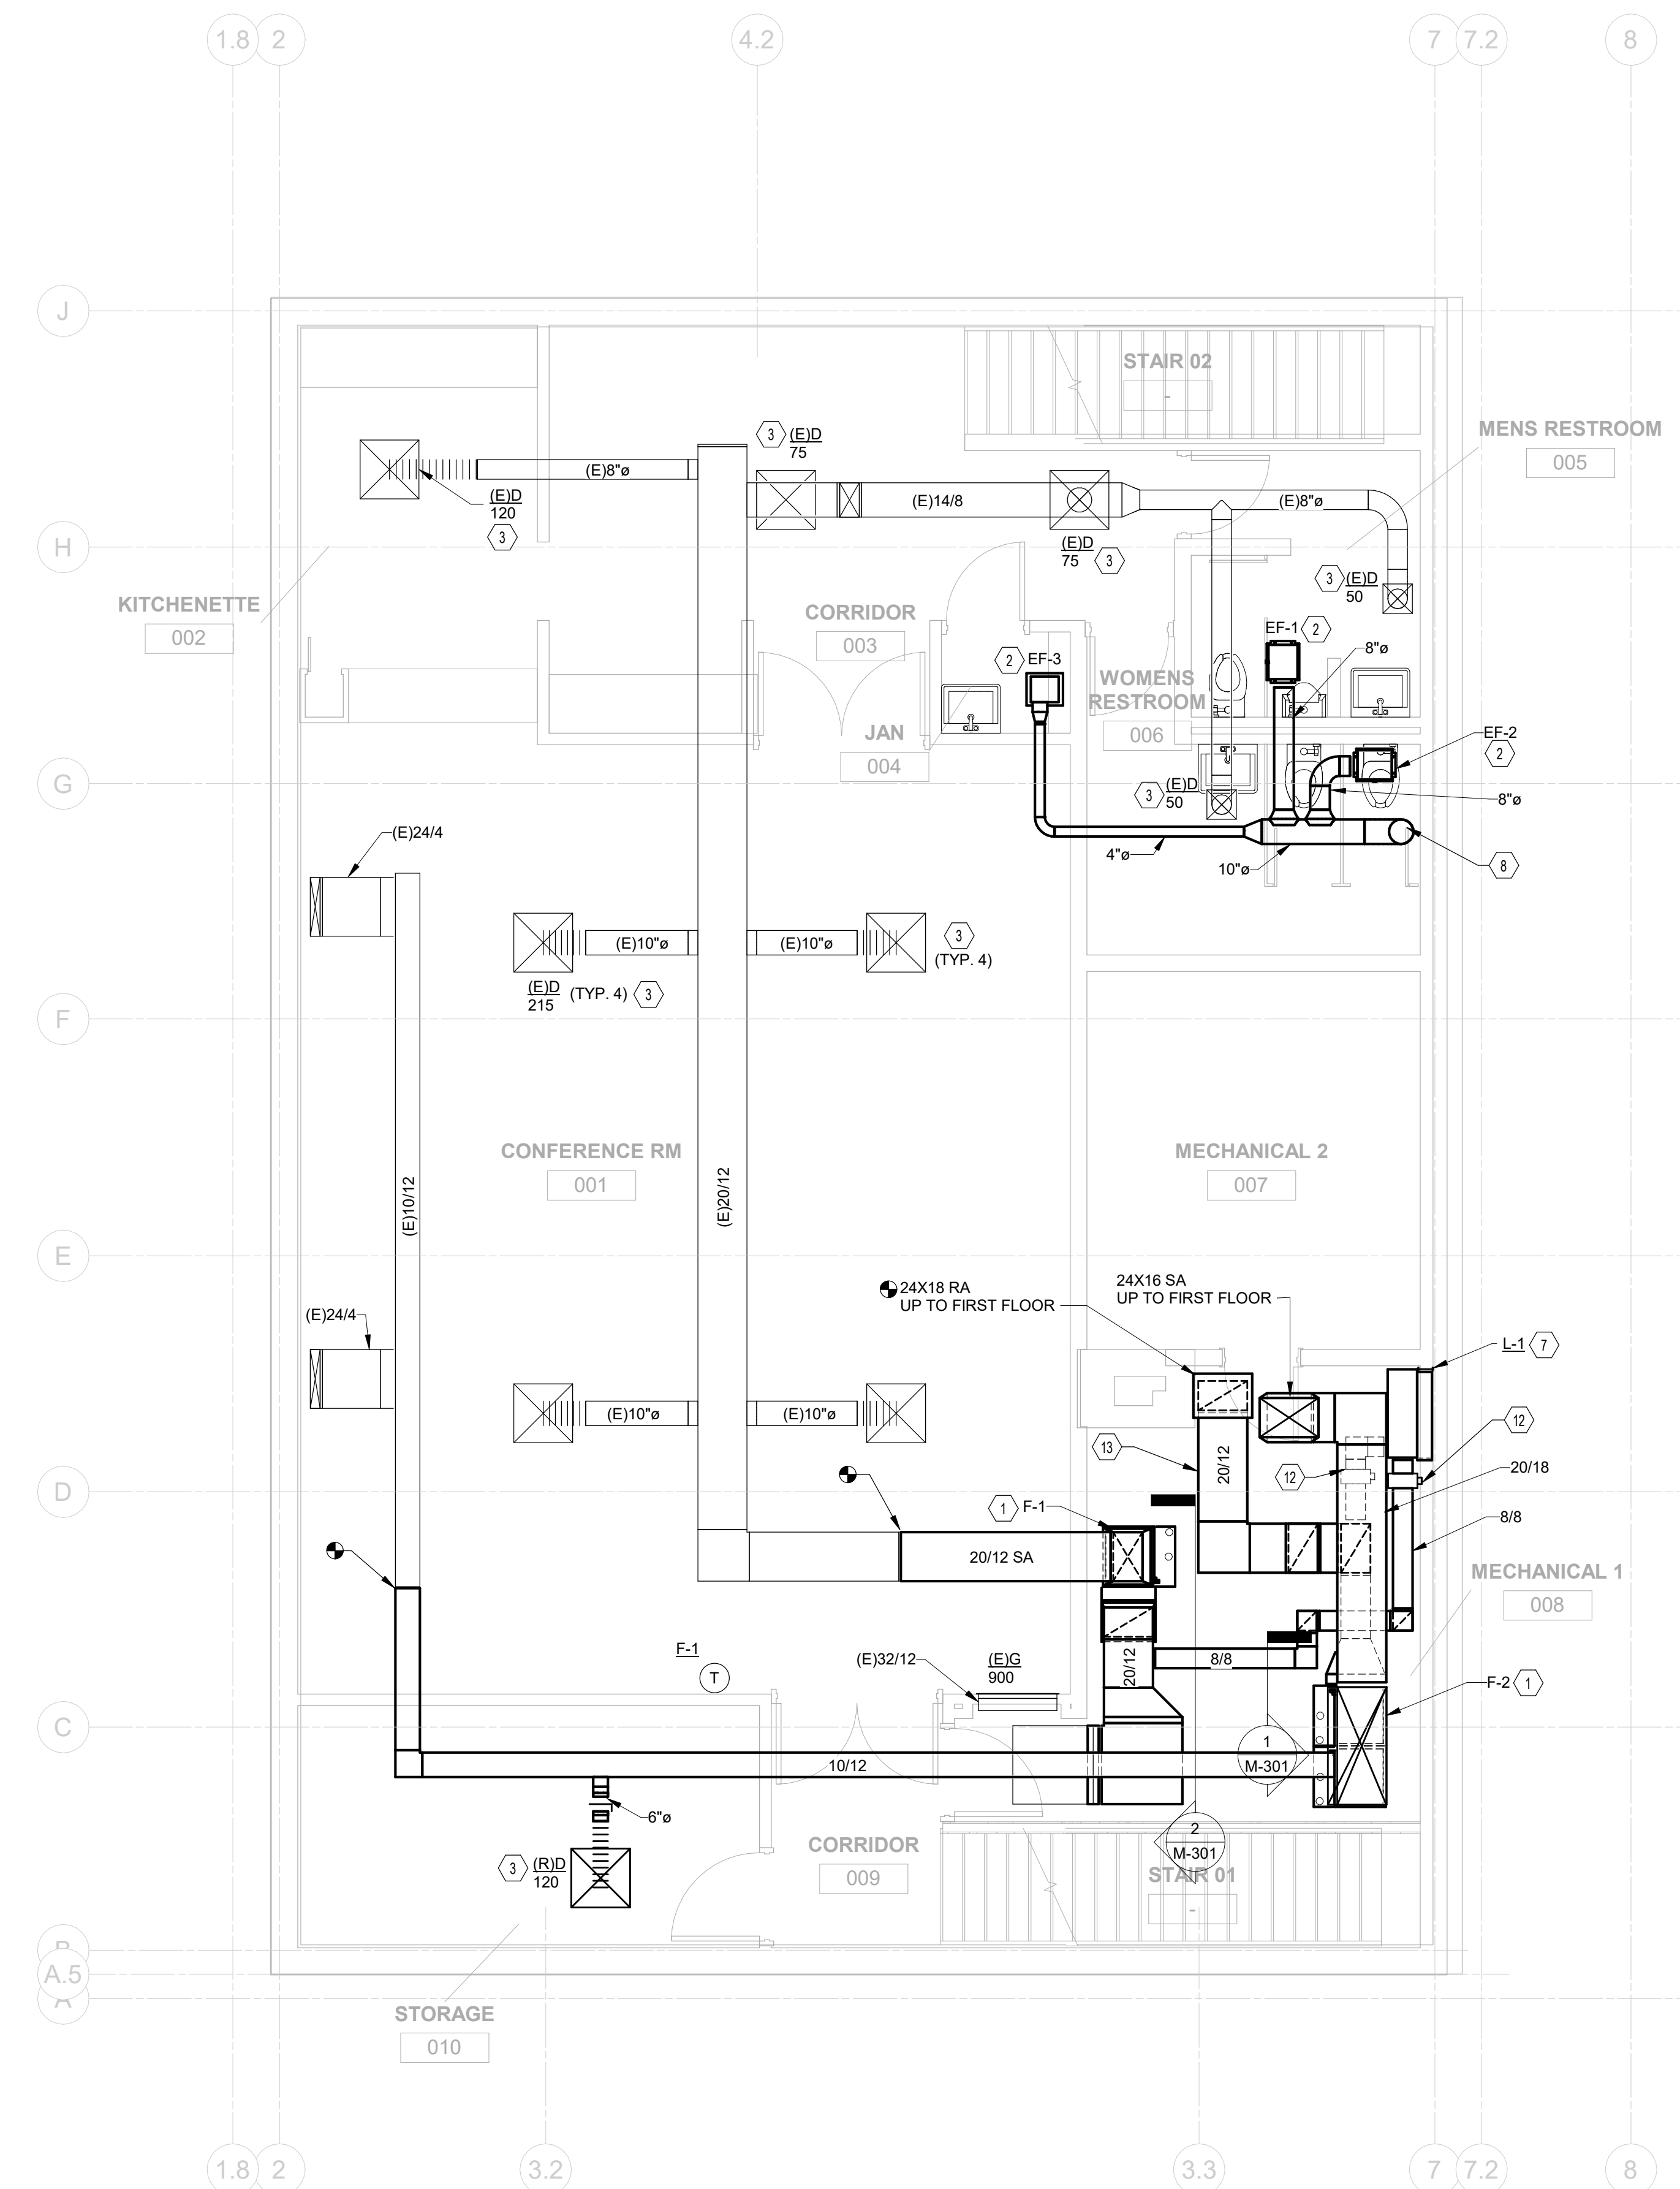
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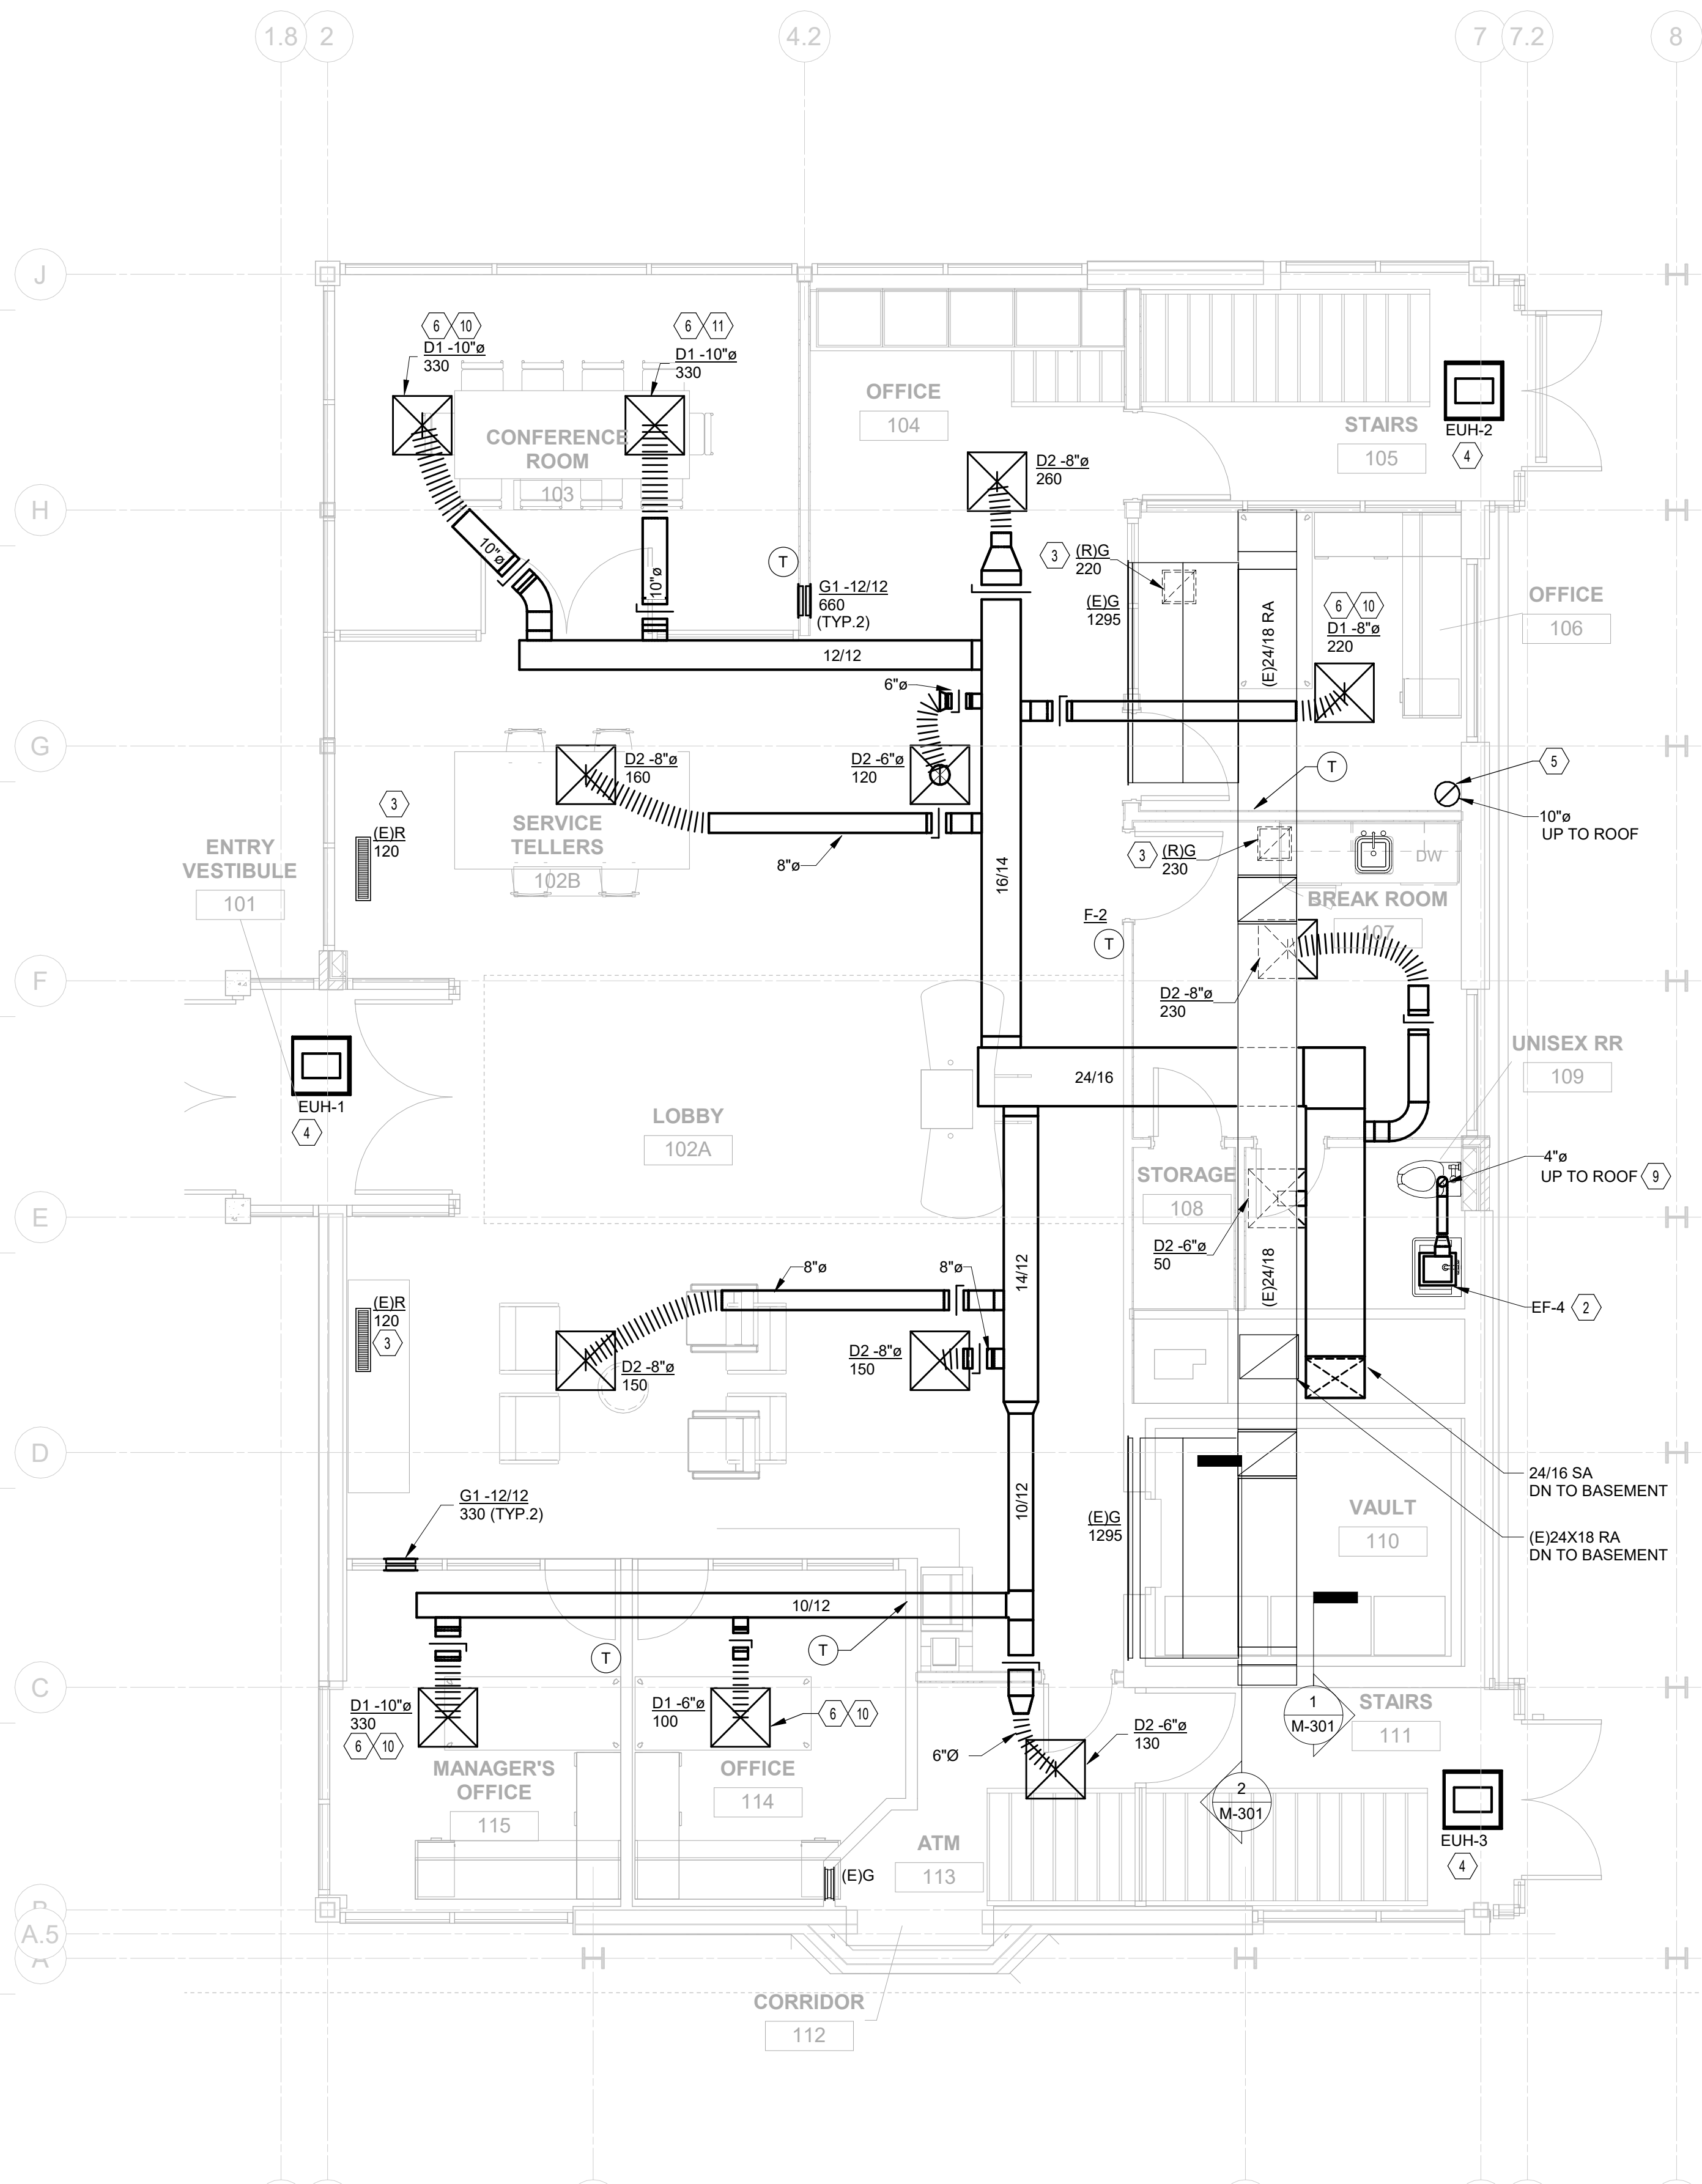
DRAWING TITLE:
ENLARGED PLANS - MECHANICAL - DEMOLITION

PROGRESS DRAWING NOT FOR CONSTRUCTION	09/10/2020
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	20022

MD401
PRELIMINARY DEVELOPMENT PLAN



1 PLAN BASEMENT FLOOR PLAN - MECHANICAL
1/4" = 1'-0"



2 PLAN FIRST FLOOR PLAN - MECHANICAL
1/4" = 1'-0"

- CODED NOTES:**
1. PROVIDE GAS-FIRED FURNACE AND EVAPORATOR COIL. PROVIDE EQUIPMENT PAD. REFER TO SCHEDULE SHEET FOR MORE INFORMATION. REFER TO DETAILS 4M-501 AND 5M-501.
 2. PROVIDE RESTROOM CABINET EXHAUST FAN. REFER TO SCHEDULE SHEET FOR MORE INFORMATION.
 3. REBALANCE RELOCATED/EXISTING AIR DEVICE TO INDICATED CFM.
 4. PROVIDE CEILING RECESSED ELECTRIC UNIT HEATER. REFER TO SCHEDULE SHEET FOR MORE INFORMATION.
 5. TERMINATE EXHAUST WITH PITCHED ROOF WALL CAP WITH 10"Ø EXTENSION EQUAL TO FAMCO BK10X.
 6. PROVIDED VAV DIFFUSER. REFER TO SCHEDULE SHEET FOR MORE INFORMATION. REFER TO SHEET M-701 FOR CONTROL INFORMATION.
 7. PROVIDE INTAKE AIR LOUVER L-1. PROVIDE SHEET METAL BLANK-OFF PANEL FOR REMAINING WALL OPENING. REFER TO SCHEDULE SHEET FOR MORE INFORMATION.
 8. 10"Ø EXHAUST DUCT UP TO FIRST FLOOR.
 9. TERMINATE EXHAUST DUCT THROUGH ROOF WITH PITCHED ROOF CAP. REFER TO SCHEDULE SHEET FOR MORE INFORMATION.
 10. MASTER VAV DIFFUSER FOR SPACE.
 11. DRONE VAV DIFFUSER FOR SPACE.
 12. PROVIDE 120V MOTORIZED OUTSIDE AIR DAMPER.
 13. DUCT SMOKE DETECTOR.


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 FOR
HEARTLAND BANK


MOODY-NOLAN
 300 SPRUCE STREET
 SUITE 300
 COLUMBUS, OHIO 43215
 PHONE: (614) 461-4664
 FAX: (614) 280-8881

FLOOR PLANS - HVAC

PROGRESS DRAWING NOT FOR CONSTRUCTION	09/10/2020	
	DRAWN BY: Author	CHECKED BY: Checker
	20022	
	M-101	
PRELIMINARY DEVELOPMENT PLAN		

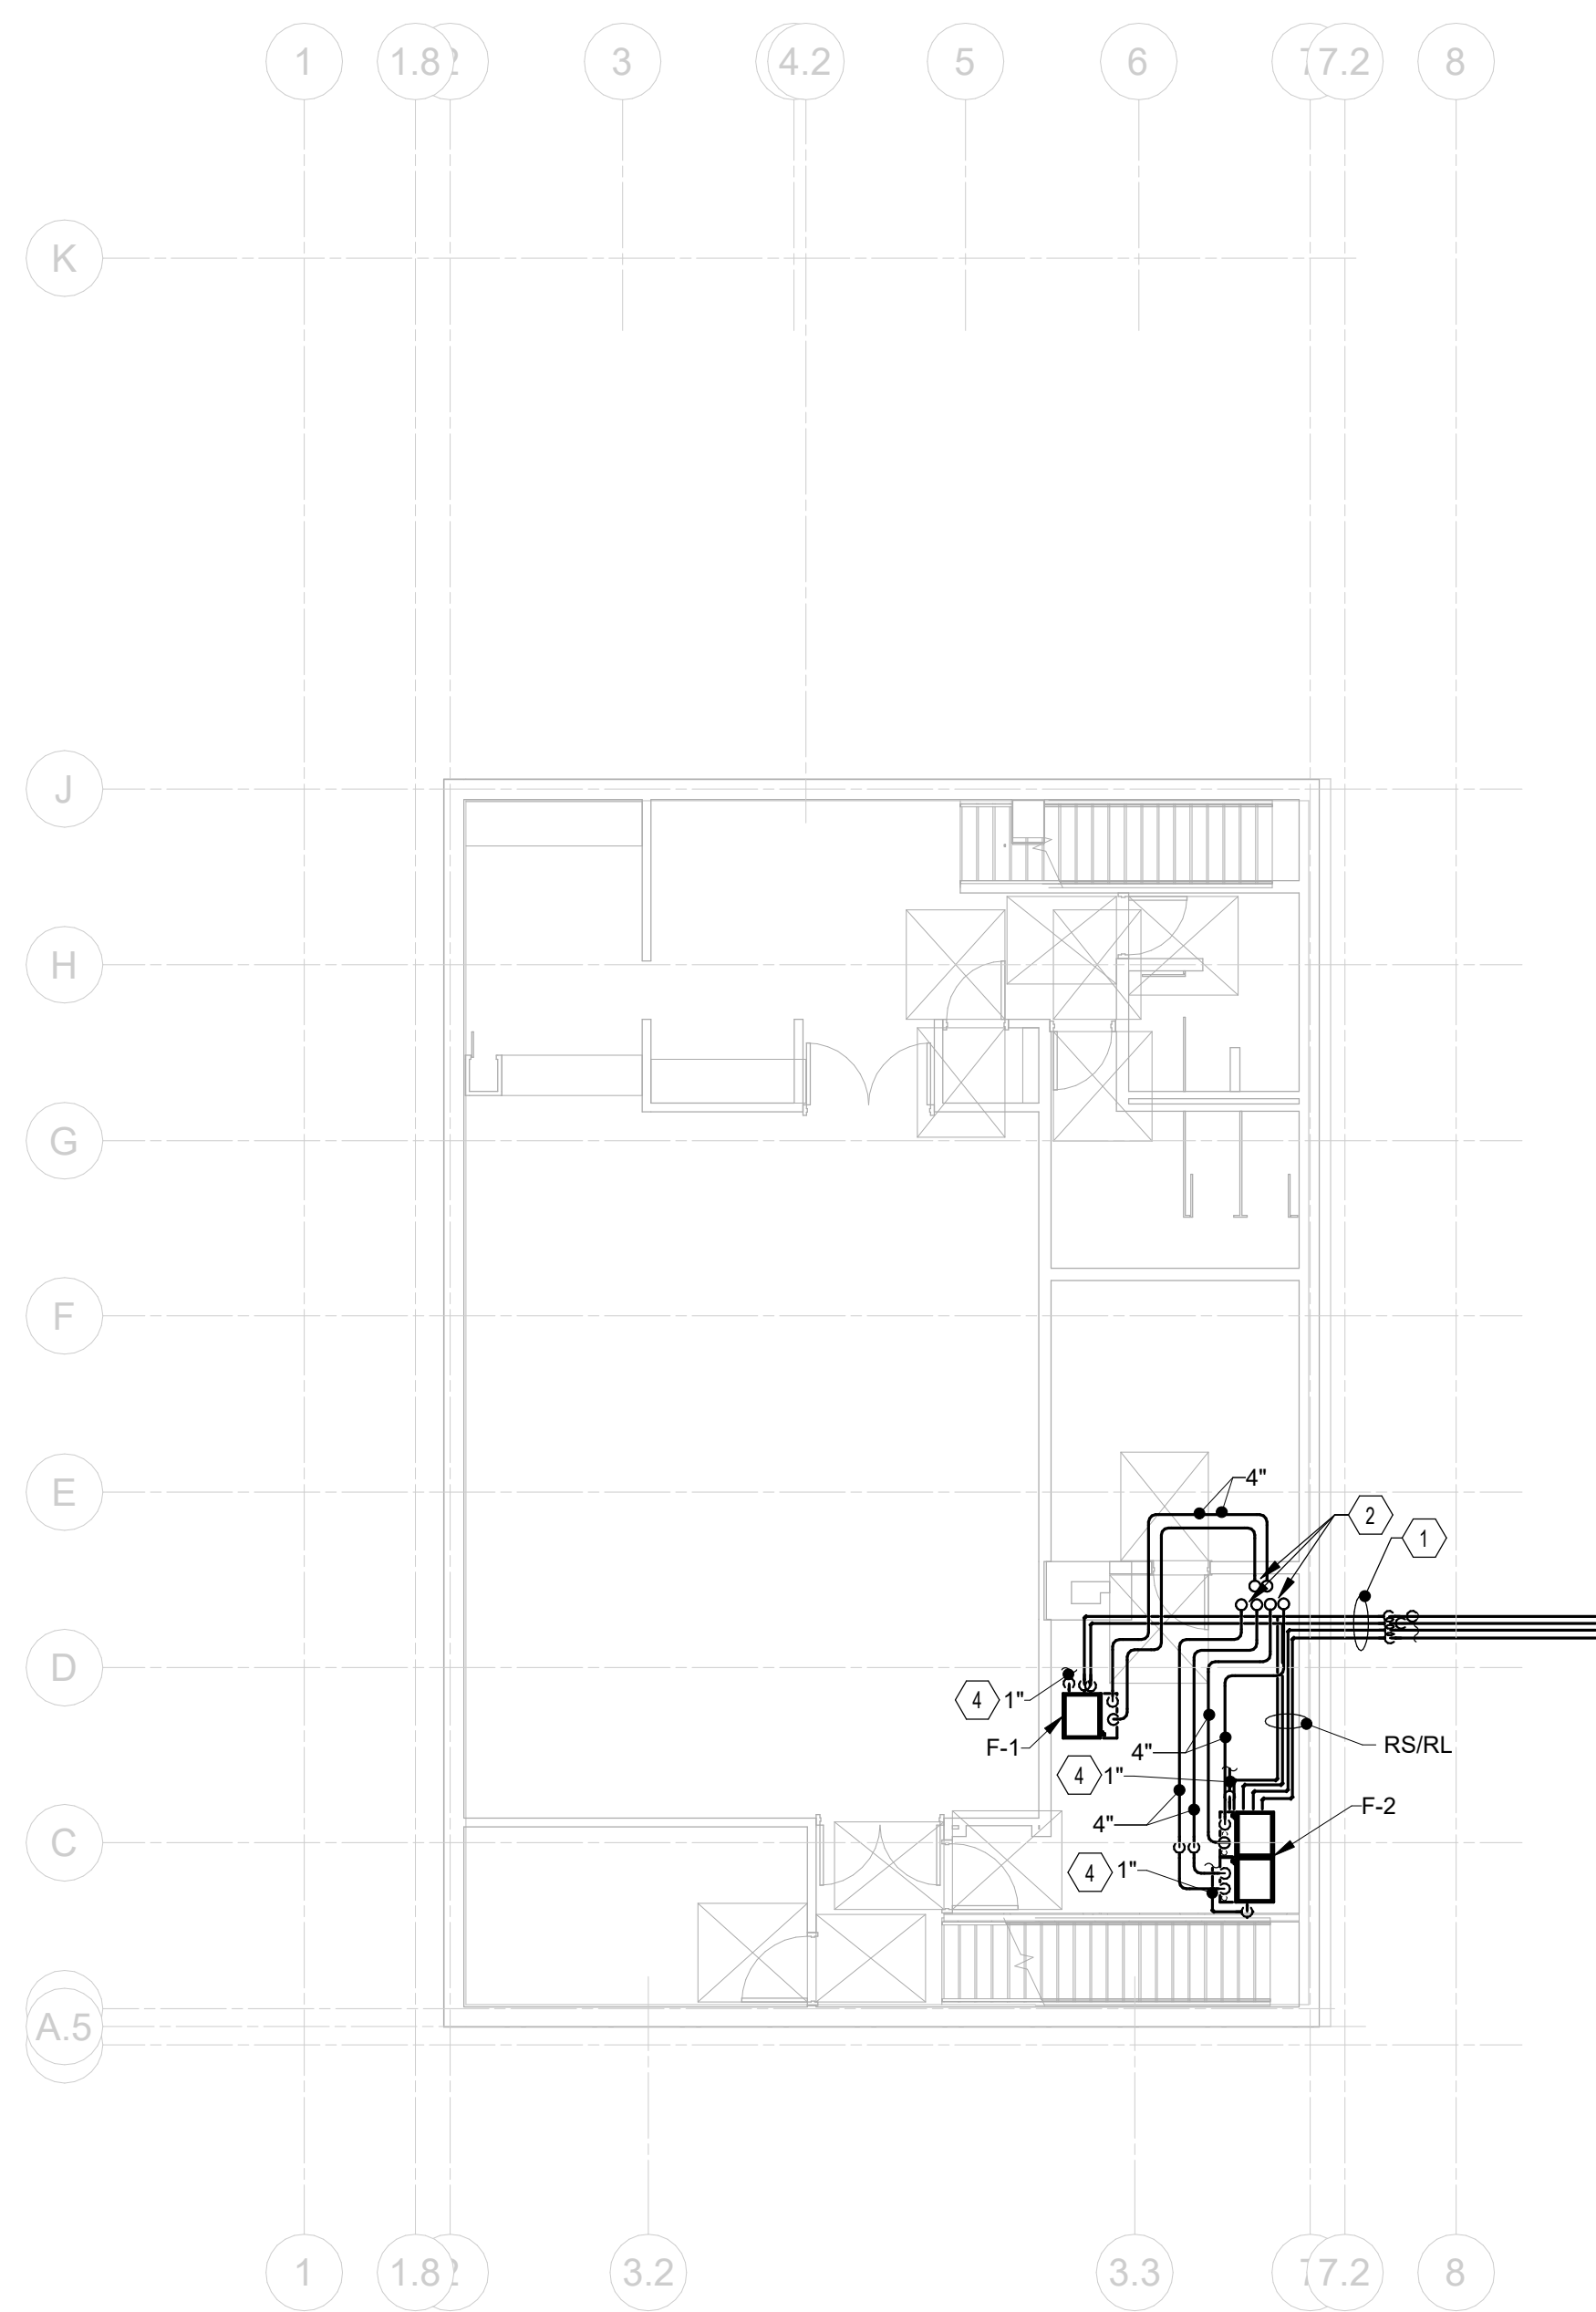

1 PLAN BASEMENT FLOOR PLAN - HVAC PIPING
1/8" = 1'-0"

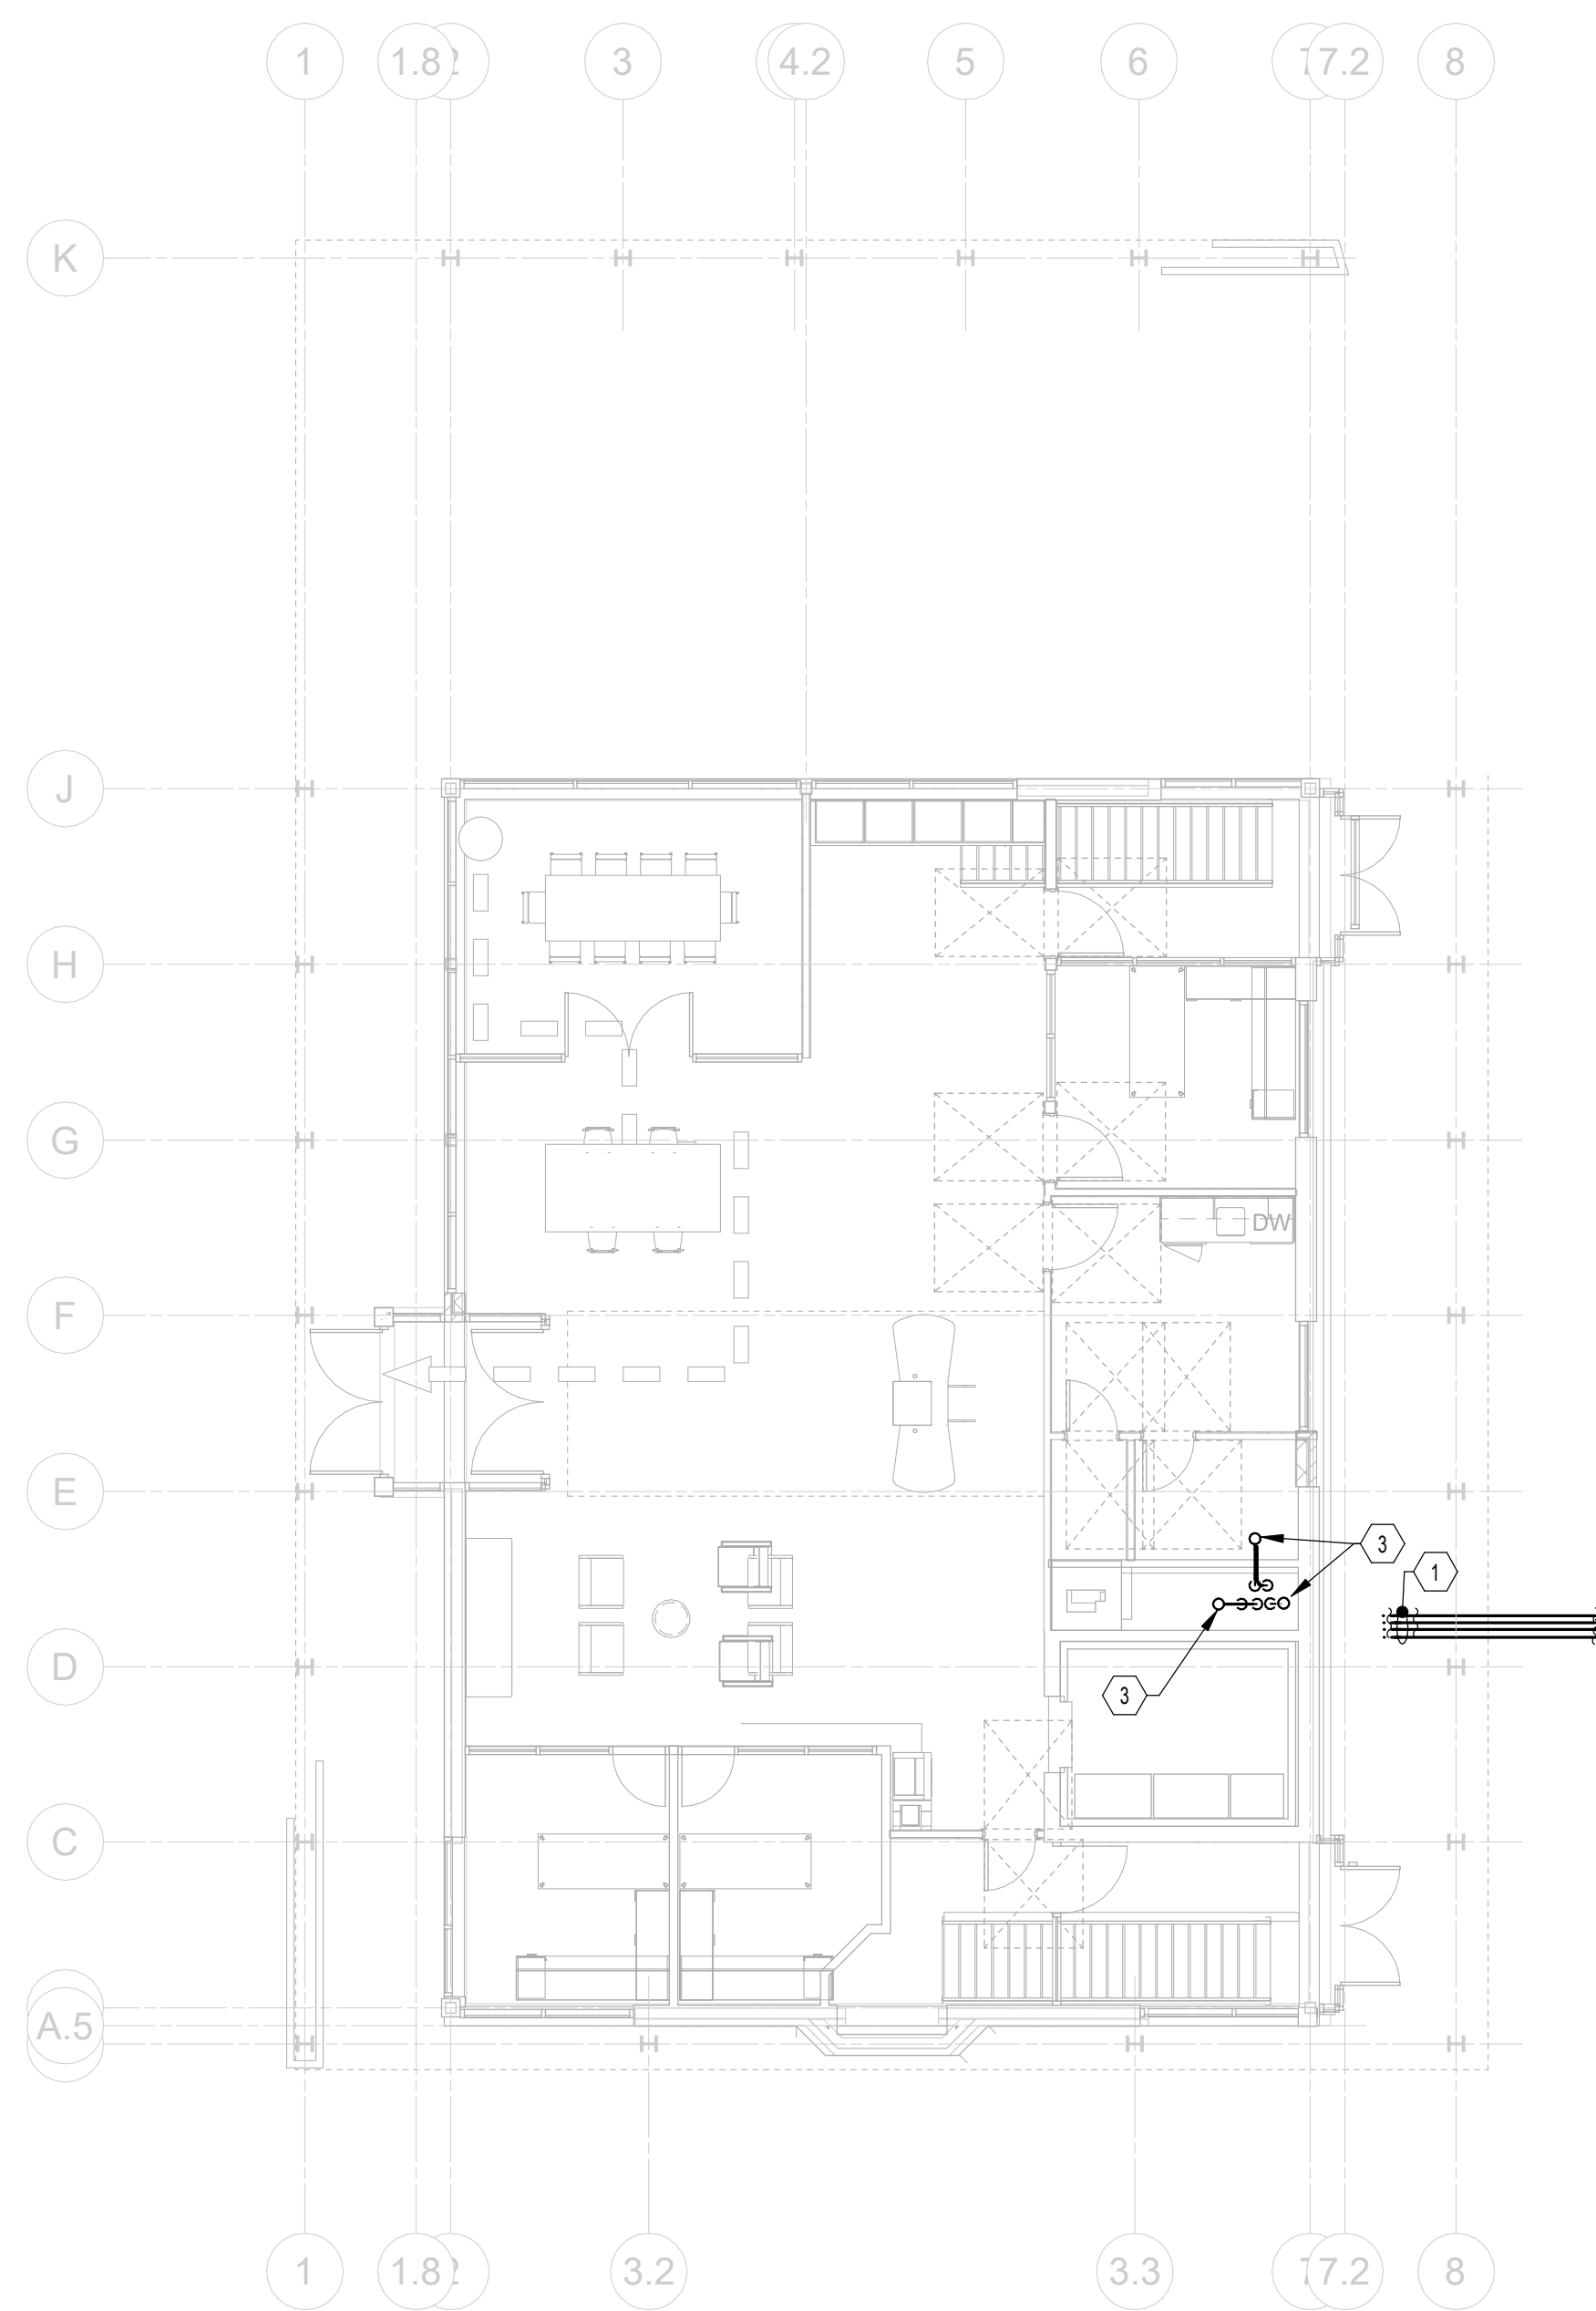

2 PLAN FIRST FLOOR PLAN - HVAC PIPING
1/8" = 1'-0"

CODED NOTES:

1. ROUTE REFRIGERANT PIPING FROM INDOOR EVAPORATOR COILS TO AIR-COOLED CONDENSING UNIT. REFRIGERANT PIPING SHALL ROUTE THROUGH INSULATED BLANK OFF PANEL AND INTO EXISTING AREAWELL. SEAL PENETRATIONS THROUGH BLANK OFF PANEL WATERTIGHT. INSTALL PER MANUFACTURERS RECOMMENDATIONS. REFER TO SHEET M-401 FOR CONTINUATION.
2. ROUTE COMBUSTION AIR INTAKE/VENT PIPING UP THROUGH EXISTING CHASE.
3. TERMINATE COMBUSTION AIR INTAKE/VENT PIPING THROUGH ROOF WITH 4" CONCENTRIC VENT KIT. INSTALL PER MANUFACTURERS RECOMMENDATIONS. REFER TO DETAILS 2/M-502 AND 7/M-502.
4. ROUTE 1" CONDENSATE PIPE TO NEAREST FLOOR DRAIN.


#	DATE	CHANGE DESCRIPTION

RENOVATION OF HEARTLAND BANK DUBLIN
6500 FRANTZ ROAD
DUBLIN, OH 43017
FOR
HEARTLAND BANK


MOODY-NOLAN
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DRAWING TITLE:
FLOOR PLANS - HVAC PIPING

PROGRESS DRAWING NOT FOR CONSTRUCTION	09/10/2020
	DRAWN BY: Author CHECKED BY: Checker
	20022
	M-201
PRELIMINARY DEVELOPMENT PLAN	

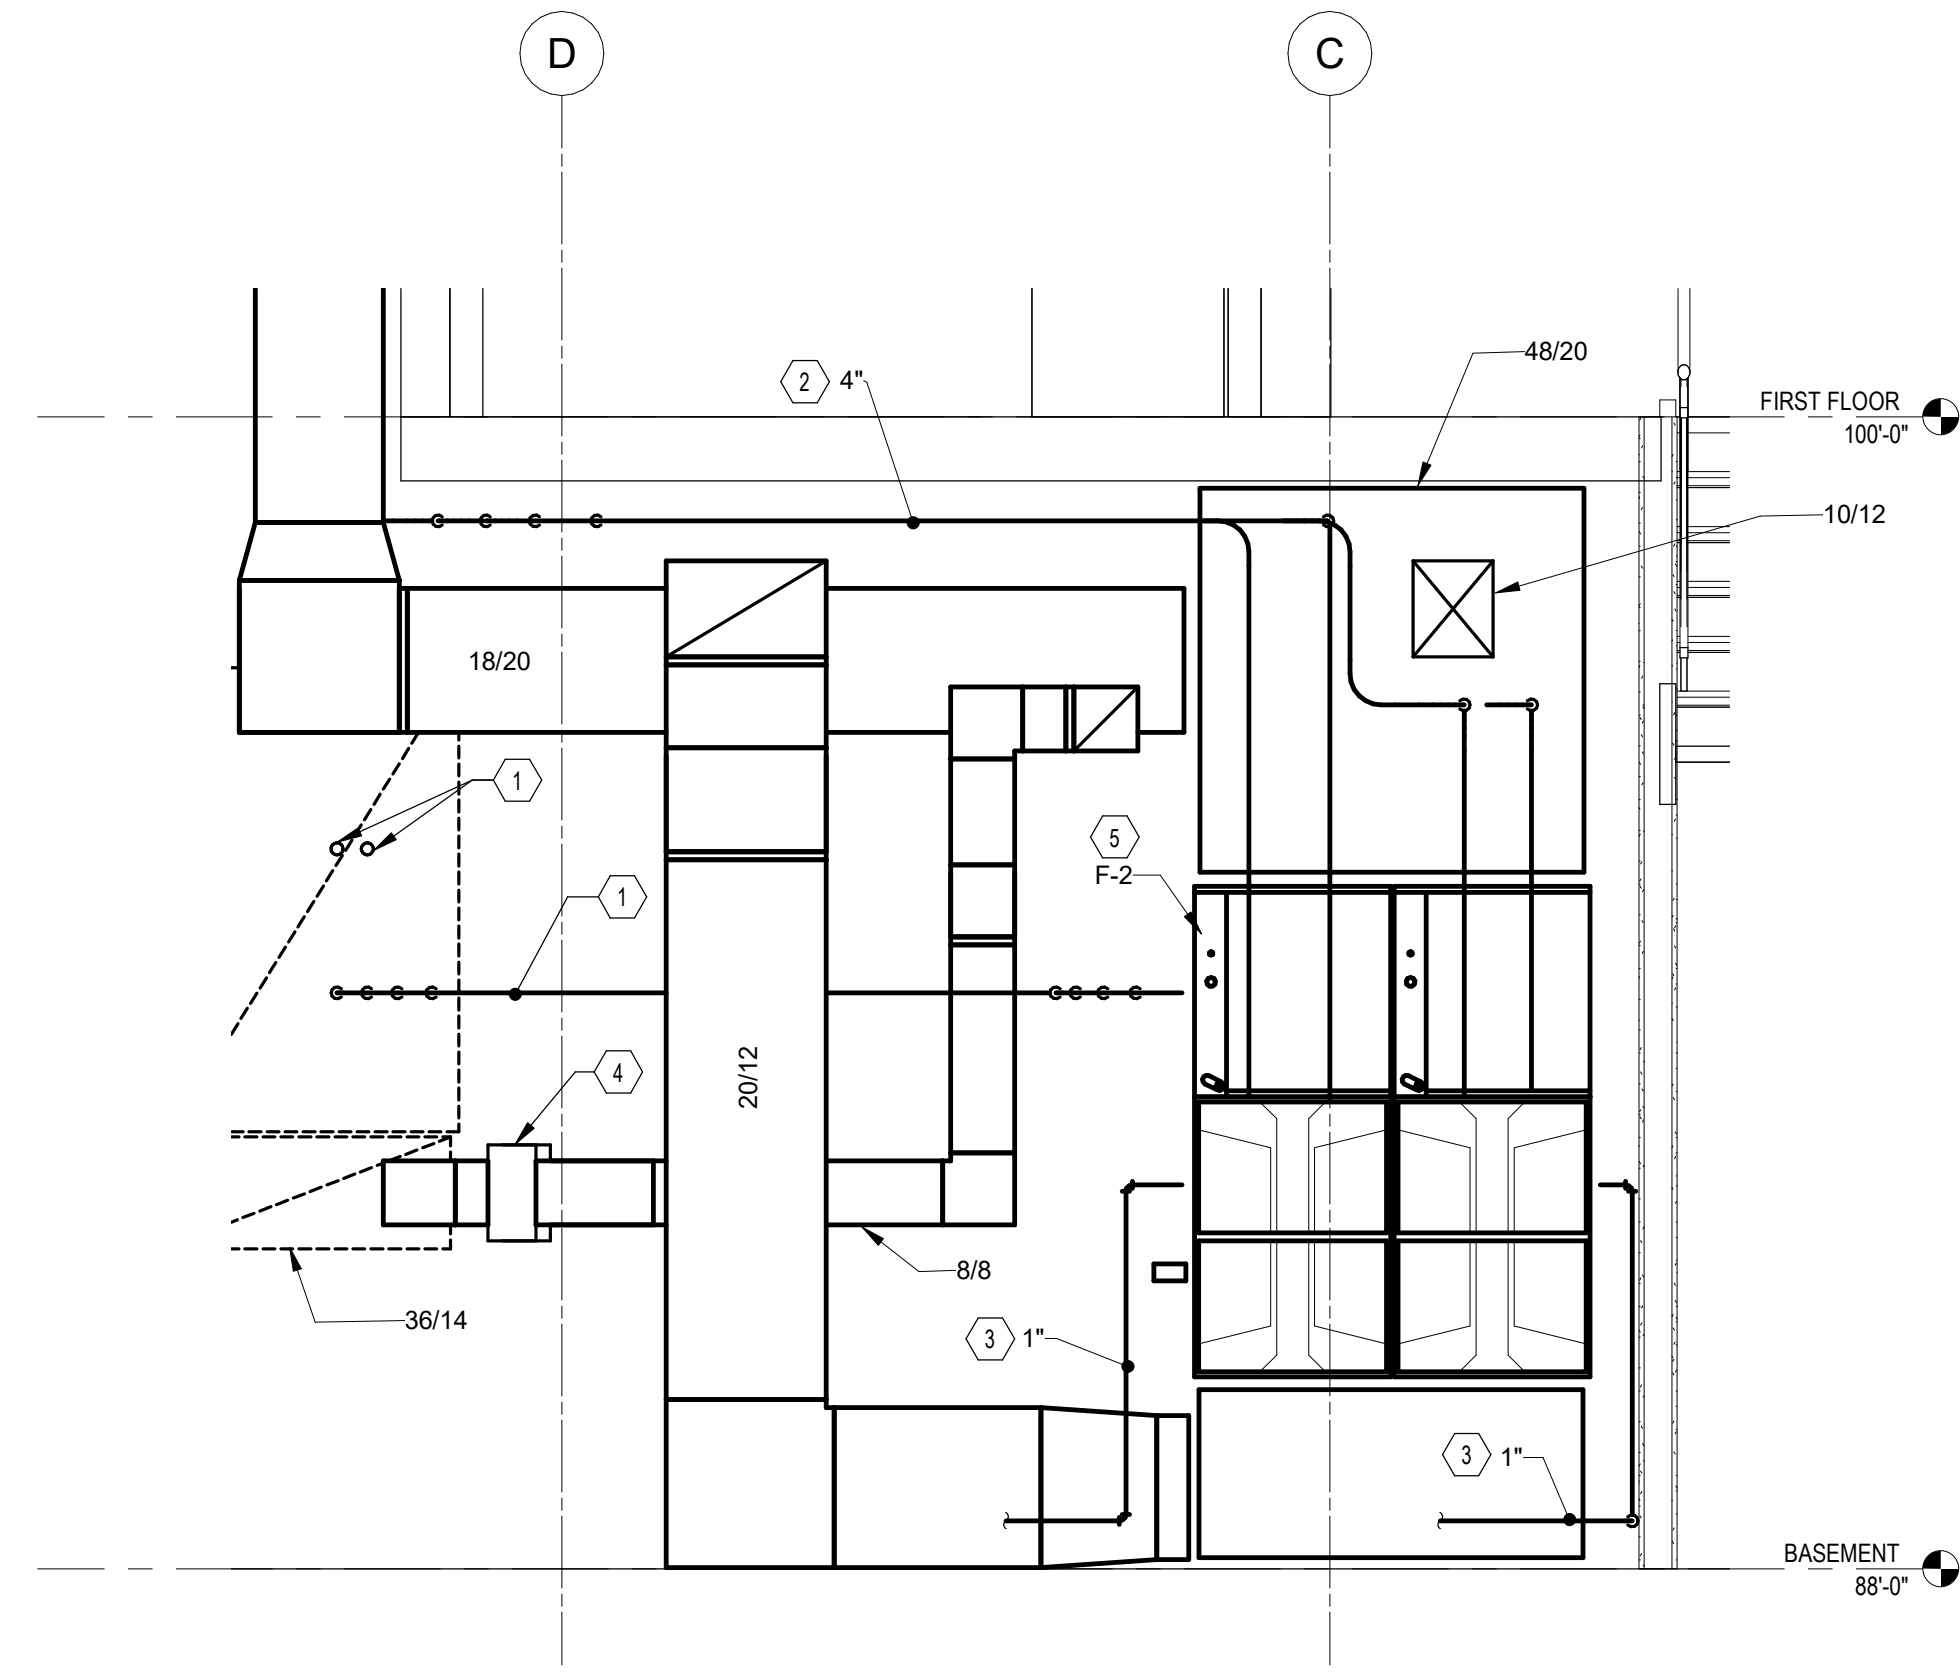

1 PLAN SECTION F-2
1/2" = 1'-0"

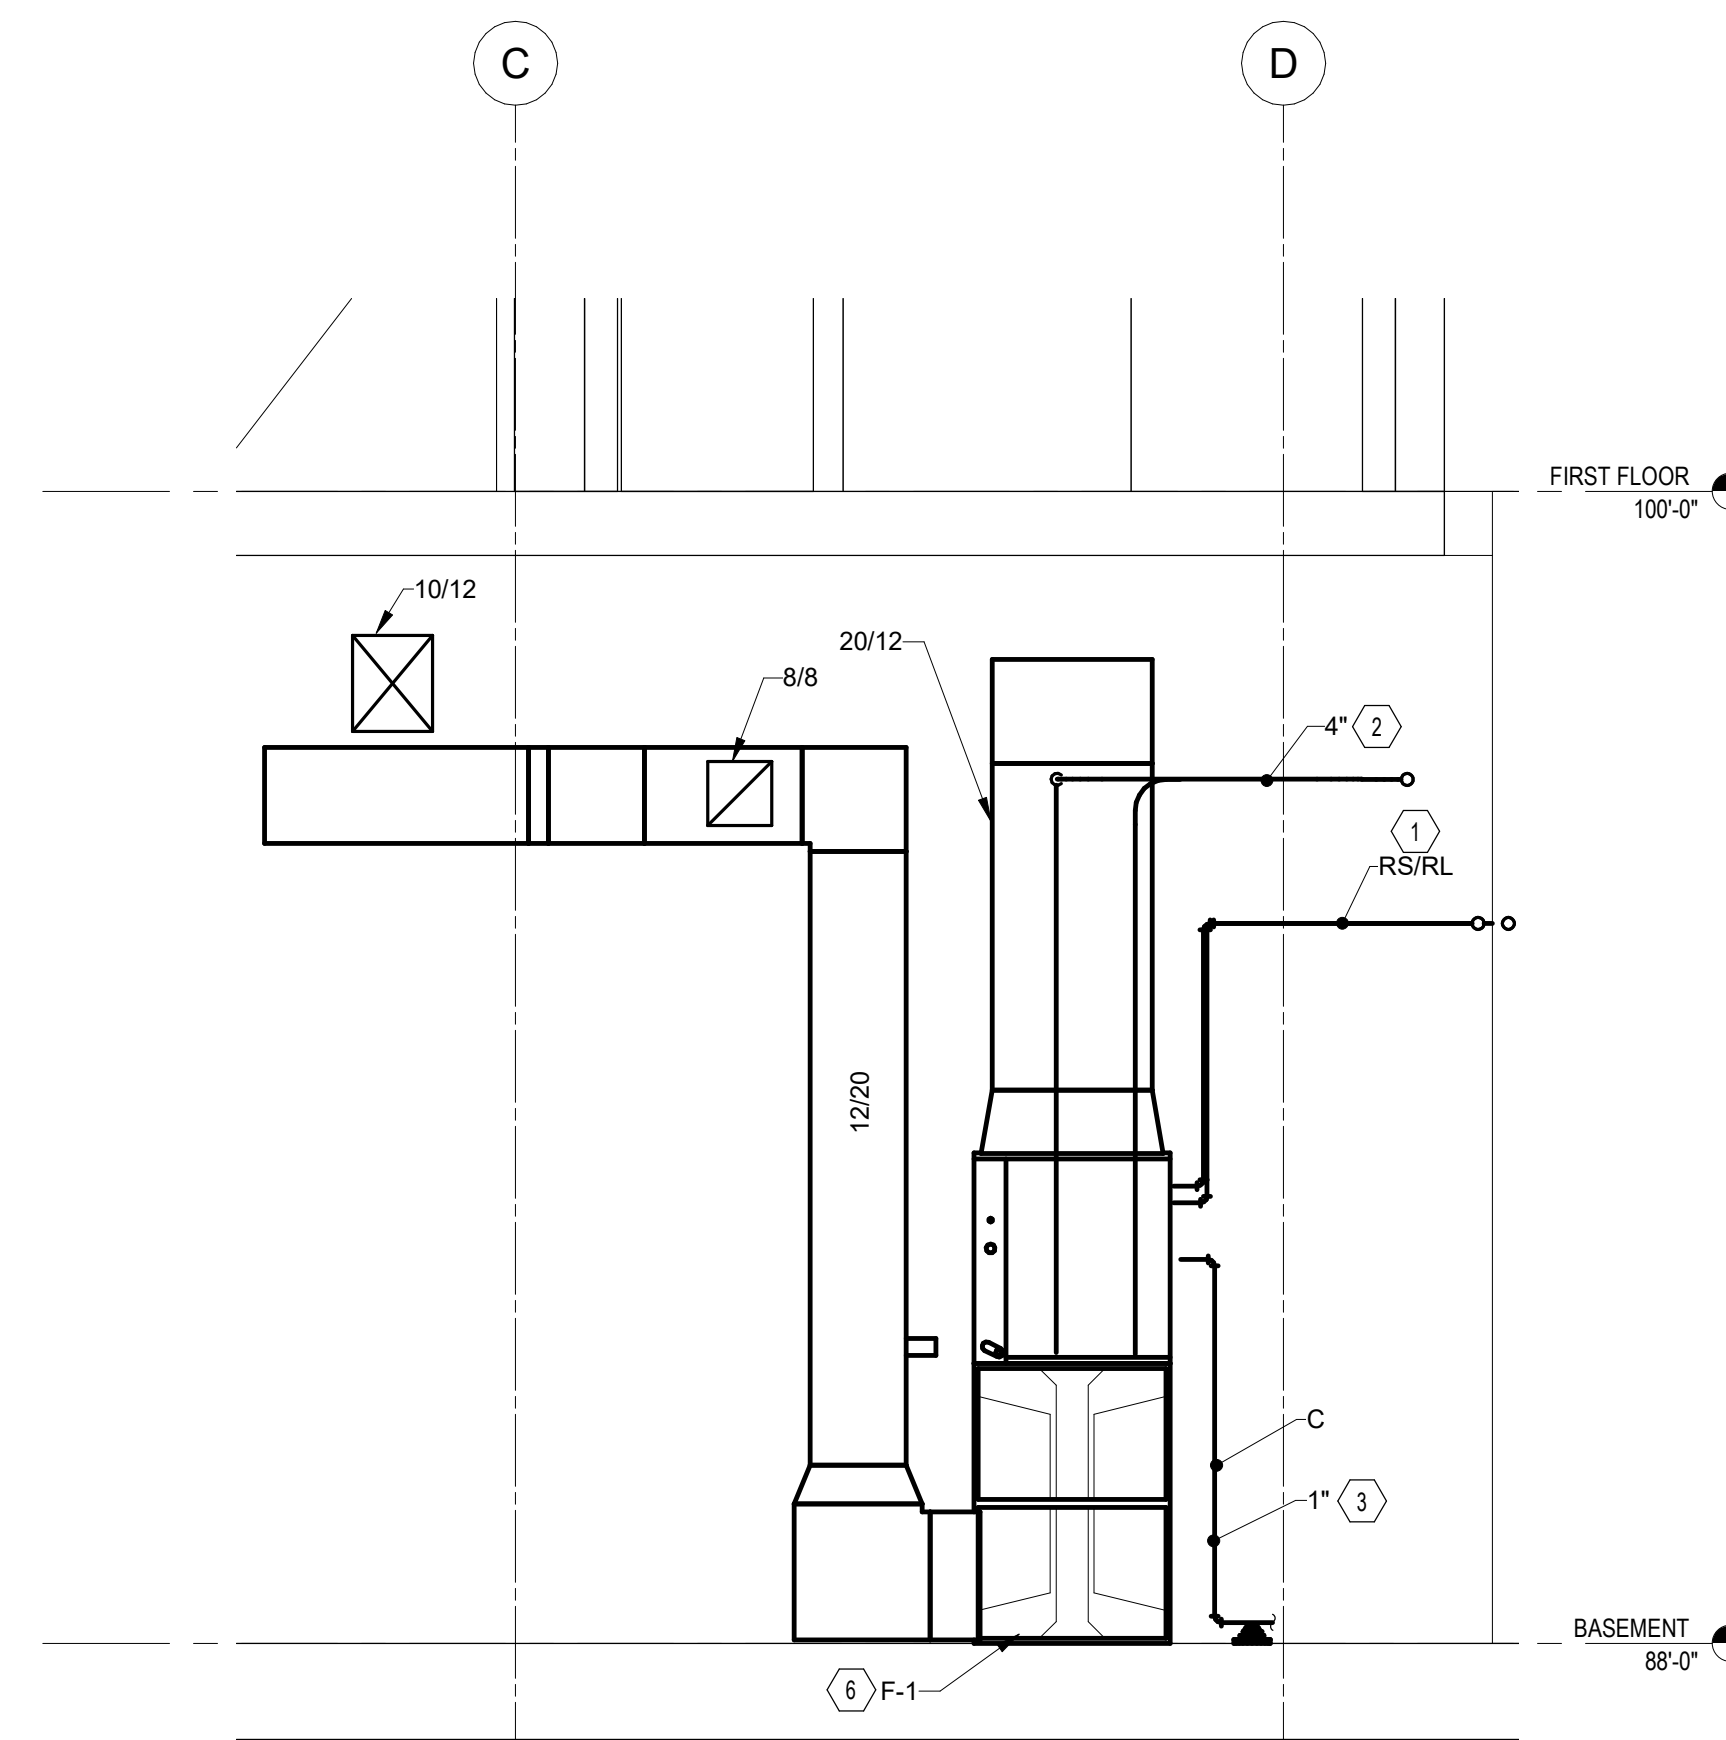

2 PLAN SECTION F-1
1/2" = 1'-0"

CODED NOTES:

1. ROUTE REFRIGERANT PIPING FROM INDOOR EVAPORATOR COILS TO AIR-COOLED CONDENSING UNIT. REFER TO SHEET M-201 FOR CONTINUATION.
2. ROUTE COMBUSTION AIR INTAKE/VENT PIPING TO EXISTING CHASE. REFER TO M-201 FOR CONTINUATION.
3. ROUTE 1" CONDENSATE PIPE TO NEAREST FLOOR DRAIN.
4. PROVIDE 120V MOTORIZED OUTSIDE AIR DAMPER.
5. REFER TO DETAIL 5M-501 FOR TWINNED FURNACE CONFIGURATION.
6. REFER TO DETAIL 4M-501 FOR FURNACE CONFIGURATION.


#	DATE	CHANGE DESCRIPTION

RENOVATION OF HEARTLAND BANK DUBLIN
6500 FRANTZ ROAD
DUBLIN, OH 43017
FOR
HEARTLAND BANK

MOODY-NOLAN
300 SPRUCE STREET
SUITE 300
COLUMBUS, OHIO 43215
PHONE: (614) 461-4664
FAX: (614) 280-8881

DRAWING TITLE:
SECTIONS - MECHANICAL

PROGRESS DRAWING NOT FOR CONSTRUCTION	09/10/2020	
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	20022	
	M-301	
PRELIMINARY DEVELOPMENT PLAN		

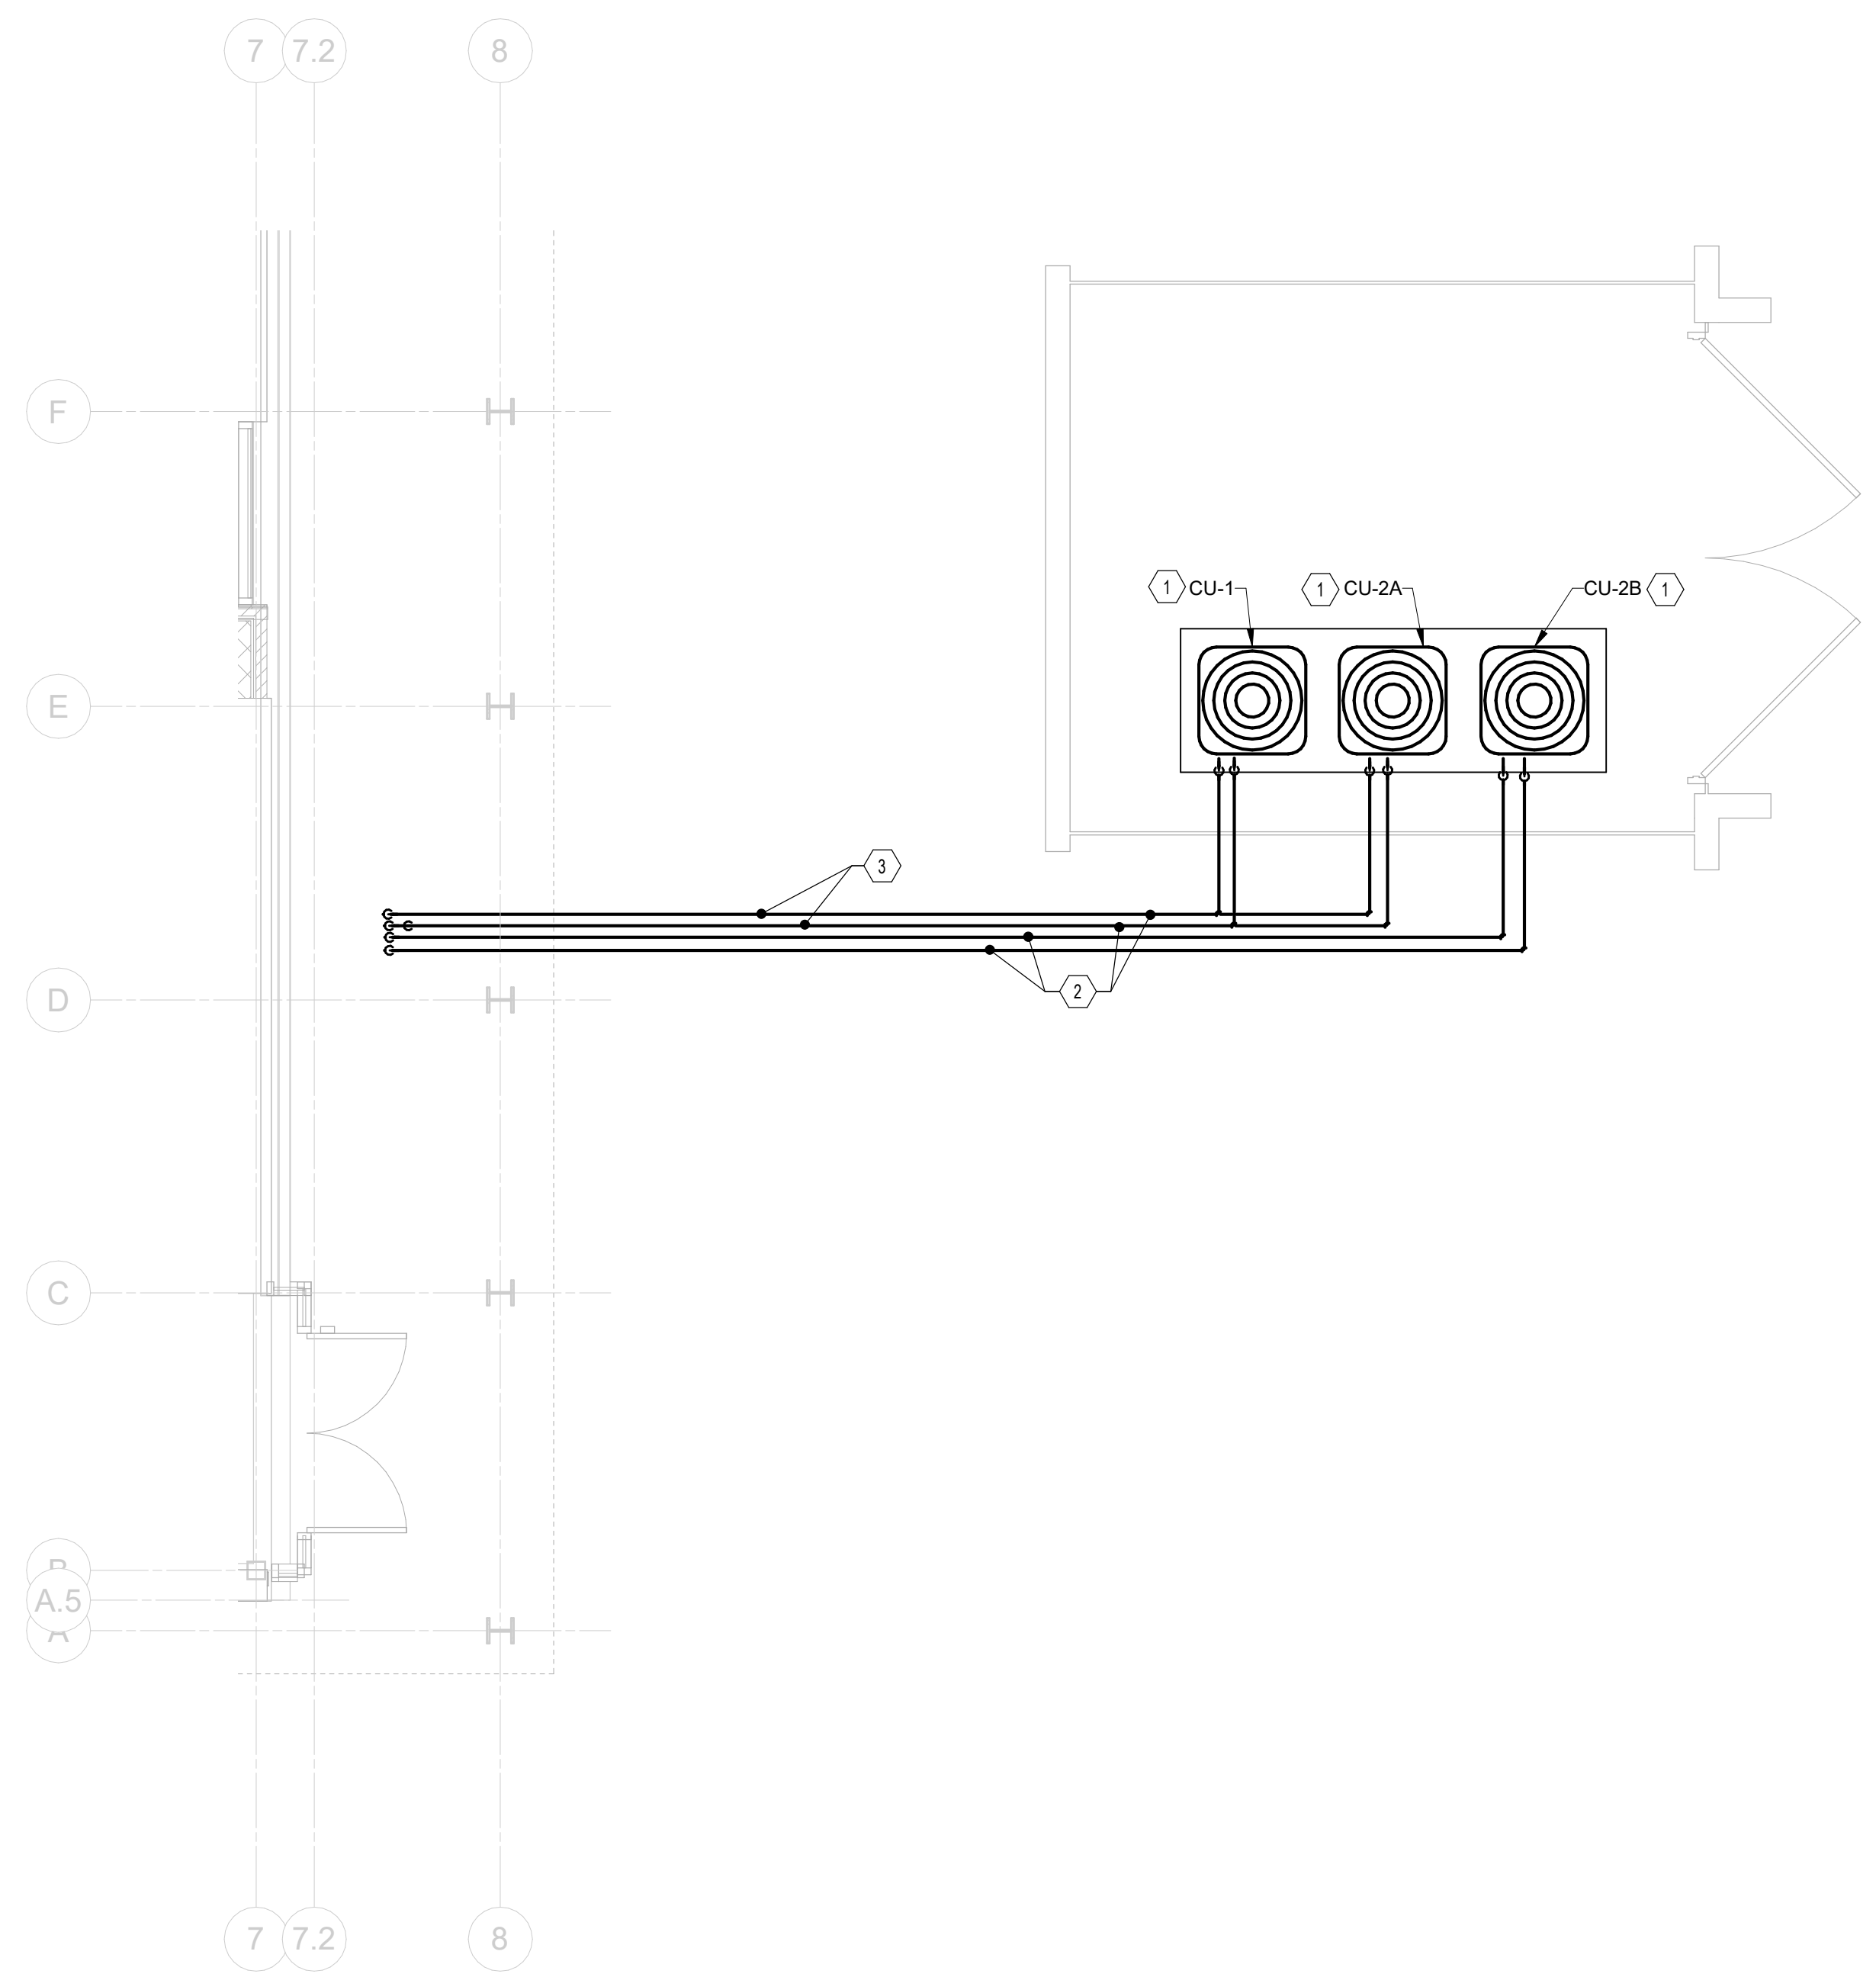

- CODED NOTES:**
1. PROVIDE AIR-COOLED CONDENSING UNIT IN MECHANICAL YARD. PROVIDE EXTERIOR EQUIPMENT PAD. REFER TO SCHEDULE SHEET FOR MORE INFORMATION. REFER TO DETAIL 914-902.
 2. ROUTE REFRIGERANT PIPING FROM AIR-COOLED CONDENSING UNIT TO INDOOR EVAPORATOR COILS. INSTALL PER MANUFACTURERS RECOMMENDATIONS. PROVIDE TRENCHING AND EXCAVATION FOR INSTALLATION.
 3. TWO SETS OF REFRIGERANT PIPING STACKED.

1 PLAN EQUIPMENT YARD PLAN - MECHANICAL
1/4" = 1'-0"

#	DATE	CHANGE DESCRIPTION

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6500 FRANTZ ROAD
DUBLIN, OH 43017
FOR
HEARTLAND BANK

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300 SPRUCE STREET
SUITE 300
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DRAWING TITLE:
ENLARGED PLANS - MECHANICAL

PROGRESS DRAWING NOT FOR CONSTRUCTION	09/10/2020	
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	20022	
	M-401	
PRELIMINARY DEVELOPMENT PLAN		


DUCT CONSTRUCTION DETAILS

DESCRIPTION	DUCTWORK AS SHOWN ON THE PLANS		DETAILED CONSTRUCTION REQUIRED
	DOUBLE LINE DRAWING	SINGLE LINE DRAWING	
DUCT TAKEOFF FROM LOW PRESSURE MAIN			
ELBOW AND SPLIT (LOW PRESSURE DUCTWORK ONLY)			
ELBOW			
SQUARE OR RECTANGULAR RADIUS ELBOW			
UNEQUAL ELBOWS (LOW PRESSURE DUCTWORK ONLY)			
DUCT TAKEOFF FROM RECTANGULAR LOW PRESSURE MAIN WITH BELLMOUTH FITTING			


NOTES:

- SUPPLY AND RETURN AIR DUCTWORK SHOWN AS INDICATED TO HAVE TURNING VANES.
- DUCT PRESSURES CLASSES**
ROUND DUCT DOWNSTREAM OF VAV BOXES TO BE CONSTRUCTED TO MEET SMACNA STANDARDS FOR 3" WG POSITIVE STATIC PRESSURE.
RECTANGULAR DUCT - SUPPLY, RETURN OR EXHAUST TO BE CONSTRUCTED TO MEET SMACNA STANDARDS FOR 3" WG PRESSURE.
- FROM 0 - 35° USE 2 GORE FITTINGS, 35 - 71° USE 3 GORE FITTINGS, 72 - 90° USE 5 GORE FITTINGS. FOR ELBOWS WHICH EXCEED 90°, ADD ONE GORE FOR EACH ADDITIONAL 18° FOR FITTING CONSTRUCTION. NOTE: 90° ELBOW DEPICTED REQUIRES 5 GORE FITTING CONSTRUCTION.


1 DETAIL DUCT CONSTRUCTION
NTS

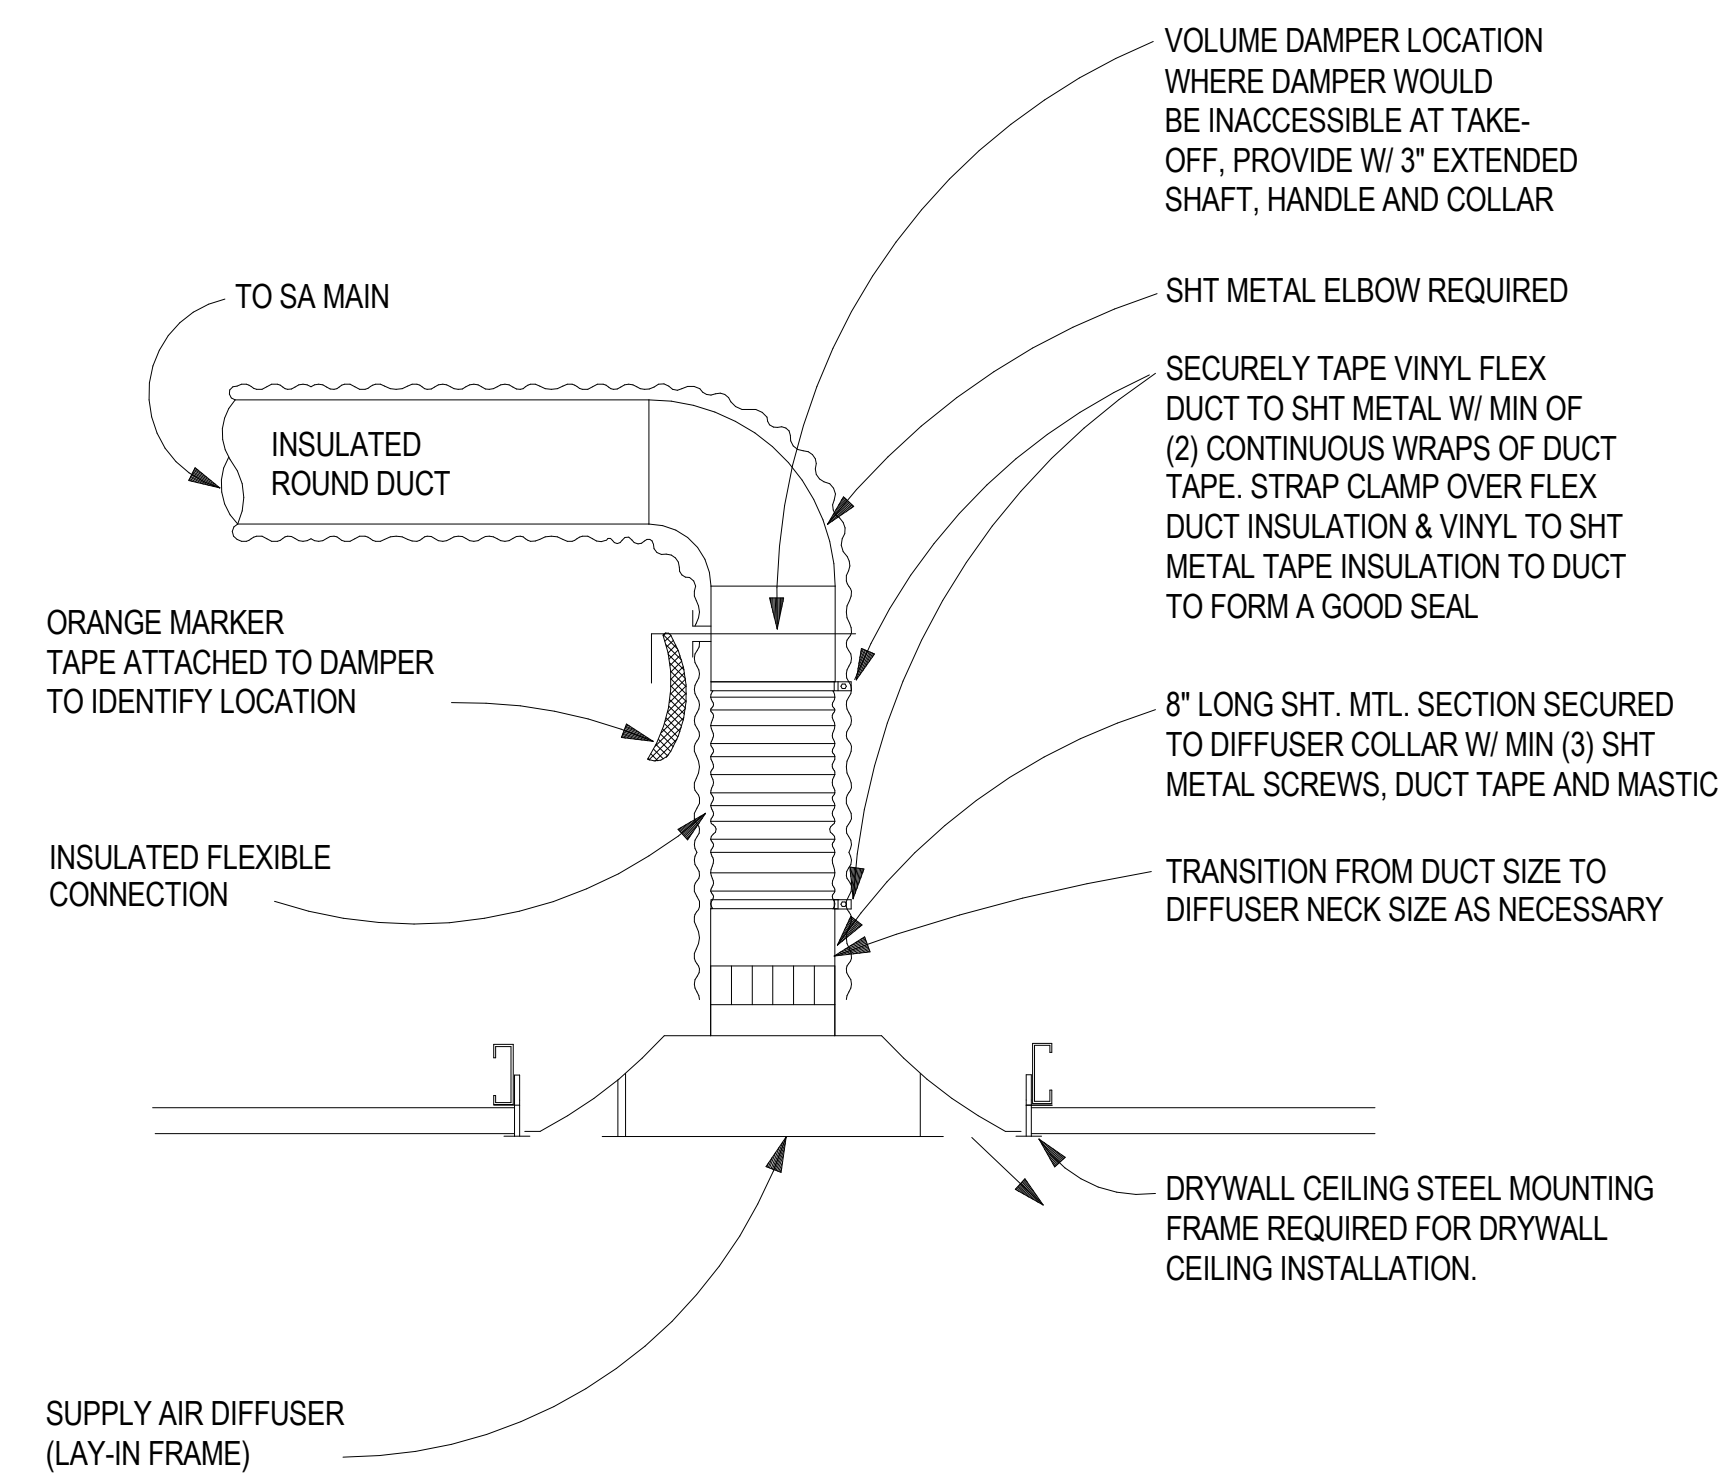


2 DETAIL DIFFUSER MOUNTING
NTS

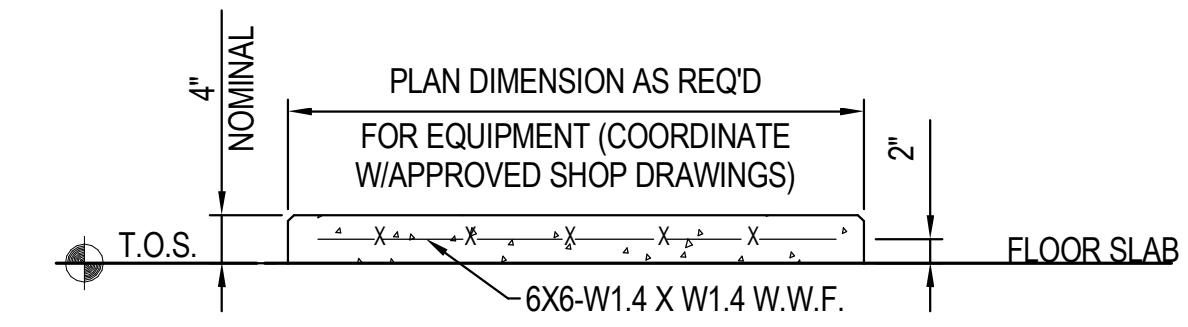

3 DETAIL INTERIOR EQUIPMENT PAD
NTS

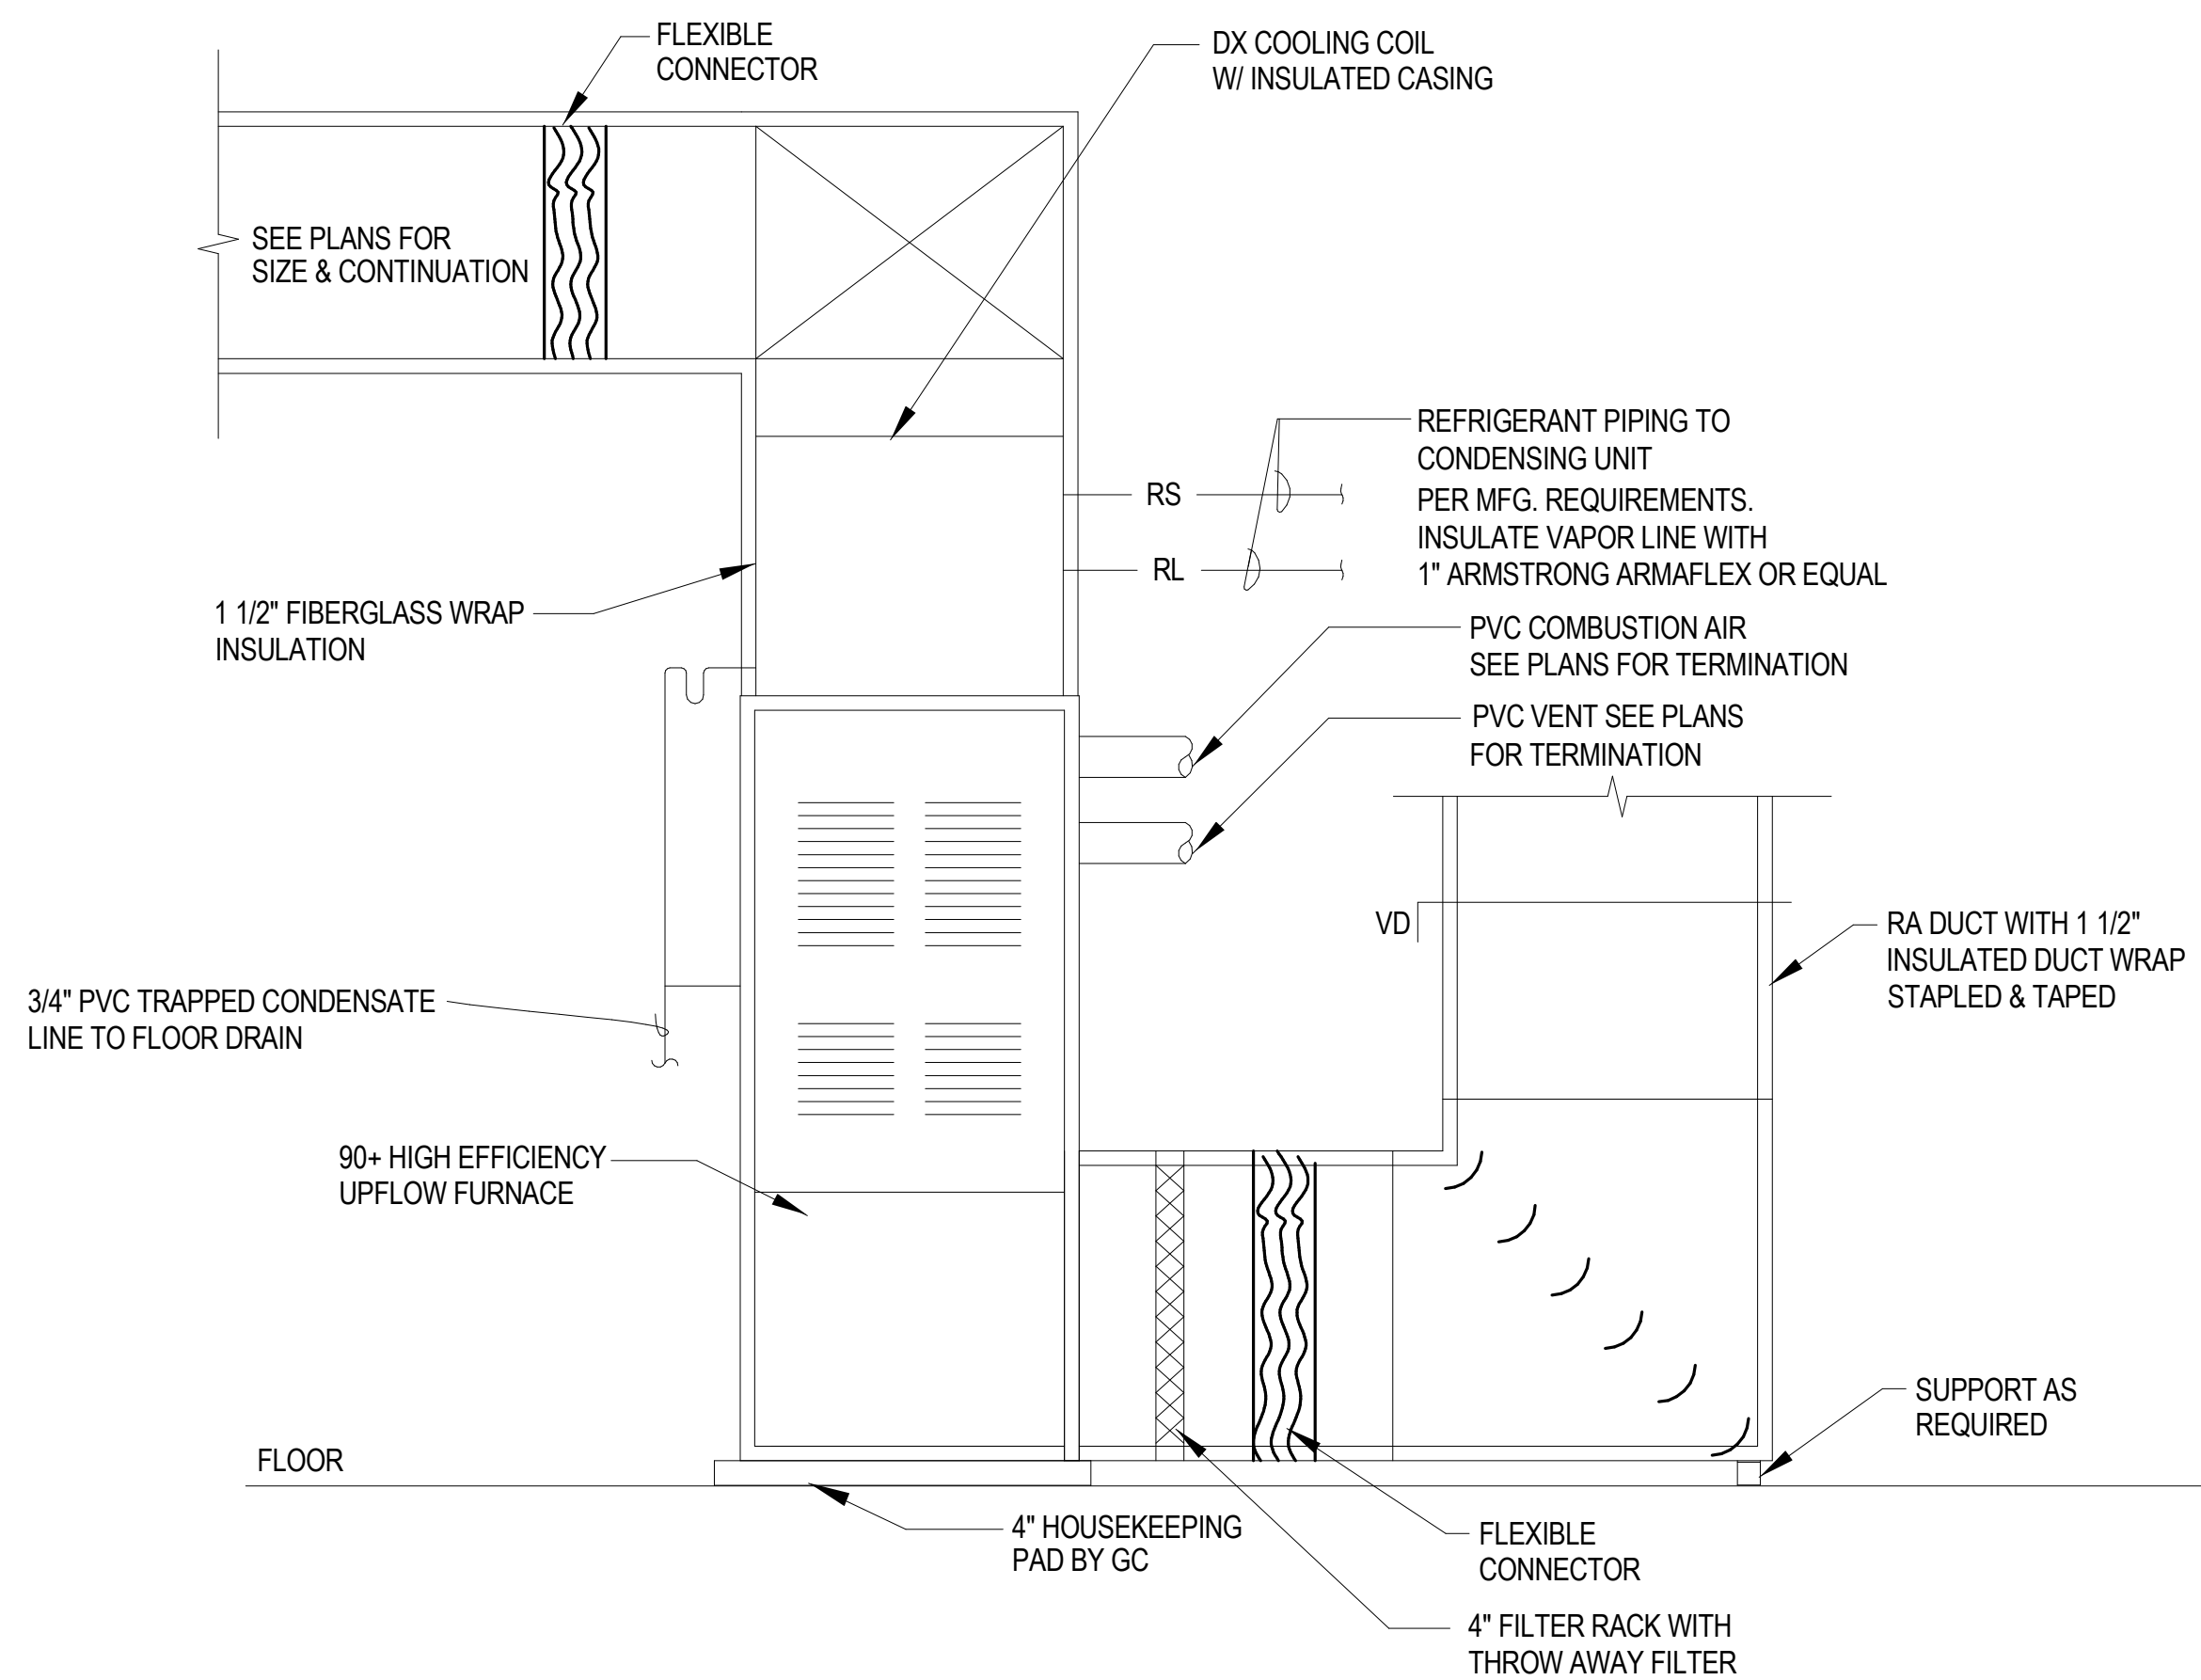

4 DETAIL FURNACE (F-1)
NTS

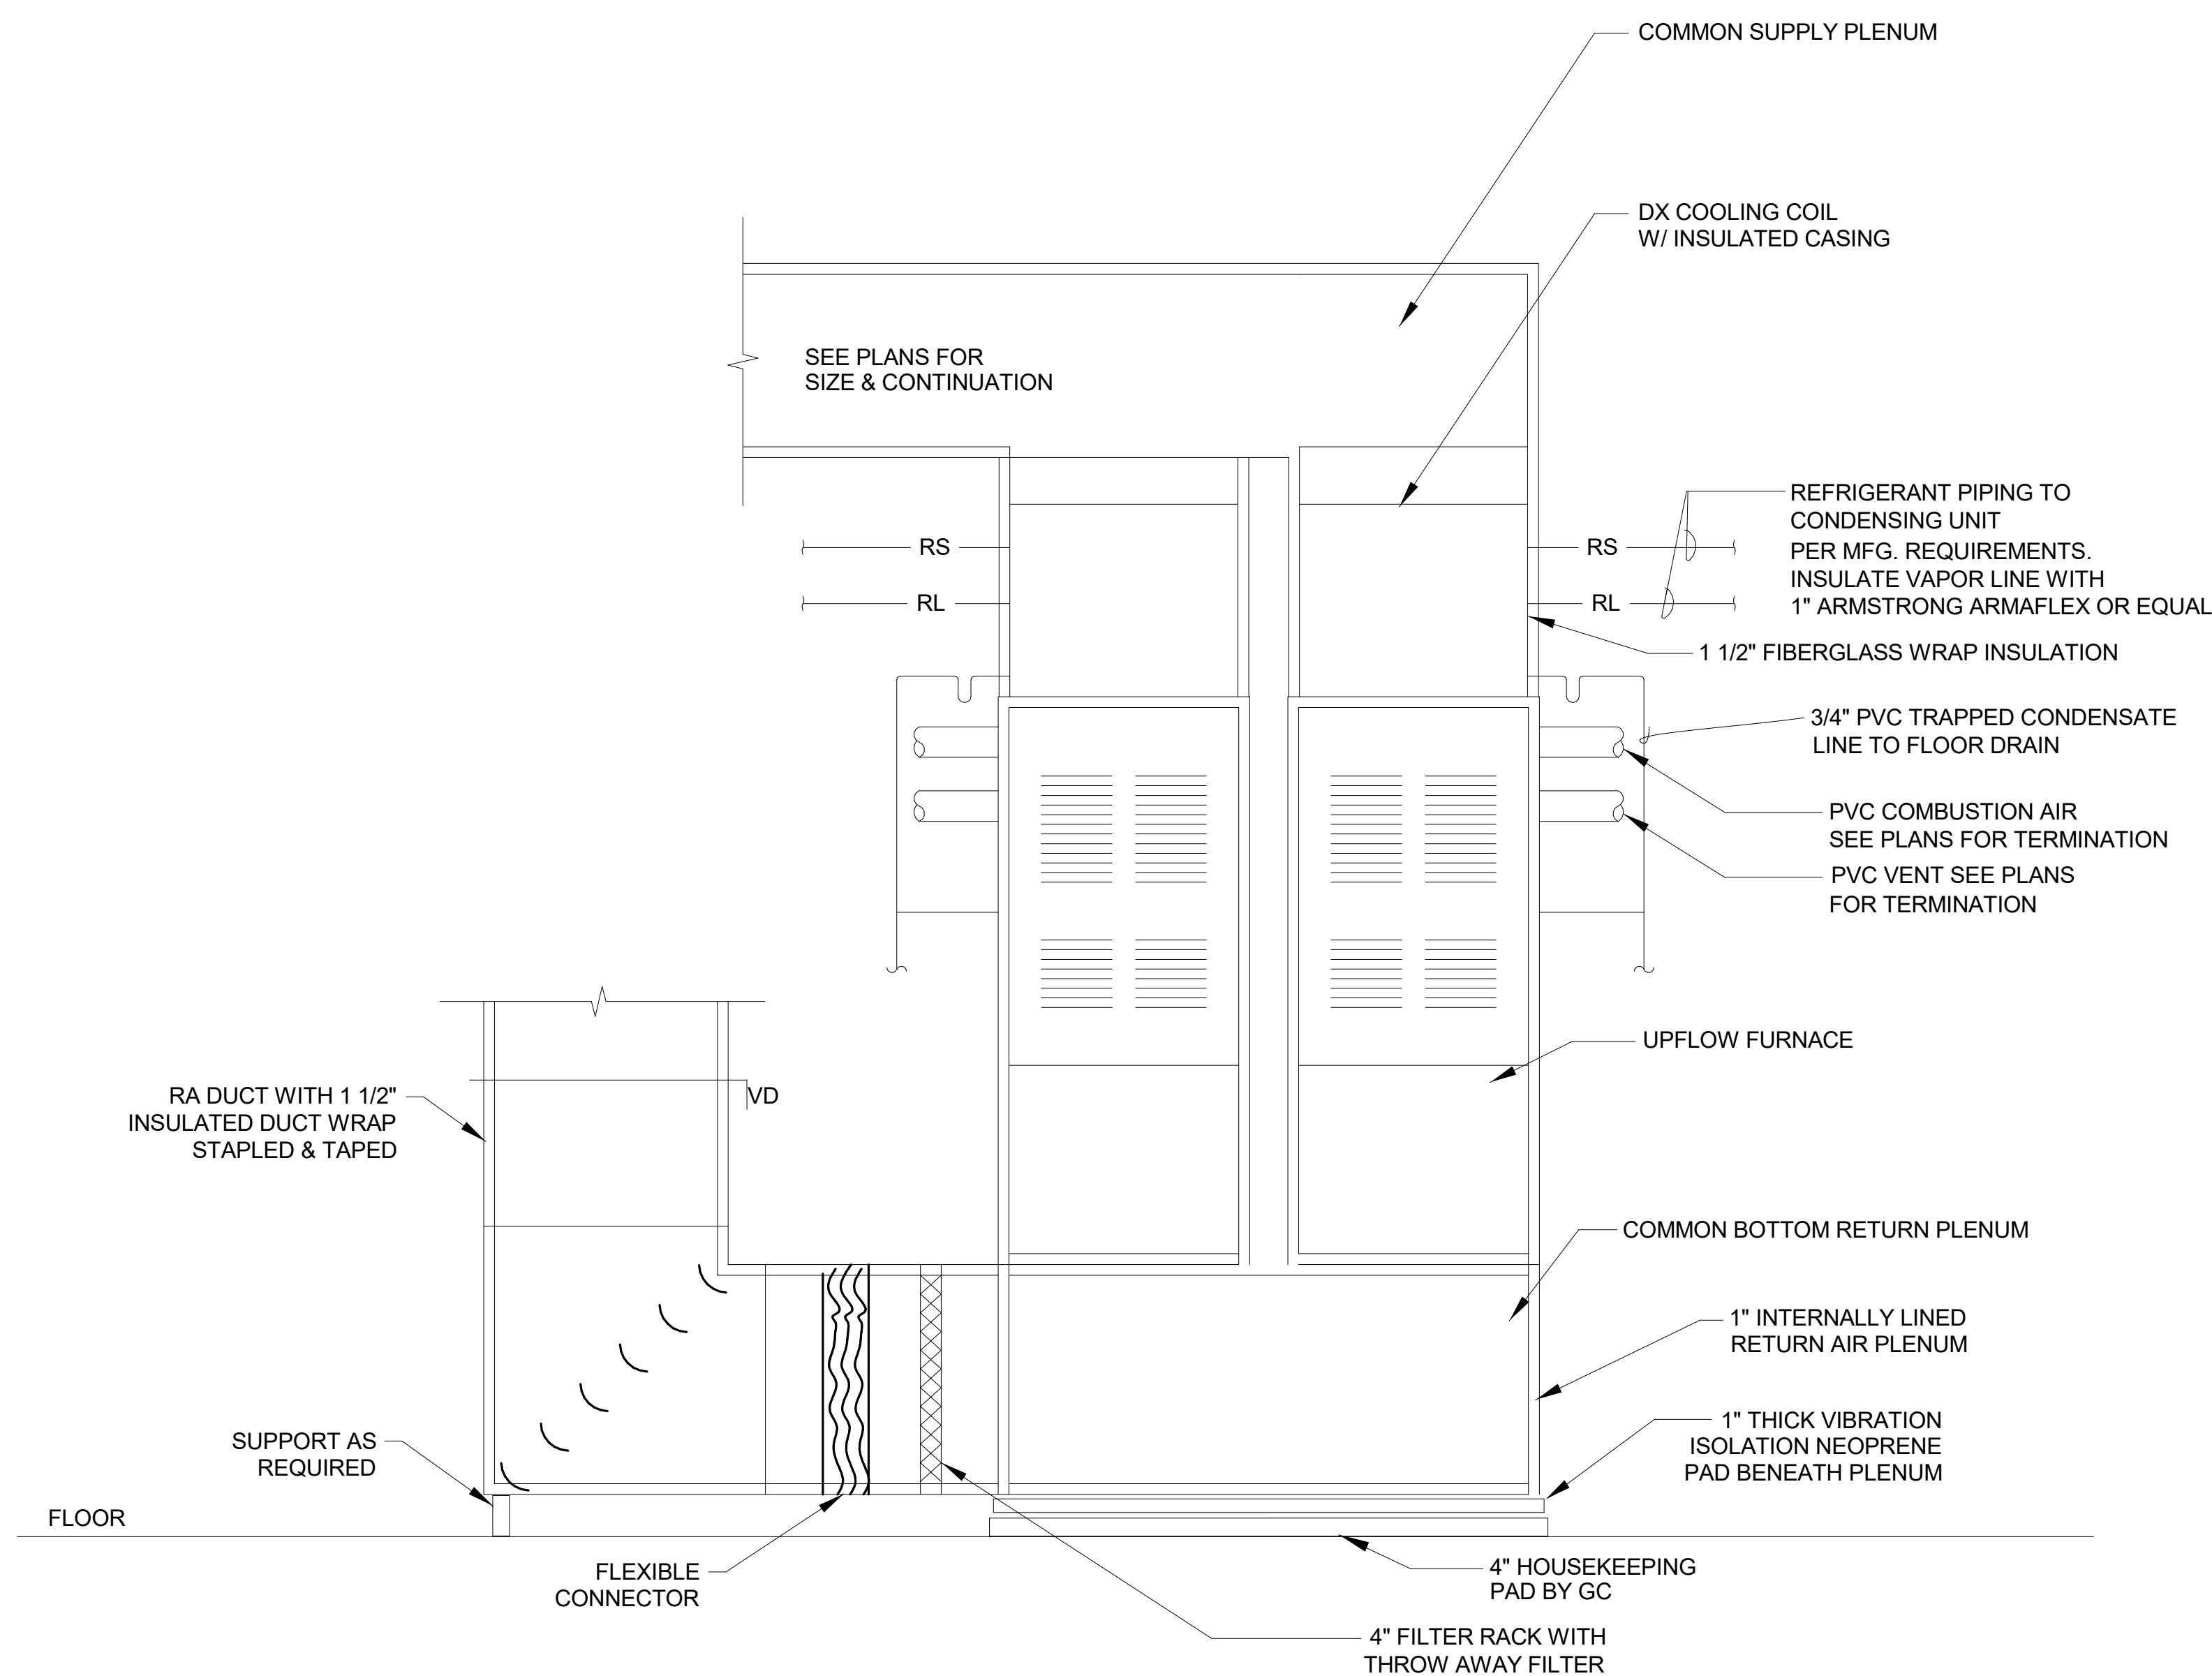

5 DETAIL TWINNED FURNACES (F-2)
NTS

#	DATE	CHANGE DESCRIPTION


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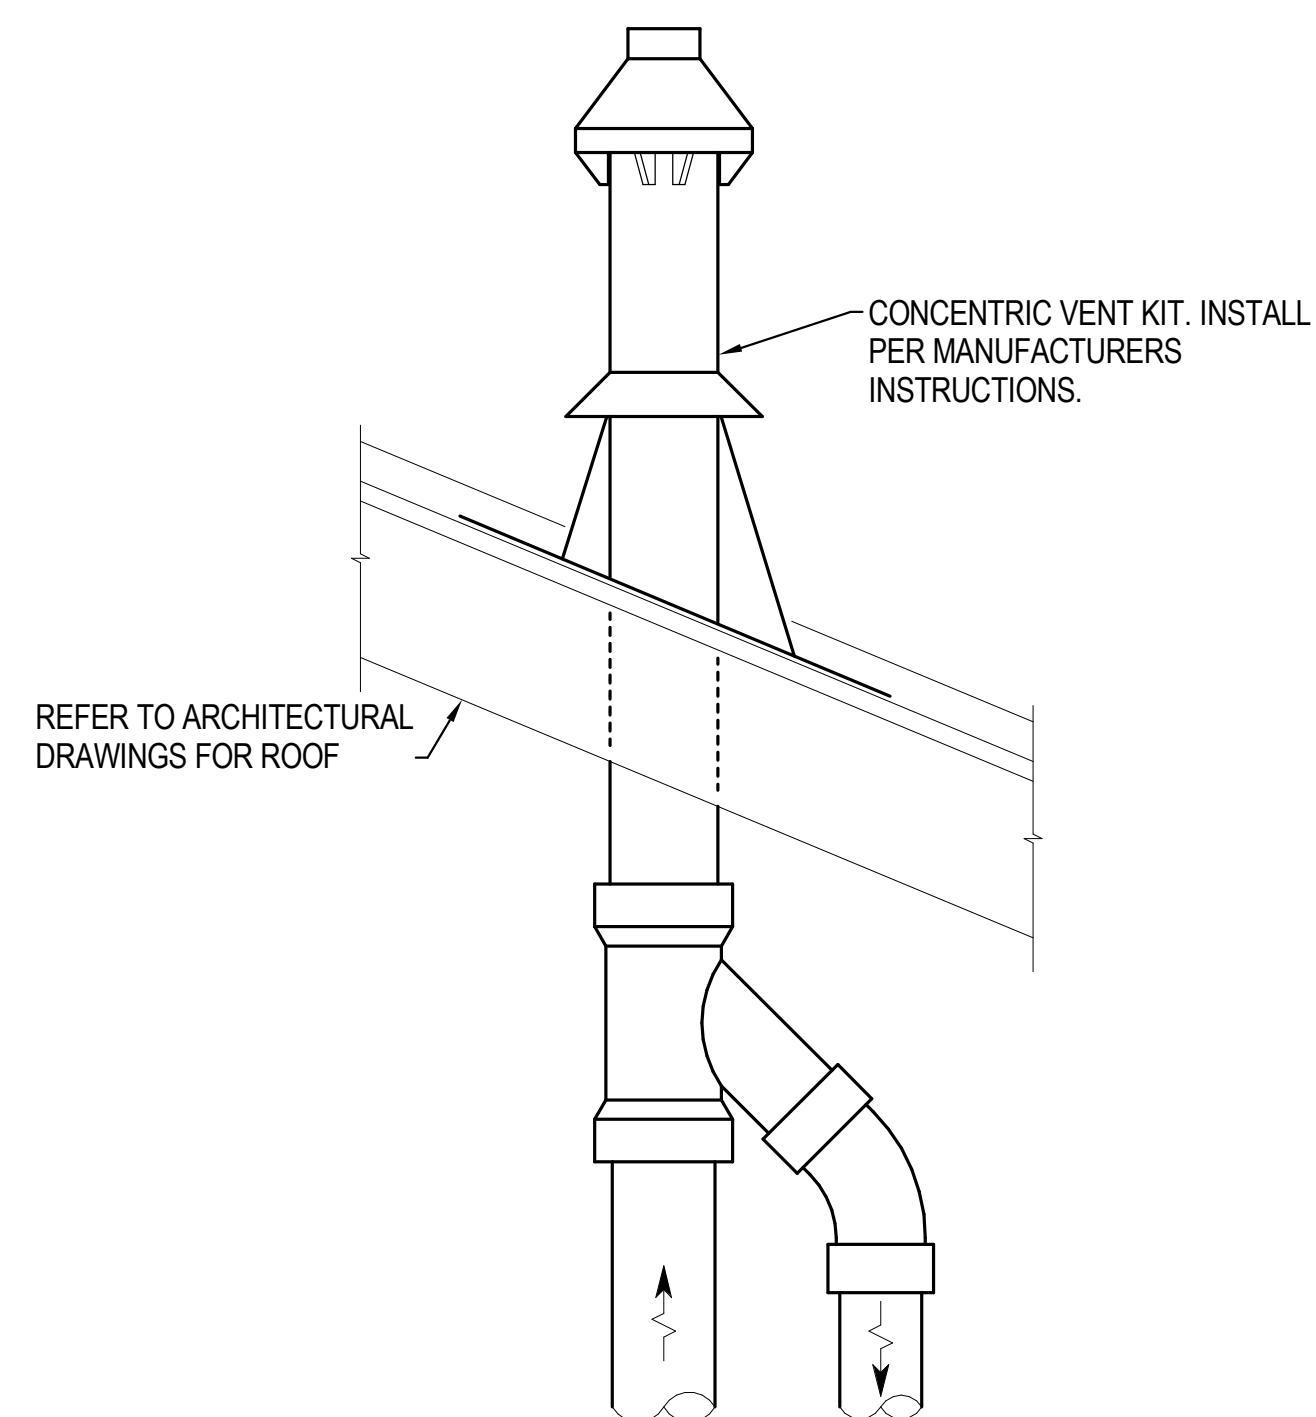
DRAWING TITLE:

DETAILS - MECHANICAL


PROGRESS DRAWING NOT FOR CONSTRUCTION	09/10/2020
	DRAWN BY: Author CHECKED BY: Checker
	20022
M-501	
PRELIMINARY DEVELOPMENT PLAN	




1 **DETAIL** DETAIL - CEILING MOUNTED EXHAUST FAN
NTS

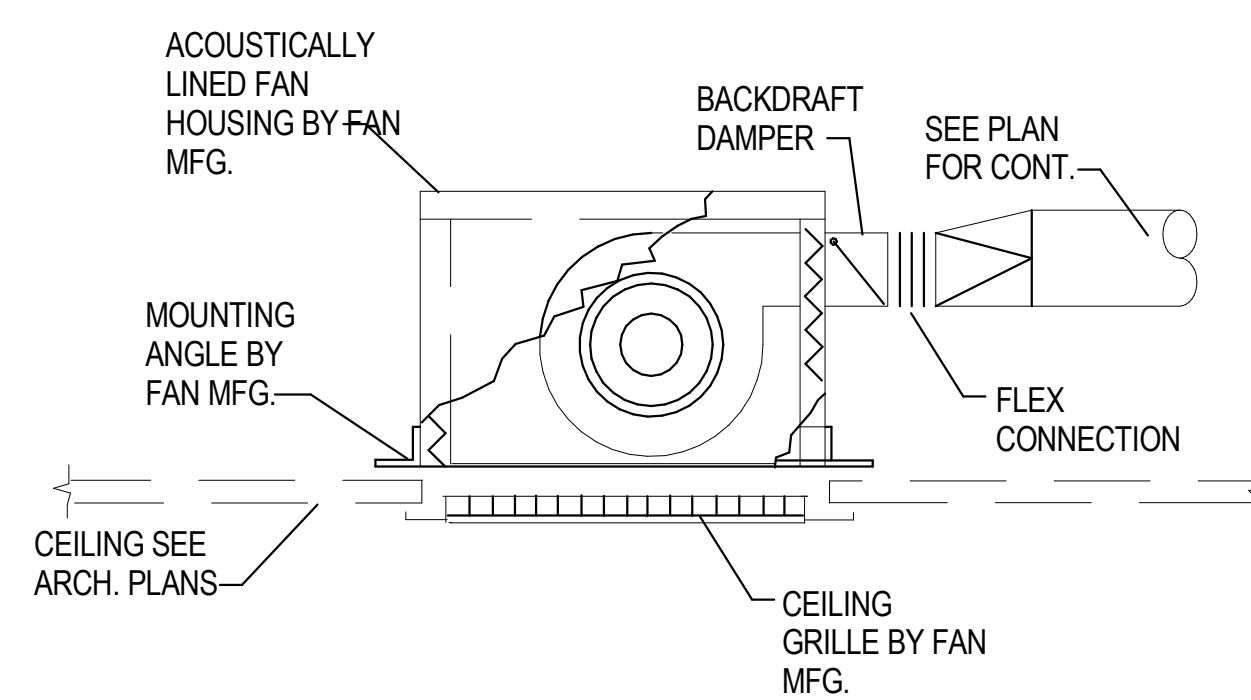


2 **DETAIL** DETAIL - FURNACE VENTING
NTS

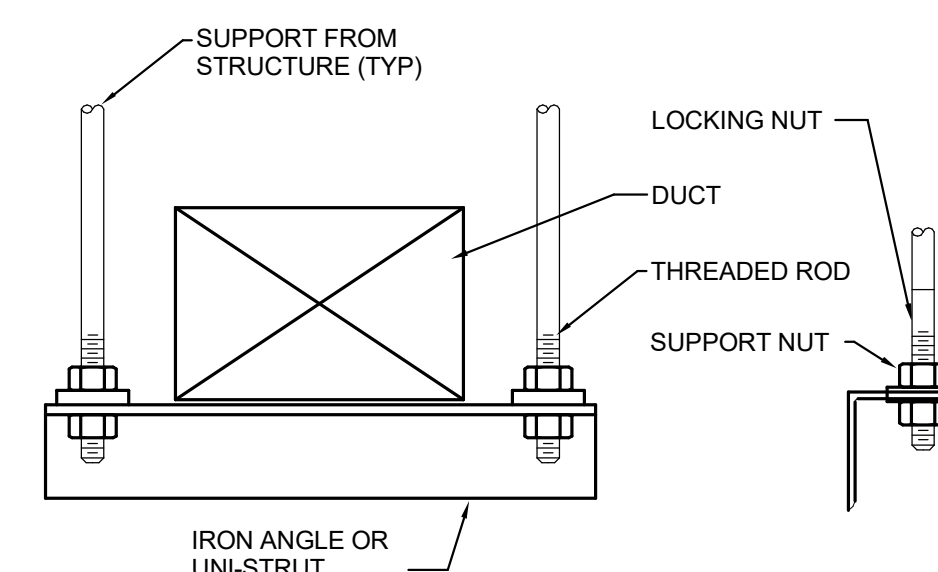


3 **DETAIL** DETAIL - TYPICAL DUCT SUPPORT
NTS

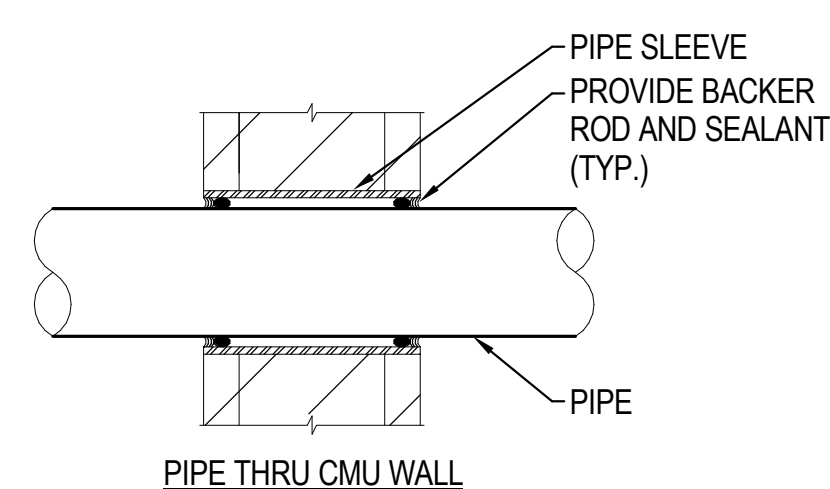

4 **DETAIL** DETAIL - TYPICAL WALL PENETRATION
NTS

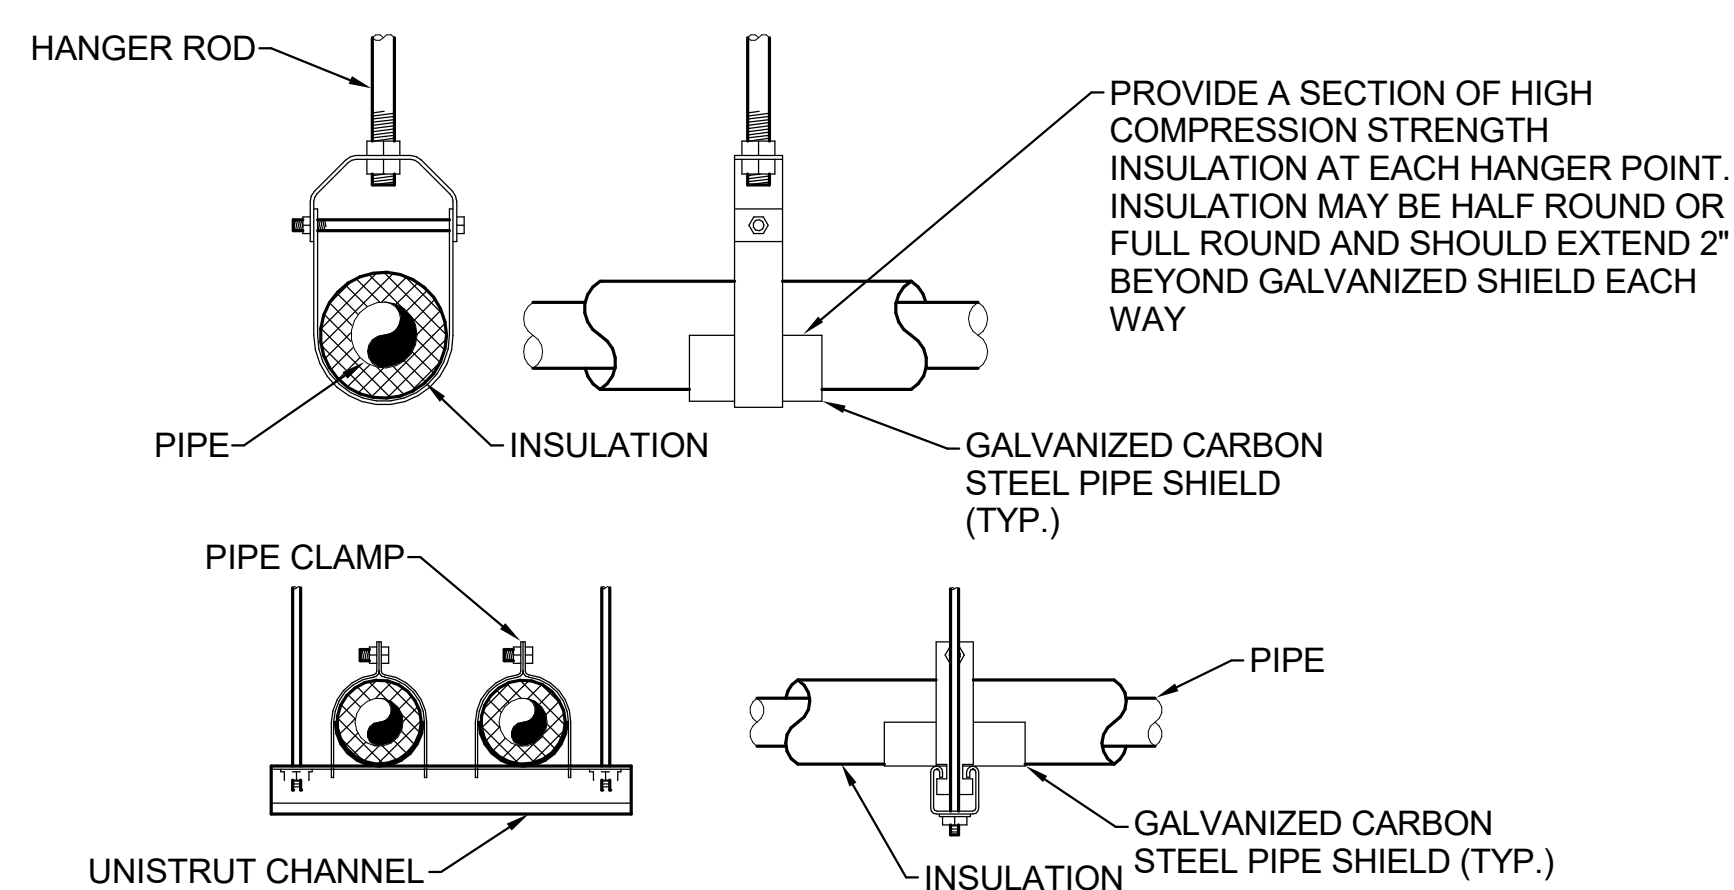


5 **DETAIL** DETAIL - TYPICAL PIPE HANGER
NTS

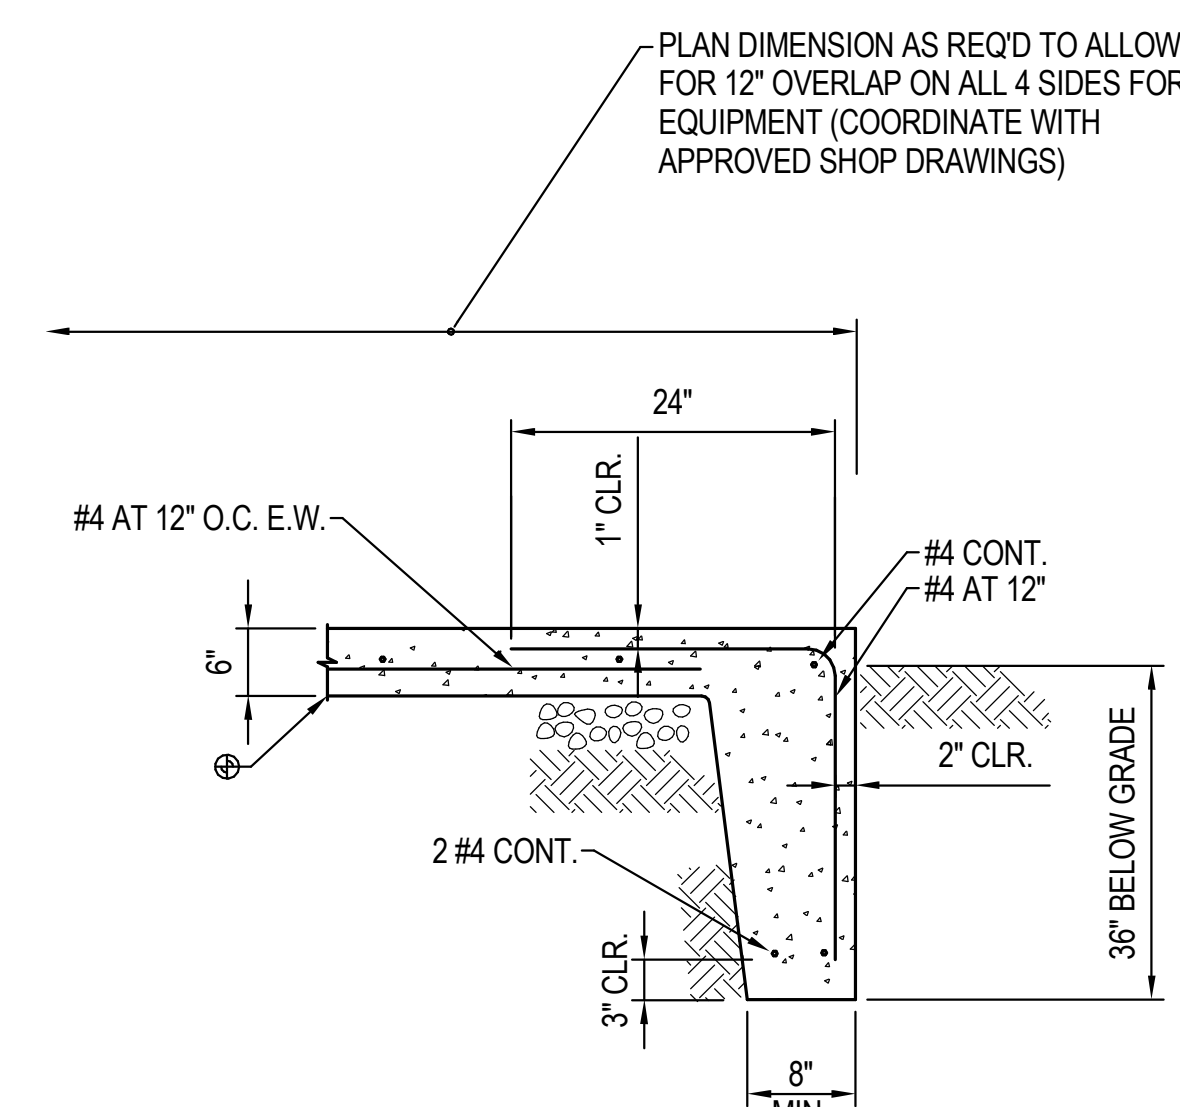

6 **DETAIL** DETAIL - EXTERIOR CONCRETE PAD
NTS

NOTE: "A" DENOTES 0 TO 2 IN BETWEEN THE FIRST 2 VENTS. THIRD VENT (AND FOURTH VENT, IF USED) MUST BE 36 IN. AWAY.

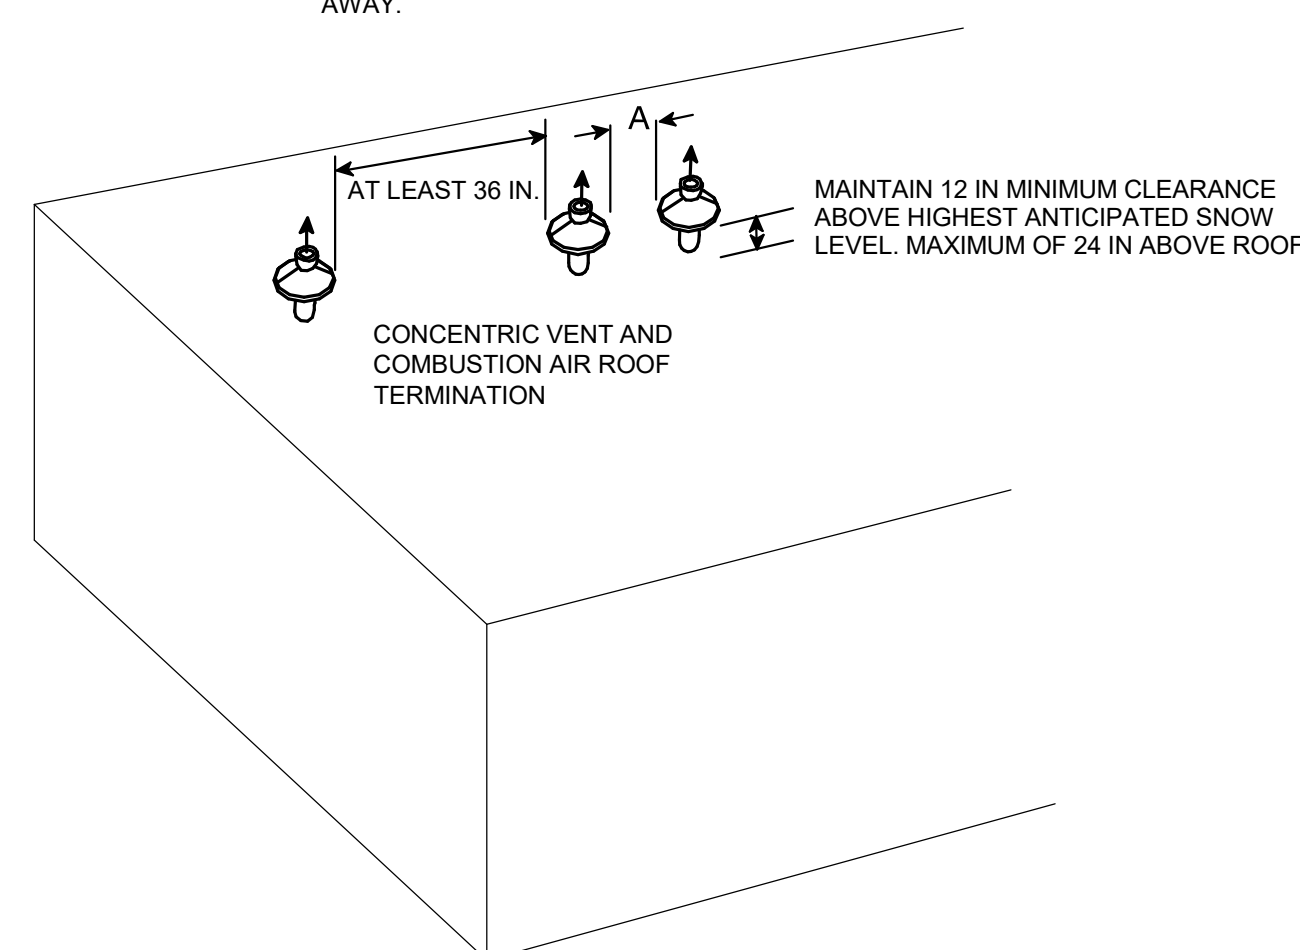

7 **DETAIL** DETAIL - CONCENTRIC VENT CLEARANCES
NTS

#	DATE	CHANGE DESCRIPTION

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SUITE 300
COLUMBUS, OHIO 43215
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DRAWING TITLE:

DETAILS - MECHANICAL

PROGRESS DRAWING NOT FOR CONSTRUCTION	09/10/2020
	DRAWN BY: Author CHECKED BY: Checker
	20022
	M-502
	PRELIMINARY DEVELOPMENT PLAN

NATURAL GAS FURNACES																										
EQUIPMENT BASED ON BRYANT UNLESS NOTED OTHERWISE																										
REFRIGERANT TO BE R-410A																										
FURNACE & BLOWER												COOLING COIL				CONDENSING UNITS					REMARKS					
TAG	SERVICE	MODEL NO.	TYPE	INPUT (MBH)	OUTPUT (MBH)	AFUE %	CFM	MIN VENT AIR CFM	ESP (IN WC)	BLOWER HP	VOLT	PHASE	MODEL NO.	EAT °F		COOLING CAPACITY (MEH)		UNIT TAG	MODEL NO.	MCA	VOLT	PHASE	AHR SEER	WEIGHT (LBS)	SOUND POWER (dBA)	REMARKS
														DB	WB	TOTAL	SENSIBLE									
F-1	BASEMENT	926TA66120V24	DIRECT-VENT FIXED-CAPACITY	120	117	96.0	1,400	250	0.5	1	115	1	CNPVP4324ALA	80	67	41.5	31.67	CU-1	113ANAD420N0	23.5	208	1	14.5	188	78	PROGRAMMABLE THERMOSTAT WITH AUTO CHANGEOVER, CRANKCASE HEATER, FILTER DRIER, LIQUID-LINE SOLENOID VALVE, LOW-AMBIENT CONTROLLER, WINTER START CONTROL, MERV-13 FILTER
F-2	BASEMENT	926TA66120V24	DIRECT-VENT FIXED-CAPACITY	120	117	96.0	1,400	210	0.5	1	115	1	CNPVP4324ALA	80	67	41.5	31.67	CU-2A	113ANAD420N0	23.5	208	1	14.5	188	78	PROGRAMMABLE THERMOSTAT WITH AUTO CHANGEOVER, CRANKCASE HEATER, FILTER DRIER, LIQUID-LINE SOLENOID VALVE, LOW-AMBIENT CONTROLLER, WINTER START CONTROL, MERV-13 FILTER, TWINNING KIT MODEL KGATW0801HSI
		926TA66120V24	DIRECT-VENT FIXED-CAPACITY	120	117	96.0	1,400	SEE ABOVE	0.5	1	115	1	CNPVP4324ALA	80	67	41.5	31.67	CU-2B	113ANAD420N0	23.5	208	1	14.5	188	78	

SEQUENCE OF OPERATIONS

SPLIT SYSTEM SEQUENCE

THERE ARE 2 SPLIT SYSTEM SERVING THE BUILDING. EACH SPLIT SYSTEM CONSISTS OF AN INDOOR FURNACE UNIT WITH EVAPORATOR COIL (F-1 THRU F-2) AND AN OUTDOOR CONDENSING UNIT (CU-1, CU-2A, CU-2B).

THE INDOOR FURNACE FAN SPEED SHALL BE CONTROLLED BY THE SPLIT-SYSTEM CONTROLLER'S BUILT-IN CONTROL SYSTEM. AT ANY TIME THE BUILDING IS IN OCCUPIED MODE, THE OUTDOOR AIR DAMPER SHALL OPEN AND THE FAN SHALL OPERATE CONTINUOUSLY.

EACH SPLIT-SYSTEM SHALL CYCLE ITS REFRIGERANT CIRCUIT IN HEATING OR COOLING MODE DEPENDENT UPON SPACE DEMAND FROM THE ZONE SPACE THERMOSTAT TO MAINTAIN SETPOINT (HEATING: 70 DEGREES, ADJUSTABLE; COOLING: 75 DEGREES, ADJUSTABLE).

IF A ZONE FURNACE IS OPERATING IN THE HEATING MODE, THE GAS FURNACE SHALL BE ENABLED AND THE OUTDOOR CONDENSING UNIT SHALL SHUT DOWN. THE GAS FURNACE SHALL MODULATE ITS BURNER DEPENDENT UPON SPACE DEMAND FROM THE ZONE SPACE THERMOSTAT TO MAINTAIN SETPOINT (70 DEGREES, ADJUSTABLE).

THE SPLIT-SYSTEM FACTORY CONTROLLER SHALL OPERATE ON ITS OWN CONTROLS AND SAFETIES. UPON ACTIVATION OF A DUCT MOUNTED SMOKE DETECTOR, THE UNIT SHALL SHUT DOWN.

ELECTRIC UNIT HEATER SEQUENCE

RECESSED CEILING MOUNTED ELECTRIC UNIT HEATERS (EUH-1,2,3) SERVE THE VESTIBULE AND STAIRWELL SPACES IN THE BUILDING.

ELECTRIC UNIT HEATERS SHALL ACTIVATE UPON A SIGNAL FROM ITS INTEGRAL THERMOSTAT WHEN THE SPACE TEMPERATURE DROPS BELOW SETPOINT (70 DEGREES, ADJUSTABLE).

JANITOR CLOSET EXHAUST FAN SEQUENCE

EXHAUST FAN EF-3 SHALL RUN CONTINUOUSLY.

RESTROOM EXHAUST FAN SEQUENCE (EF-1,2,4)

EXHAUST FANS EF-1,2, AND 4 SHALL BE TIED INTO THE LIGHT SWITCH. UPON ACTIVATION OF THE LIGHT SWITCH, THE FAN SHALL RUN.

VAV ZONE DIFFUSER SEQUENCE

THE VAV ZONE DIFFUSERS SHALL BE CONTROLLED BY A REMOTE THERMOSTAT. CONFERENCE ROOM 103 INCLUDES A MASTER VAV DIFFUSER AND DRONE VAV DIFFUSER. ALL OTHER SPACES WITH ZONE DIFFUSERS ONLY CONSIST OF A MASTER VAV ZONE DIFFUSER.

SUMMER

THE VAV ZONE DIFFUSER(S) SHALL BE CONTROLLED BY A DIFFUSER MOUNTED TEMPERATURE SENSOR IN COOLING MODE. A WALL MOUNTED ASSEMBLY WILL PROVIDE SET-POINT ADJUSTMENT.

THE VAV ZONE DIFFUSER(S) SHALL BE NORMALLY FULLY OPEN. UPON A DROP IN SPACE TEMPERATURE BELOW THE COOLING SETPOINT (75°F SUMMER (ADJ.)) THE DAMPER(S) SHALL MODULATE CLOSED UNTIL THE SPACE TEMPERATURE IS SATISFIED. UPON A RISE IN SPACE TEMPERATURE ABOVE THE COOLING SETPOINT (75°F SUMMER (ADJ.)), THE DAMPER(S) SHALL MODULATE OPEN UNTIL THE SPACE TEMPERATURE IS SATISFIED.

WINTER

THE VAV ZONE DIFFUSER(S) SHALL BE CONTROLLED BY A WALL MOUNTED ASSEMBLY IN HEATING MODE AND SHALL PROVIDE SET-POINT ADJUSTMENT.

THE VAV ZONE DIFFUSER(S) SHALL BE NORMALLY FULLY OPEN. UPON A RISE IN SPACE TEMPERATURE ABOVE THE HEATING SETPOINT (70°F (ADJ.)) THE DAMPER(S) SHALL MODULATE CLOSED UNTIL THE SPACE TEMPERATURE IS SATISFIED. UPON A DROP IN SPACE TEMPERATURE BELOW THE HEATING SETPOINT (70°F (ADJ.)), THE DAMPER(S) SHALL MODULATE OPEN UNTIL THE SPACE TEMPERATURE IS SATISFIED.

FC - FORWARD CURVE															FANS							
TAG	LOCATION	SERVICE	FAN TYPE	WHEEL TYPE	CFM	RPM	ESP (IN WC)	MOTOR			MAX SONES	MANUFACTURER AND MODEL	WEIGHT (LBS)	REMARKS								
								WATTS	PH	VOLT												
EF-1,2	RESTROOMS	EXHAUST	CENTRIFUGAL	FC	100	784	0.5	24	1	115	3.5	GREENHECK SP-A390-VG	32	PROVIDE WITH DISCONNECT SWITCH, GRAVITY BACKDRAFT DAMPER, ROUND DUCT CONNECTION STANDARD GRILLE								
EF-3	JAN CLST.	EXHAUST	CENTRIFUGAL	FC	50	935	0.549	6	1	115	2.0	GREENHECK SP-80-VG	12	PROVIDE WITH DISCONNECT SWITCH, GRAVITY BACKDRAFT DAMPER, ROUND DUCT CONNECTION STANDARD GRILLE								
EF-4	RESTROOM	EXHAUST	CENTRIFUGAL	FC	70	935	0.487	6	1	115	2.0	GREENHECK SP-80-VG	19	PROVIDE WITH DISCONNECT SWITCH, GRAVITY BACKDRAFT DAMPER, ROUND DUCT CONNECTION STANDARD GRILLE, PITCHED ROOF CAP W/BUILT-IN BIRDSCREEN								

DIFFUSER, REGISTER, AND GRILLES												
TAG	SERVICE	NECK SIZE (IN)	TYPE	DAMPER	FACE SIZE	MATERIAL	FINISH	PATTERN	MANUFACTURER	MODEL NO.	CONTROL POWER (V)	REMARKS
D1	CEILING SUPPLY AIR	SEE PLANS	SQUARE LAY-IN	YES	24x24	STEEL	BAKED ON WHITE ENAMEL	4-WAY	ACCUTHERM	ADV	120	ALL
D2	CEILING SUPPLY AIR	SEE PLANS	SQUARE LAY-IN	NO	24x24	STEEL	BAKED ON WHITE ENAMEL	4-WAY	TITUS	OMNI	-	-
G1	TRANSFER AIR	126	GRILLE SURFACE	NO	NECK SIZE + 1.75"	STEEL	BAKED ON WHITE ENAMEL	-	TITUS	350RL	-	-

NOTES:
 1. PROVIDE WITH WALL MOUNTED THERMOSTAT.
 2. PROVIDE WITH 115V TO 24V ONBOARD TRANSFORMER FOR MASTER.

LOUVER SCHEDULE											
EQUIPMENT BASED ON GREENHECK UNLESS NOTED OTHERWISE											
TAG	MODEL	LOCATION	SERVICE	CFM	TYPE	MATERIAL	DIMENSION HxWxD (IN)	FREE FACE AREA (SF)	MAX SP DROP	FREE AREA VEL (FPM)	REMARKS
L-1	ESD-635	MECH ROOM	INTAKE	460	STATIONARY DRAINABLE	ALUM	14x36x6	1.1	0.03	420	ALL


NOTES: 1. PROVIDE WITH BIRDSCREEN.

ELECTRIC UNIT HEATER SCHEDULE									
EQUIPMENT BASED ON QMARK UNLESS NOTED OTHERWISE									
UNIT DATA				HEATING ELEMENTS					REMARKS
TAG	SERVICE	MODEL	TYPE	CFM	AMPS	TOTAL KW	VOLTS	PHASE	
EUH-1	VESTIBULE 101	CDF-548	RECESSED	300	9.6	2	208	1	ALL
EUH-2	STAIRS 105	CDF-548	RECESSED	300	19.2	4	208	1	ALL
EUH-3	STAIRS 111	CDF-548	RECESSED	300	19.2	4	208	1	ALL

NOTES:
 1. PROVIDE INTEGRAL THERMOSTAT.
 2. PROVIDE INTEGRAL DISCONNECT SWITCH.
 3. PROVIDE RECESSED ENCLOSURE.

#	DATE	CHANGE DESCRIPTION

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DRAWING TITLE:

SCHEDULES - MECHANICAL

PROGRESS DRAWING NOT FOR CONSTRUCTION	09/10/2020	
	DRAWN BY: Author	CHECKED BY: Checker
	2022	
	M-601	
PRELIMINARY DEVELOPMENT PLAN		

ABBREVIATIONS	
NOTE: NOT ALL ABBREVIATIONS MAY BE USED.	
(A)	EXISTING TO BE ABANDONED
(D)	EXISTING TO BE DEMOLISHED
(E)	EXISTING TO REMAIN
(F)	FUTURE
(R)	EXISTING TO BE RELOCATED
A	AMPERE
AC	ALTERNATING CURRENT OR AIR CONDITIONER
AFF	ABOVE FINISHED FLOOR
AFG	ABOVE FINISHED GRADE
AIC	AMPS INTERRUPTING CAPACITY
ANNC	ANNUNCIATOR
AWG	AMERICAN WIRE GAUGE
BPS	BOLTED PRESSURE SWITCH
C	CONDUIT
CB	CIRCUIT BREAKER
CCTV	CLOSED CIRCUIT TELEVISION
CKT	CIRCUIT
CM	CONSTRUCTION MANAGER
DC	DIRECT CURRENT
DP	DISTRIBUTION PANELBOARD
DTT	DOUBLE TWIN TUBE
EB	ELECTRONIC BALLAST
EC	ELECTRICAL CONTRACTOR
EM	EMERGENCY
EMT	ELECTRICAL METAL TUBING
EWC	ELECTRIC WATER COOLER
FA	FIRE ALARM
FLA	FULL LOAD AMPS
G	GROUND
GC	GENERAL TRADES CONTRACTOR
GFCI	GROUND FAULT CIRCUIT INTERRUPTER
GEN	GENERATOR
HOA	HAND-OFF-AUTOMATIC
HP	HORSEPOWER
HPC	HIGH PRESSURE CONTACT SWITCH
HZ	HERTZ
IG	ISOLATED GROUND
IMC	INTERMEDIATE METAL CONDUIT
INCD	INCANDESCENT
KVA	KILOVOLT AMPERE
KW	KILOWATT
LTG	LIGHTING OR LIGHT
LRA	LOCKED ROTOR AMPS
MCA	MINIMUM CIRCUIT AMPACITY
MCB	MAIN CIRCUIT BREAKER
MCC	MOTOR CONTROL CENTER
MDP	MAIN DISTRIBUTION PANEL
MLO	MAIN LUGS ONLY
MOCP	MAXIMUM OVERCURRENT PROTECTION
MSB	MAIN SWITCHBOARD
MH	METAL HALIDE
MTS	MANUAL TRANSFER SWITCH
NAC	NOTIFICATION APPLIANCE CIRCUIT
NC	NORMALLY CLOSED
NO	NORMALLY OPEN
NF	NON-FUSED
OCC	OCCUPANCY
PA	PUBLIC ADDRESS
PB	PULL BOX OR PUSH BUTTON
PVC	POLYVINYL CHLORIDE (PLASTIC PIPE)
PWR	POWER
RECP	RECEPTACLE
STP	SHIELDED, TWISTED PAIR
TC	TIME CLOCK
TRT	TRIPLE TUBE
TYP	TYPICAL
UNO	UNLESS NOTED OTHERWISE
UTP	UNSHIELDED, TWISTED PAIR
V	VOLT
W	WATT
WAP	WIRELESS ACCESS POINT
WH	WATTHOUR
WP	WEATHERPROOF, NEMA 3R UNO
XFMR	TRANSFORMER
Z	IMPEDANCE
∅	PHASE

LIGHTING SYMBOLS	
NOTE: NOT ALL SYMBOLS MAY BE USED.	
	GENERAL PURPOSE LUMINAIRE: REFER TO LUMINAIRE SCHEDULE FOR ADDITIONAL INFORMATION
	GENERAL PURPOSE LUMINAIRE ON EMERGENCY POWER: REFER TO LUMINAIRE SCHEDULE FOR ADDITIONAL INFORMATION
	GENERAL PURPOSE DUAL BALLAST LUMINAIRE ONE BALLAST ON EMERGENCY POWER: REFER TO LUMINAIRE SCHEDULE FOR ADDITIONAL INFORMATION
○	ROUND LUMINAIRE: REFER TO LUMINAIRE SCHEDULE FOR ADDITIONAL INFORMATION
○	WALL WASHER: REFER TO LUMINAIRE SCHEDULE FOR ADDITIONAL INFORMATION
○	WALL MOUNTED LUMINAIRE: REFER TO LUMINAIRE SCHEDULE FOR ADDITIONAL INFORMATION
△	WALL MOUNTED DECORATIVE LUMINAIRE: REFER TO LUMINAIRE SCHEDULE FOR ADDITIONAL INFORMATION
□	WALL MOUNTED FLOOD LIGHT: REFER TO LUMINAIRE SCHEDULE FOR ADDITIONAL INFORMATION
	TRACK LIGHTING
	TRACK LIGHTING HEAD
	REMOTE HEAD
	STEP LIGHT
	EMERGENCY LIGHT
	EXIT SIGN
	CEILING MOUNTED ILLUMINATED EXIT SIGN WITH DIRECTIONAL ARROWS
	EMERGENCY DUAL FACE ILLUMINATED EXIT SIGN WITH DIRECTIONAL ARROWS
	EXIT SIGN WITH INTEGRAL HEADS
\$x	SWITCH: X=BLANK-SINGLE POLE 20A, TOGGLE; X=S-THREE WAY, X=H-FOUR WAY, X=P-PILOT LIGHT; X=K-KEY, X=MS-MOMENTARY
☉	PHOTOCELL
	WALL MOUNTED OCCUPANCY SENSOR: X=BLANK-DUAL TECHNOLOGY; X=IR-PASSIVE INFRARED, X=US-ULTRASONIC
	CEILING MOUNTED OCCUPANCY SENSOR: X=BLANK-DUAL TECHNOLOGY; X=IR-PASSIVE INFRARED, X=US-ULTRASONIC
D	DIMMER
PP	POWER PACK
J	JUNCTION BOX
	PANELBOARD
■	LIGHTING CONTROL PANEL
⊠	LOW VOLTAGE TRANSFORMER

POWER SYMBOLS	
NOTE: NOT ALL SYMBOLS MAY BE USED.	
	20A DUPLEX RECEPTACLE WITH COVER PLATE: X=TYPE, Y=NON-STANDARD MOUNTING HEIGHT, Z=SPECIAL DESIGNATION, (18" AFF TYPICAL)
	DUPLEX RECEPTACLE ON EMERGENCY CIRCUIT WITH COVER PLATE: X=TYPE, Y=NON-STANDARD MOUNTING HEIGHT, Z=SPECIAL DESIGNATION, (18" AFF TYPICAL)
⊕	FLOOR OR CEILING MOUNTED DUPLEX RECEPTACLE:
	DUPLEX RECEPTACLE: ABOVE COUNTER (48" AFF TYPICAL)
	DOUBLE DUPLEX RECEPTACLE WITH SINGLE COVER PLATE
	SIMPLEX RECEPTACLE WITH COVER PLATE
WRP	WEATHER RESISTANT DUPLEX RECEPTACLE, GROUND FAULT CIRCUIT INTERRUPTING WITH IN-USE COVER
⊕	WALL MOUNTED SPECIAL RECEPTACLE: REFER TO PLANS FOR ADDITIONAL INFORMATION
F.C	FLOOR OR CEILING MOUNTED SPECIAL RECEPTACLE: F=FLOOR, C=CEILING REFER TO PLANS FOR ADDITIONAL INFORMATION
	SURFACE MOUNTED RACEWAY
X	STANDARD DISCONNECT SWITCH: X=DISCONNECT SIZE, Y=NUMBER OF POLES
	STANDARD FUSED DISCONNECT SWITCH: X=DISCONNECT SIZE, Y=FUSE SIZE, Z=NUMBER OF POLES
	MOTOR STARTER: X=STARTER SIZE, Y=NUMBER OF POLES
	COMBINATION MOTOR STARTER/DISCONNECT SWITCH: X=STARTER SIZE, Y=FUSE SIZE, Z=NUMBER OF POLES
M	MOTOR (BY OTHERS); PROVIDE POWER AS INDICATED
\$	FRACTIONAL HORSEPOWER MANUAL MOTOR STARTER
J	JUNCTION BOX
⊠	TRANSFORMER
H	HANDHOLE/POLE BOX: SEE DETAILS FOR ADDITIONAL INFORMATION
CP	CONTROL PANEL
SPD	SURGE PROTECTIVE DEVICE
	PANELBOARD
ATS	AUTOMATIC TRANSFER SWITCH
VFD	VARIABLE FREQUENCY DRIVE (BY DIVISION 23)
P	PUSH BUTTON
P	POWER POLE
R	CORD REEL
⊕	GROUND ROD
⊕x	POKE THROUGH SERVICE FITTING: X=TYPE

TELECOMM SYMBOLS	
NOTE: NOT ALL SYMBOLS MAY BE USED.	
	WALL MOUNTED DATA OUTLET (18" AFF): X=NUMBER OF OUTLETS
	CEILING MOUNTED DATA OUTLET: C=CEILING
	WALL MOUNTED PHONE/DATA OUTLET (18" AFF): X=NUMBER OF OUTLETS (P=PHONE, D=DATA)
	WIRELESS ACCESS POINT
	POKE THROUGH DEVICE: PROVIDE (1) DUPLEX OUTLET AND (2) CAT6 DATA JACKS, TERMINATE DATA ON PATCH PANEL IN NEAREST IT CLOSET: A=POWER / AV / DATA, B=POWER / DATA
	SURFACE MOUNTED RACEWAY
	CABLE TRAY
	EQUIPMENT RACK
	TELEPHONE TERMINAL BOARD: PLYWOOD BACKBOARD: REFER TO PLANS FOR ACTUAL LENGTHS

DRAWING INDEX	
DWG NO.	SHEET TITLE
E-001	GENERAL INFORMATION - ELECTRICAL
ED10X	FLOOR PLAN - ELECTRICAL - DEMOLITION
E-10X	FLOOR PLAN - LIGHTING
E-20X	FLOOR PLAN - POWER
E-30X	FLOOR PLAN - SYSTEMS
E-40X	ENLARGED PLANS - ELECTRICAL
E-50X	DETAILS - ELECTRICAL
E-60X	SCHEDULES - ELECTRICAL
E-70X	DIAGRAMS - ELECTRICAL

LINE TYPE LEGEND	
	EXISTING TO REMAIN
	EXISTING TO BE REMOVED
	NEW WORK

SECURITY SYMBOLS	
NOTE: NOT ALL SYMBOLS MAY BE USED.	
	CAMERA: PTZ=PAN, TILT, AND ZOOM; F=FIXED DIRECTIONAL; D=DOME CAMERA
AH	ALARM HORN
CR	CARD READER
DL	DOOR LATCH
IC	INTERCOM
KP	KEY PAD
LM	LATCH MONITOR
MS	MONITORING STATION
MD	MOTION DETECTOR
TS	TAMPER SWITCH
PS	POWER SUPPLY
RE	REQUEST EXIT
ES	ELECTRIC STRIKE
P	PUSH BUTTON
R	CCTV EQUIPMENT RACK

PAGING SYMBOLS	
NOTE: NOT ALL SYMBOLS MAY BE USED.	
	MICROPHONE OUTLET
⊕	WALL MOUNTED HORN
⊕	CEILING MOUNTED HORN
⊕	WALL MOUNTED SPEAKER
⊕	CEILING MOUNTED SPEAKER
V	VOLUME CONTROL STATION
R	EQUIPMENT RACK


#	DATE	CHANGE DESCRIPTION

RENOVATION OF HEARTLAND BANK DUBLIN
6500 FRANTZ ROAD
DUBLIN, OH 43017
FOR
HEARTLAND BANK

300 SPRUCE STREET
SUITE 300
COLUMBUS, OHIO 43215
PHONE: (614) 461-4664
FAX: (614) 280-8881

DRAWING TITLE:
GENERAL INFORMATION - ELECTRICAL

PROGRESS DRAWING NOT FOR CONSTRUCTION	09/10/2020 DRAWN BY: Author CHECKED BY: Checker 20022 E-001 PRELIMINARY DEVELOPMENT PLAN
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1 PLAN SITE PLAN - ELECTRICAL
 1" = 10'-0"

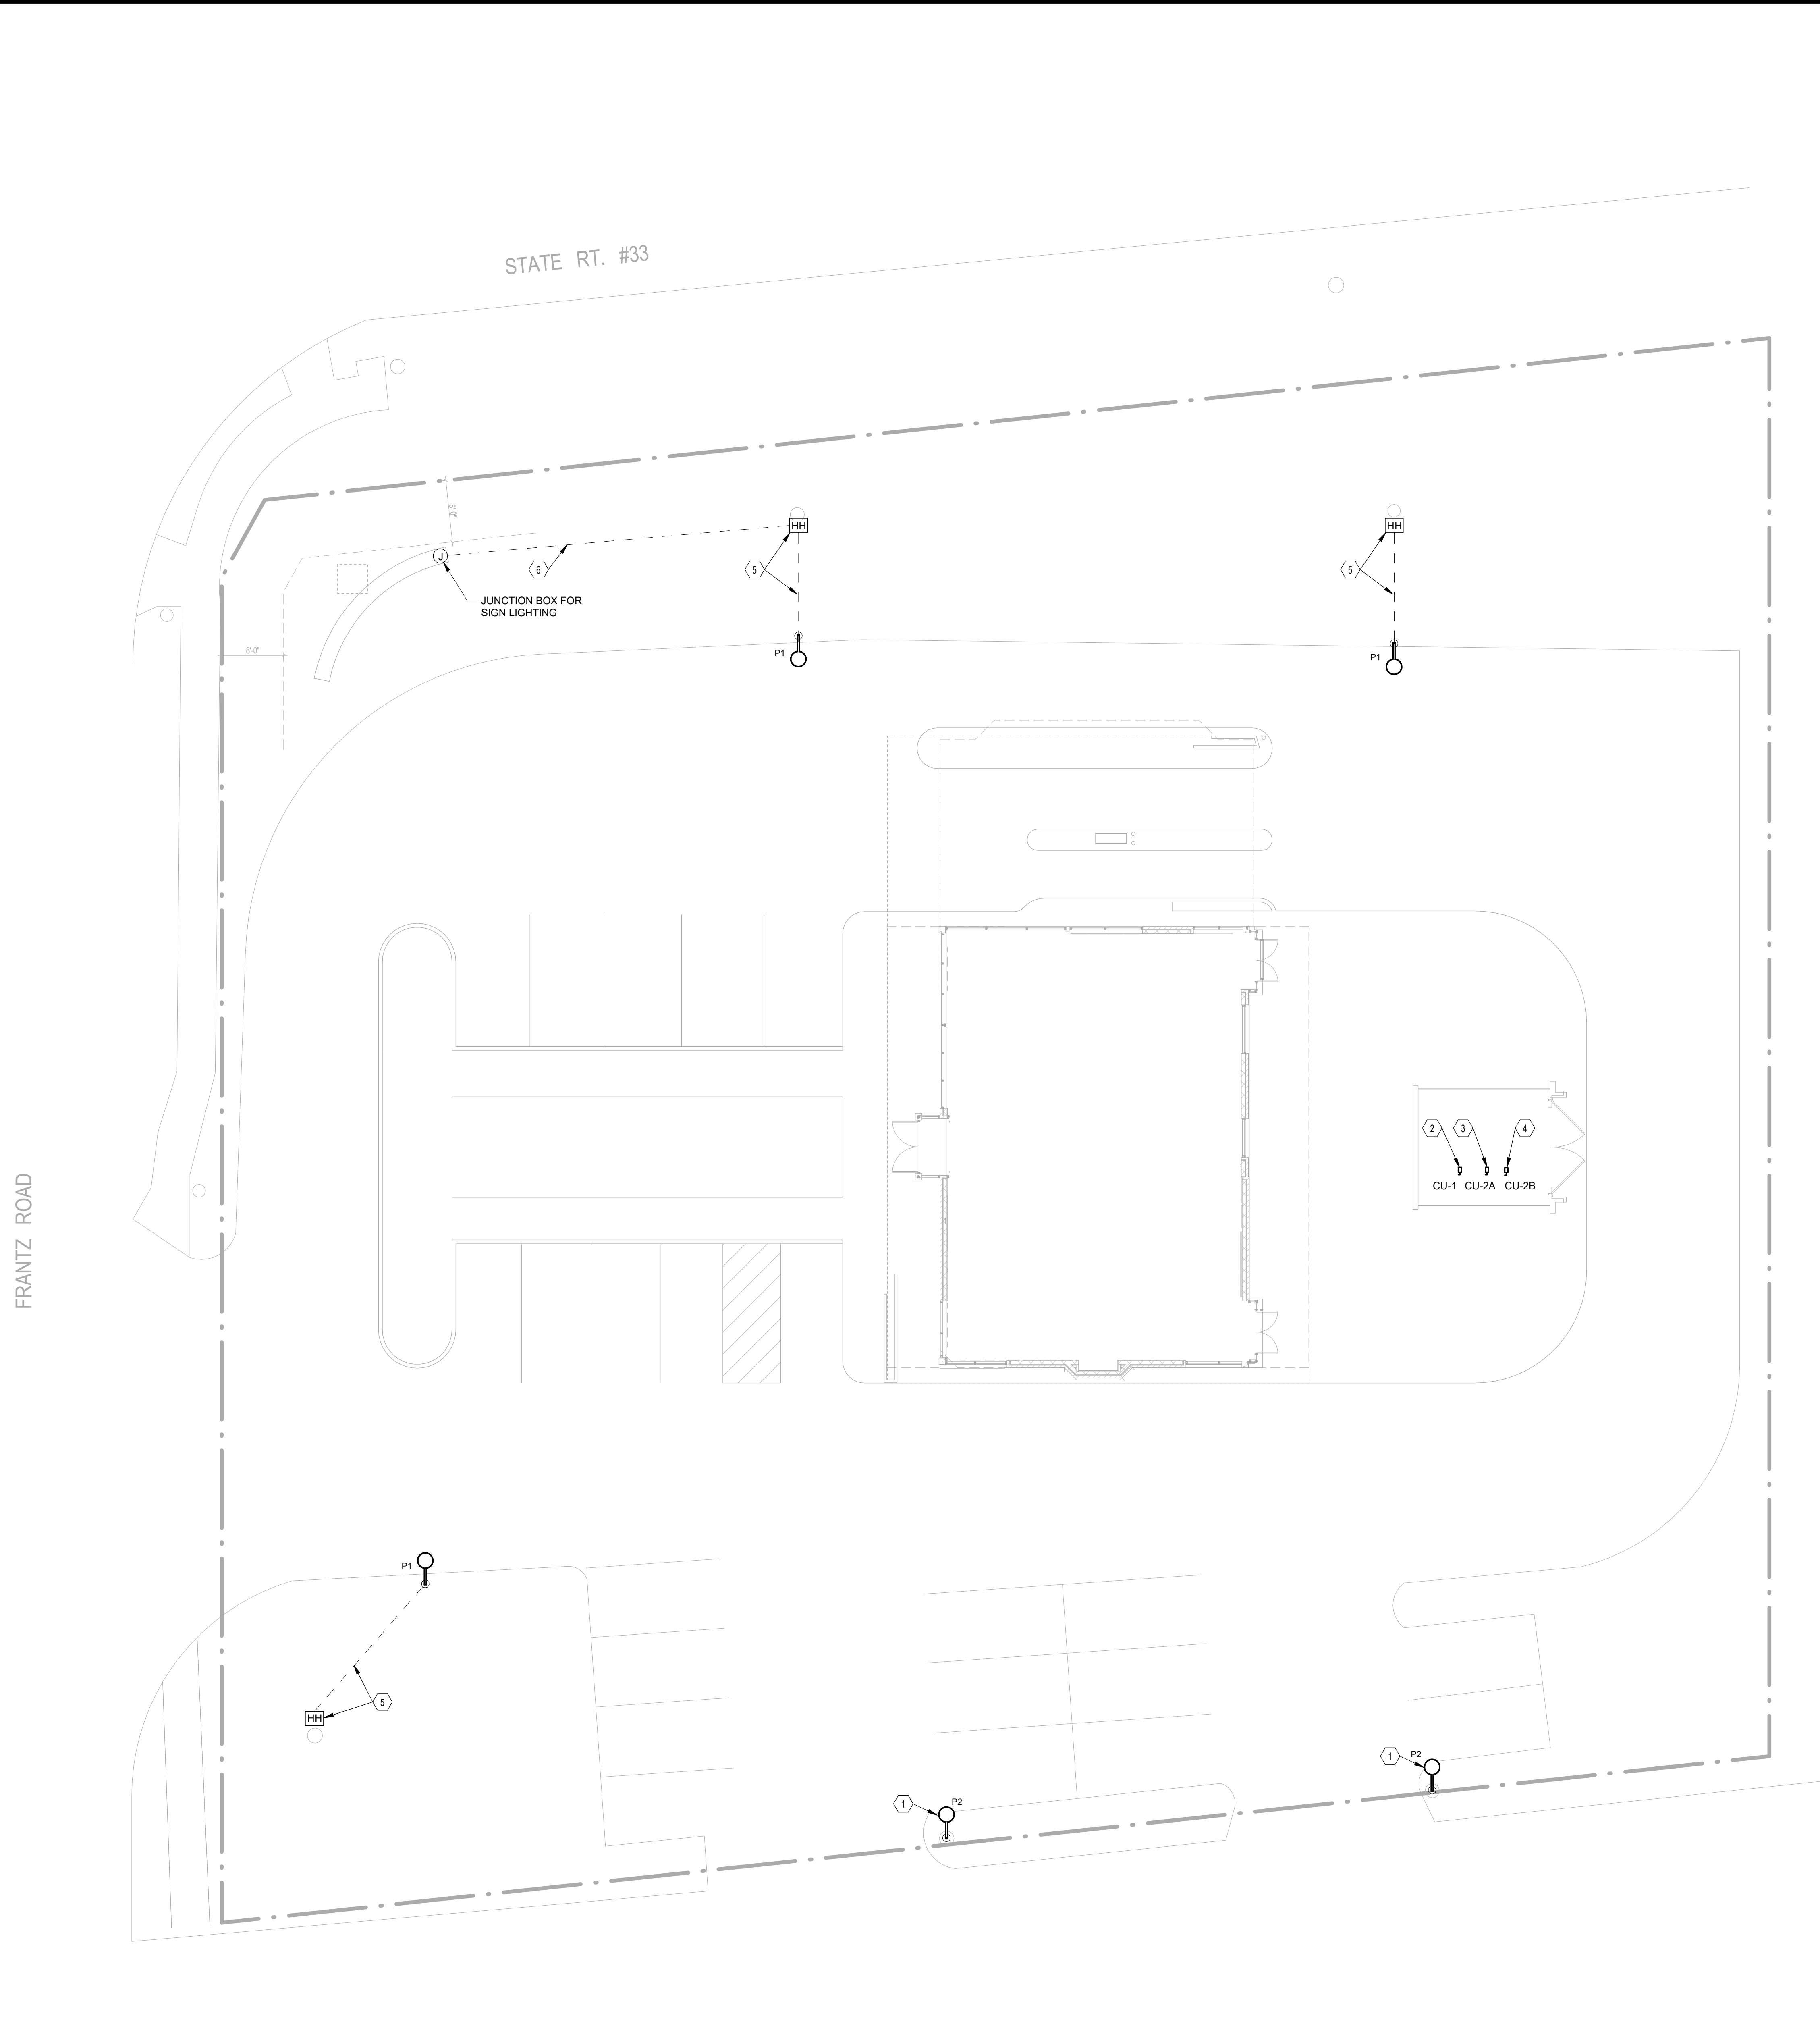GENERAL NOTES:

- A. UNLESS NOTED OTHERWISE, MINIMUM CONDUIT SIZE FOR ALL EXTERIOR INSTALLATIONS SHALL BE 1".
- B. UNDERGROUND CONDUIT ROUTING SHOWN IS DIAGRAMATIC. CONTRACTOR SHALL CONDUCT UNDERGROUND UTILITY LOCATING AND DETERMINE EXACT ROUTING. CONTRACTOR SHALL ALSO CONTACT "DUPS" NO LESS THAN 7 CALENDAR DAYS PRIOR TO DIGGING.
- C. COORDINATE ALL SITE WORK WITH OTHER TRADES AND EXISTING UNDERGROUND UTILITIES.

CODED NOTES:

- 1. PROVIDE 20' LIGHT POLE AND LUMINAIRE ON EXISTING POLE BASE. EXTEND EXISTING CIRCUIT TO LUMINAIRE.
- 2. CU-1, 208V, 1PH: PROVIDE 30/2 NEMA 3R FUSED DISCONNECT. PROVIDE UNISTRUT SUPPORT AS NECESSARY.
- 3. CU-2A, 208V, 1PH: PROVIDE 30/2 NEMA 3R FUSED DISCONNECT. PROVIDE UNISTRUT SUPPORT AS NECESSARY.
- 4. CU-2B, 208V, 1PH: PROVIDE 30/2 NEMA 3R FUSED DISCONNECT. PROVIDE UNISTRUT SUPPORT AS NECESSARY.
- 5. DEMOLISH EXISTING POLE LIGHT AND BASE. PROVIDE HANDHOLE. INTERCEPT CIRCUIT, MATCH WIRE SIZE, MAKE JUNCTIONS AND EXTEND TO NEW LIGHT POLE.
- 6. EXTEND EXISTING LIGHTING CIRCUIT FROM HANDHOLE TO SIGN LIGHTING.

#	DATE	CHANGE DESCRIPTION

RENOVATION OF HEARTLAND BANK DUBLIN
 6500 FRANTZ ROAD
 DUBLIN, OH 43017
 FOR
HEARTLAND BANK


MOODY-NOLAN
 300 SPRUCE STREET
 SUITE 300
 COLUMBUS, OHIO 43215
 PHONE: (614) 461-4664
 FAX: (614) 280-8881

DRAWING TITLE:
SITE PLAN - ELECTRICAL

PROGRESS DRAWING NOT FOR CONSTRUCTION	09/10/2020
	DRAWN BY: Author CHECKED BY: Checker
	20022
	ES-100
	PRELIMINARY DEVELOPMENT PLAN

FRANTZ ROAD

STATE RT. #33

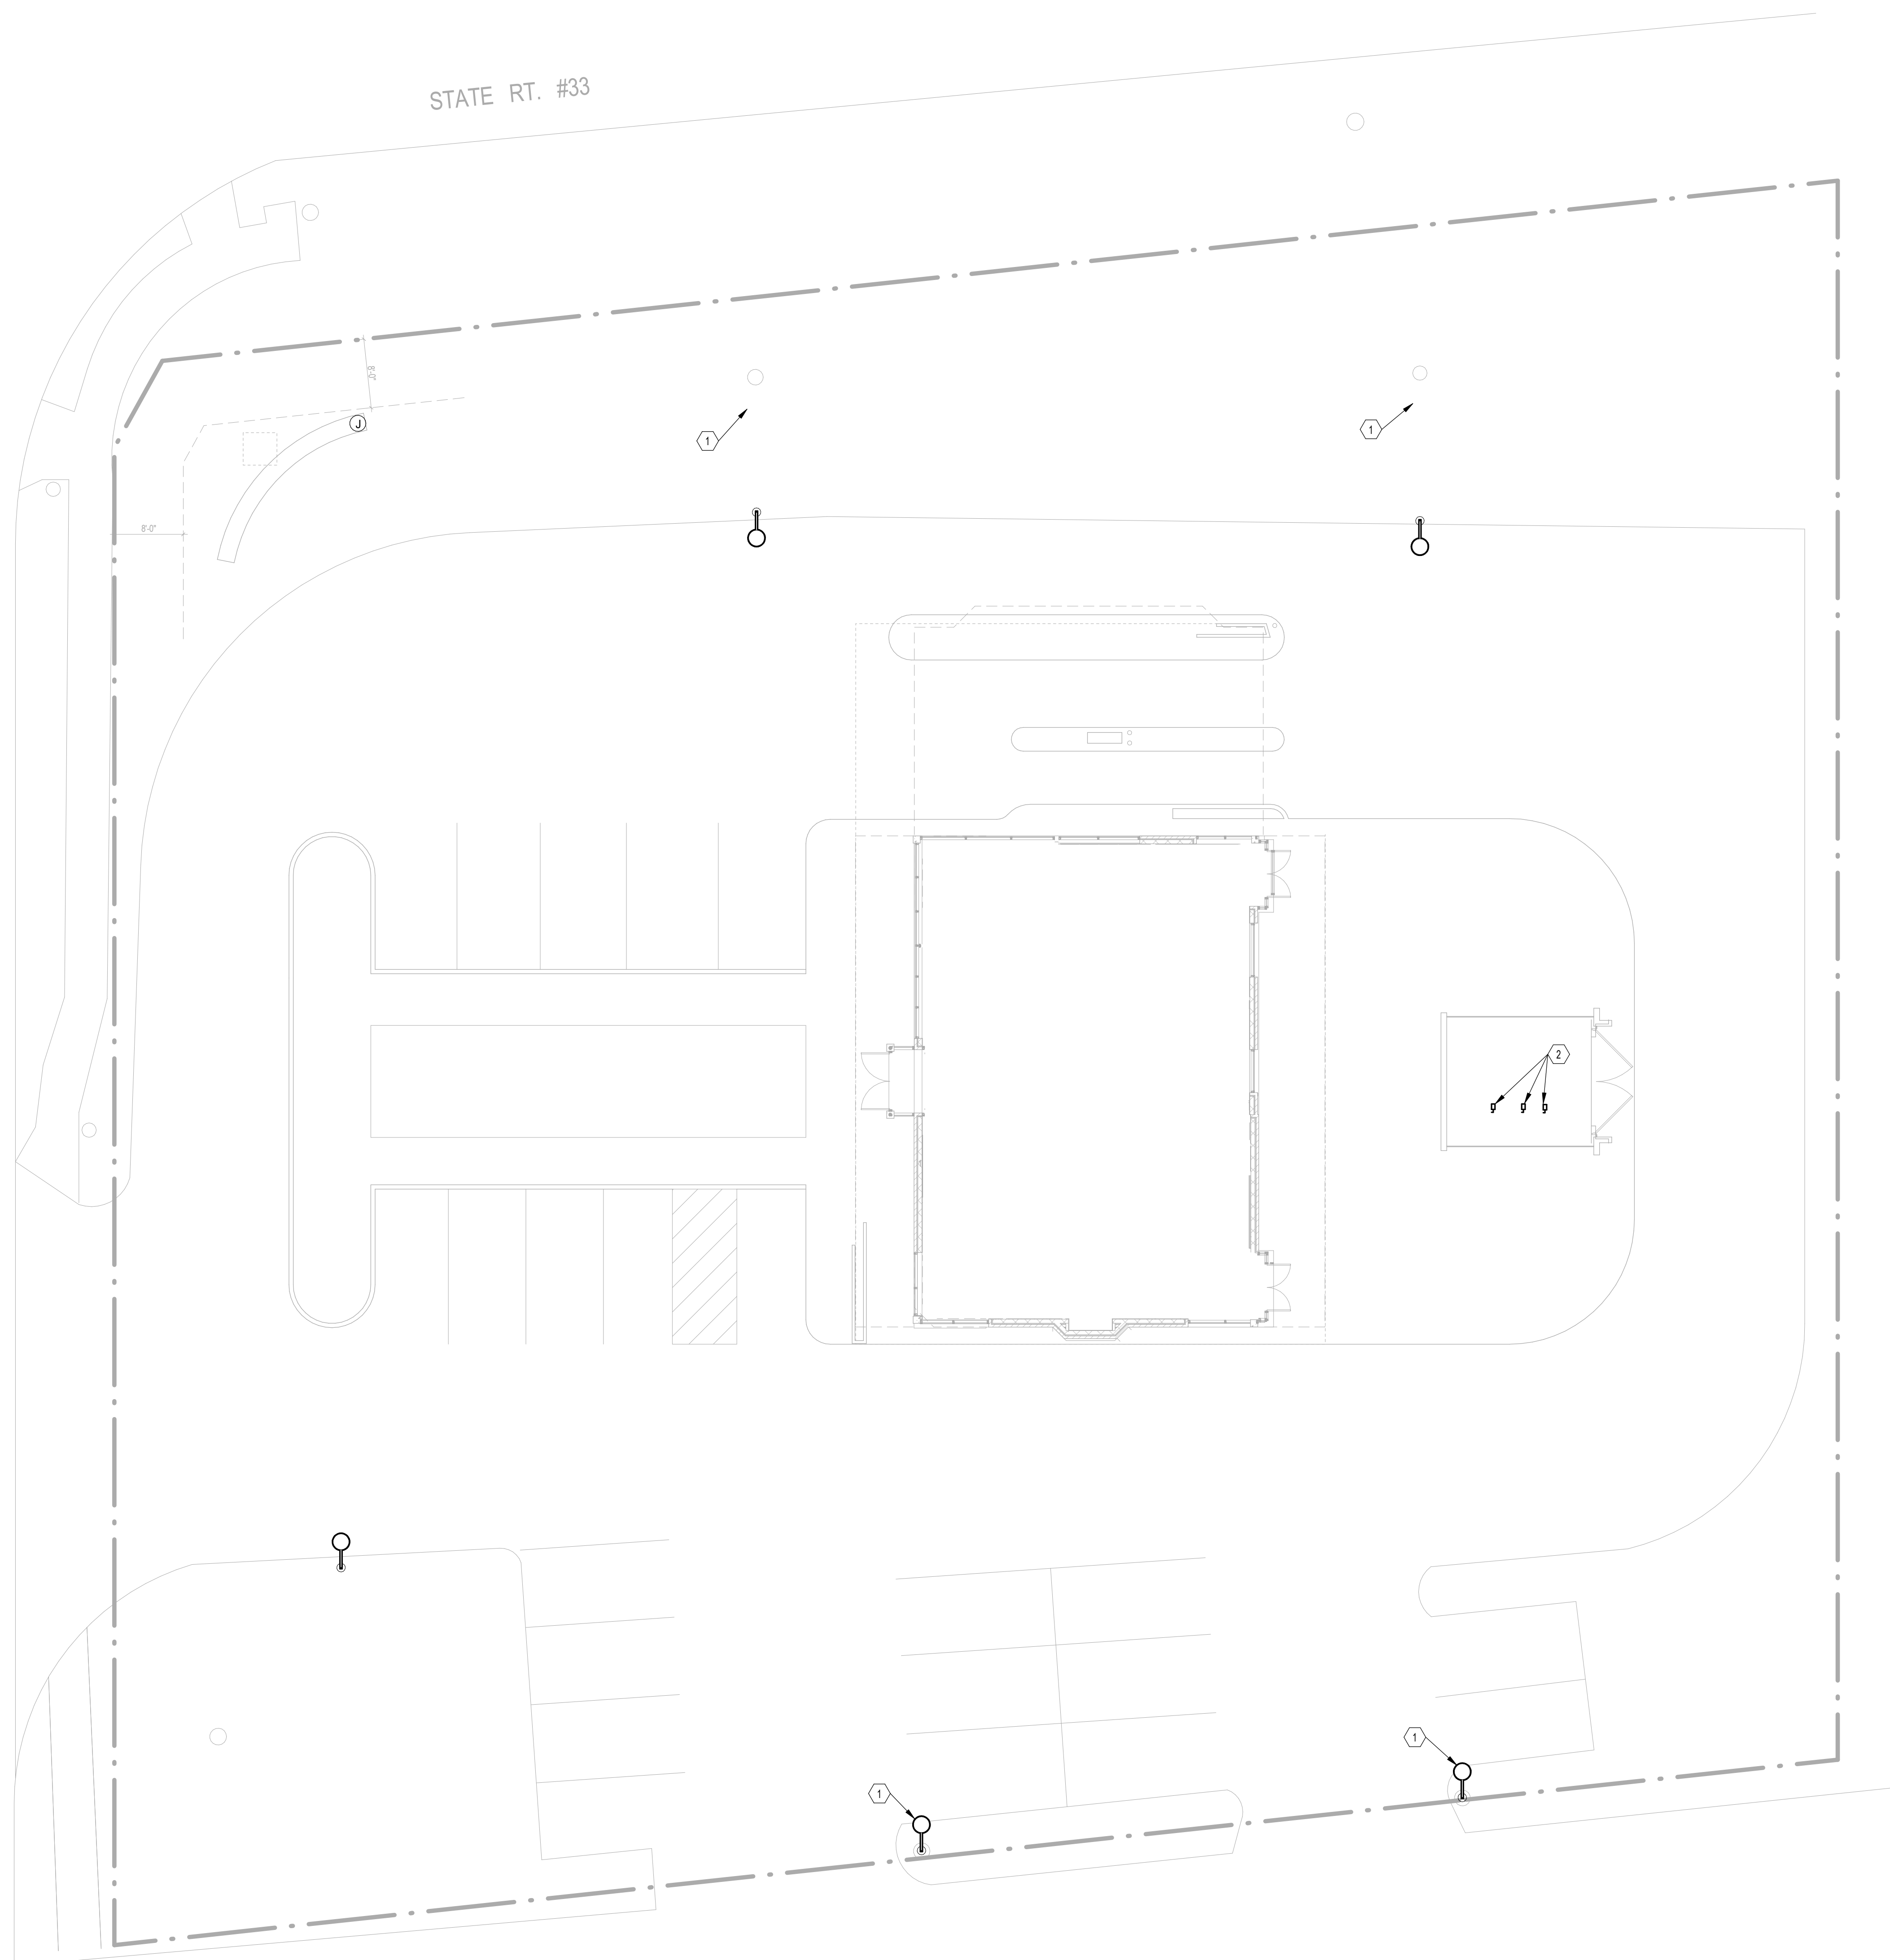

1 **PLAN** SITE PLAN - ELECTRICAL DEMOLITION
1" = 10'-0"

CODED NOTES:

1. DEMOLISH EXISTING LUMINAIRE AND LIGHT POLE. EXISTING BASE AND CIRCUITING TO REMAIN FOR REUSE.
2. POWER CONNECTION TO CONDENSING UNIT. DISCONNECT SWITCH AND CONDUCTORS TO BE DEMOLISHED BACK TO SOURCE.


#	DATE	CHANGE DESCRIPTION

RENOVATION OF HEARTLAND BANK DUBLIN
 6500 FRANTZ ROAD
 DUBLIN, OH 43017
 FOR
HEARTLAND BANK

MOODY-NOLAN
 300 SPRUCE STREET
 SUITE 300
 COLUMBUS, OHIO 43215
 PHONE: (614) 461-4664
 FAX: (614) 280-8881

DRAWING TITLE:
SITE PLAN - ELECTRICAL - DEMOLITION

PROGRESS DRAWING NOT FOR CONSTRUCTION	09/10/2020	
	DRAWN BY: Author	CHECKED BY: Checker
	20022	
ED-100		
PRELIMINARY DEVELOPMENT PLAN		

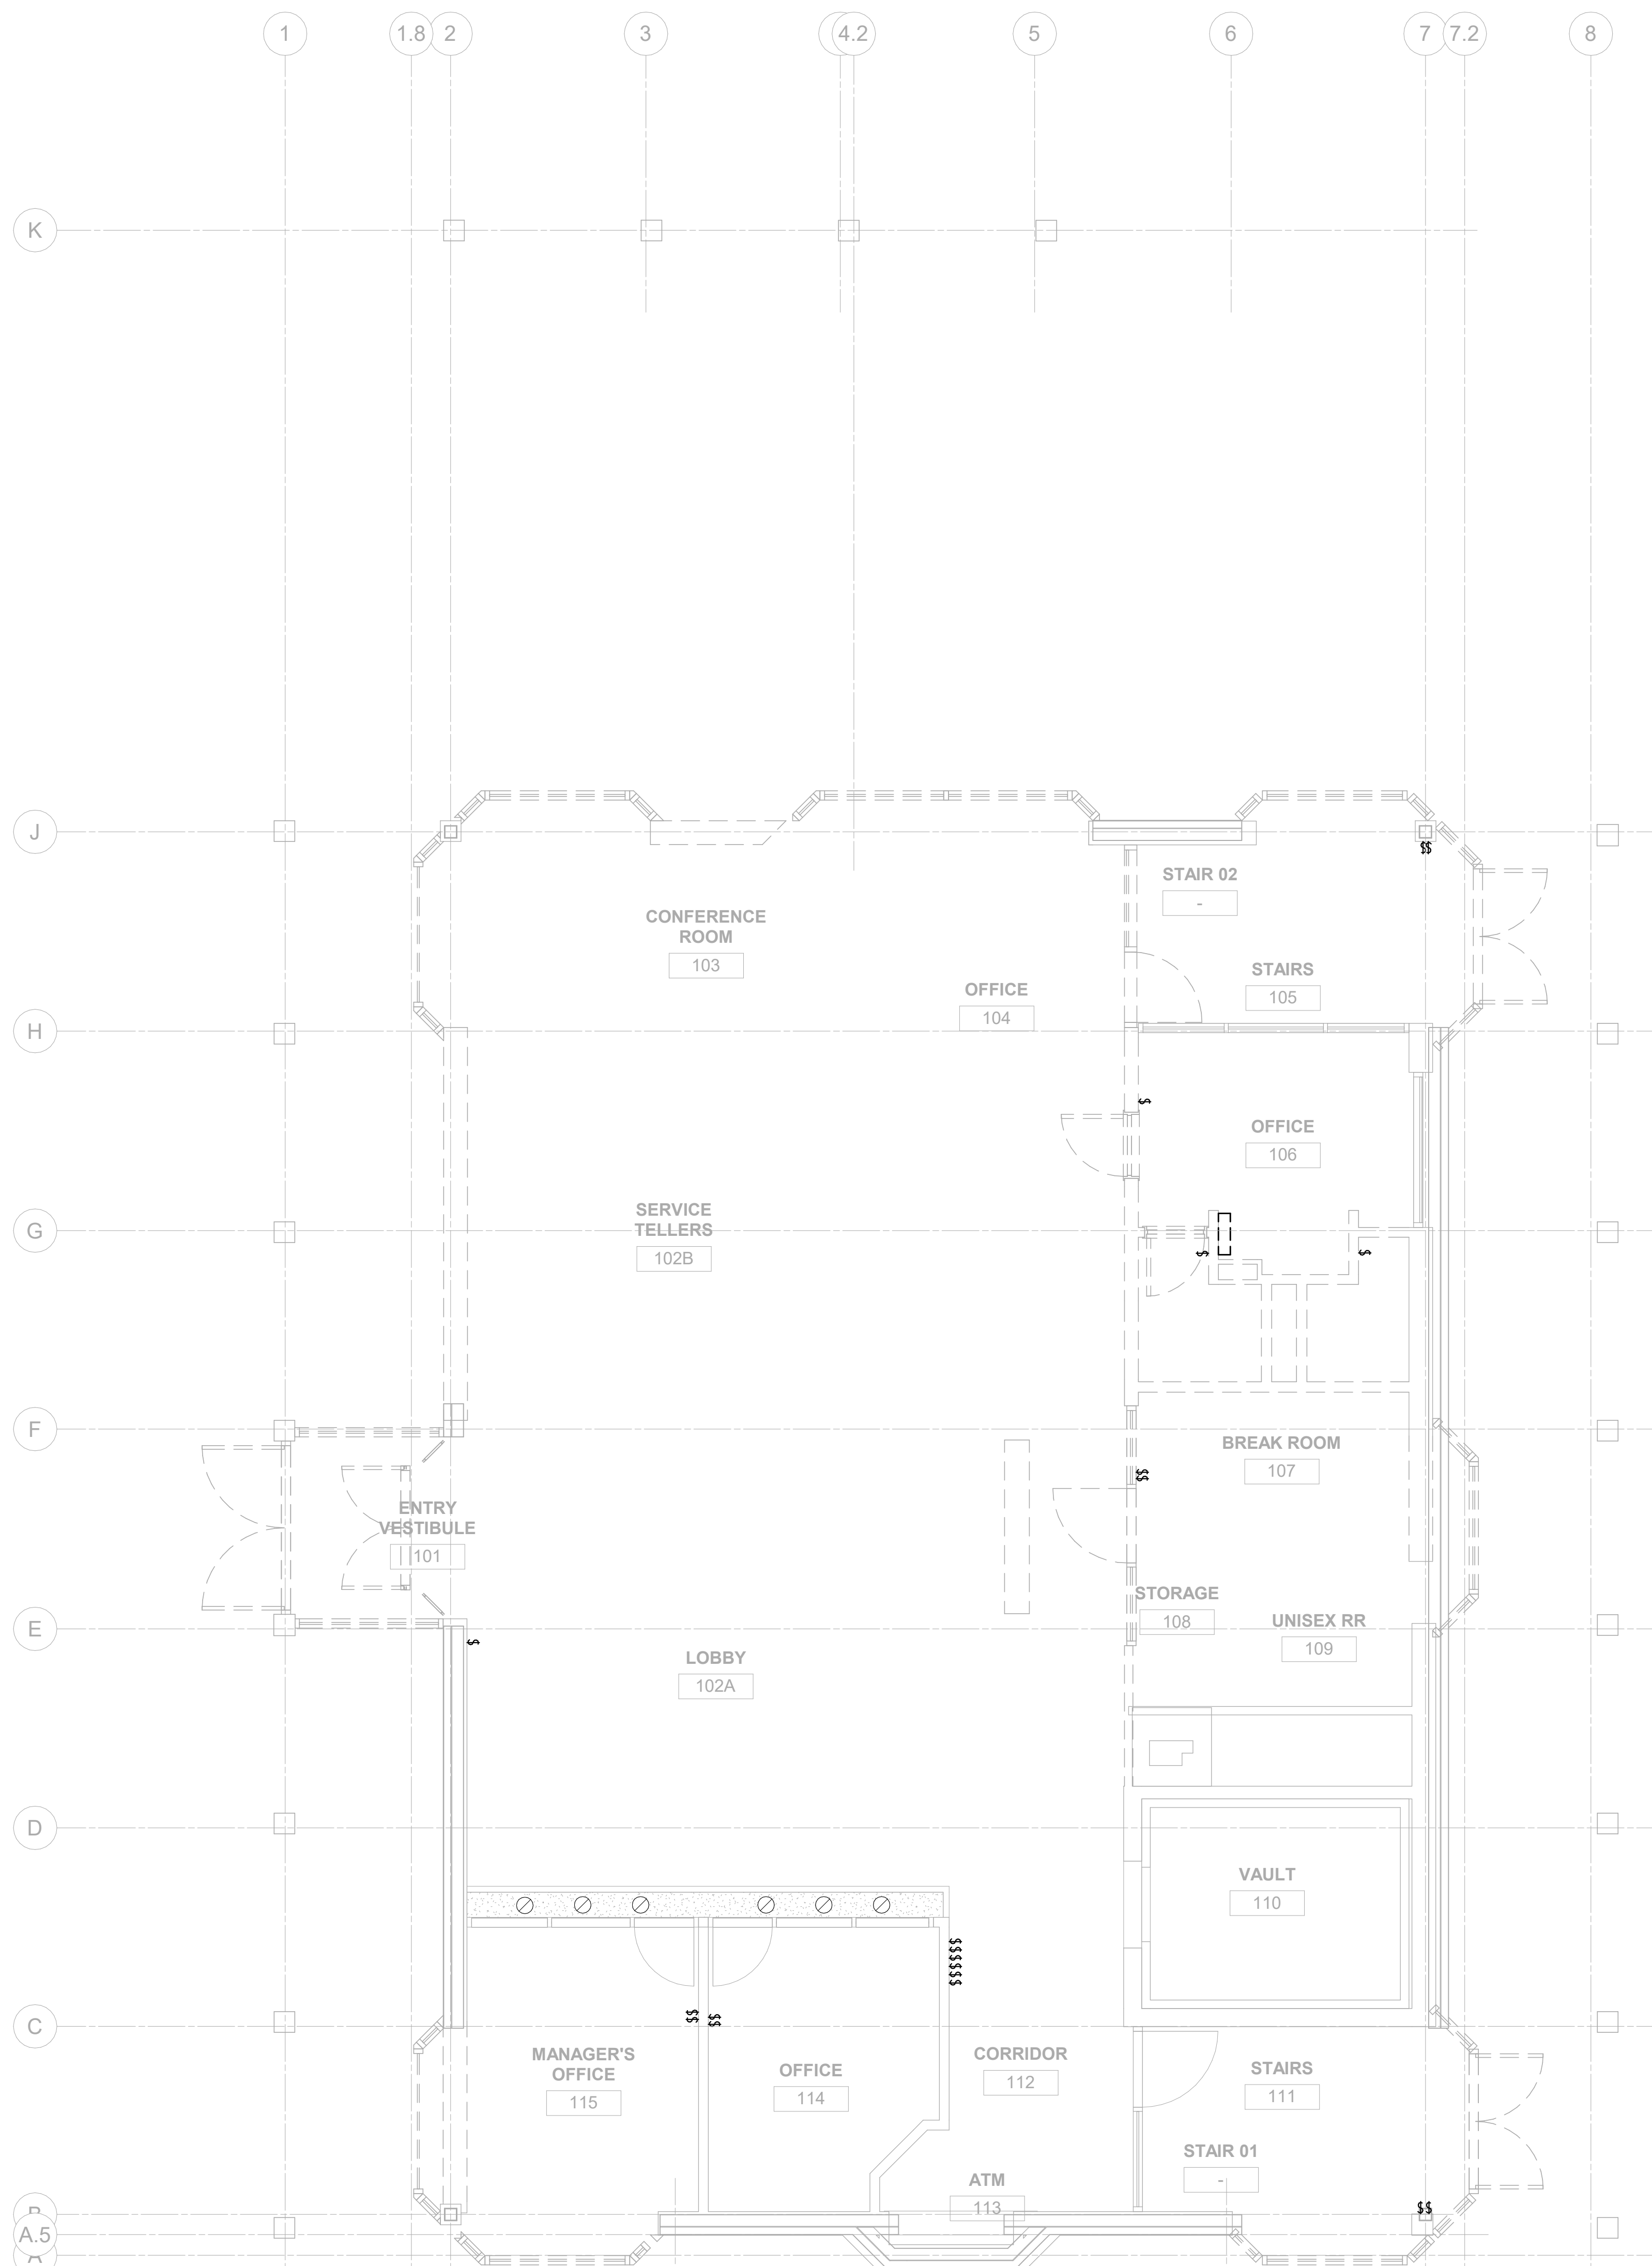

1 PLAN FIRST FLOOR CEILING PLAN - LIGHTING - DEMOLITION
 1/4" = 1'-0"

GENERAL NOTES:

- A. UNLESS NOTED OTHERWISE ALL 1ST FLOOR INTERIOR LUMINAIRES AND CONTROLS SHALL BE DEMOLISHED.
- B. DRAWINGS ARE DIAGRAMMATIC IN NATURE AND REPRESENT AN APPROXIMATION OF INITIAL CONDITIONS. INFORMATION PROVIDED IS BASED ON THE BEST AVAILABLE DATA. ELECTRICAL CONTRACTOR SHALL FIELD VERIFY EXISTING CONDITIONS AND EXTENT OF THE NEW WORK PRIOR TO CONSTRUCTION.
- C. ENSURE THAT ALL LIGHTING FIXTURES AND WIRING DEVICES IN ADJACENT SPACES AND BASEMENT REMAIN OPERATIONAL DURING DEMOLITION AND AFTER RENOVATION IS COMPLETED. PROVIDE NEW BRANCH CIRCUITING AS REQUIRED TO MAINTAIN SERVICE.
- D. ALL EQUIPMENT TO BE REMOVED SHALL BE DISPOSED OF BY THE CONTRACTOR IN ACCORDANCE WITH STATE, LOCAL LAWS, ORDINANCES, RULES AND REGULATIONS.
- E. UNLESS NOTED OTHERWISE, ALL CONDUCTORS OF DEMOLISHED DEVICES AND EQUIPMENT THAT ARE NOT INDICATED FOR REUSE SHALL BE COMPLETELY REMOVED BACK TO SOURCE.

CODED NOTES:

- 1.


#	DATE	CHANGE DESCRIPTION

RENOVATION OF HEARTLAND BANK DUBLIN
 6500 FRANTZ ROAD
 DUBLIN, OH 43017
 FOR HEARTLAND BANK

MOODY-NOLAN
 300 SPRUCE STREET
 SUITE 300
 COLUMBUS, OHIO 43215
 PHONE: (614) 461-4664
 FAX: (614) 280-8881

FLOOR PLANS - LIGHTING - DEMOLITION

PROGRESS DRAWING NOT FOR CONSTRUCTION	09/10/2020 DRAWN BY: Author CHECKED BY: Checker
	2022
	ED-101 PRELIMINARY DEVELOPMENT PLAN

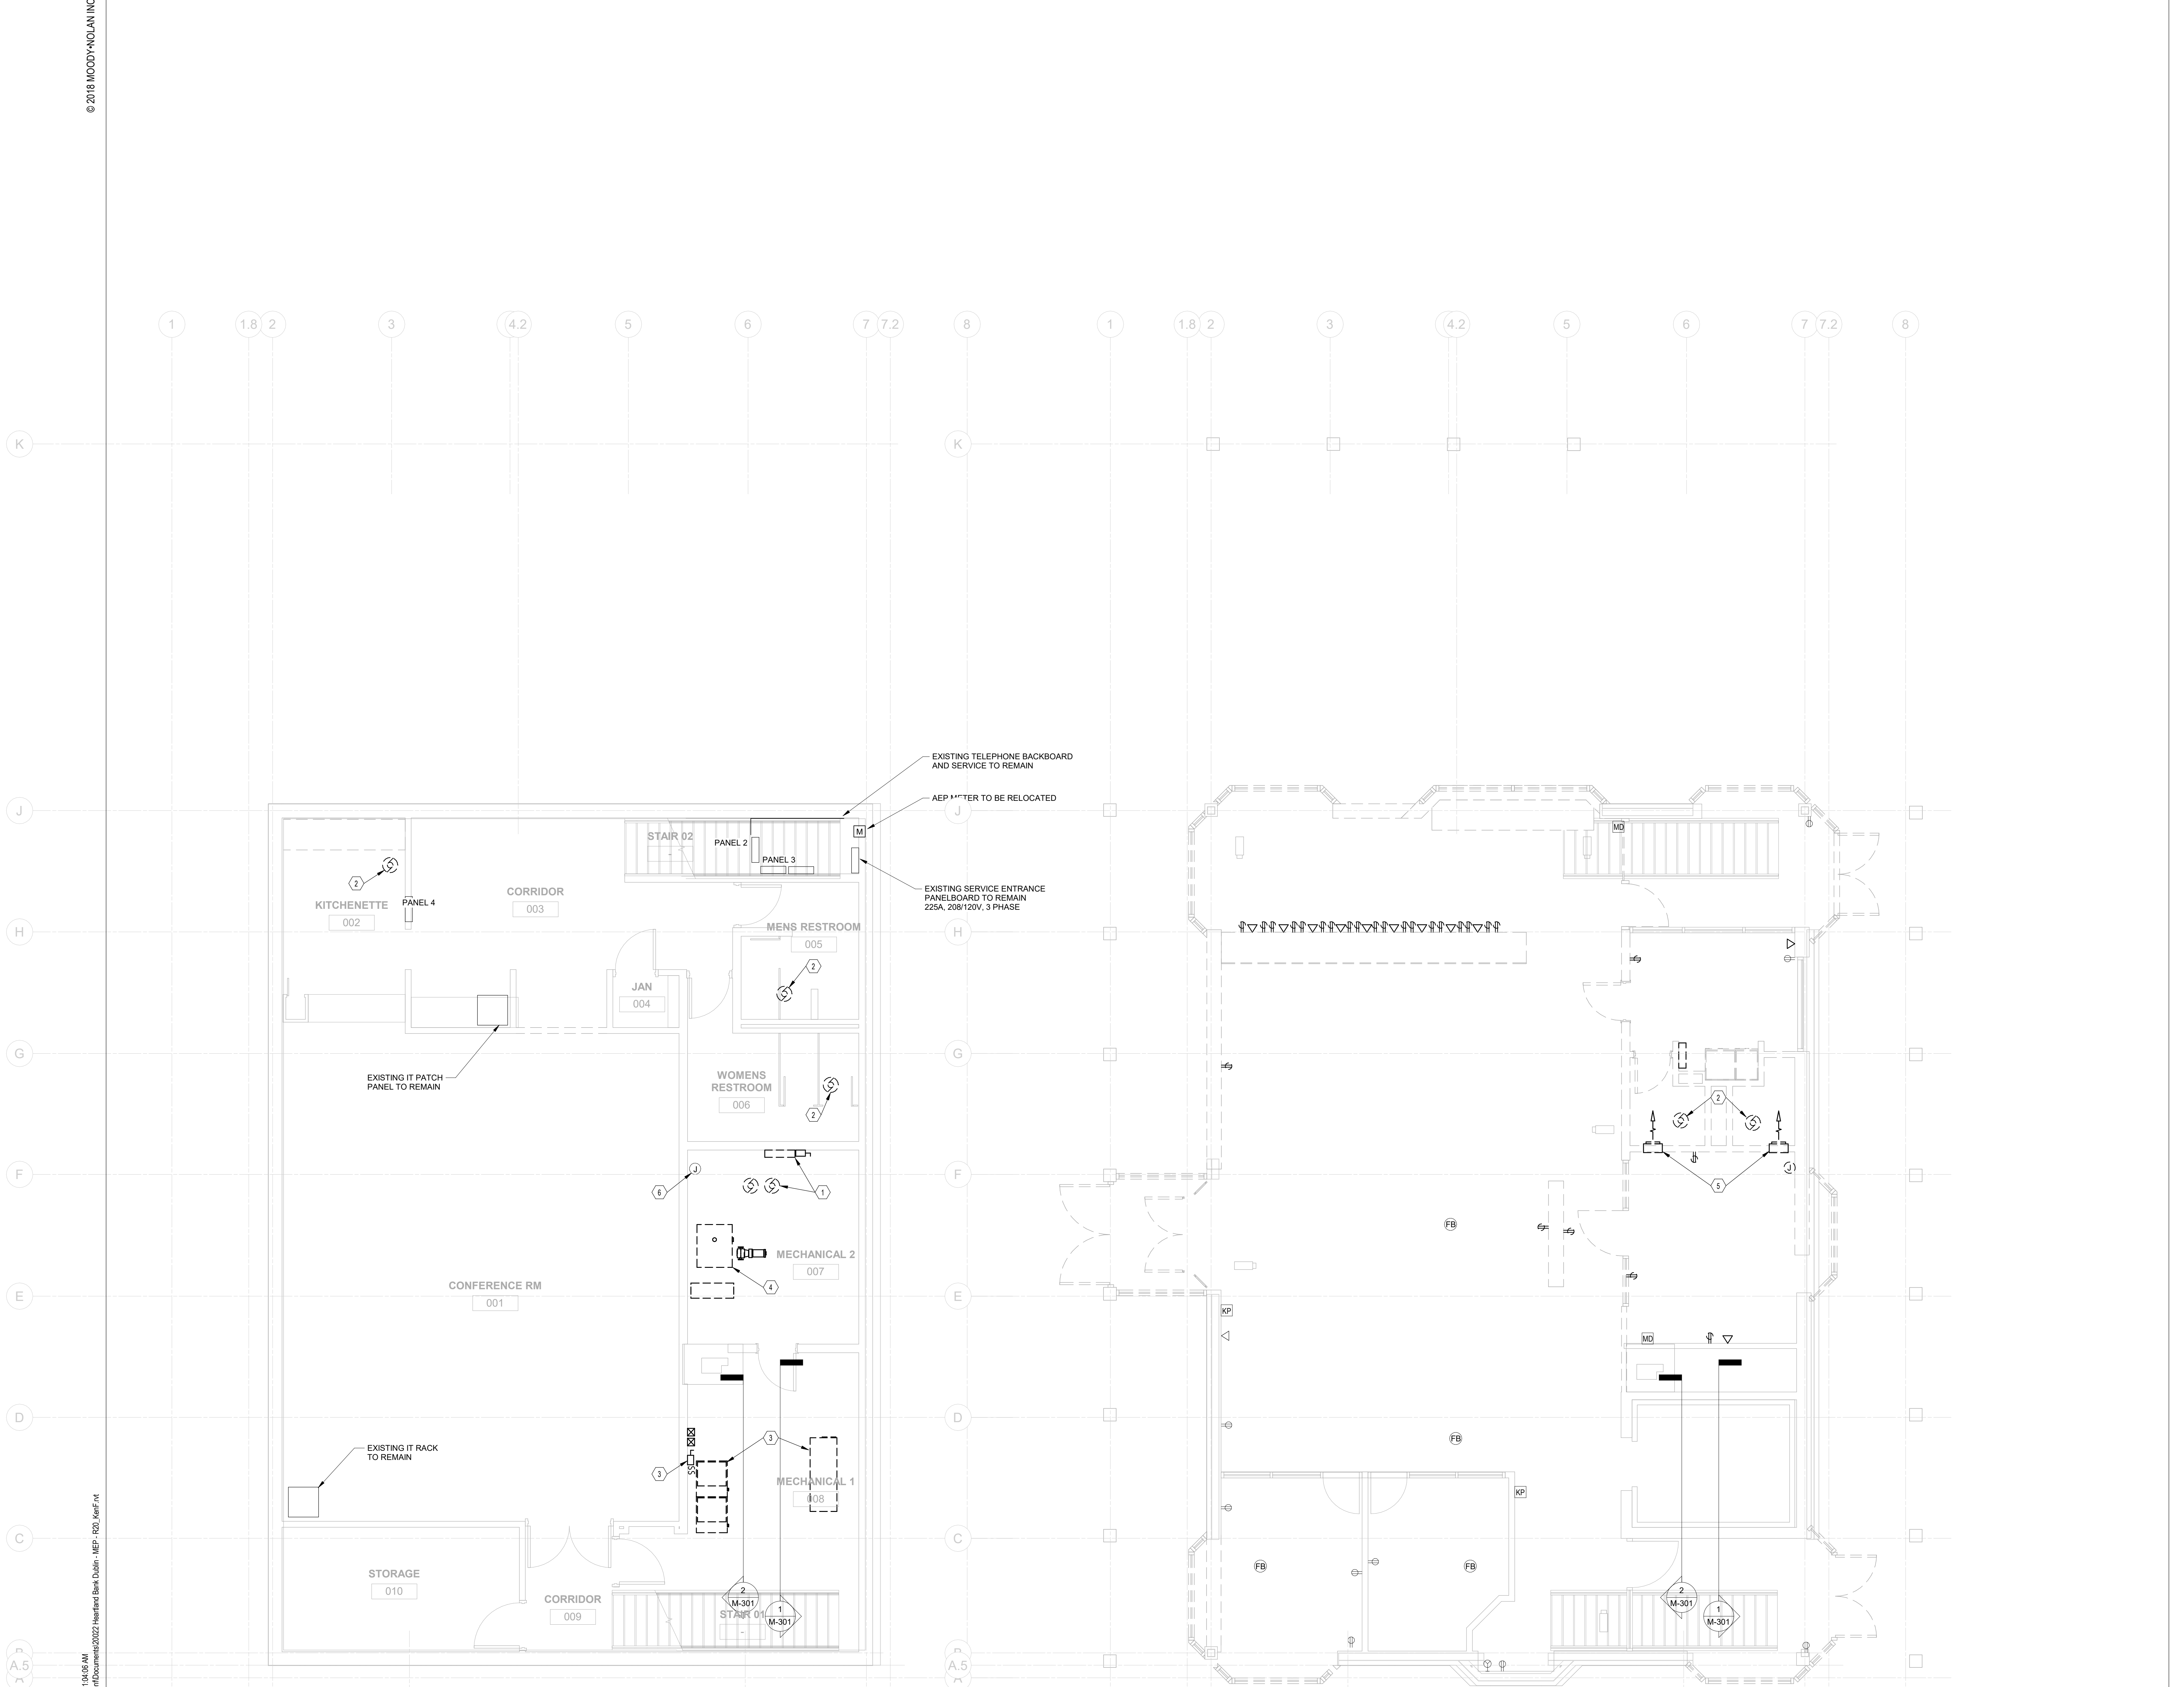

1 PLAN BASEMENT FLOOR PLAN - ELECTRICAL - DEMOLITION
1/4" = 1'-0"

2 PLAN FIRST FLOOR PLAN - ELECTRICAL - DEMOLITION
1/4" = 1'-0"

GENERAL NOTES:

- A. DRAWINGS ARE DIAGRAMMATIC IN NATURE AND REPRESENT AN APPROXIMATION OF INITIAL CONDITIONS. INFORMATION PROVIDED IS BASED ON THE BEST AVAILABLE DATA. ELECTRICAL CONTRACTOR SHALL FIELD VERIFY EXISTING CONDITIONS AND EXTENT OF THE NEW WORK PRIOR TO CONSTRUCTION.
- B. ENSURE THAT ALL WIRING DEVICES IN ADJACENT SPACES AND BASEMENT REMAIN OPERATIONAL DURING DEMOLITION AND AFTER RENOVATION IS COMPLETED. PROVIDE NEW BRANCH CIRCUITING AS REQUIRED TO MAINTAIN SERVICE.
- C. ALL EQUIPMENT TO BE REMOVED SHALL BE DISPOSED OF BY THE CONTRACTOR IN ACCORDANCE WITH STATE, LOCAL LAWS, ORDINANCES, RULES AND REGULATIONS.
- D. UNLESS NOTED OTHERWISE, ALL CONDUCTORS OF DEMOLISHED DEVICES AND EQUIPMENT THAT ARE NOT INDICATED FOR REUSE SHALL BE COMPLETELY REMOVED BACK TO SOURCE.

CODED NOTES:

- 1. POWER CONNECTION TO SEWAGE EJECTOR PUMP AND SUMP PUMP TO BE DEMOLISHED. DEMOLISH EXISTING CONTROL PANEL AND ASSOCIATED HARDWARE. MAINTAIN AND PROTECT EXISTING CIRCUITS FOR USE WITH NEW PUMPS.
- 2. POWER CONNECTION TO EXHAUST FAN TO BE DEMOLISHED.
- 3. POWER CONNECTION TO FURNACE AND ASSOCIATED HARDWARE TO BE DEMOLISHED.
- 4. POWER CONNECTION TO BOILER AND ASSOCIATED HARDWARE TO BE DEMOLISHED.
- 5. POWER CONNECTION TO UNIT HEATER TO BE DEMOLISHED.
- 6. WATER HEATER TO REMAIN.

#	DATE	CHANGE DESCRIPTION

RENOVATION OF HEARTLAND BANK DUBLIN
 6500 FRANTZ ROAD
 DUBLIN, OH 43017
 FOR
HEARTLAND BANK


MOODY-NOLAN
 300 SPRUCE STREET
 SUITE 300
 COLUMBUS, OHIO 43215
 PHONE: (614) 461-4664
 FAX: (614) 280-8881

FLOOR PLANS - POWER/SYSTEMS - DEMOLITION


09/10/2020
 DRAWN BY: Author CHECKED BY: Checker
 20022
ED-201
 PRELIMINARY DEVELOPMENT PLAN

K
J
H
G
F
E
D
C
A.5

1 1.8 2 3 4.2 5 6 7 7.2 8

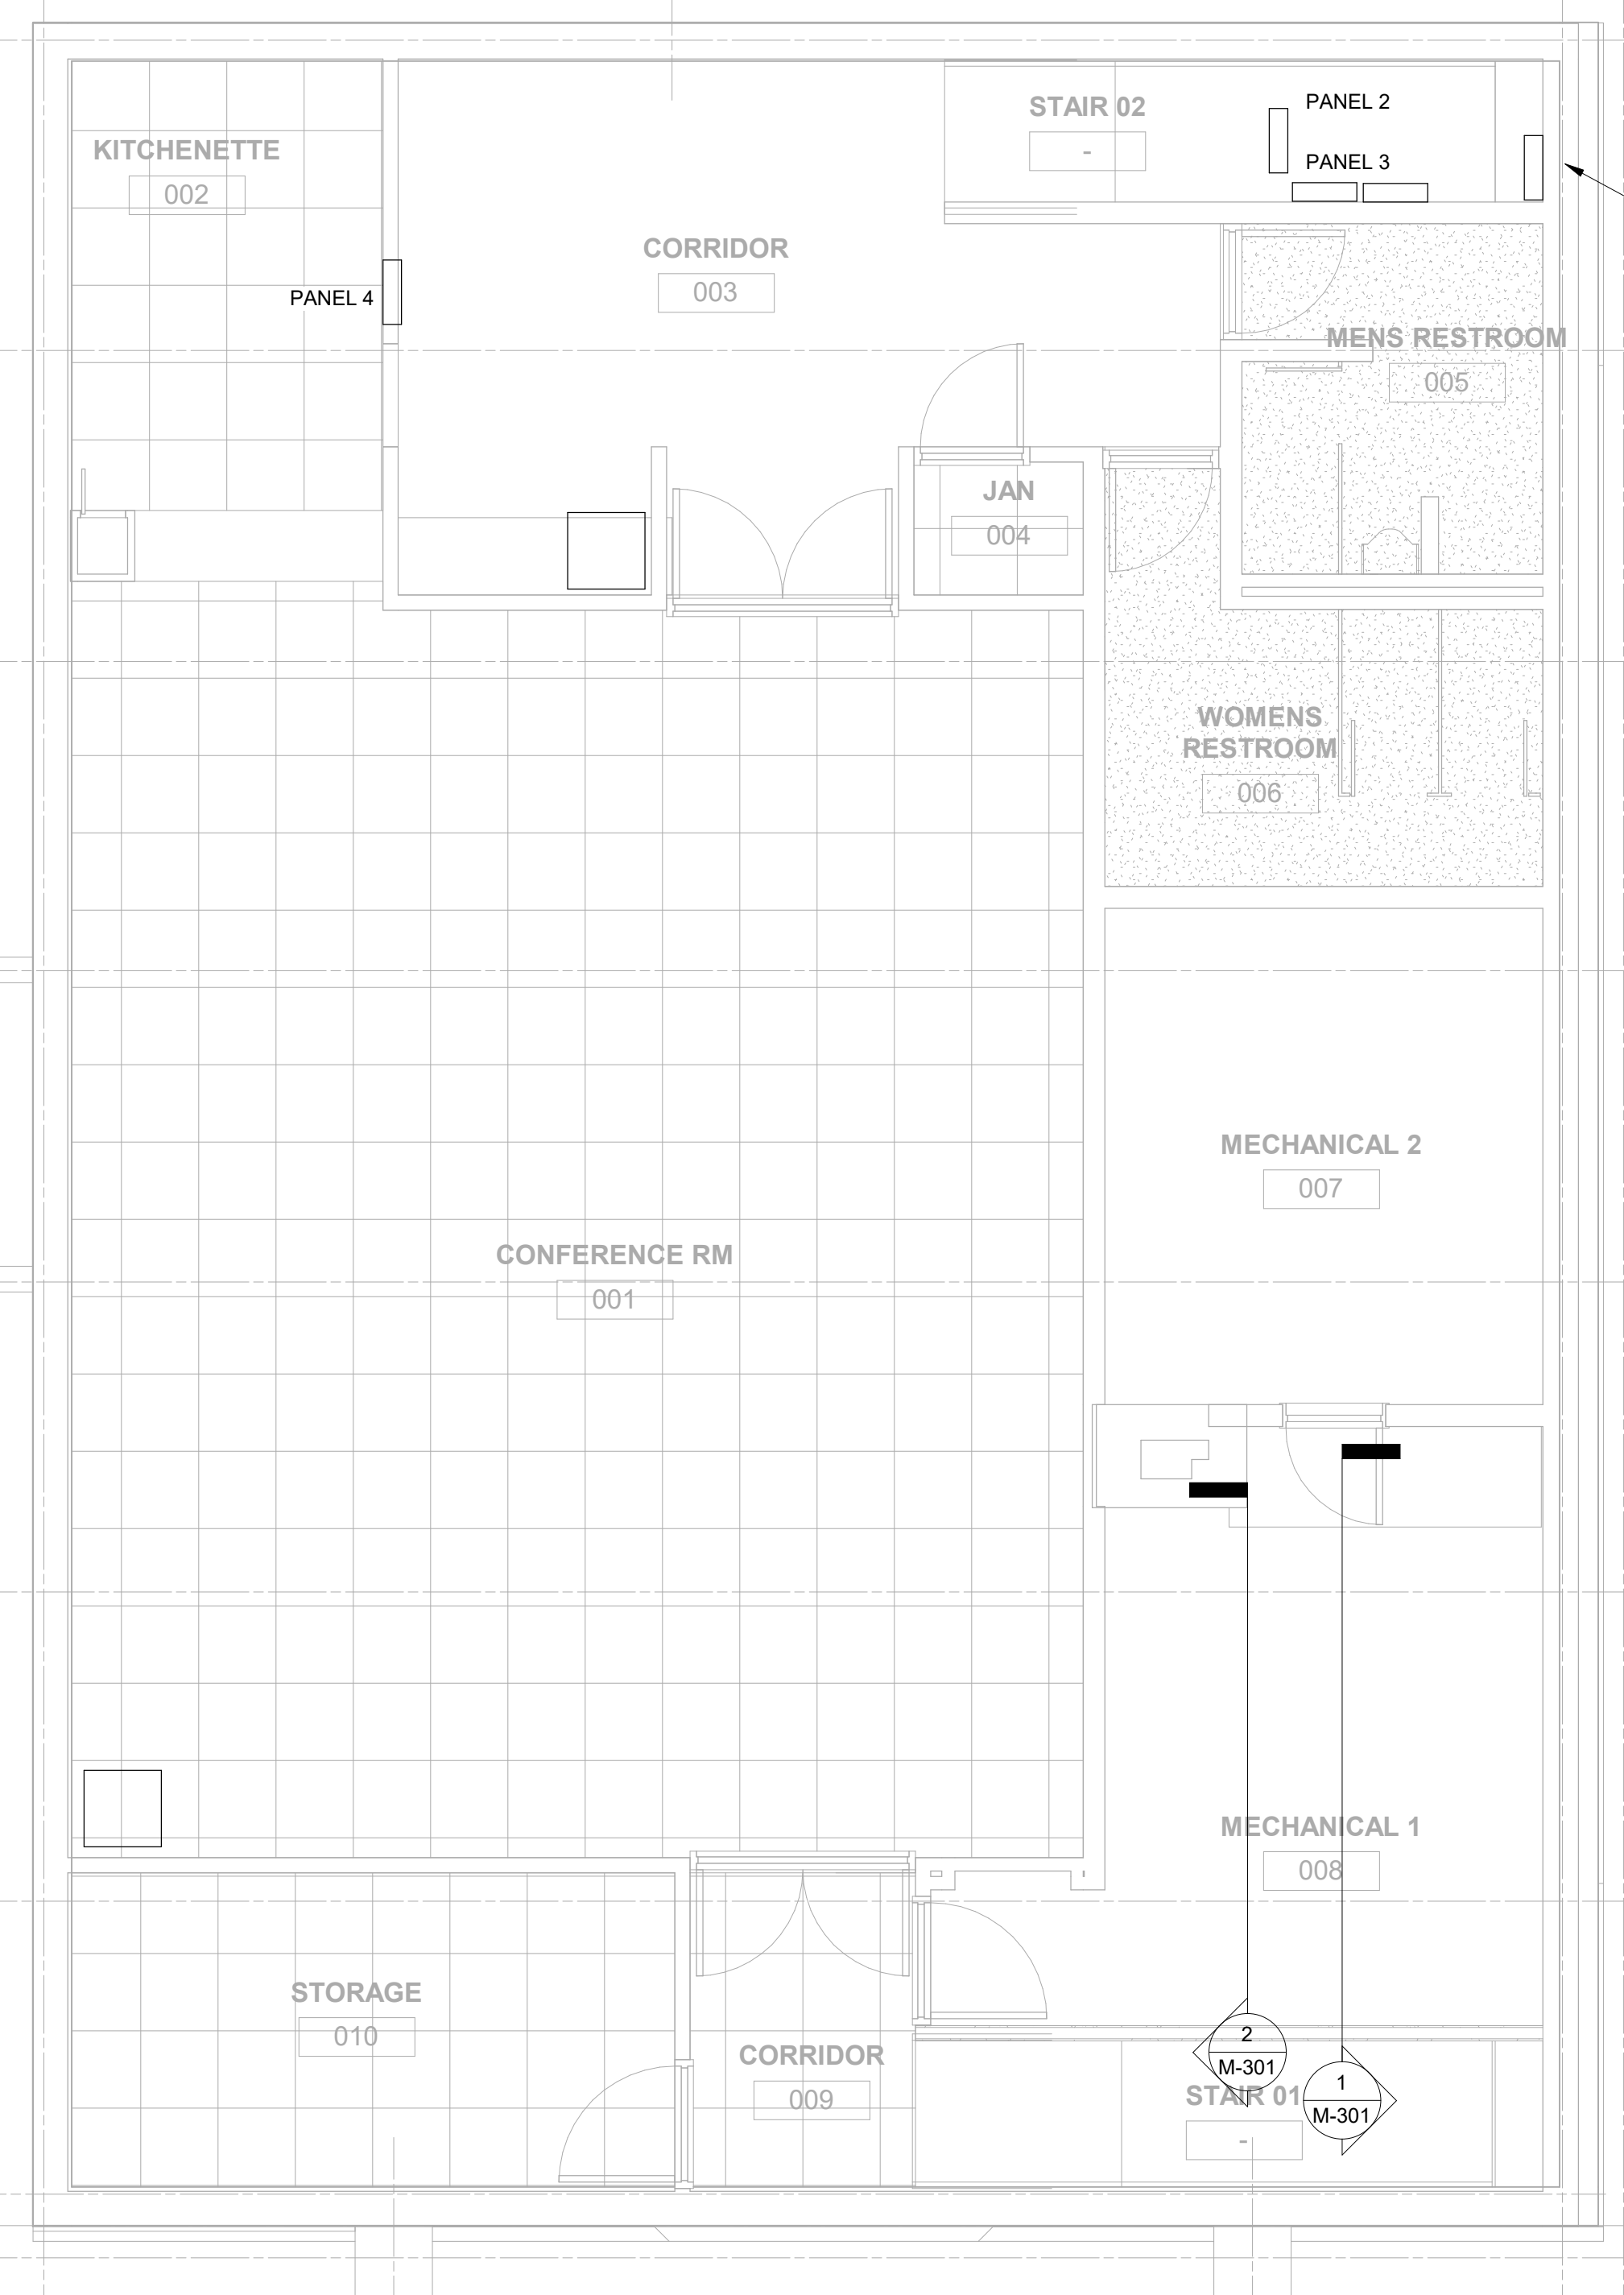

1 PLAN BASEMENT CEILING PLAN - LIGHTING
1/4" = 1'-0"

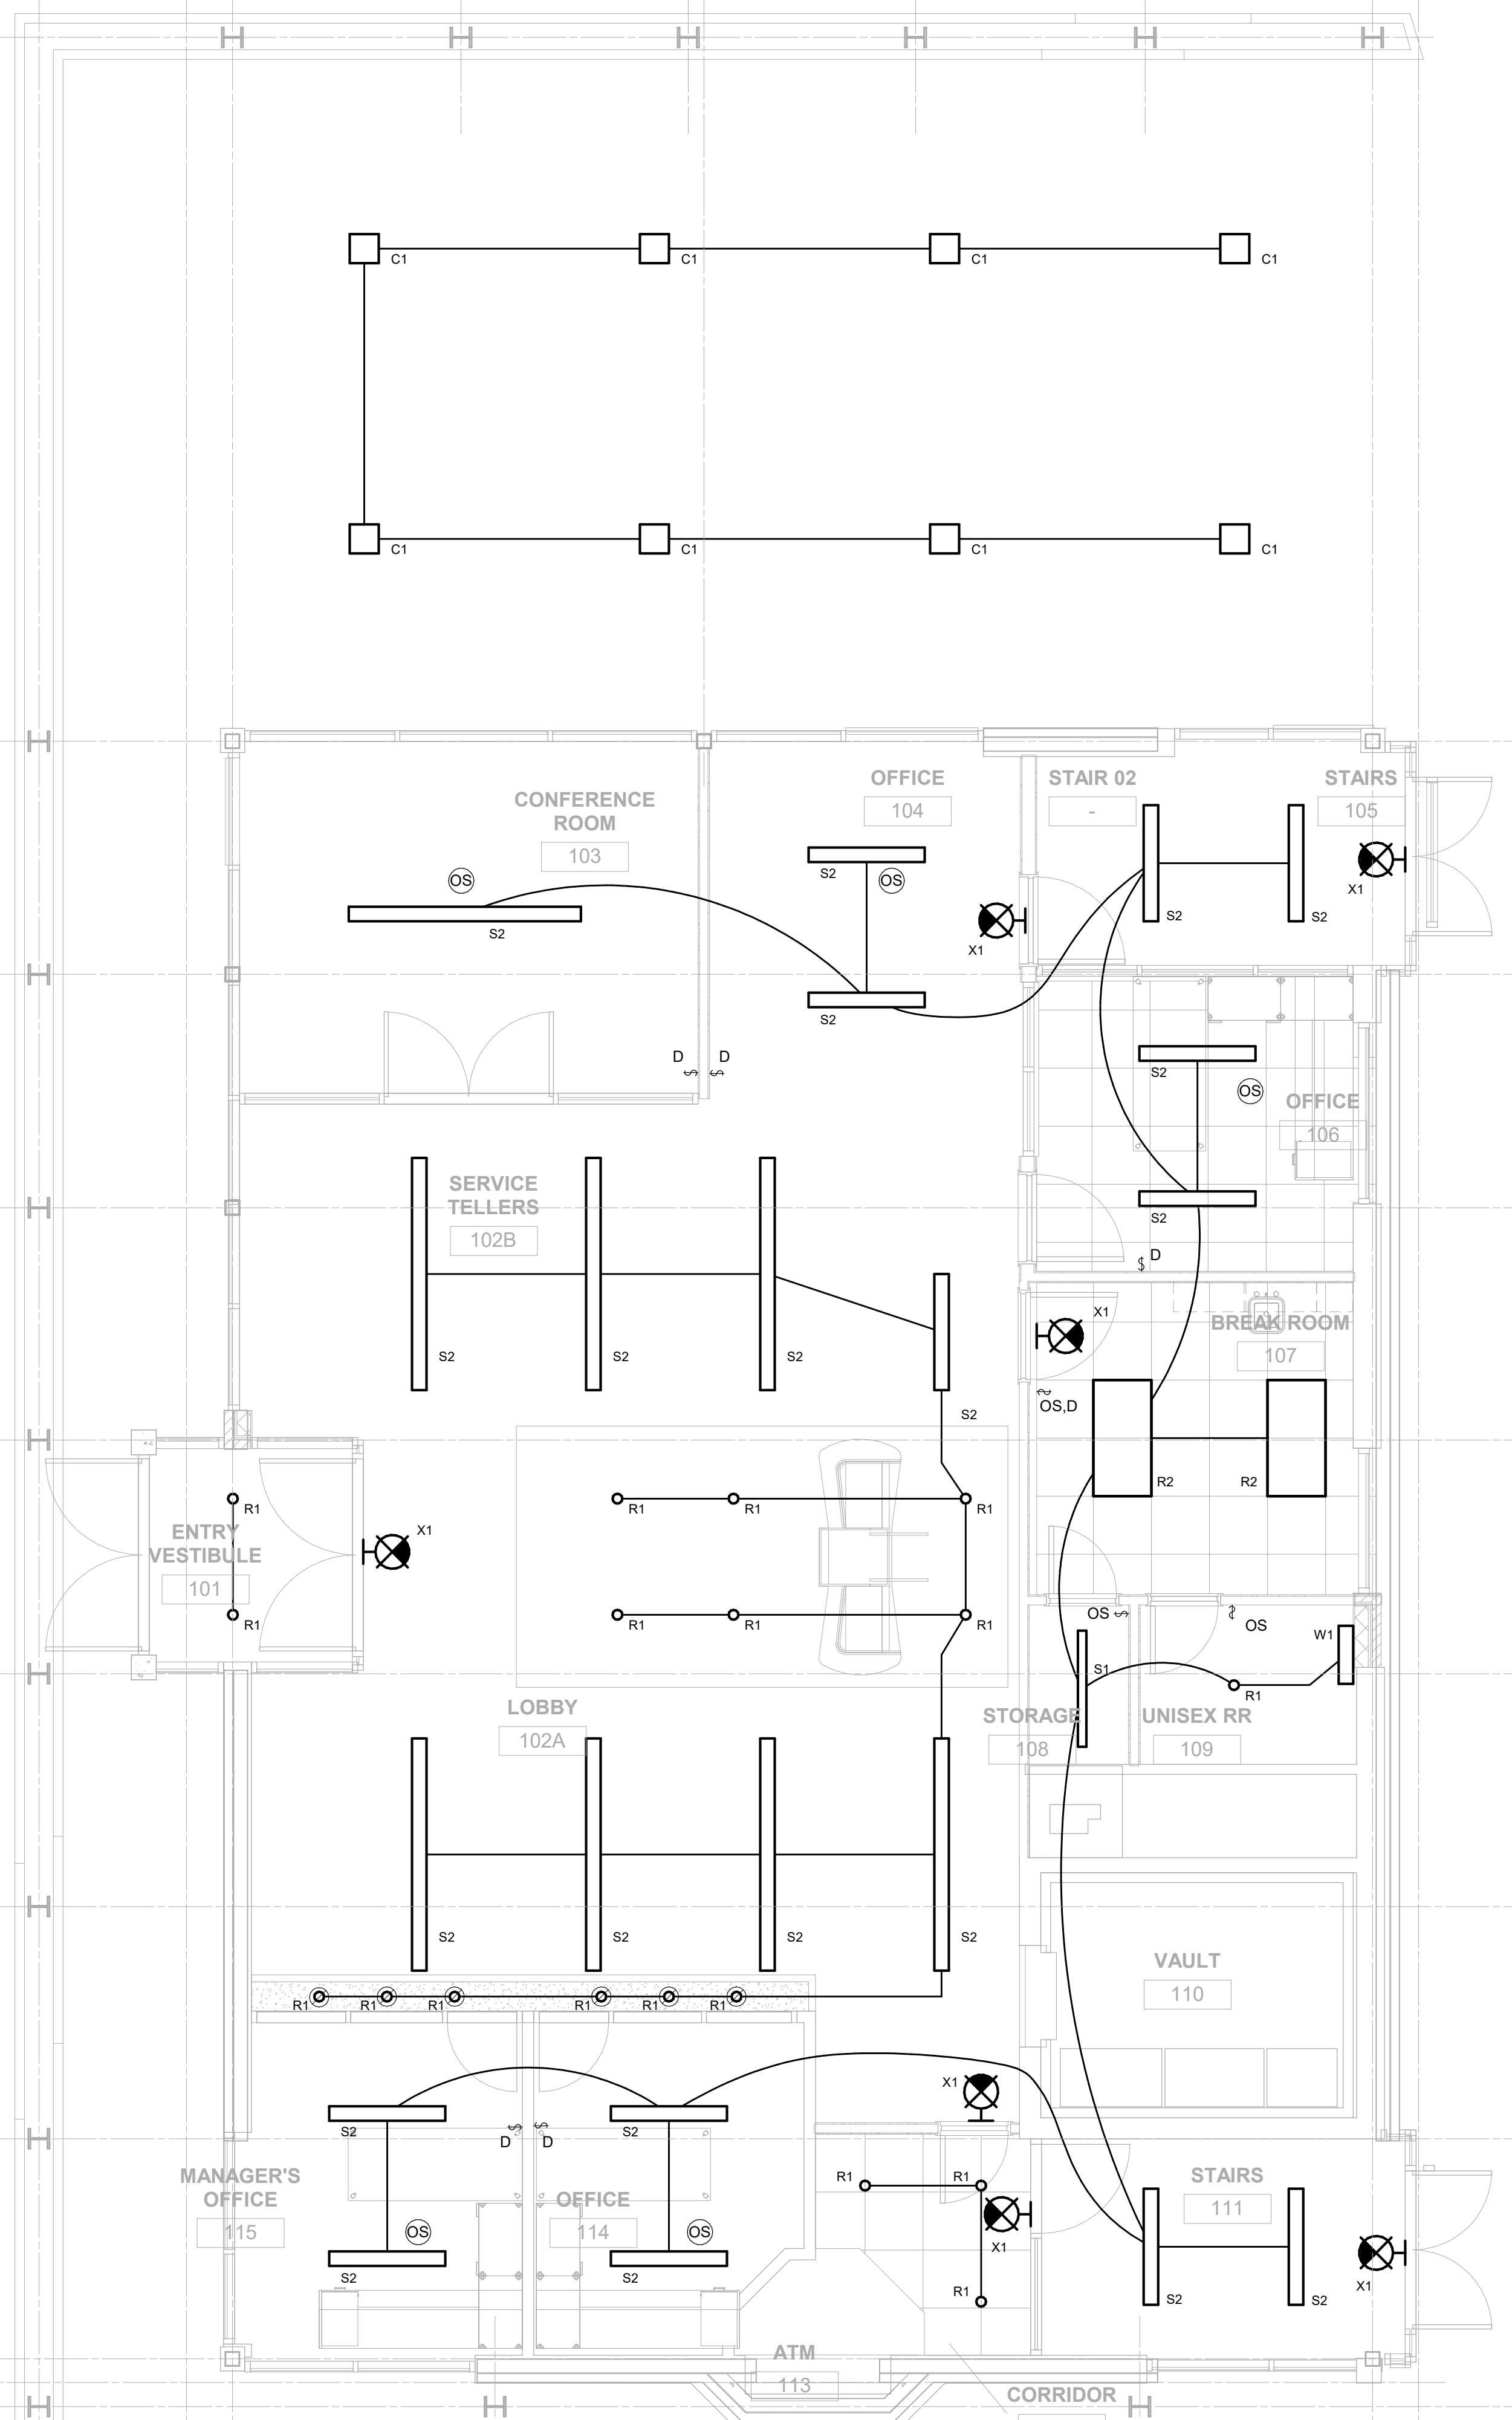

2 PLAN FIRST FLOOR CEILING PLAN - LIGHTING
1/4" = 1'-0"

- GENERAL NOTES:**
- A. COORDINATE EXACT LOCATION OF LUMINAIRES WITH ARCHITECTURAL REFLECTED CEILING PLAN AND HVAC PLANS PRIOR TO ROUGH-IN TO AVOID CONFLICTS.
 - B. CONTRACTOR SHALL FIELD VERIFY EXISTING PANEL CIRCUITING FOR CIRCUIT MODIFICATIONS SHOWN. MAINTAIN CIRCUITRY CONTINUITY FOR DOWNSTREAM DEVICES.
 - C. POWER PACKS AND SLAVE PACKS ARE NOT SHOWN FOR CLARITY. POWER PACKS AND SLAVE PACKS SHALL BE LOCATED WITHIN EACH ROOM ABOVE CEILING ADJACENT TO THE ENTRY DOOR.
 - D. NO SHARED NEUTRALS - EACH NEW CIRCUIT SHALL HAVE DEDICATED NEUTRAL CONDUCTOR.
 - E. PROVIDE ALL MOUNTING HARDWARE PER MANUFACTURER'S WRITTEN INSTRUCTIONS TO SUPPORT LUMINAIRES. CONTRACTOR TO VERIFY MOUNTING HEIGHTS WITH ARCHITECTURAL ELEVATIONS PRIOR TO ROUGH-IN. LUMINAIRES SHALL NOT BE SUPPORTED BY CEILINGS.
 - F. STRAIGHT LINES INDICATE LUMINAIRES CIRCUITED TO COMMON CONTROLS. ARCHED LINES INDICATE A COMMON BRANCH CIRCUIT BUT SEPARATE CONTROLS.
 - G. EMERGENCY EGRESS LIGHTING, EXIT SIGNS AND NIGHT LIGHTS SHALL BE CONNECTED TO LOCAL LIGHTING CIRCUIT AHEAD OF ANY SWITCHING OR CONTROLS WITH A MINIMUM OF #12 CONDUCTORS.

- CODED NOTES:**
- 1.

#	DATE	CHANGE DESCRIPTION

RENOVATION OF HEARTLAND BANK DUBLIN
 6500 FRANTZ ROAD
 DUBLIN, OH 43017
 FOR
HEARTLAND BANK

MOODY-NOLAN
 300 SPRUCE STREET
 SUITE 300
 COLUMBUS, OHIO 43215
 PHONE: (614) 461-4664
 FAX: (614) 280-8881

DRAWING TITLE:
FLOOR PLANS - LIGHTING


DATE: 09/10/2020
 DRAWN BY: Author
 CHECKED BY: Checker

PROGRESS DRAWING NOT FOR CONSTRUCTION

20022

E-101

PRELIMINARY DEVELOPMENT PLAN

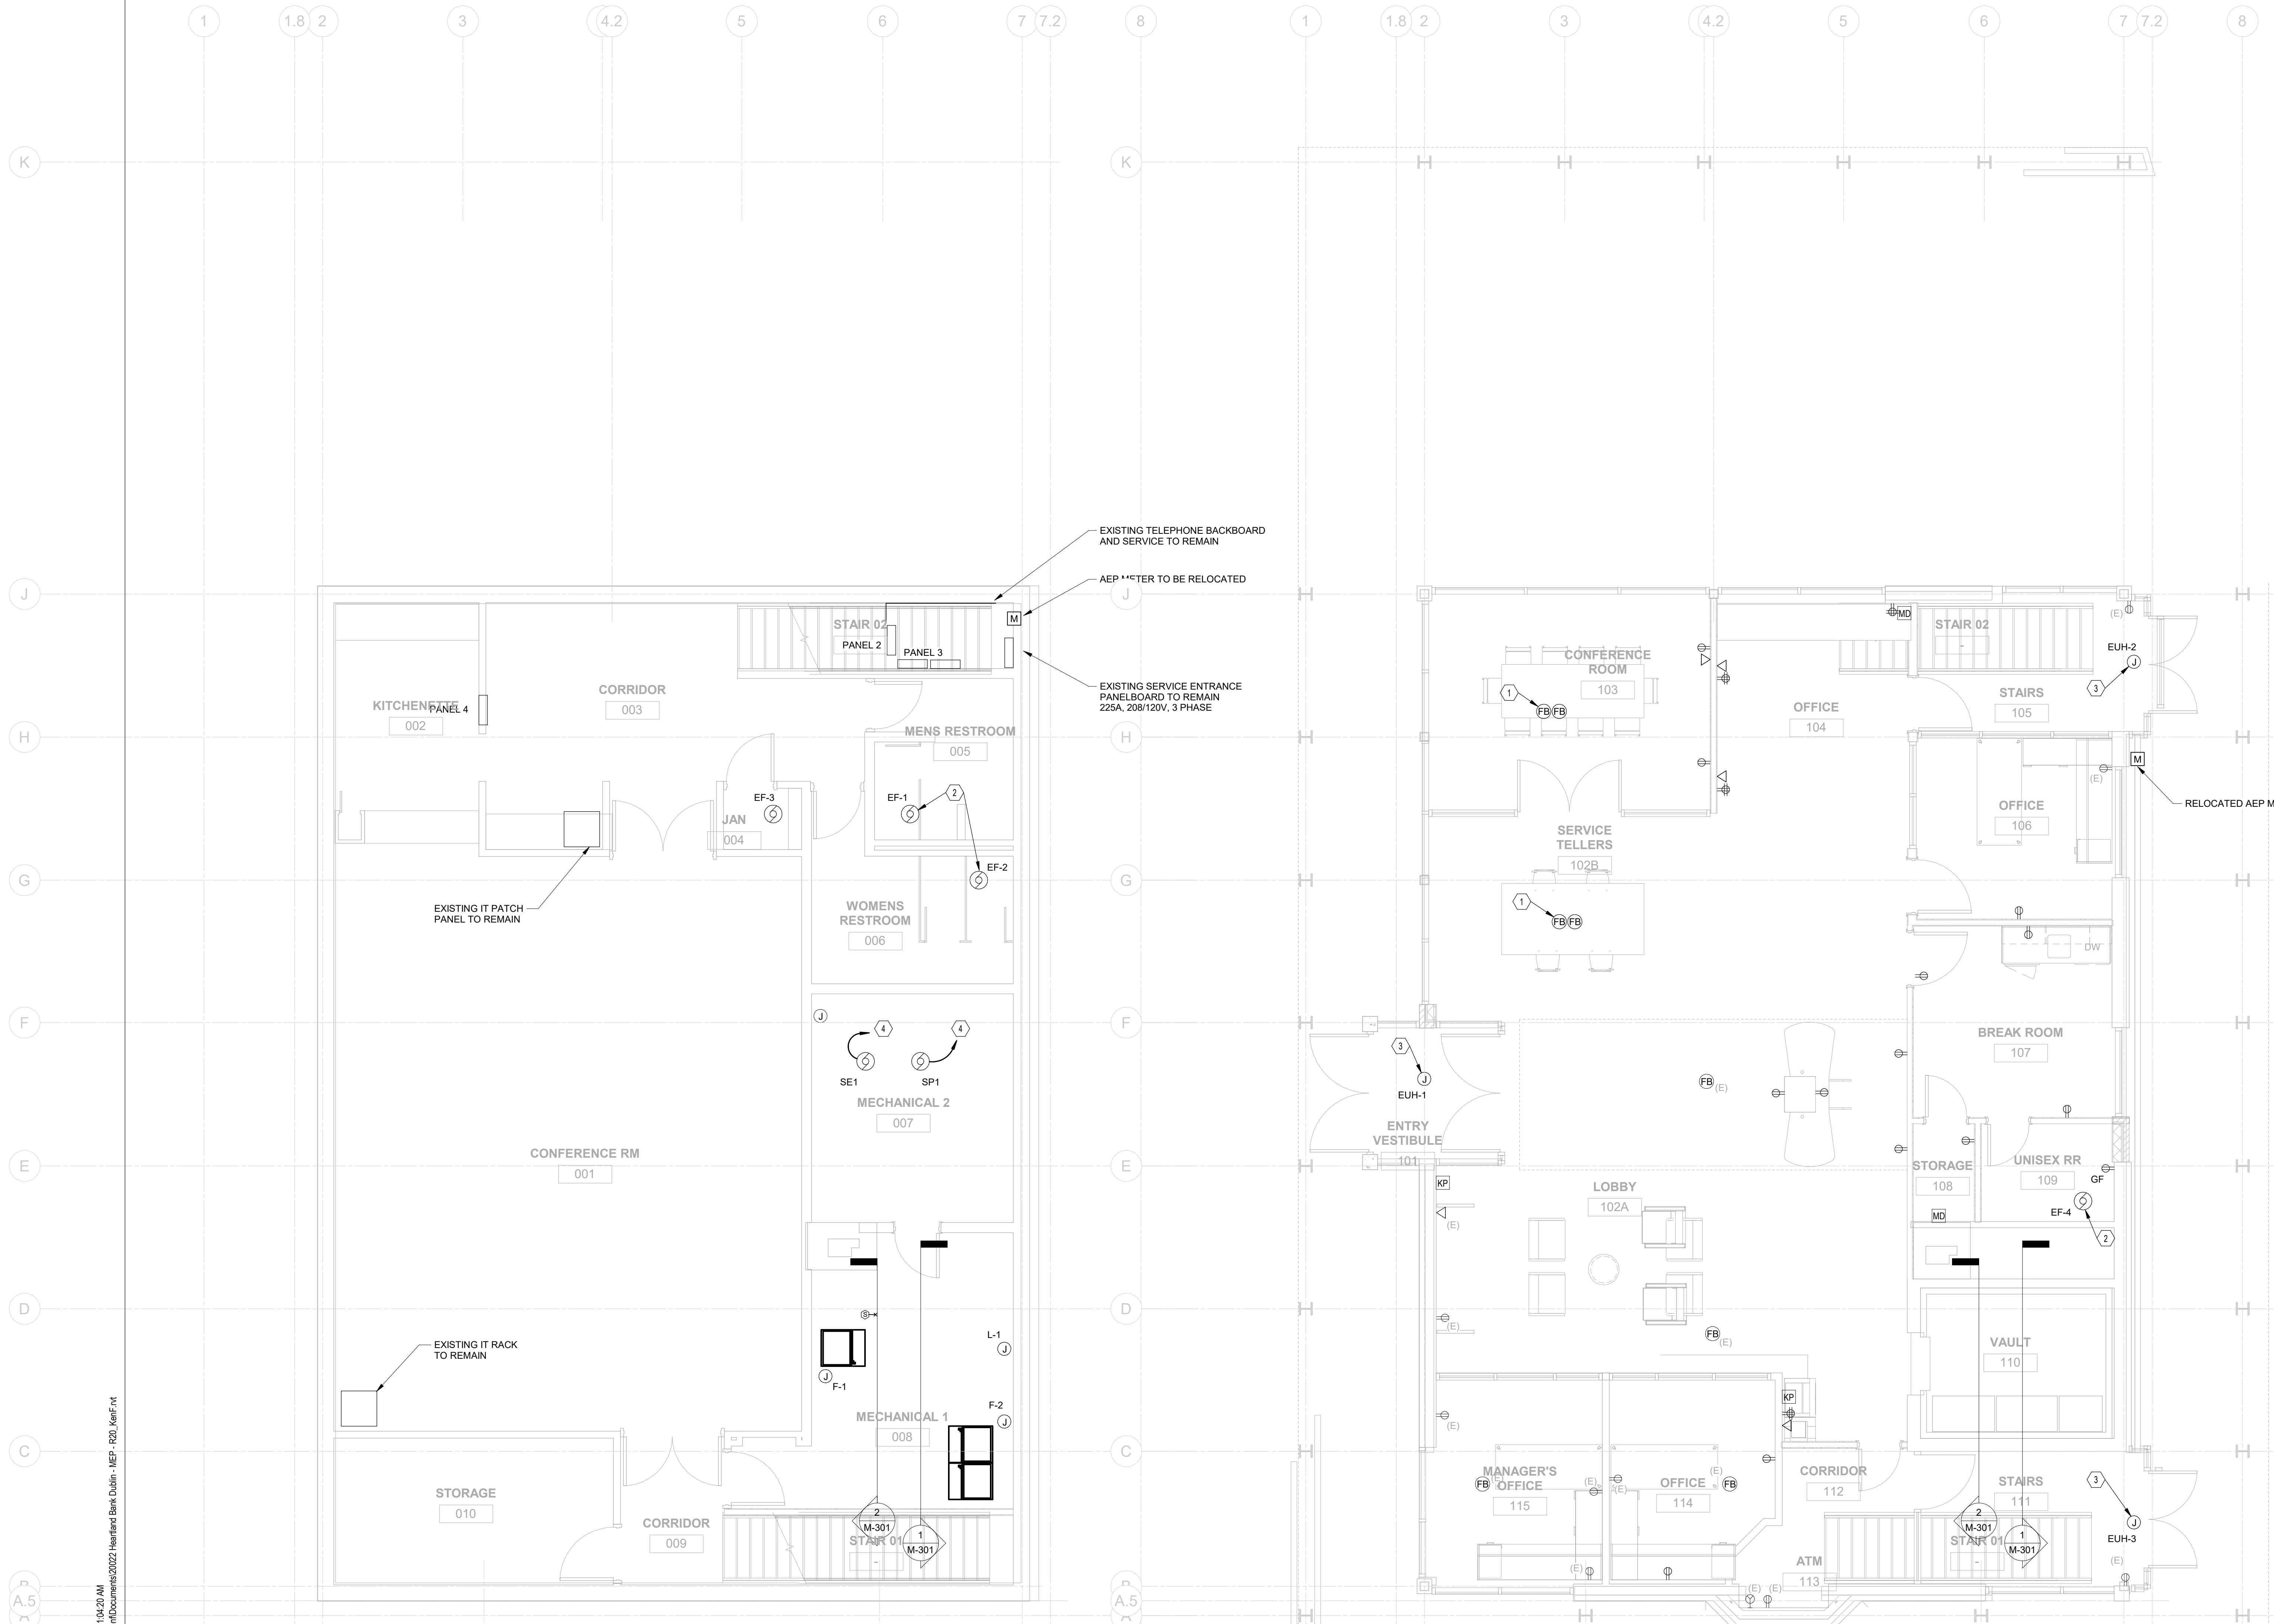

1 PLAN BASEMENT FLOOR PLAN - ELECTRICAL
1/4" = 1'-0"

2 PLAN FIRST FLOOR PLAN - ELECTRICAL
1/4" = 1'-0"

- GENERAL NOTES:**
- A. UNLESS NOTED OTHERWISE NO ELECTRICAL WORK ANTICIPATED IN BASEMENT.
- CODED NOTES:**
1. PROVIDE POKE THRU RECEPTACLE AND DATA OUTLET.
 2. EXHAUST FAN 120V FRACTIONAL HP WITH INTEGRAL DISCONNECT. FAN SHALL BE CONTROLLED WITH LIGHTS.
 3. ELECTRIC UNIT HEATER, 208V SINGLE PHASE WITH INTEGRAL DISCONNECT.
 4. UTILIZE EXISTING CIRCUIT RETAINED FROM DEMOLITION PHASE TO SERVE NEW EQUIPMENT. INTERCEPT CIRCUIT, MATCH WIRE SIZE, MAKE JUNCTIONS AND EXTEND TO NEW EQUIPMENT AS NECESSARY.

#	DATE	CHANGE DESCRIPTION

RENOVATION OF HEARTLAND BANK DUBLIN
 6500 FRANTZ ROAD
 DUBLIN, OH 43017
 FOR
HEARTLAND BANK

MOODY-NOLAN
 300 SPRUCE STREET
 SUITE 300
 COLUMBUS, OHIO 43215
 PHONE: (614) 461-4664
 FAX: (614) 280-8881

DRAWING TITLE:
FLOOR PLANS - POWER/SYSTEMS

PROGRESS DRAWING NOT FOR CONSTRUCTION	09/10/2020
	DRAWN BY: Author CHECKED BY: Checker
	20022
E-201	
PRELIMINARY DEVELOPMENT PLAN	

Panel:

Location: STAIR 02 -
 Supply From: STAIR 02 -
 Mounting: Recessed
 Enclosure: Type 1

Volts: 120/208 Wye
 Phases: 3
 Wires: 4

A.I.C. Rating:
 Mains Type:
 Mains Rating: 100 A
 MCB Rating: 225 A

CK T	Circuit Description	Trip	Pole s	A	B	C	Pole s	Trip	Circuit Description	CK T
1	(E) UPS	30 A	1	0.0	0.0		1	20 A	(E) EXISTING LOAD	2
3	(E) WEST WALL #1	20 A	1		0.0	0.0		3	30 A (E) SORTER	4
5	(E) SOUTH WALL #2	20 A	1			0.0	0.0			6
7	(E) WEST WALL #2	20 A	1	0.0	0.0			1	20 A (E) EAST WALL #2	8
9	SPARE	20 A	1		0.0	0.0		1	20 A (E) EAST WALL #3	10
11	(E) IRRIGATION TIMER	20 A	1			0.0	0.0	1	20 A (E) EAST WALL #1	12
13	(E) SOUTH WALL #1	20 A	1	0.0	0.0			1	20 A SPARE	14
15	SPARE	20 A	1		0.0	0.0		1	20 A SPARE	16
17	SPACE	--	--			0.0	0.0	--	--	18
19	SPACE	--	--	0.0	0.0			--	--	20
21	SPACE	--	--		0.0	0.0		--	--	22
23	SPACE	--	--			0.0	0.0	--	--	24
Total Load:				0.0 kVA	0.0 kVA	0.0 kVA				
Total...				0 A	0 A	0 A				
Conn. Load:										
Demand Load:										
Demand...										

Panel: PANEL 2

Location: STAIR 02 -
 Supply From: STAIR 02 -
 Mounting: Recessed
 Enclosure: Type 1

Volts: 120/208 Wye
 Phases: 3
 Wires: 4

A.I.C. Rating:
 Mains Type:
 Mains Rating: 100 A
 MCB Rating: 225 A

CK T	Circuit Description	Trip	Pole s	A	B	C	Pole s	Trip	Circuit Description	CK T
1	(E) UPS	30 A	1	0.0	0.0		1	20 A	(E) EXISTING LOAD	2
3	(E) WEST WALL #1	20 A	1		0.0	0.0		3	30 A (E) SORTER	4
5	(E) SOUTH WALL #2	20 A	1			0.0	0.0			6
7	(E) WEST WALL #2	20 A	1	0.0	0.0			1	20 A (E) EAST WALL #2	8
9	SPARE	20 A	1		0.0	0.0		1	20 A (E) EAST WALL #3	10
11	(E) IRRIGATION TIMER	20 A	1			0.0	0.0	1	20 A (E) EAST WALL #1	12
13	(E) SOUTH WALL #1	20 A	1	0.0	0.0			1	20 A SPARE	14
15	SPARE	20 A	1		0.0	0.0		1	20 A SPARE	16
17	SPACE	--	--			0.0	0.0	--	--	18
19	SPACE	--	--	0.0	0.0			--	--	20
21	SPACE	--	--		0.0	0.0		--	--	22
23	SPACE	--	--			0.0	0.0	--	--	24
Total Load:				0.0 kVA	0.0 kVA	0.0 kVA				
Total...				0 A	0 A	0 A				
Conn. Load:										
Demand Load:										
Demand...										

Panel: PANEL 3

Location: STAIR 02 -
 Supply From: STAIR 02 -
 Mounting: Recessed
 Enclosure: Type 1

Volts: 120/208 Wye
 Phases: 3
 Wires: 4

A.I.C. Rating:
 Mains Type:
 Mains Rating: 100 A
 MCB Rating: 225 A

CK T	Circuit Description	Trip	Pole s	A	B	C	Pole s	Trip	Circuit Description	CK T
1	(E) MAIN UPS	20 A	2	0.0	0.0		1	20 A	(E) GEN	2
3	SPACE	--	--		0.0	0.0		1	20 A (E) SUMP PUMP	4
5	SPACE	--	--			0.0	0.0	--	--	6
7	SPACE	--	--	0.0				--	--	8
Total Load:				0.0 kVA	0.0 kVA	0.0 kVA				
Total...				0 A	0 A	0 A				
Conn. Load:										
Demand Load:										
Demand...										

Panel: PANEL 4

Location: KITCHENETTE 002
 Supply From: KITCHENETTE 002
 Mounting: Recessed
 Enclosure: Type 1

Volts: 120/208 Wye
 Phases: 3
 Wires: 4

A.I.C. Rating:
 Mains Type:
 Mains Rating: 100 A
 MCB Rating: 100 A

CK T	Circuit Description	Trip	Pole s	A	B	C	Pole s	Trip	Circuit Description	CK T
1	(E) LTG DRIVE THRU	20 A	1	0.0	0.0		1	20 A	(E) RECPT TELLER	2
3	SPARE	20 A	1		0.0	0.0		1	20 A (E) LTS MEETING RM	4
5	(E) RECPT DRIVE THRU	20 A	1			0.0	0.0	1	20 A (E) RECPT FRONT	6
7	(E) LTG CANOPY	20 A	1	0.0	0.0			1	20 A (E) RECPT DRIVE THRU	8
9	(E) LANE RTS (TWIN)	20 A	1		0.0	0.0		1	20 A (E) RECPT FLOOR	10
11	(E) LANE RTS	20 A	1			0.0	0.0	1	20 A (E) LTS ENTRANCE	12
13	(E) LANE RTS	30 A	1	0.0	0.0			1	20 A (E) RECPT/DYE	14
15	(E) LTG EXTERIOR	20 A	1		0.0	0.0		--	--	16
17	(E) LTG EXTERIOR	20 A	1			0.0	0.0	1	20 A (E) RECPT TELLER	18
19	(E) LTG SIGN	20 A	1	0.0	0.0			1	20 A (E) RECPT DRIVE THRU	20
Total Load:				0.0 kVA	0.0 kVA	0.0 kVA				
Total...				0 A	0 A	0 A				
Conn. Load:										
Demand Load:										
Demand...										

LUMINAIRE SCHEDULE

TYPE	DIMENSIONS	MOUNTING	CONSTRUCTION AND FINISH	DESCRIPTION AND OPTIONS	LAMPS	BALLAST(S)	VOLTAGE/OAD	APPROVED MANUFACTURER(S)
C1		SURFACE		SURFACE CANOPY LIGHT	INTEGRAL 4000K XX LUMENS	ELECTRONIC 0-10v DRIVER		
P1			20" SQUARE STEEL POLE (BRONZE)	AREA LIGHT TYPE 3 DISTRIBUTION	4000K	ELECTRONIC 0-10V DRIVER	120/277V 52W	LITHONIA RSX1
P2			20" SQUARE STEEL POLE (BRONZE)	AREA LIGHT TYPE 4 DISTRIBUTION	4000K	ELECTRONIC 0-10V DRIVER	120/277V 52W	LITHONIA RSX1
R1	4" DIA x 6" DEEP	RECESSED GRID OR DRYWALL	HEAVY GAUGE STEEL WITH CAST ALUMINUM HEATSINK	LED DOWNLIGHT CLEAR SPECULAR REFLECTOR	4000K	ELECTRONIC 0-10V DRIVER		GOTHAM EVO4
R2	2"x4" MAX 5.25" DEEP	RECESSED CEILING GRID	STEEL FORMED STEEL, ACRYLIC DIFFUSER	RECESSED INDIRECT LED ACRYLIC LENS, MATTE WHITE FINISH	4000K 4300 LUMENS	1 ELECTRONIC DRIVER		LITHONIA EPANL
S1	3" X 48" 6" DEEP	SURFACE MOUNT	COLD ROLLED FORMED STEEL, FLAT ACRYLIC LENS	LINEAR INDUSTRIAL	4000K, 4000 LUMENS	ELECTRONIC 0-10V DRIVER		LITHONIA CLX
S2	LENGTH AS SHOWN ON DRAWINGS	SUSPENDED	EXTRUDED ALUMINUM BODY WITH MICROPRISMATIC ACRYLIC LENS	LINEAR SUSPENDED DIRECT/INDIRECT		ELECTRONIC 0-10V DRIVER		MARK S1LD
W1		SURFACE/WALL	STEEL FORMED STEEL ACRYLIC DIFFUSER	VANITY LIGHT	3000K	ELECTRONIC 0-10v DRIVER		ACCESS 62518
X1	10.75" X 13" 4" DEEP	UNIVERSAL SURFACE CEILING/WALL	THERMOPLASTIC	UNIVERSAL MOUNT EDGE LIT EXIT NICAD BATTERY, SINGLE OR DOUBLE GAGE AS SHOWN, MIRROR BACK AS REQUIRED	LED	N/A		LITHONIA ECBR

#	DATE	CHANGE DESCRIPTION

RENOVATION OF HEARTLAND BANK DUBLIN
 6500 FRANTZ ROAD
 DUBLIN, OH 43017
 FOR
HEARTLAND BANK

MOODY-NOLAN
 300 SPRUCE STREET
 SUITE 300
 COLUMBUS, OHIO 43215
 PHONE: (614) 461-4664
 FAX: (614) 280-8881

DRAWING TITLE:
SCHEDULES - ELECTRICAL

09/10/2020
 DRAWN BY: Author CHECKED BY: Checker
 20022

E-601

PRELIMINARY DEVELOPMENT PLAN