


RENOVATION OF HEARTLAND BANK DUBLIN

6500 FRANTZ ROAD
DUBLIN, OH 43017

PREPARED FOR:

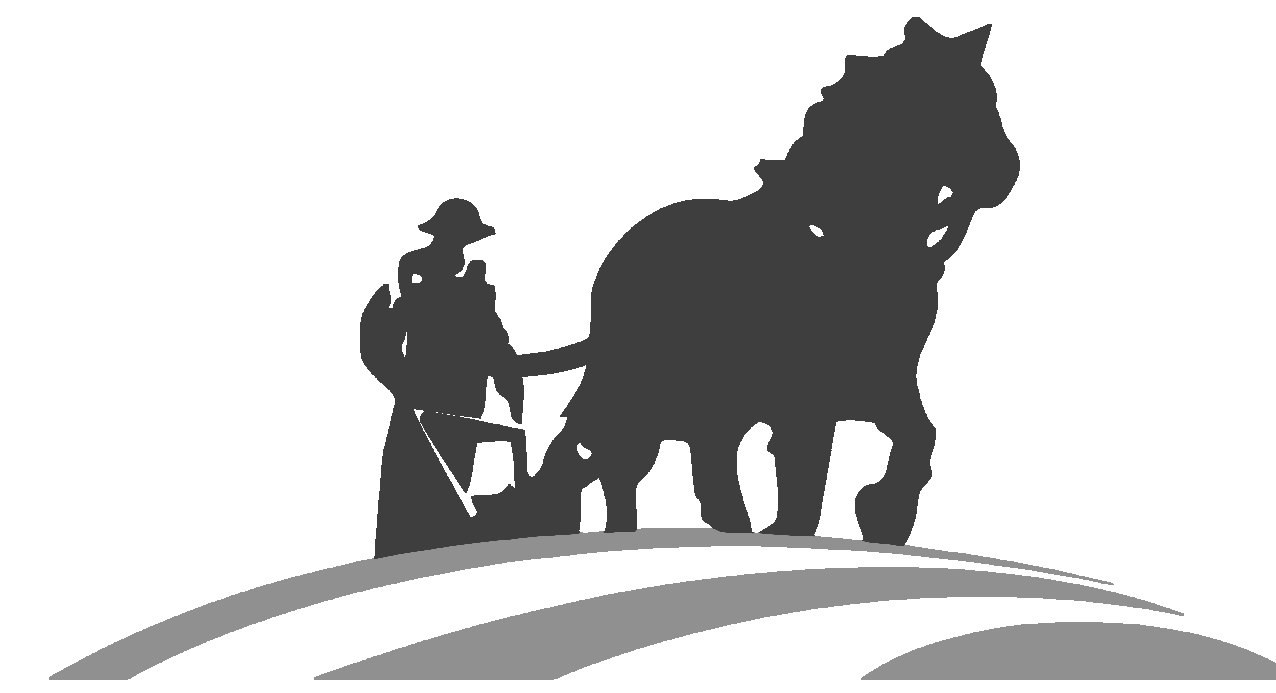

HEARTLAND BANK

430 N. HAMILTON ROAD
WHITEHALL, OH 43213

PREPARED BY:

CIVIL ENGINEER



300 SPRUCE STREET
SUITE 200
COLUMBUS, OH 43215

PHONE: (614) 280-8999

ARCHITECT



300 SPRUCE STREET
SUITE 300
COLUMBUS, OH 43215

PHONE: (614) 461-4664 FAX: (614) 280-8881

STRUCTURAL ENGINEER



5640 FRANTZ ROAD
DUBLIN, OH 43017

PHONE: (614) 766-0066

PLUMBING, MECHANICAL &
ELECTRICAL ENGINEER



1405 DUBLIN ROAD
COLUMBUS, OH 43215

PHONE: (614) 486-4778


FINAL DEVELOPMENT PLAN 11/30/2020

ABBREVIATIONS

SYMBOLS table with columns for symbols and their corresponding descriptions (e.g., AND, ANGLE, AT, NUMBER / POUND).

G, H, I, J, K, L, M, N, O, P, Q, R, S, T, U, V, W, X, Y, Z tables listing abbreviations and their meanings (e.g., GAGE / GAUGE, HEIGHT / HIGH, JANITOR, SOUTH).

SYMBOLS LEGEND

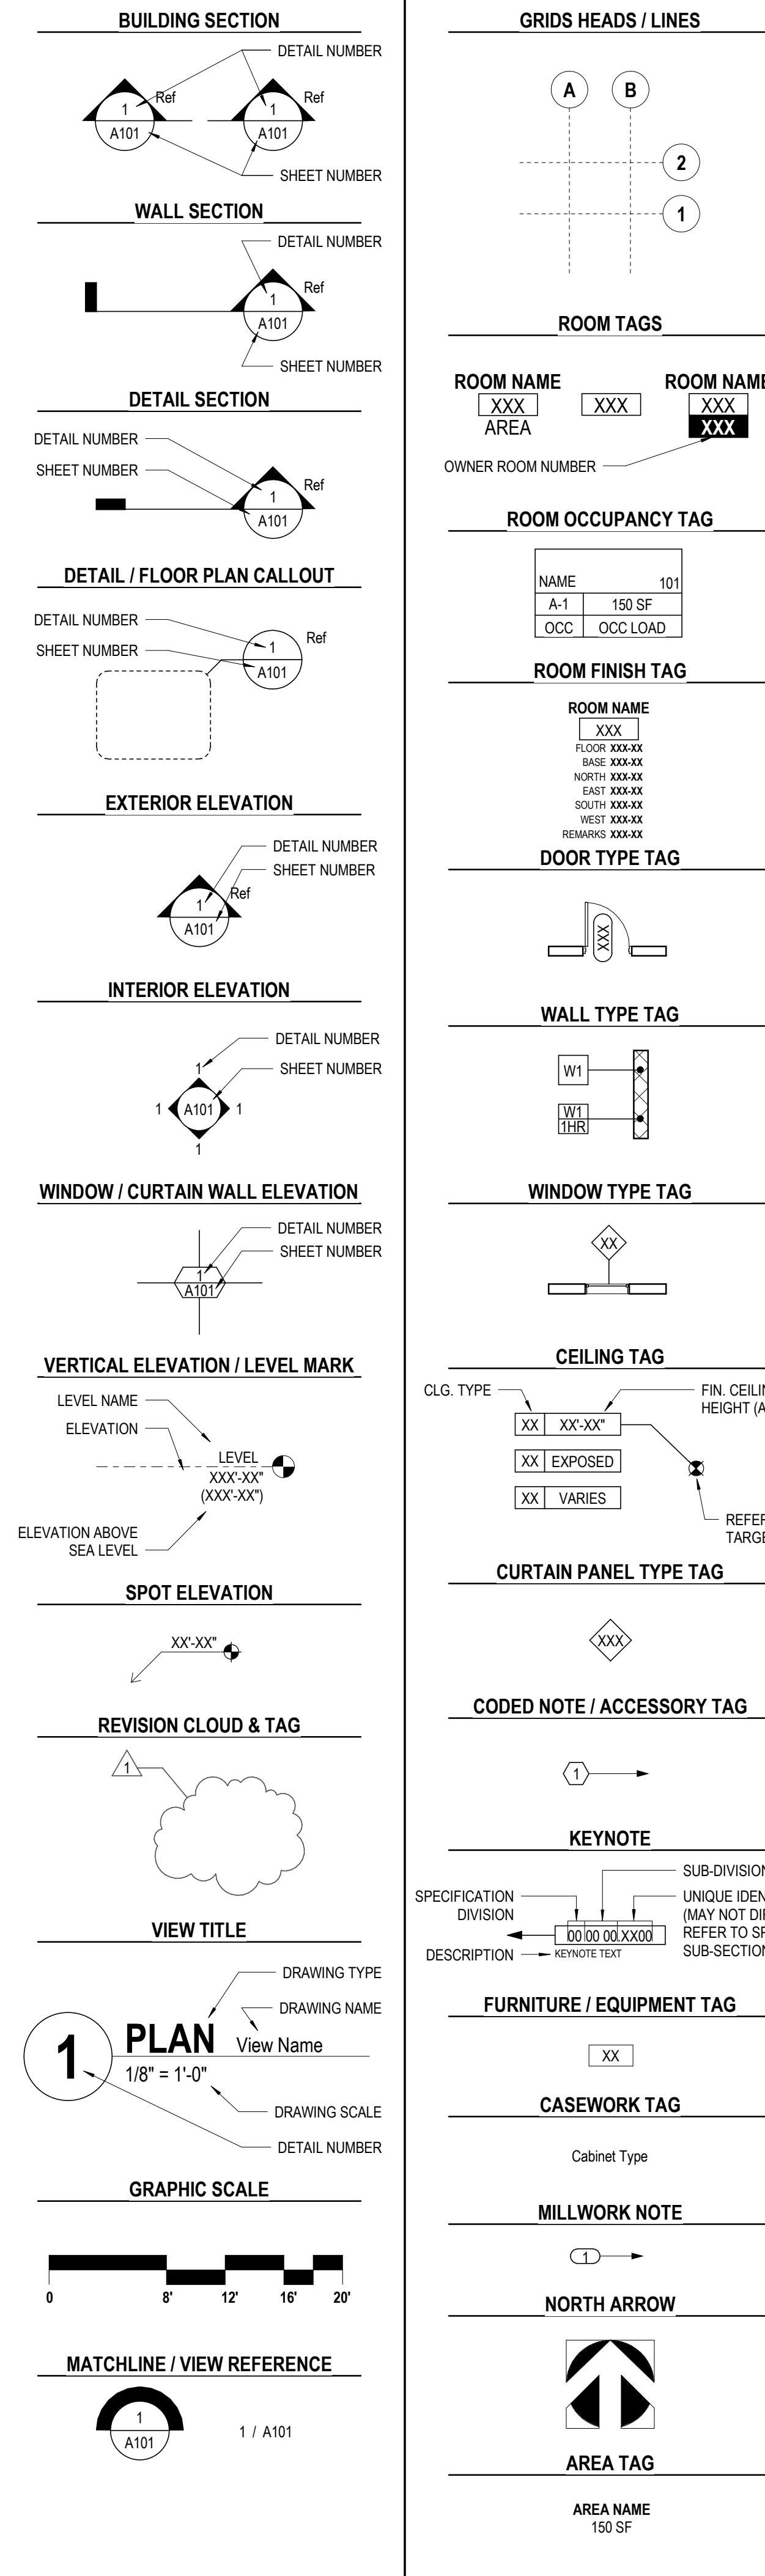

CODE SUMMARY

OWNER: HEARTLAND BANK
OWNERS ADDRESS: 430 N. HAMILTON ROAD, WHITEHALL, OH 43013
OWNERS PHONE:
SITE ADDRESS: 6500 FRANTZ ROAD, DUBLIN, OH 43017
SITE ZONING:
SITE AREA: 0.913 ACRES
PARKING REQUIRED: 4,436 SF/1000 x 2.5 = 12
PARKING SHOWN: 20 + 2 HANDICAPPED = 22
BUILDING CODES:
-OHIO BUILDING CODE: 2017 OBC
-OHIO PLUMBING CODE: 2017 OPC
-OHIO MECHANICAL CODE: 2017 OMC
-NATIONAL ELECTRIC CODE: 2017 NEC - NFPA 70
-INTERNATIONAL FUEL GAS CODE: 2015 IFGC
-INTERNATIONAL ENERGY CONSERVATION CODE: 2012 IECC
-ASHRAE 90.1 2007 ENERGY STANDARDS FOR BUILDING EXCEPT LOW-RISE RESIDENTIAL BUILDINGS: 2010 ASHRAE 90.1
-ICC A117.1-2009 ACCESSIBLE AND USEABLE BUILDINGS AND FACILITIES: ANSI A117.1 - 2009
-OHIO FIRE CODE: 2017 OFC
-NATIONAL FIRE ALARM AND SIGNALLING CODE NFPA 72-10
BUILDING DATA:
CONSTRUCTION TYPE: TYPE VB (COMBUSTIBLE, NON-PROTECTED)
USE GROUP: B - BUSINESS
ALLOWABLE HEIGHT: 40'-0"
ACTUAL HEIGHT: 25'-6"
ALLOWABLE AREA SF: 9,000 SF
ALLOWABLE AREA INCREASE FOR OPEN PERIMETER:
ALLOWABLE FLOOR AREA:
ACTUAL FLOOR AREAS: BASEMENT 2,106 SF, FIRST FLOOR 2,330 SF, TOTAL 4,436 SF
FIRE RESISTANCE RATINGS TABLE 602
EXTERIOR WALLS: 0 HR
VERTICAL CIRCULATION: 0 HR
EXIT ACCESS CORRIDORS: 0 HR
STRUCTURE: 0 HR
FLOORS: 0 HR
ROOF: 0 HR

INDEX OF DRAWINGS

Index of drawings table with columns for drawing number and sheet name, listing various drawings like GENERAL, CIVIL, LANDSCAPE, STRUCTURAL, DEMOLITION, ARCHITECTURAL, PLUMBING, MECHANICAL, and ELECTRICAL.


GENERAL NOTES

Area of general notes section, currently blank.

AREA MAP

VICINITY MAP

MATERIALS LEGEND

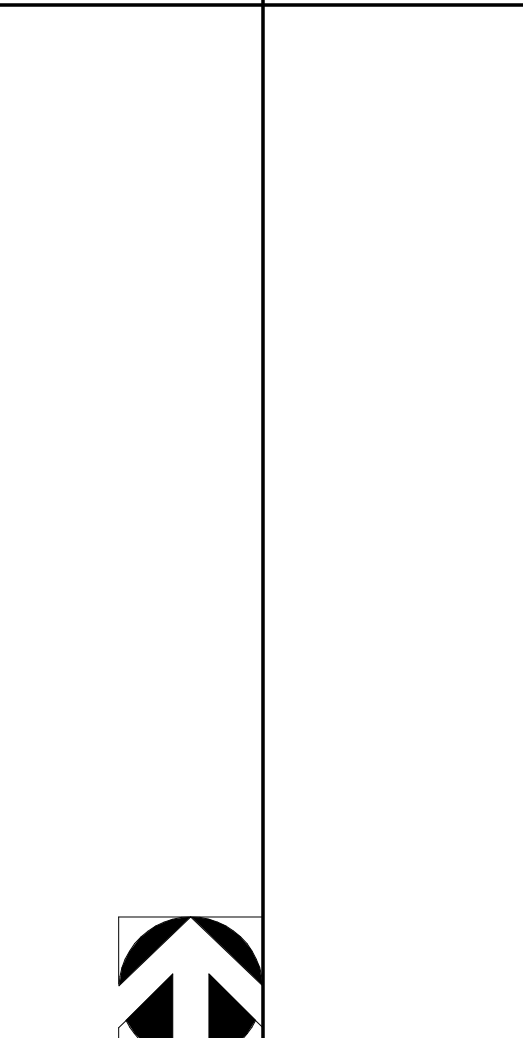


Materials legend table listing materials and their corresponding hatching patterns (e.g., ALUMINUM, GRANULAR FILL, ACOUSTIC CEILING, GYPSUM BOARD).

Project information block including logo for HEARTLAND BANK DUBLIN, address (300 SPRUCE STREET, SUITE 300, COLUMBUS, OHIO 43215), phone number (614) 461-4664, and fax number (614) 280-8881.


Drawing index block with a table showing drawing number (G001), date (11/30/2020), and status (FINAL DEVELOPMENT PLAN).

TYPE 1 - 1 5/8" METAL STUD WALL TYPES

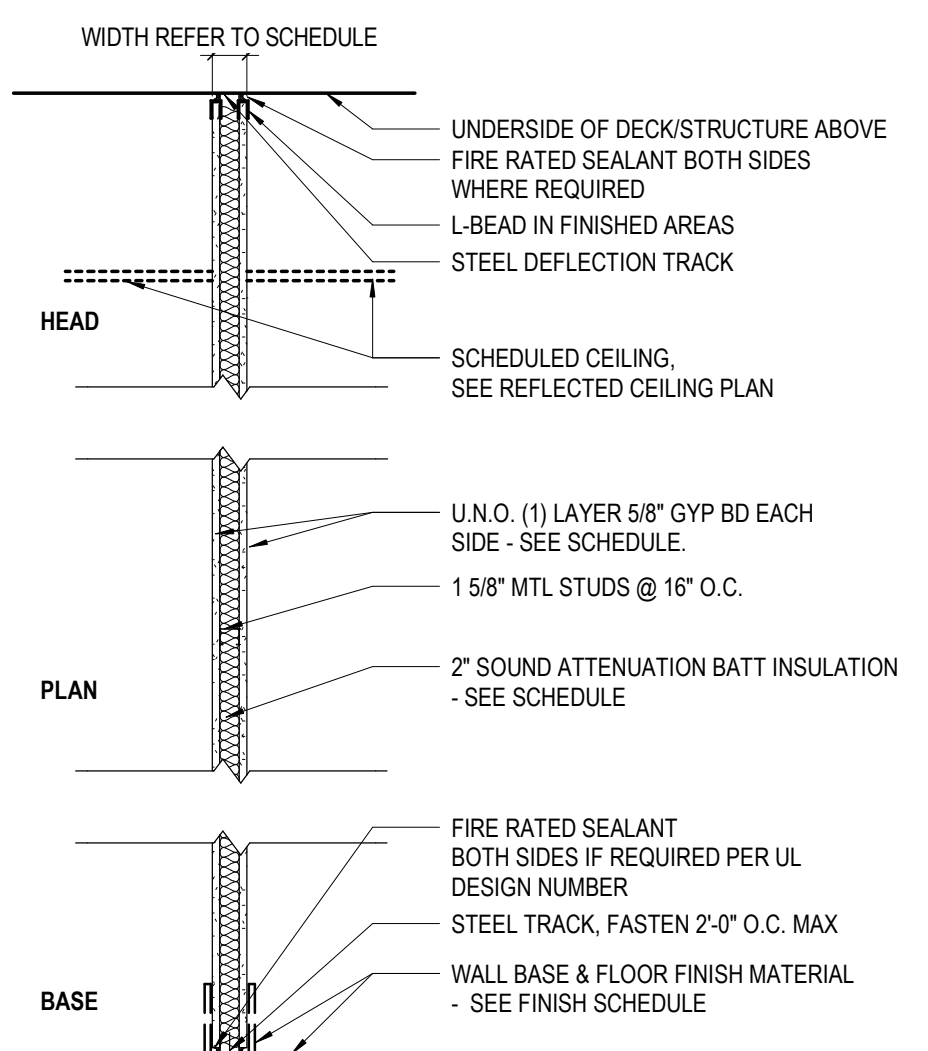


TYPE	WIDTH	STUD WIDTH	GYP. BD. - 1 SIDE	GYP. BD. - 2 SIDES	"TYPE X" GYP. BD.	FIRE RATING	UL #	STC RATING	SOUND INSUL.	CODED NOTES	COMMENTS
1K	2 1/4"	1 5/8"	Yes	No	No	0HR			No	04	
1L	2 1/4"	1 5/8"	Yes	No	No	0HR			No	05	

TYPE 2 - 2 1/2" METAL STUD WALL TYPES

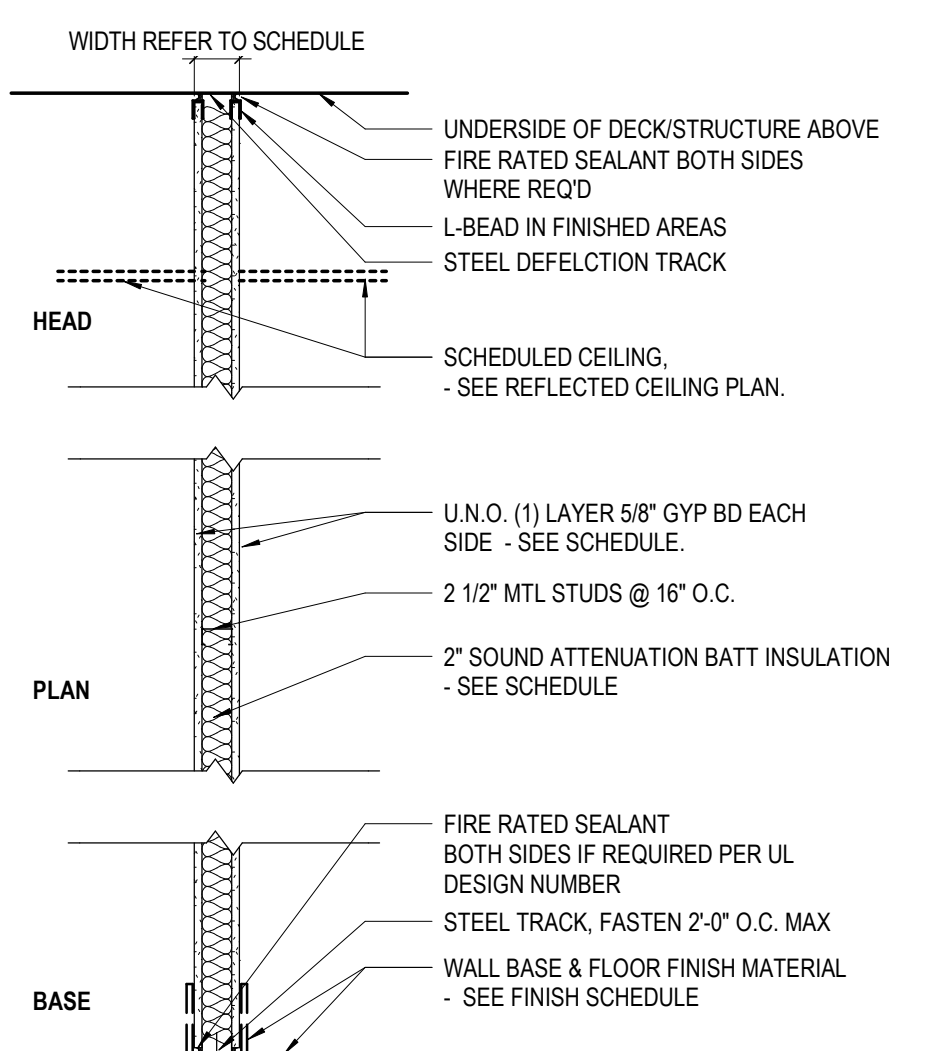


TYPE	WIDTH	STUD WIDTH	GYP. BD. - 1 SIDE	GYP. BD. - 2 SIDES	"TYPE X" GYP. BD.	FIRE RATING	UL #	STC RATING	SOUND INSUL.	CODED NOTES	COMMENTS
2K	4 1/8"	2 1/2"	No	Yes	No	0HR		43	Yes	04	
2L	4 1/8"	2 1/2"	No	Yes	No	0HR		40	No	04	
2M	4 1/4"	2 1/2"	Yes	No	No	0HR		No	02, 05		

TYPE 3 - 3 5/8" METAL STUD WALL TYPES

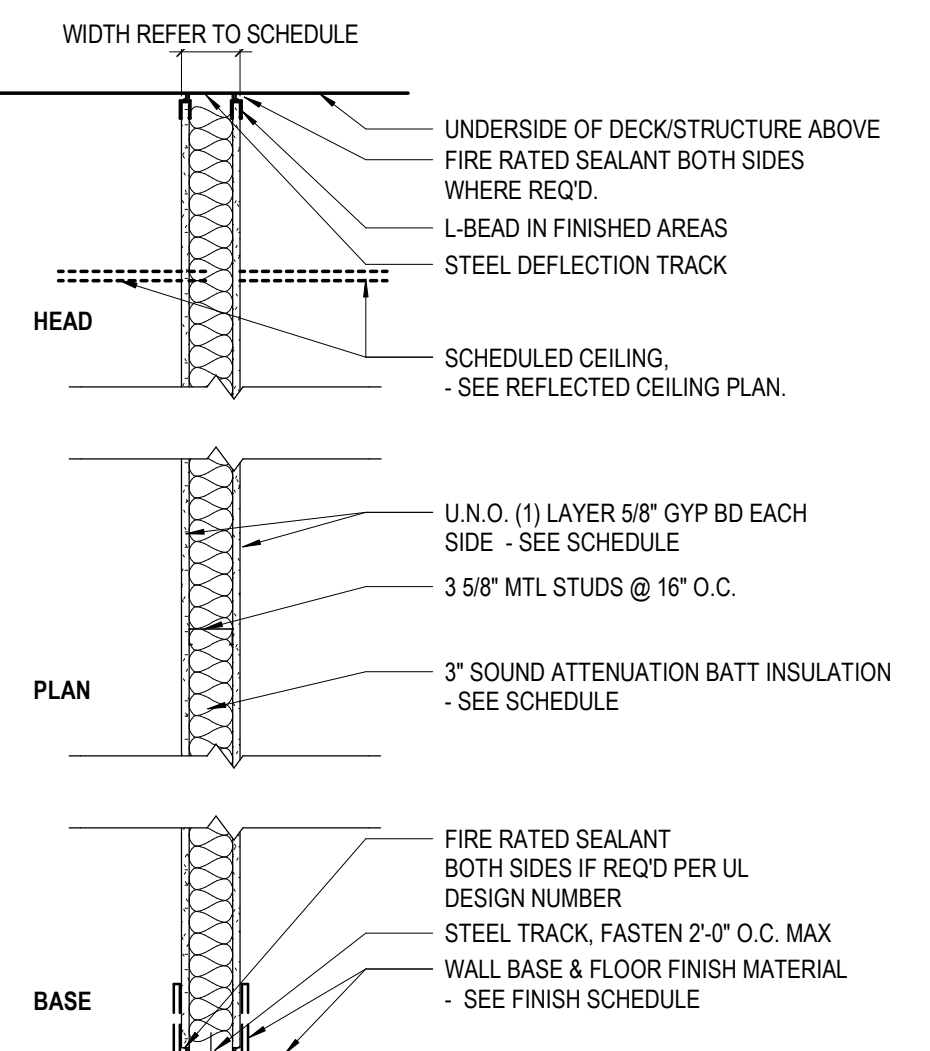


TYPE	WIDTH	STUD WIDTH	GYP. BD. - 1 SIDE	GYP. BD. - 2 SIDES	"TYPE X" GYP. BD.	FIRE RATING	UL #	STC RATING	SOUND INSUL.	CODED NOTES	COMMENTS
3K	4 1/4"	3 5/8"	Yes	No	No	0HR		43	Yes	04	
3L	4 1/4"	3 5/8"	Yes	No	No	0HR		40	No	04	
3M	4 1/4"	3 5/8"	Yes	No	No	0HR		No	02, 05		

TYPE 4 - 6" METAL STUD WALL TYPES

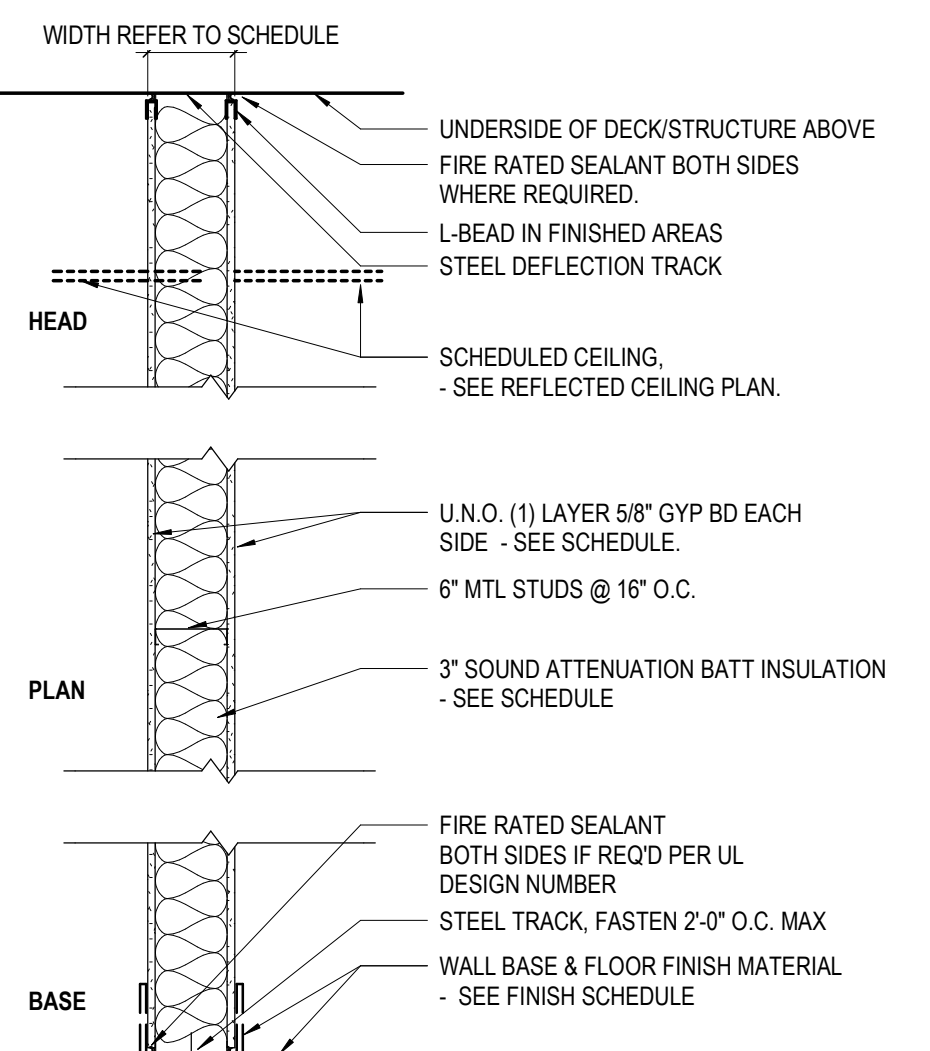

TYPE	WIDTH	STUD WIDTH	GYP. BD. - 1 SIDE	GYP. BD. - 2 SIDES	"TYPE X" GYP. BD.	FIRE RATING	UL #	STC RATING	SOUND INSUL.	CODED NOTES	COMMENTS
4K	6"	6"	Yes	No	No	0HR		43	Yes	04	
4L	6"	6"	Yes	No	No	0HR		40	No	04	
4M	6"	6"	Yes	No	No	0HR		No	02, 05		

TYPE 5 - MISC. METAL STUD WALL TYPES

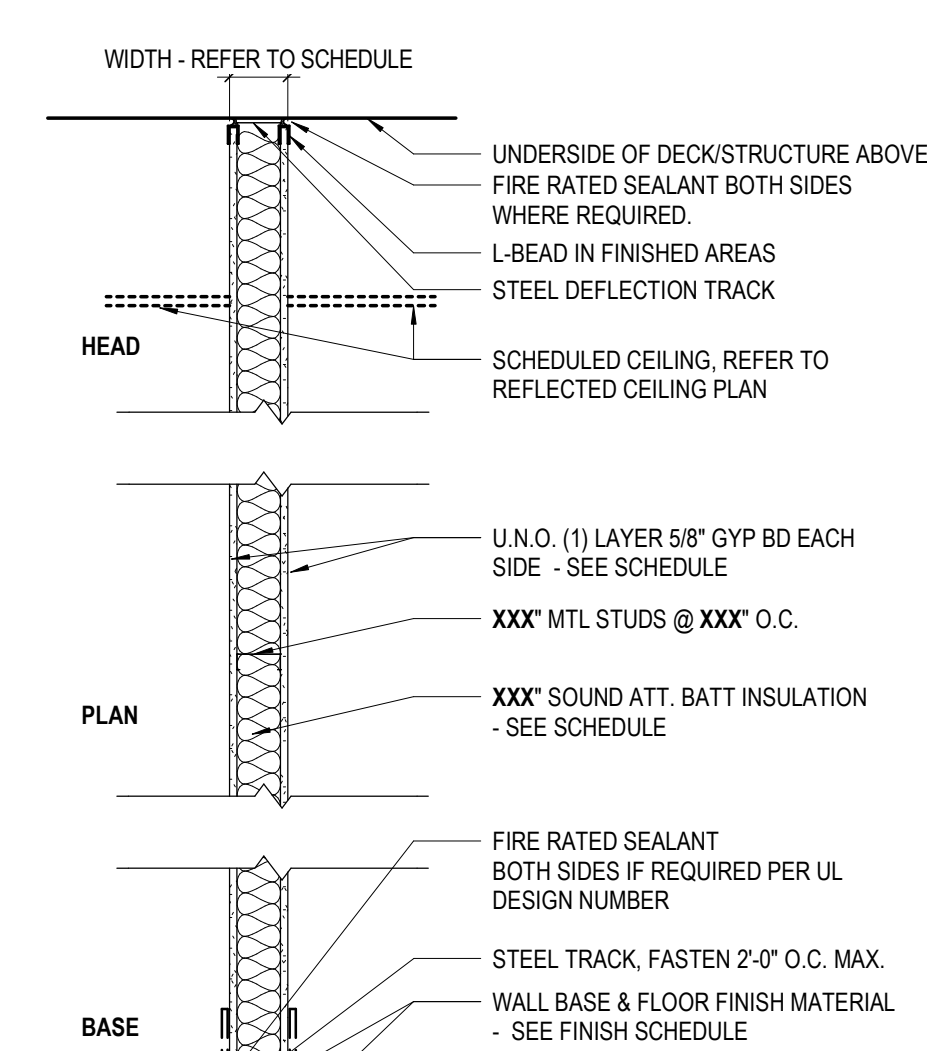

TYPE	WIDTH	STUD WIDTH	GYP. BD. - 1 SIDE	GYP. BD. - 2 SIDES	"TYPE X" GYP. BD.	FIRE RATING	UL #	STC RATING	SOUND INSUL.	CODED NOTES	COMMENTS
5K	6"	6"	Yes	No	No	0HR		43	Yes	04	
5L	6"	6"	Yes	No	No	0HR		40	No	04	
5M	6"	6"	Yes	No	No	0HR		No	02, 05		


GENERAL NOTES - WALL TYPE

- ALL DIMENSIONS TO FACE OF WALL UN.O.
- USE 5/8" WATER RESISTANT GYP. BD. ON ALL WET WALLS, UNO.
- USE CEMENT BOARD FOR ALL WALLS TO RECEIVE CERAMIC TILE, UNO.
- FIRE SAFE ALL JOINTS AND PENETRATIONS AT FIRE RATED PARTITIONS.
- UL NUMBERS LISTED APPLY ONLY TO THE TESTED MANUFACTURERS. EQUAL MANUFACTURERS EQUIVALENT ASSEMBLY INFORMATION MUST BE APPROVED BY ARCHITECT.
- INSULATION MUST EXTEND FULL HEIGHT OF PARTITION. WHERE SOUND ATTENUATION BATTS ARE INDICATED IN PARTITIONS, INSTALL ACOUSTIC SEALANT AT BOTH SIDES, ALONG THE TOP AND BOTTOM, AND AT INTERSECTING PARTITIONS.
- WHERE 3 5/8", 4" OR 6" STUD WALLS ARE INDICATED, SEE SPECIFICATIONS FOR HEIGHT LIMITS.
- REFER TO FINISH SCHEDULE FOR FINISHES.
- PROVIDE ACOUSTIC SEALANT AT TOP & BOTTOM OF PARTITION AS REQUIRED BY STC RATING.

CODED NOTE LEGEND


- BRACE EACH STUD @ 4'-0" O.C. TO BACK-UP WALL FOR ENTIRE HEIGHT OF PARTITION.
- BRACE EACH STUD @ 8'-0" O.C. TO BACK-UP WALL FOR ENTIRE HEIGHT OF PARTITION.
- SMOKE TIGHT SEAL SHALL BE PROVIDED AT TOP, BOTTOM AND ENDS OF WALL AND AT ALL PENETRATIONS.
- FULL HEIGHT PARTITION. TERMINATE GYP. BD. AND STUDS AT DECKSTRUCTURE ABOVE.
- STOP GYP. BD. AND STUDS 6" AFC. BRACE PARTITION TO DECKSTRUCTURE PER METAL STUD MANUFACTURER DESIGN LOADING CRITERIA.
- FULL HEIGHT SHAFR WALL. TERMINATE GYP. BD. AND STUDS AT DECKSTRUCTURE ABOVE.
- FULL HEIGHT PARTITION. TERMINATE GYP. BD., PLYWOOD AND STUDS AT DECKSTRUCTURE ABOVE.
- FULL HEIGHT PARTITION. TERMINATE CMU AT DECKSTRUCTURE ABOVE.
- STOP CMU FULL COURSE ABOVE FINISH CEILING. BRACE WALL TO STRUCTURE PER STRUCTURAL DRAWINGS.
- FULL HEIGHT PARTITION. TERMINATE CMU AT DECK ABOVE. STOP FURRING AND GYP. BD. @ 6" ABOVE FINISHED CEILING.
- STOP WALL FULL COURSE ABOVE FINISH CEILING. BRACE WALL TO STRUCTURE PER STRUCTURAL DRAWINGS.

TYPE 6 - 4" CONCRETE MASONRY WALLS

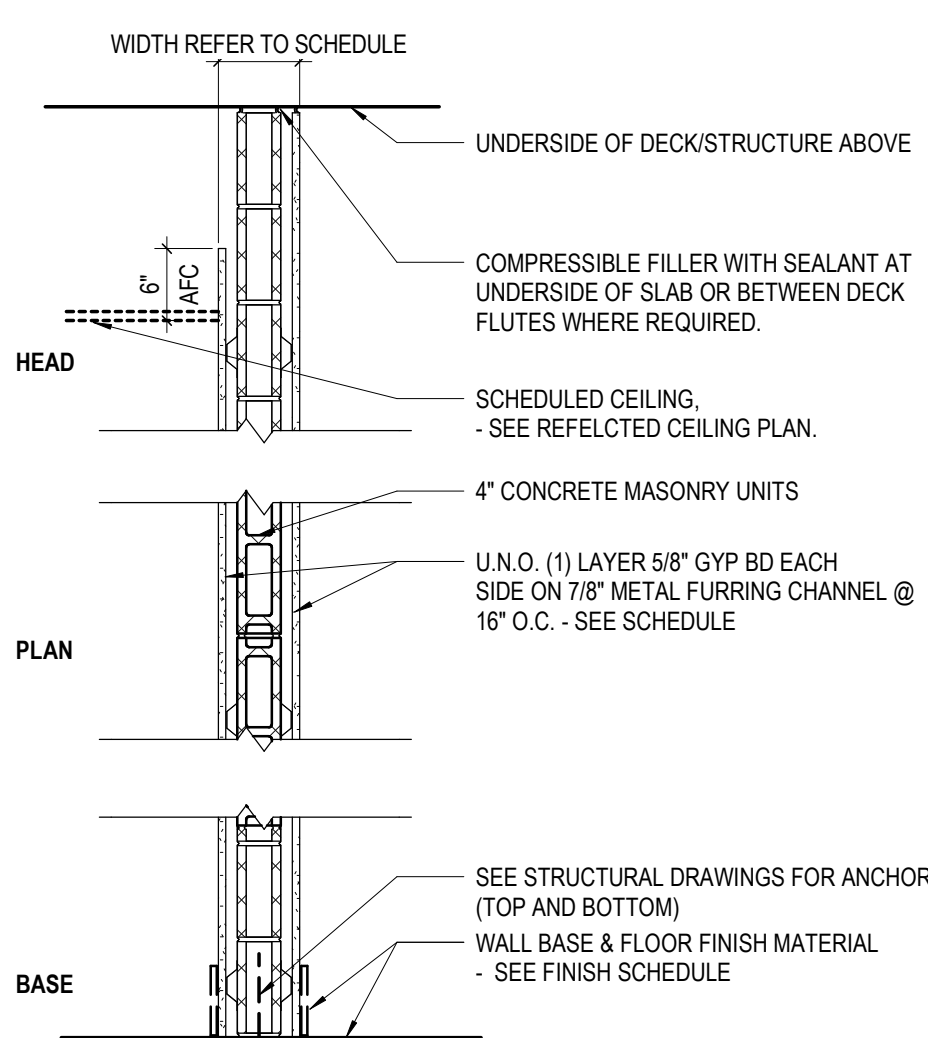


TYPE	WIDTH	GYP. BD. - 1 SIDE	GYP. BD. - 2 SIDES	"TYPE X" GYP. BD.	FIRE RATING	UL #	STC RATING	SOUND INSUL.	CODED NOTES	COMMENTS
6K	4"	Yes	No	No	0HR					
6L	4"	Yes	No	No	0HR					

TYPE 7 - 6" CONCRETE MASONRY WALLS

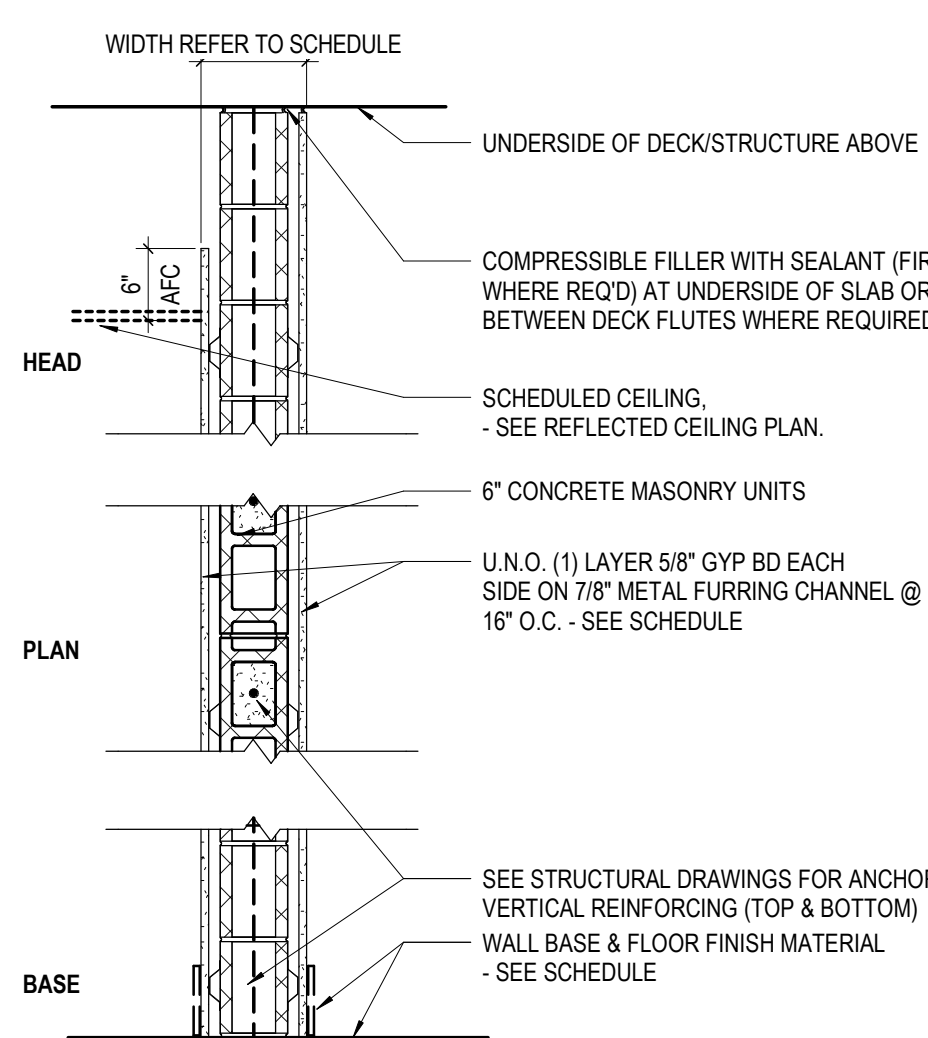


TYPE	WIDTH	GYP. BD. - 1 SIDE	GYP. BD. - 2 SIDES	"TYPE X" GYP. BD.	FIRE RATING	UL #	STC RATING	SOUND INSUL.	CODED NOTES	COMMENTS
7K	6"	Yes	No	No	0HR		46	No	08	
7L	6"	Yes	No	No	0HR		45+	No	10	7/8" METAL FURRING @ 16" O.C.

TYPE 8 - 8" CONCRETE MASONRY WALLS

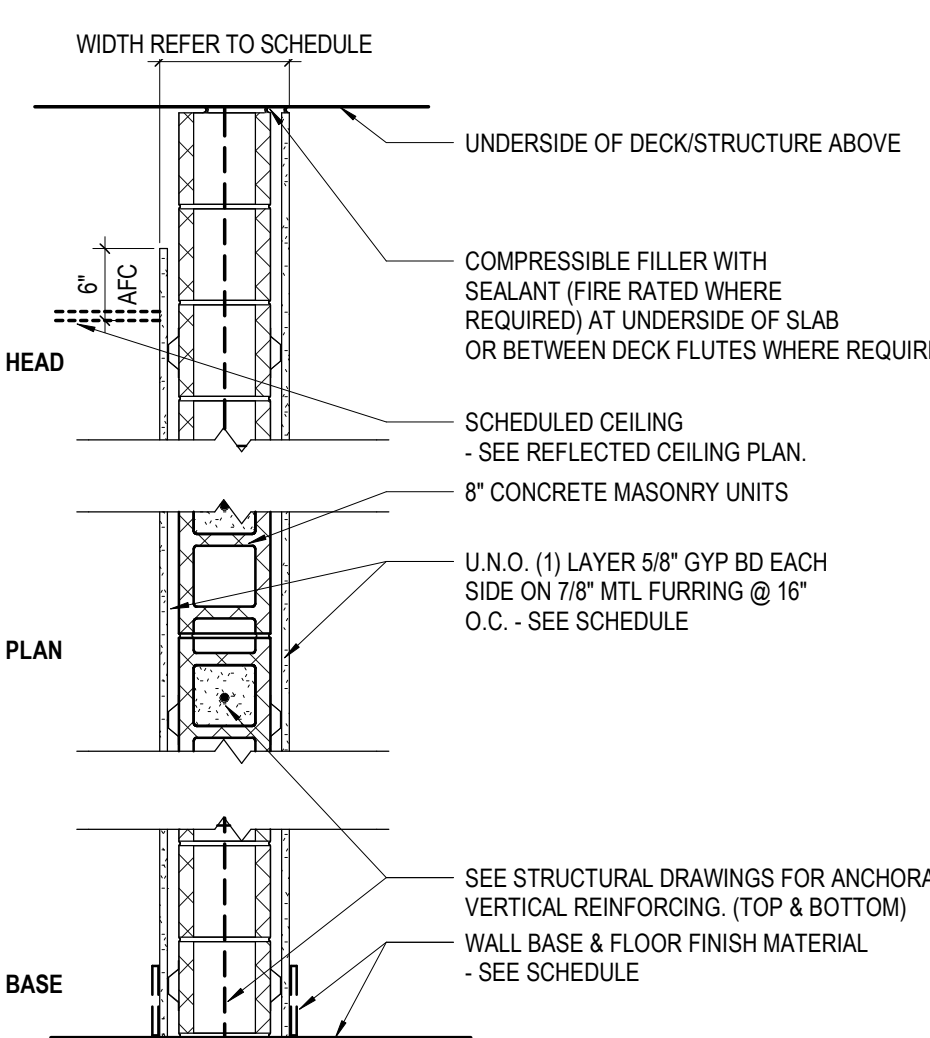


TYPE	WIDTH	GYP. BD. - 1 SIDE	GYP. BD. - 2 SIDES	"TYPE X" GYP. BD.	FIRE RATING	UL #	STC RATING	SOUND INSUL.	CODED NOTES	COMMENTS
8K	8"	Yes	No	No	0HR		46	No	08	
8L	8"	Yes	No	No	0HR		45+	No	10	7/8" METAL FURRING @ 16" O.C.

TYPE 9 - 10" CONCRETE MASONRY WALLS

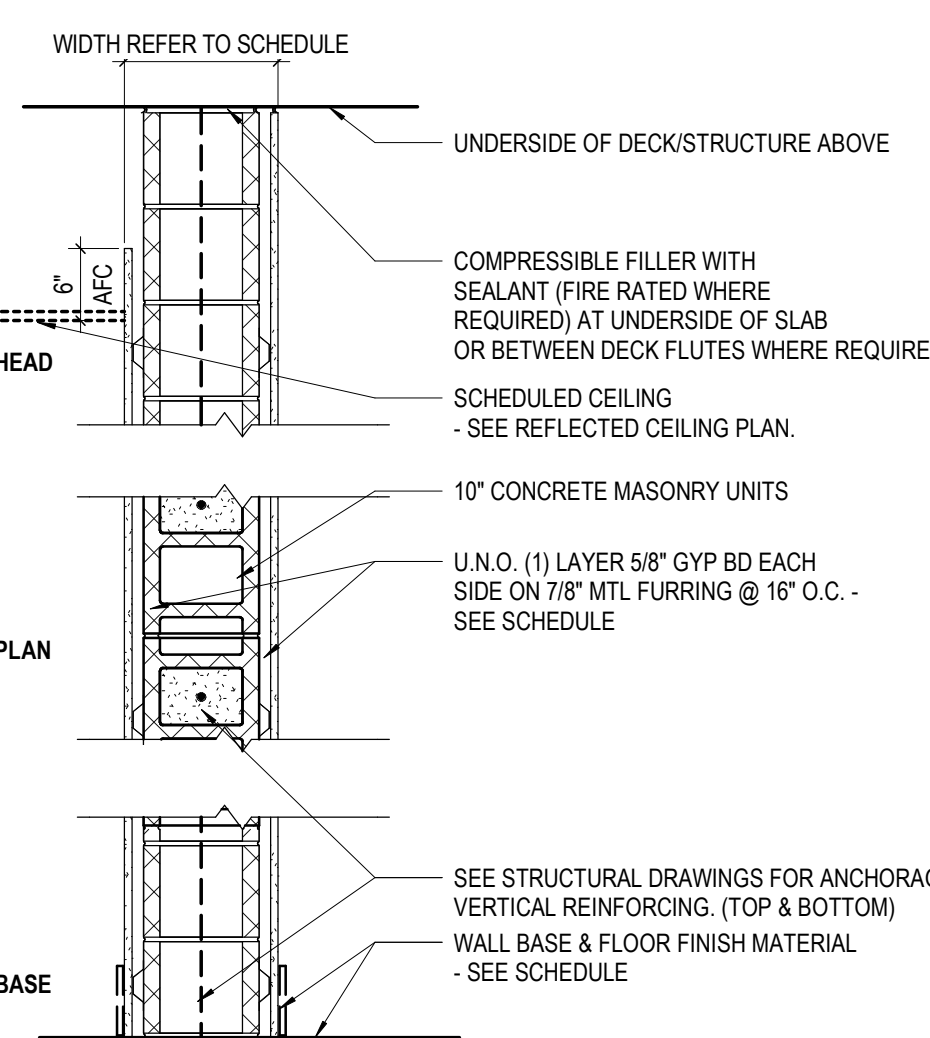


TYPE	WIDTH	GYP. BD. - 1 SIDE	GYP. BD. - 2 SIDES	"TYPE X" GYP. BD.	FIRE RATING	UL #	STC RATING	SOUND INSUL.	CODED NOTES	COMMENTS
9K	10"	Yes	No	No	0HR		46	No	10	7/8" METAL FURRING @ 16" O.C.
9L	10"	Yes	No	No	0HR		45+	No	10	7/8" METAL FURRING @ 16" O.C.

TYPE 10 - 12" CONCRETE MASONRY WALLS

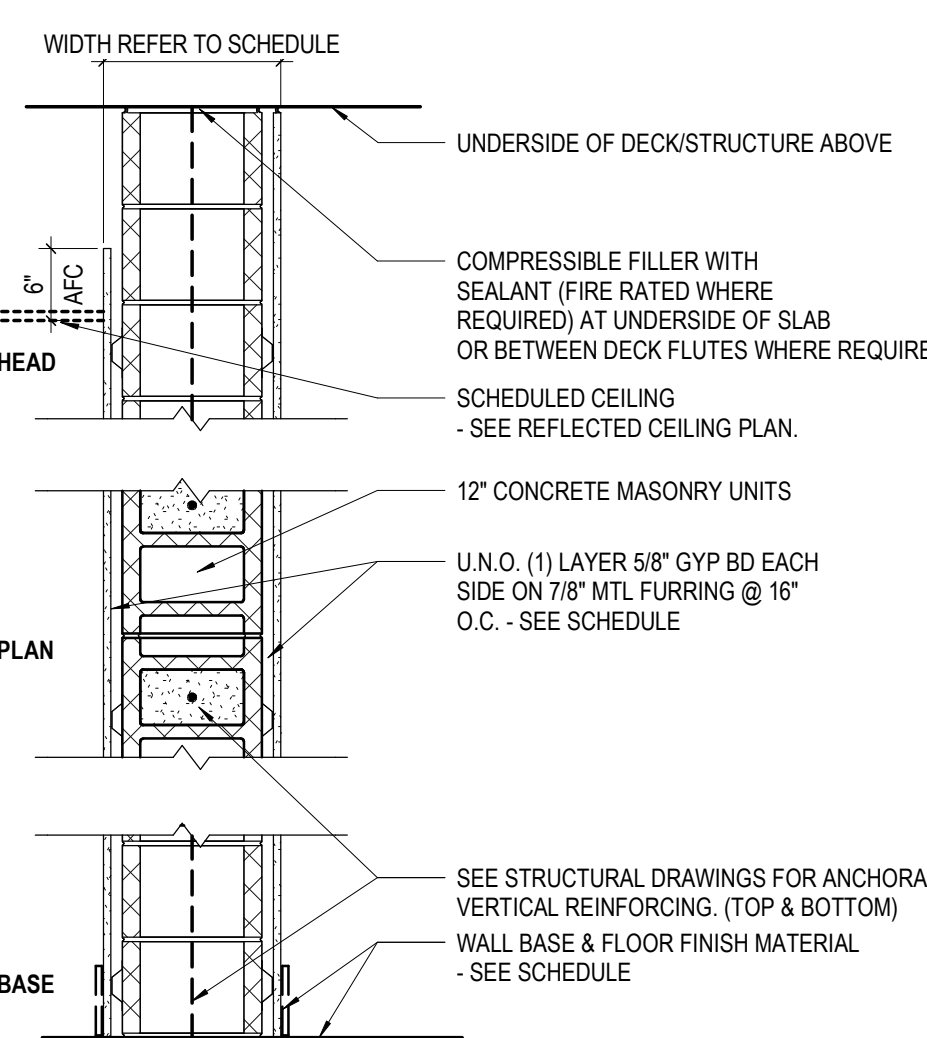


TYPE	WIDTH	GYP. BD. - 1 SIDE	GYP. BD. - 2 SIDES	"TYPE X" GYP. BD.	FIRE RATING	UL #	STC RATING	SOUND INSUL.	CODED NOTES	COMMENTS
10K	12"	Yes	No	No	0HR		46	No	10	7/8" METAL FURRING @ 16" O.C.
10L	12"	Yes	No	No	0HR		45+	No	10	7/8" METAL FURRING @ 16" O.C.

TYPE 11 - 2 X 4 WOOD STUD WALL TYPES

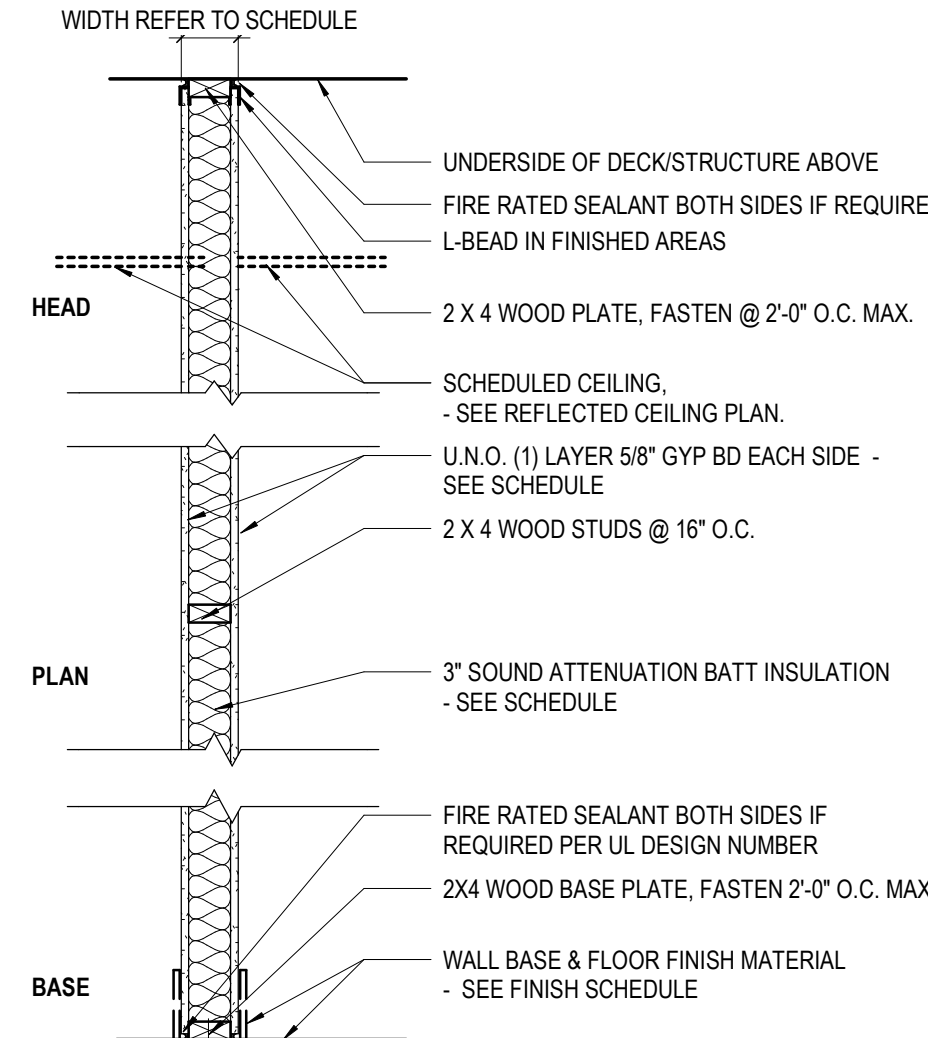


TYPE	WIDTH	STUD WIDTH	GYP. BD. - 1 SIDE	GYP. BD. - 2 SIDES	"TYPE X" GYP. BD.	FIRE RATING	UL #	STC RATING	SOUND INSUL.	CODED NOTES	COMMENTS
11D	4 3/4"	2x4	No	Yes	No	0HR		35	No	04	
11E	4 1/8"	2x4	No	Yes	No	0HR		35	No	04	
11F	4 3/4"	2x4	No	Yes	No	0HR		35	No	05	

TYPE 12 - 2 X 6 WOOD STUD WALL TYPES

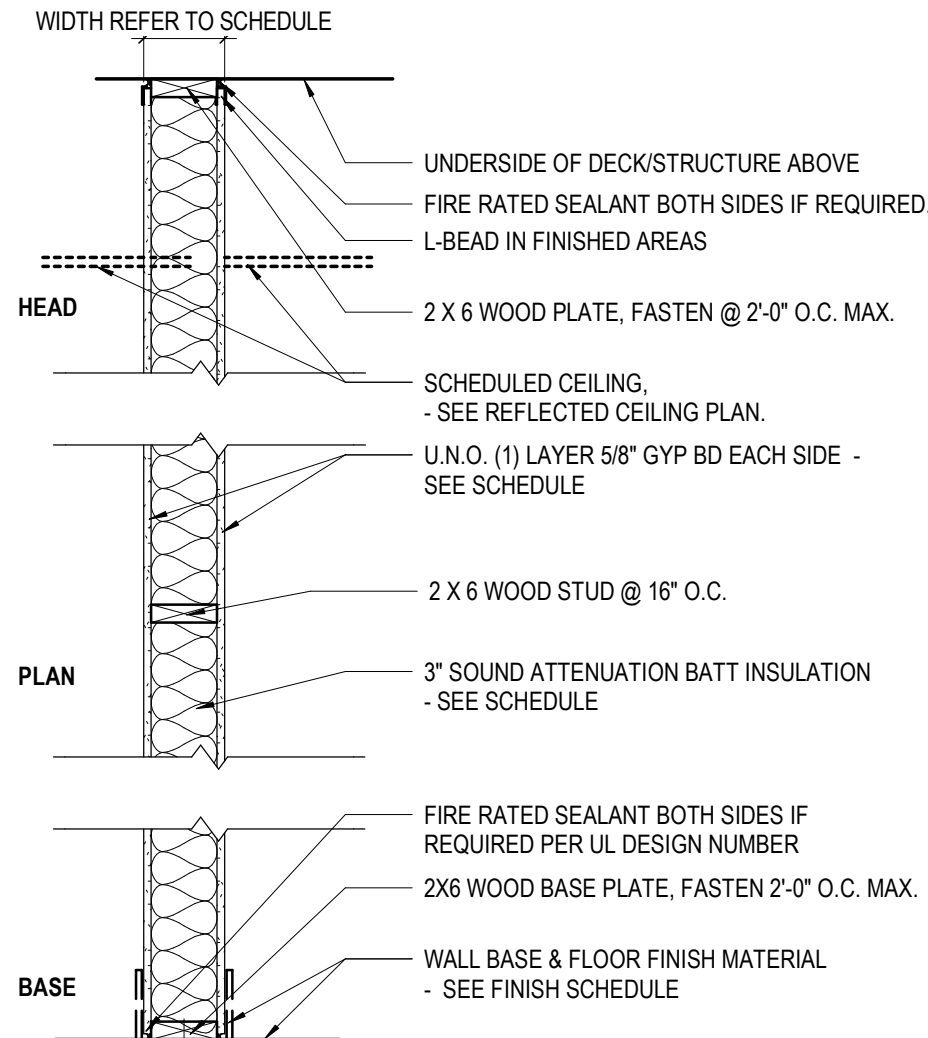


TYPE	WIDTH	STUD WIDTH	GYP. BD. - 1 SIDE	GYP. BD. - 2 SIDES	"TYPE X" GYP. BD.	FIRE RATING	UL #	STC RATING	SOUND INSUL.	CODED NOTES	COMMENTS
12D	6 3/4"	2x6	No	Yes	No	0HR		35	EST.	04	
12E	6 3/4"	2x6	No	Yes	No	0HR		35	EST.	04	

TYPE S - SHAFR WALL TYPES

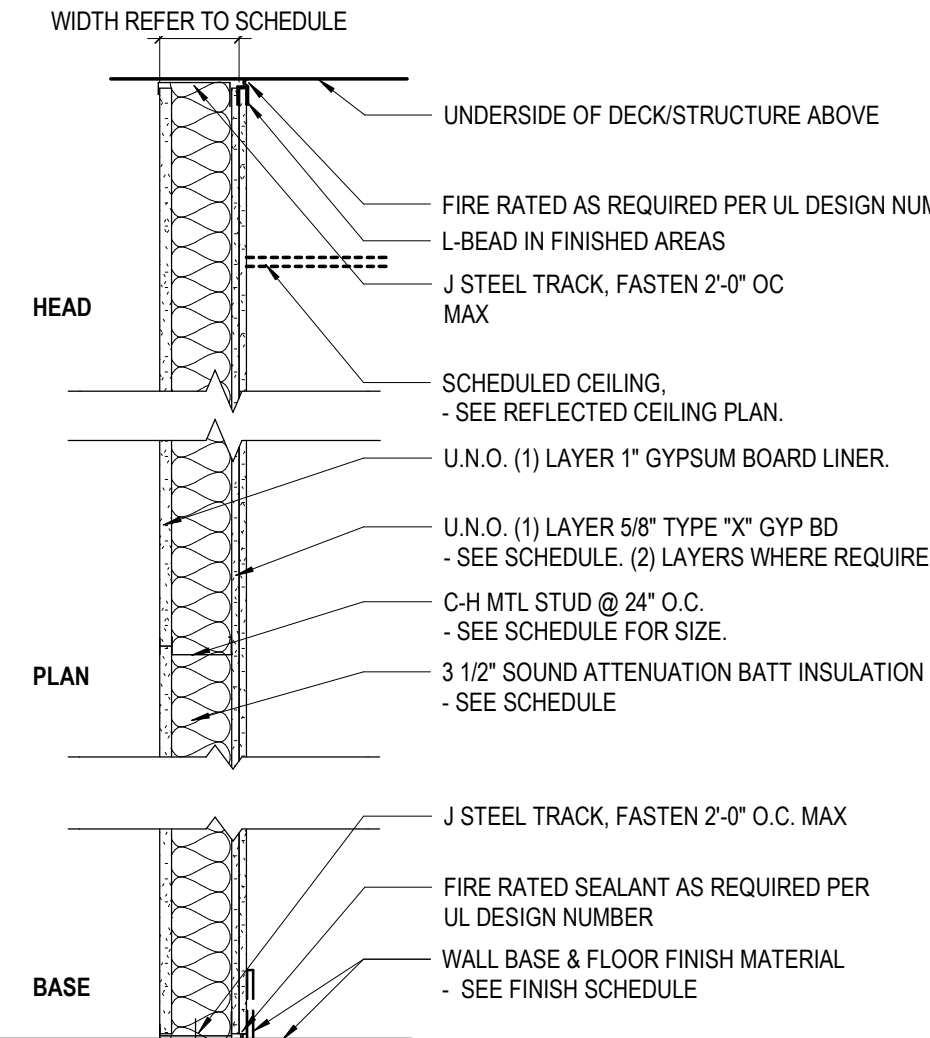


TYPE	WIDTH	STUD WIDTH	GYP. BD. - 1 SIDE	GYP. BD. - 2 SIDES	"TYPE X" GYP. BD.	FIRE RATING	UL #	STC RATING	SOUND INSUL.	CODED NOTES	COMMENTS
S											

TYPE CM - MASONRY CHASE WALL TYPES

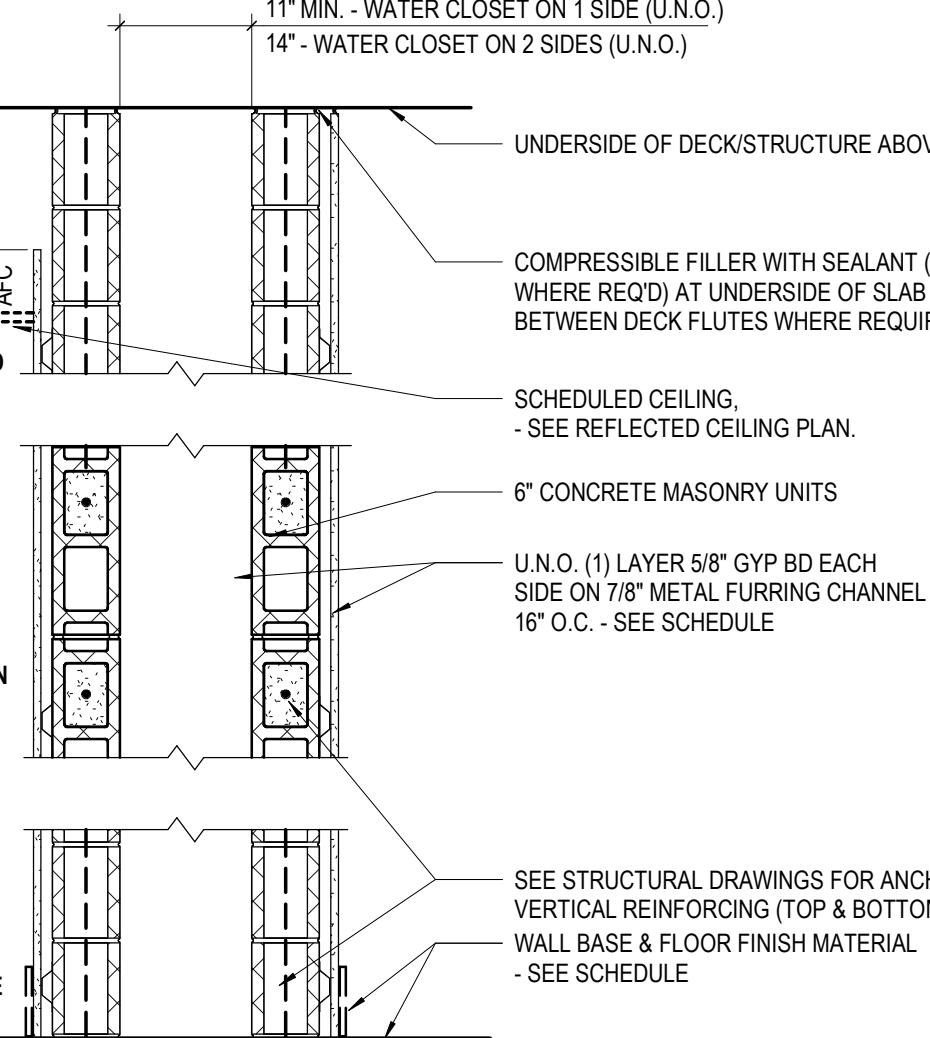

TYPE	WIDTH	STUD WIDTH	GYP. BD. - 1 SIDE	GYP. BD. - 2 SIDES	"TYPE X" GYP. BD.	FIRE RATING	UL #	STC RATING	SOUND INSUL.	CODED NOTES	COMMENTS
CM											

TYPE CS - STUD CHASE WALL TYPES

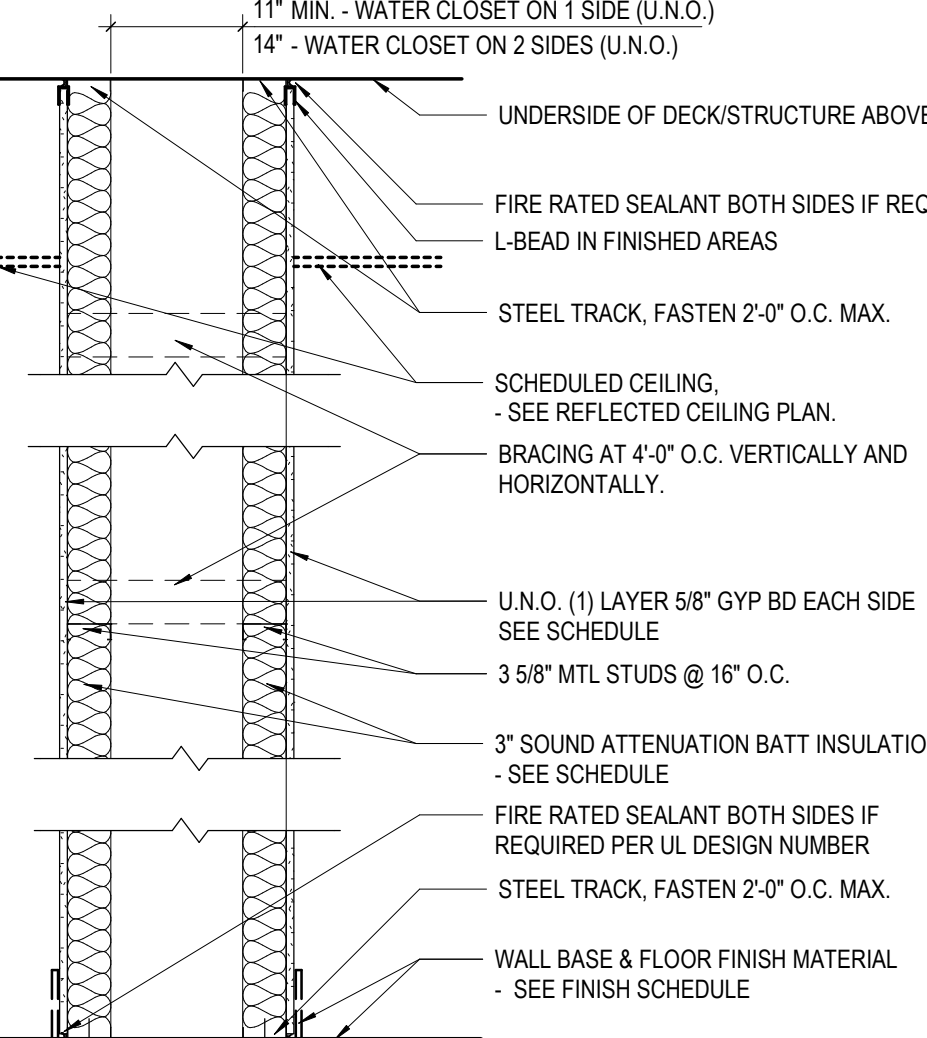


TYPE	WIDTH	STUD WIDTH	GYP. BD. - 1 SIDE	GYP. BD. - 2 SIDES	"TYPE X" GYP. BD.	FIRE RATING	UL #	STC RATING	SOUND INSUL.	CODED NOTES	COMMENTS
CS											

#	DATE	CHANGE DESCRIPTION

RENOVATION OF HEARTLAND BANK DUBLIN
 5303 FRANKLIN ROAD
 DUBLIN, OH 43017
 FOR
HEARTLAND BANK
 300 SPRUCE STREET
 SUITE 300
 COLUMBUS, OHIO 43215
 PHONE: (614) 461-4664
 FAX: (614) 280-8881


DRAWING TITLE:
WALL TYPE SCHEDULE
 11/30/2020
 DRAWN BY: XXXX CHECKED BY: XXXX
 20022
G002
 FINAL DEVELOPMENT PLAN

RE-ESTABLISH DITCH FLOW LINE AT 1.5% SLOPE. USE EXTREME CAUTION EXCAVATING IN PROXIMITY TO UNDERGROUND ELECTRIC AND TELEPHONE. SEE ODOT R/W PERMIT

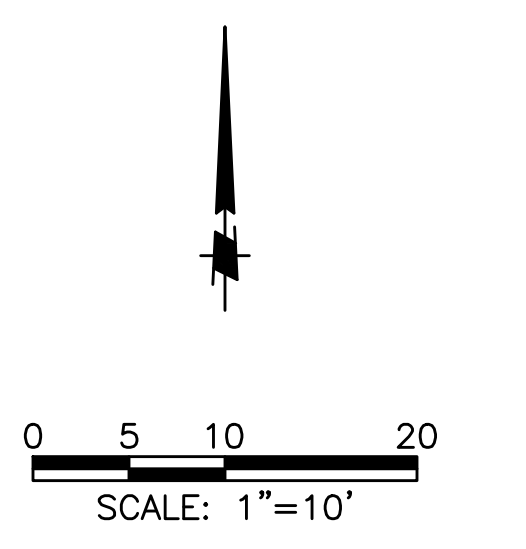

LEGEND

CONCRETE SIDEWALK REMOVED AND REPLACED

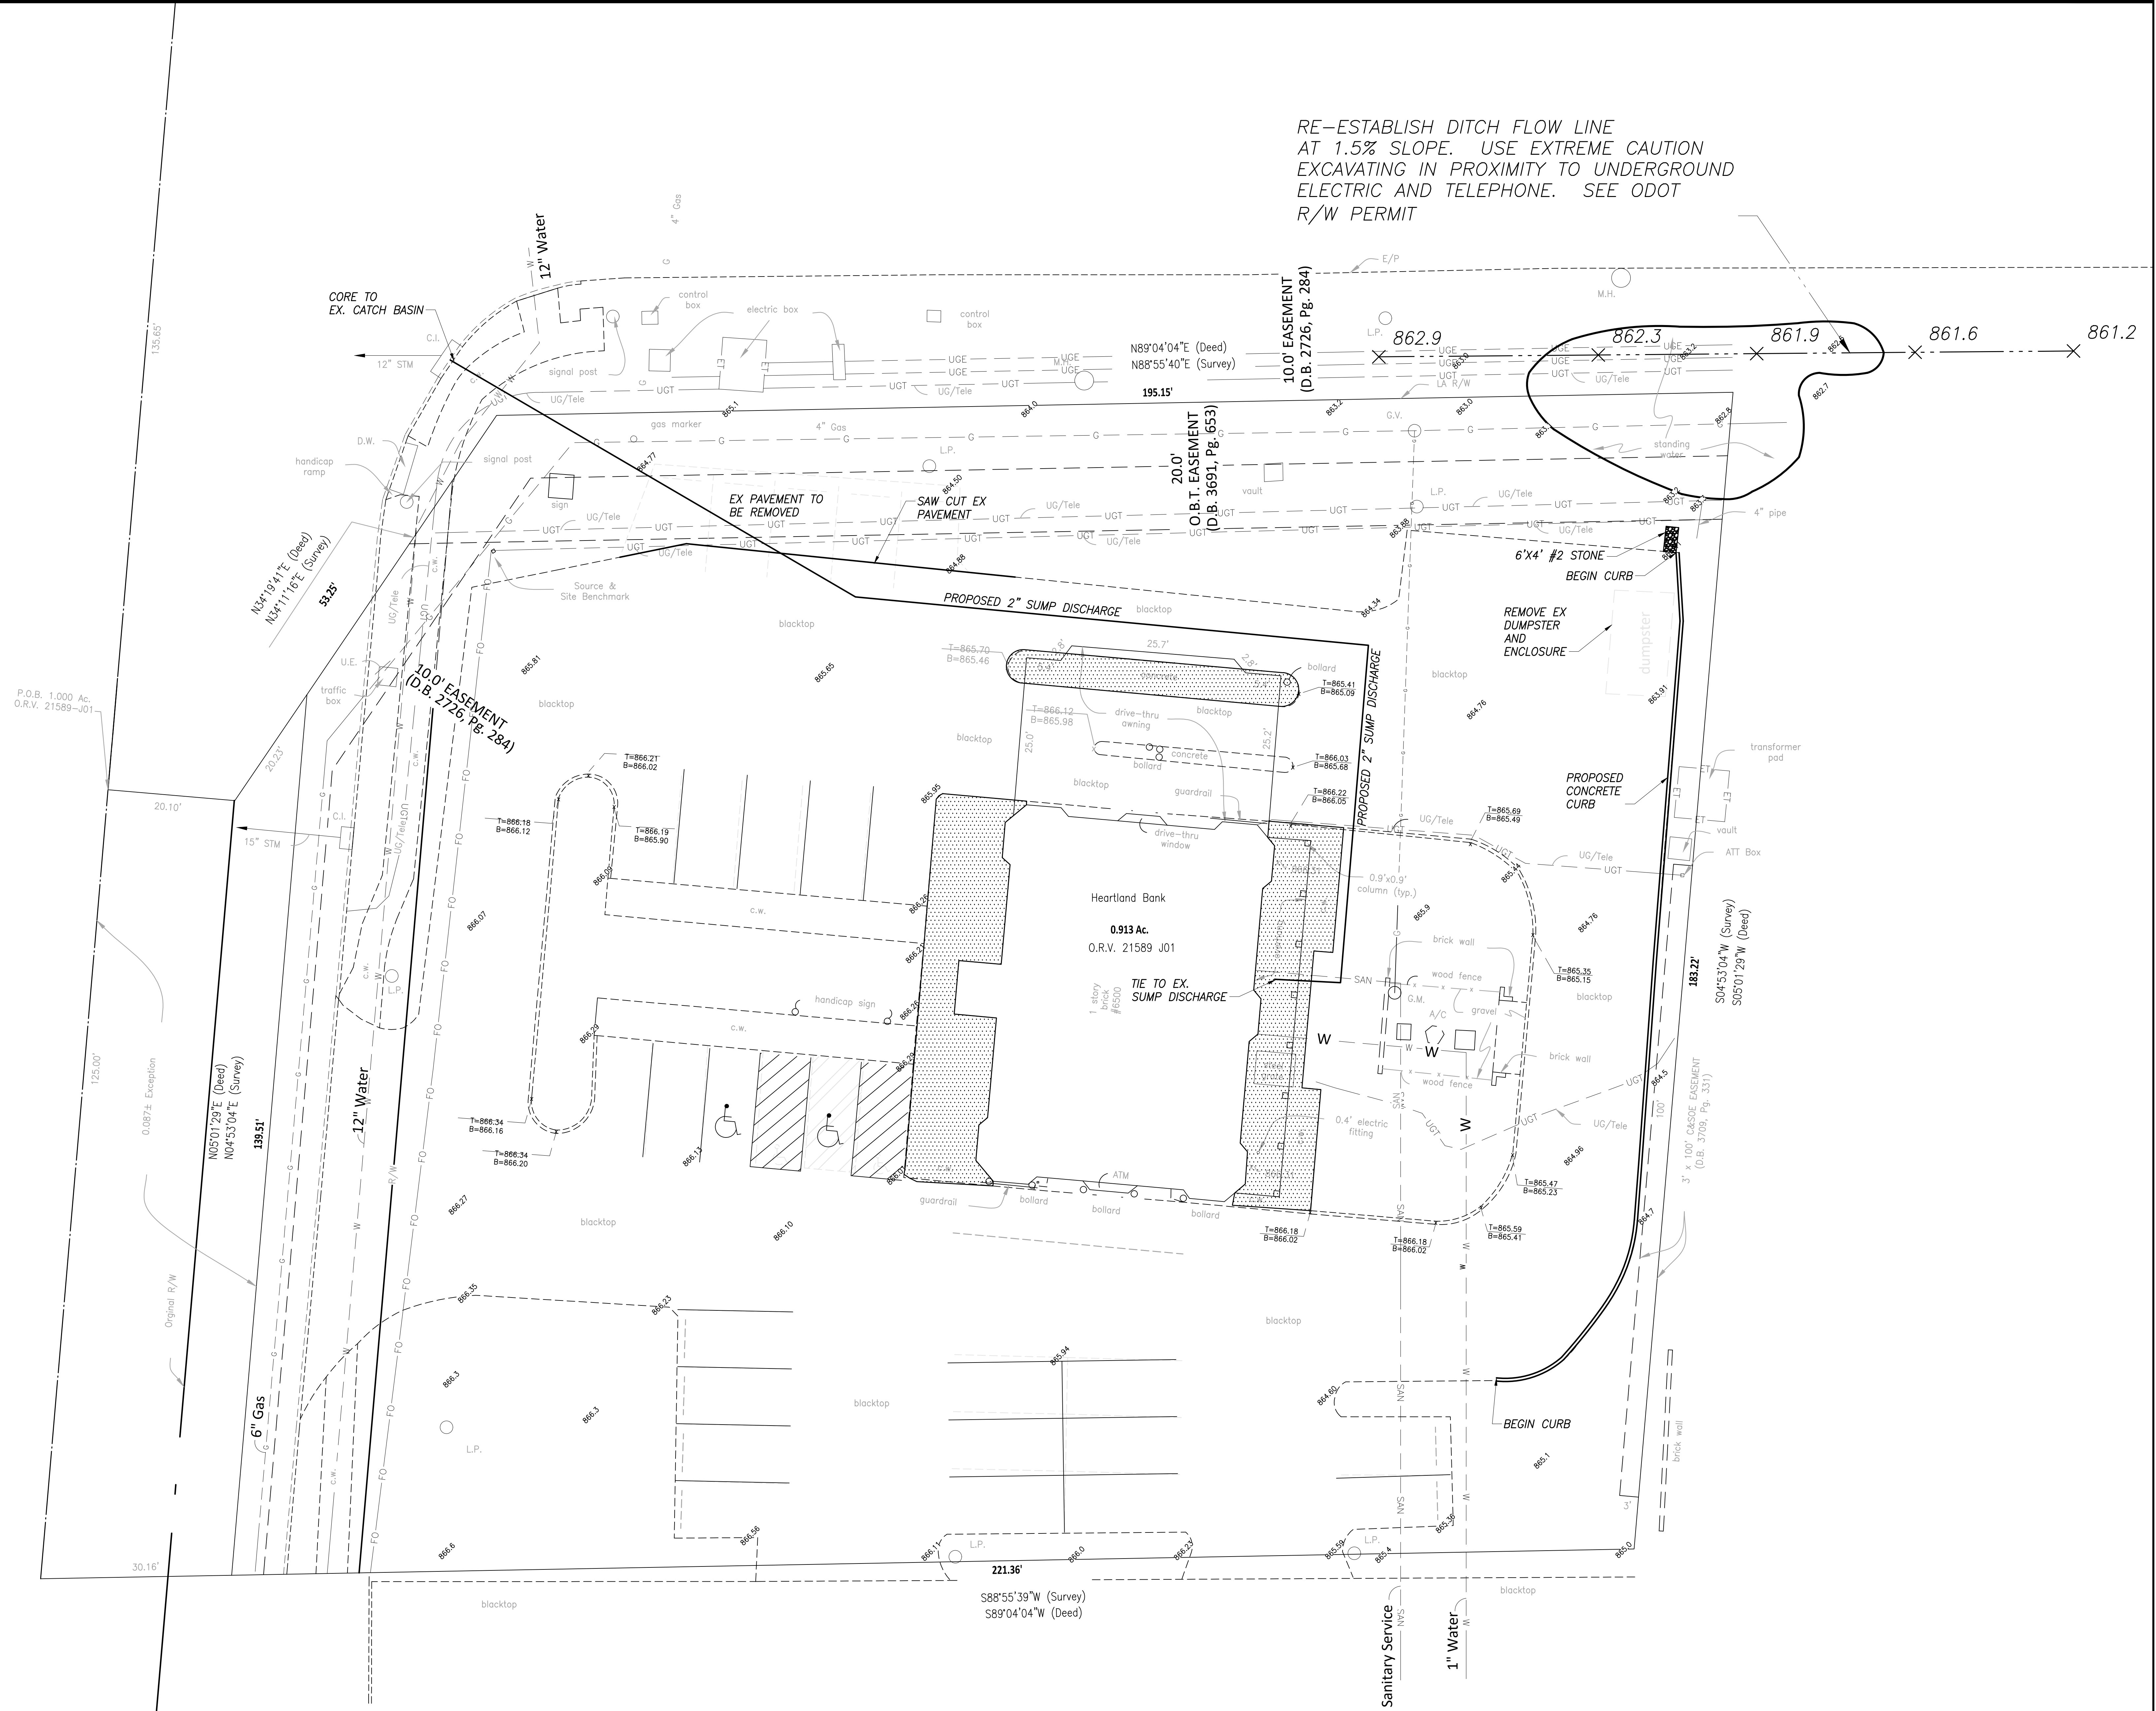

NOTE:
1) SEE ARCHITECTURAL SITE PLAN FOR PROPOSED LOT STRIPING

#	DATE	CHANGE DESCRIPTION

RENOVATION OF HEARTLAND BANK DUBLIN
 600 FRANTZ ROAD
 DUBLIN, OH 43017
 FOR
HEARTLAND BANK


MOODY-NOLAN
 300 SPRUCE STREET
 SUITE 300
 COLUMBUS, OHIO 43215
 PHONE: (614) 461-4664
 FAX: (614) 280-8881

CIVIL SITE PLAN

11/30/2020
 DRAWN BY: MSL CHECKED BY: MSL
 20022


C100
 FINAL DEVELOPMENT PLAN

WEST BRIDGE STREET

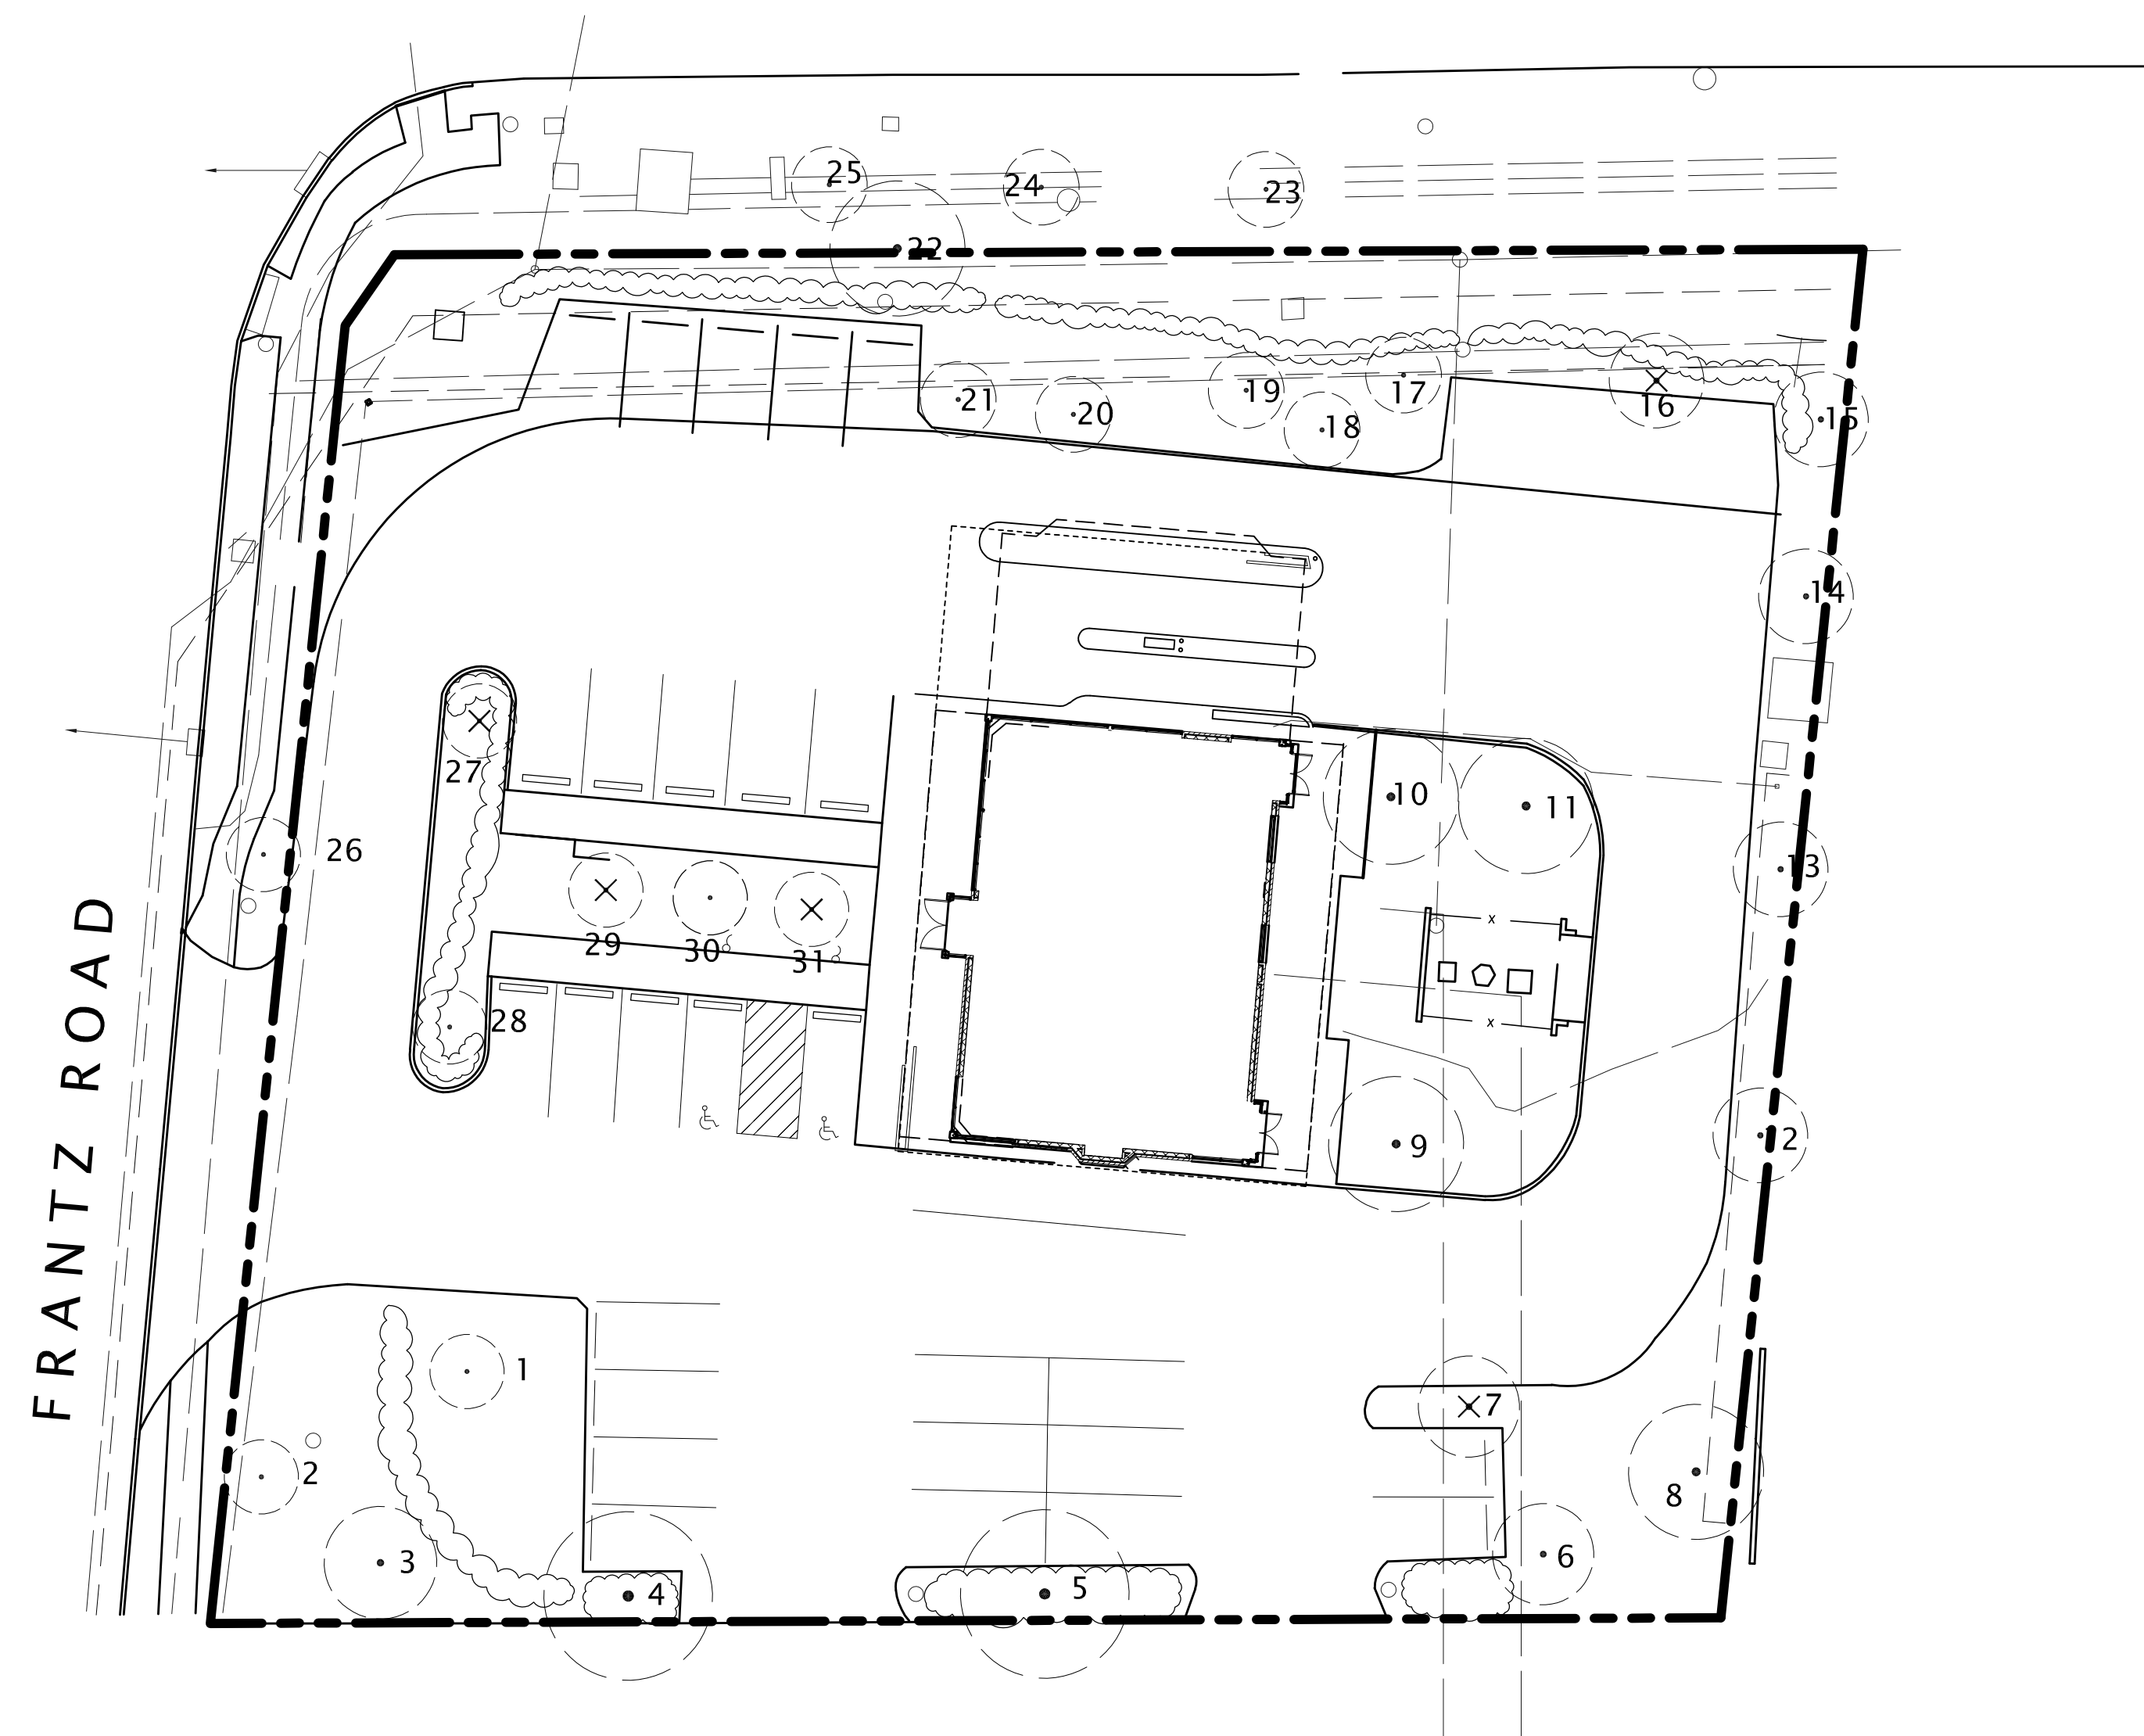


EXISTING TREE LEGEND

NO.	TREE TYPE	SIZE	CONDITION	
1	GINKGO	2" CALIPER	GOOD	RETAIN
2	CRABAPPLE	3" CALIPER	GOOD	RETAIN
3	ZELCOVA	4" CALIPER	GOOD	RETAIN
4	ZELCOVA	6" CALIPER	GOOD	RETAIN
5	ZELCOVA	6" CALIPER	GOOD	RETAIN
6	ZELCOVA	3" CALIPER	GOOD	RETAIN
7	OAK	3" CALIPER	POOR	REPLACE
8	MAPLE	20" CALIPER	GOOD	RETAIN
9	HONEYLOCUS	15" CALIPER	GOOD	RETAIN
10	HONEYLOCUS	17" CALIPER	GOOD	RETAIN
11	HONEYLOCUS	15" CALIPER	GOOD	RETAIN
12	PEAR	6" CALIPER	GOOD	RETAIN
13	PEAR	6" CALIPER	GOOD	RETAIN
14	PEAR	6" CALIPER	GOOD	RETAIN
15	PEAR	6" CALIPER	GOOD	RETAIN
16	ZELCOVA	4" CALIPER	POOR	REPLACE
17	ZELCOVA	3" CALIPER	GOOD	RETAIN
18	GINKGO	1" CALIPER	GOOD	RETAIN
19	ZELCOVA	11" CALIPER	GOOD	RETAIN
20	GINKGO	2" CALIPER	GOOD	RETAIN
21	GINKGO	2" CALIPER	GOOD	RETAIN
22	OAK	24" CALIPER	GOOD	RETAIN
23	LILAC	4" CALIPER	GOOD	RETAIN
24	LILAC	5" CALIPER	GOOD	RETAIN
25	LILAC	8" CALIPER	GOOD	RETAIN
26	LILAC	3" CALIPER	GOOD	RETAIN
27	MAPLE	5" CALIPER	POOR	REPLACE
28	LINDEN	5" CALIPER	GOOD	RETAIN
29	MAGNOLIA	5" CALIPER	GOOD	REMOVE
30	MAGNOLIA	5" CALIPER	GOOD	REMOVE
31	MAGNOLIA	5" CALIPER	GOOD	REMOVE

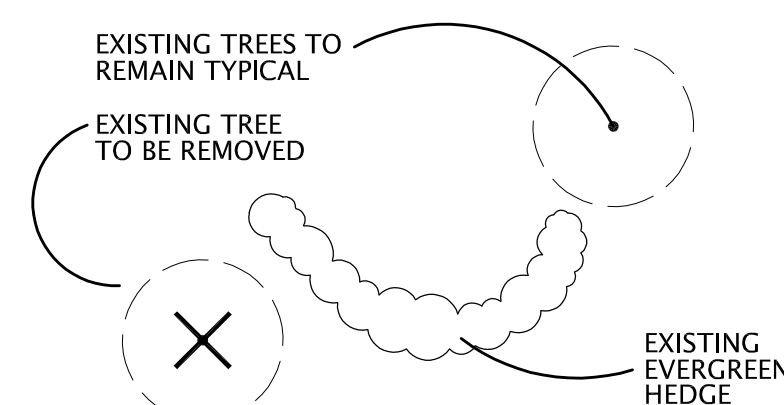

TREE LEGEND


1 TREE DEMOLITION AND PRESERVATION PLAN

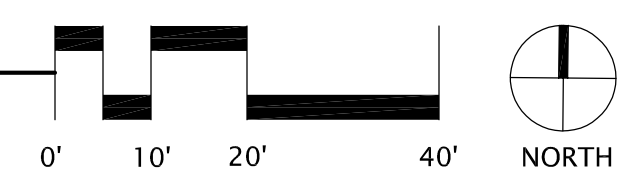

#	DATE	CHANGE DESCRIPTION

RENOVATION OF HEARTLAND BANK DUBLIN
 6500 FRANTZ ROAD
 DUBLIN, OH 43017
 FOR
HEARTLAND BANK


MOODY-NOLAN 300 SPRUCE STREET
 SUITE 300
 COLUMBUS, OHIO 43215
 PHONE: (614) 461-4664
 FAX: (614) 280-8881

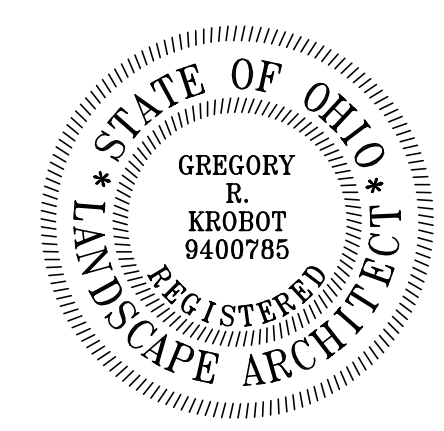

GrKLA
 LANDSCAPE ARCHITECTURE
 231 BUTTLES AVENUE
 COLUMBUS, OHIO 43215
 614.464.3463
 GREGORY.KROBOT@GMAIL.COM

DRAWING TITLE: **TREE DEMOLITION AND PRESERVATION PLAN**


PROGRESS DRAWING NOT FOR CONSTRUCTION	11/30/2020
	DRAWN BY: GJK CHECKED BY: GJK
	2022
L1.01	
FINAL DEVELOPMENT PLAN	

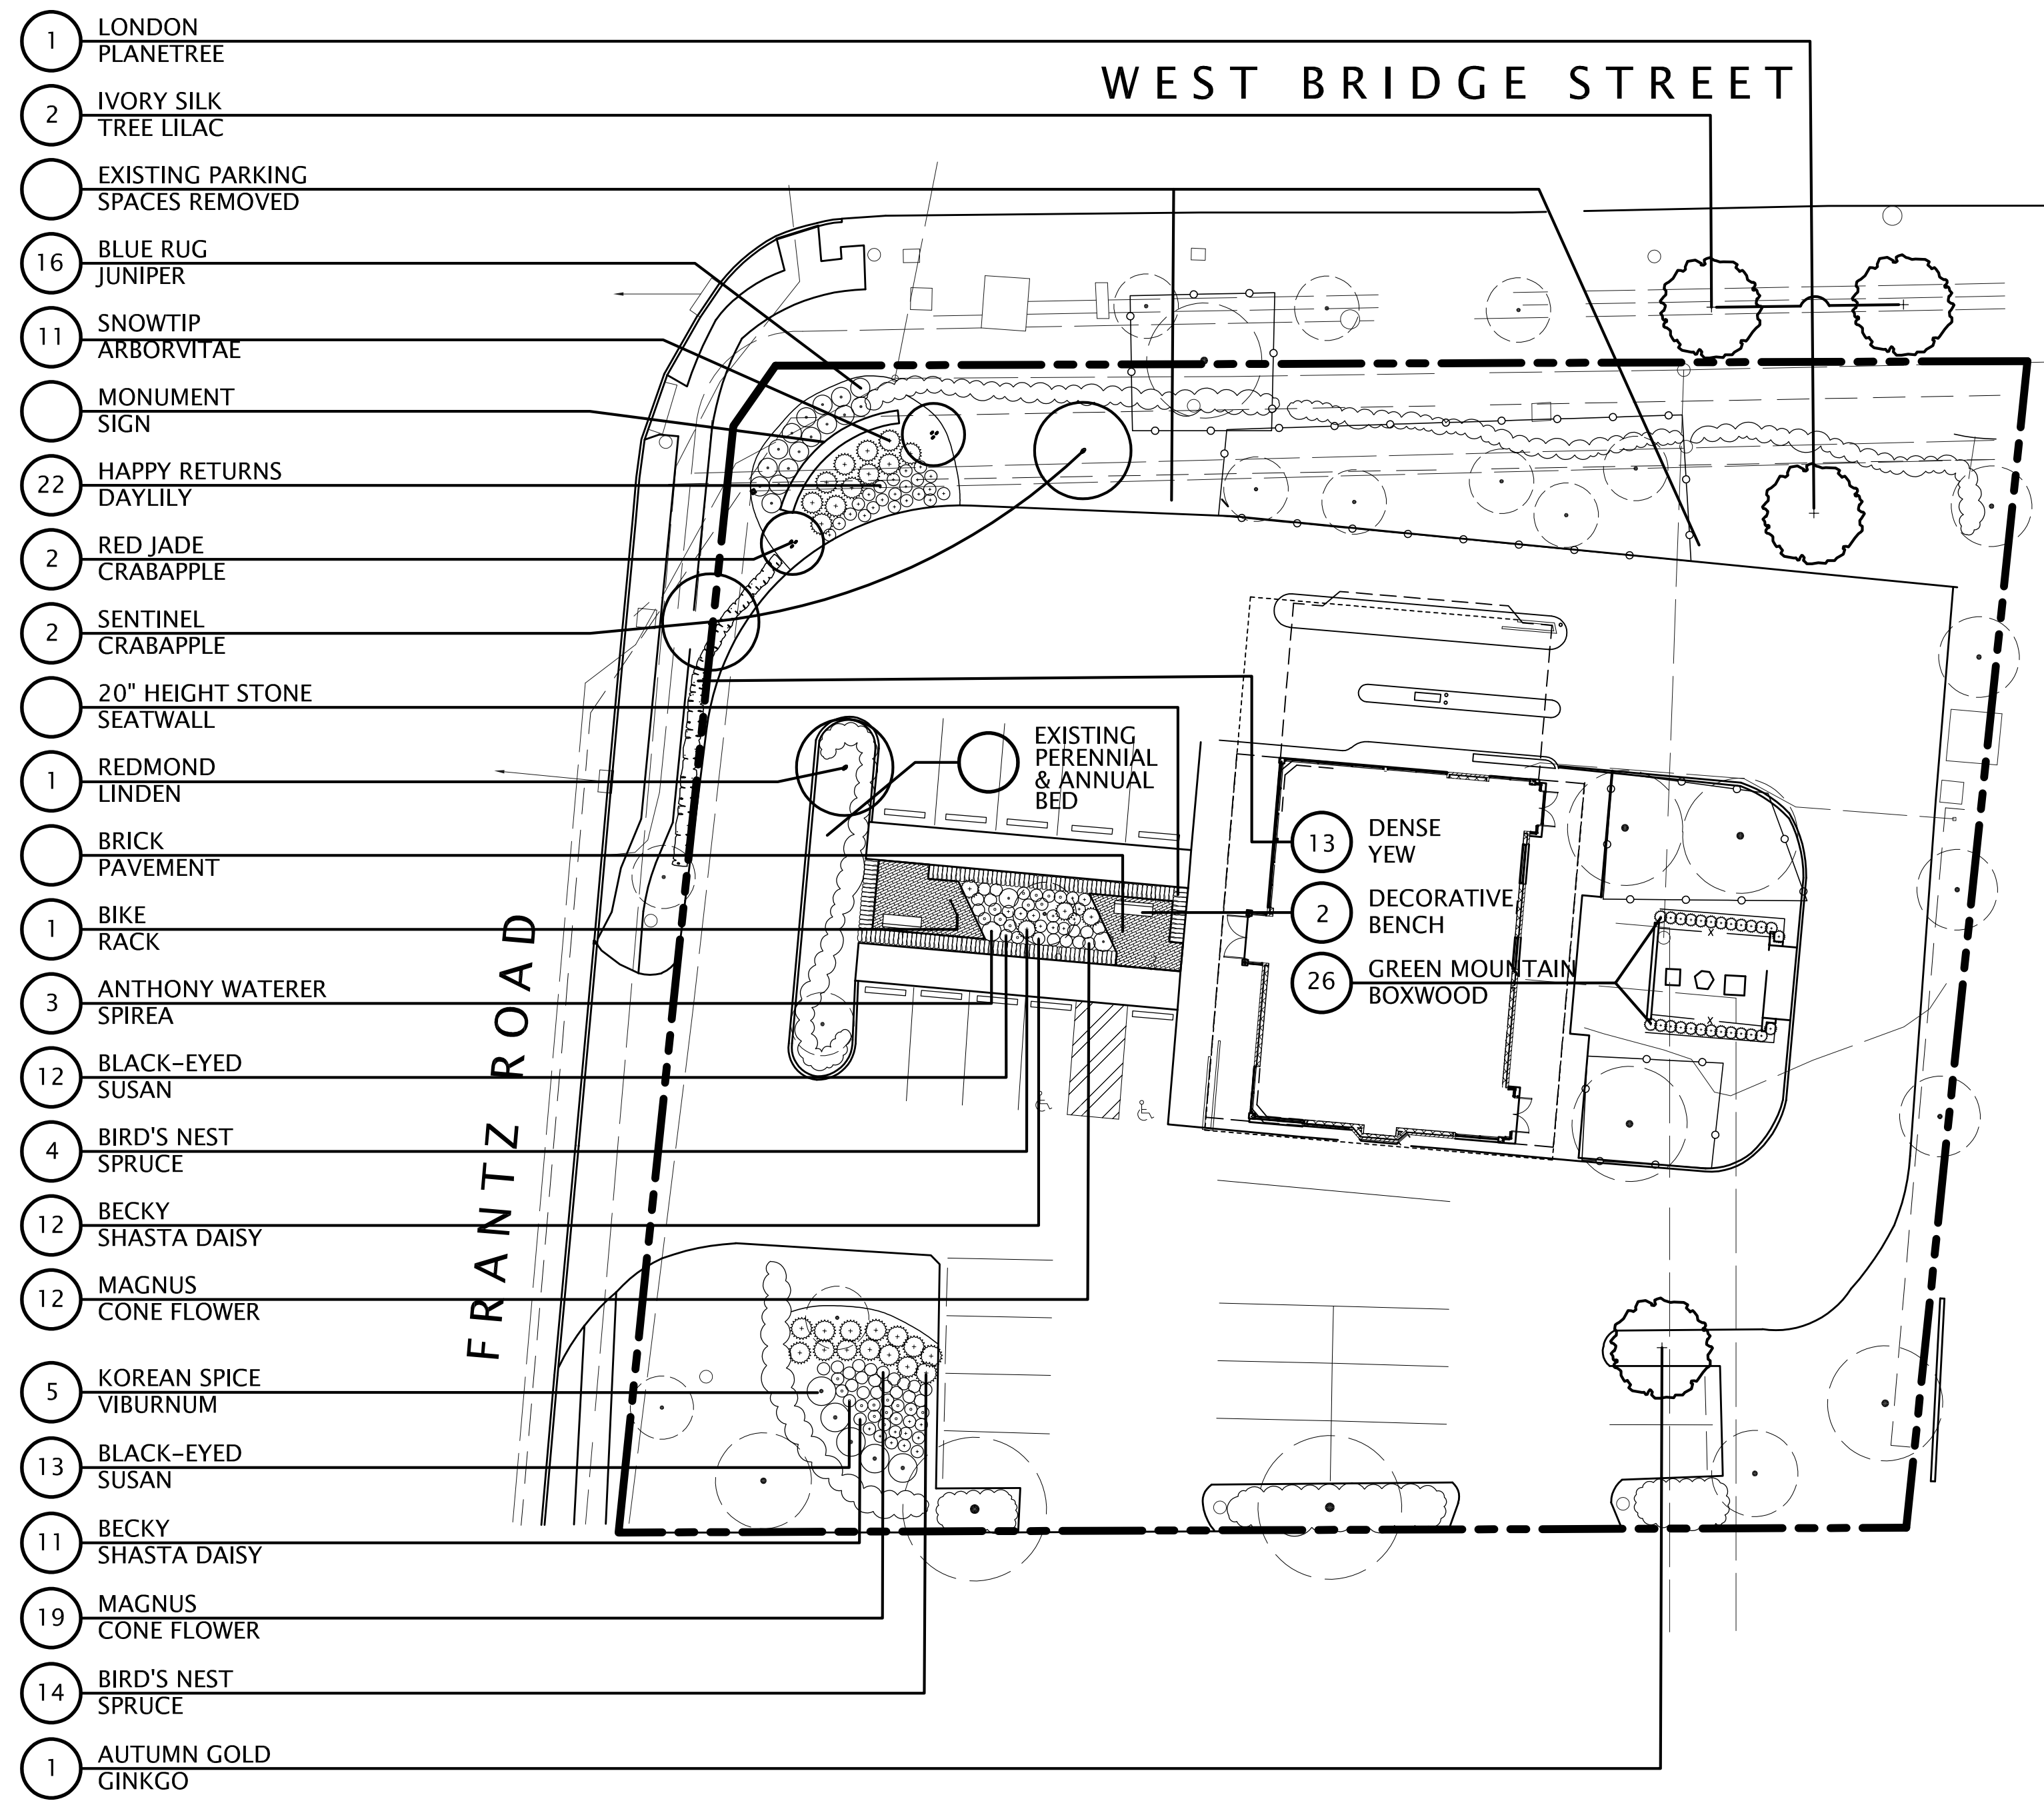

- 1 LONDON PLANETREE
- 2 IVORY SILK TREE LILAC
- EXISTING PARKING SPACES REMOVED
- 16 BLUE RUG JUNIPER
- 11 SNOWTIP ARBORVITAE
- MONUMENT SIGN
- 22 HAPPY RETURNS DAYLILY
- 2 RED JADE CRABAPPLE
- 2 SENTINEL CRABAPPLE
- 20" HEIGHT STONE SEATWALL
- 1 REDMOND LINDEN
- BRICK PAVEMENT
- 1 BIKE RACK
- 3 ANTHONY WATERER SPIREA
- 12 BLACK-EYED SUSAN
- 4 BIRD'S NEST SPRUCE
- 12 BECKY SHASTA DAISY
- 12 MAGNUS CONE FLOWER
- 5 KOREAN SPICE VIBURNUM
- 13 BLACK-EYED SUSAN
- 11 BECKY SHASTA DAISY
- 19 MAGNUS CONE FLOWER
- 14 BIRD'S NEST SPRUCE
- 1 AUTUMN GOLD GINKGO


PLANT MATERIALS LIST

QTY.	COMMON NAME	BOTANICAL NAME	SIZE	ROOT
TREES				
5	SKYLINE HONEYLOCUST	Geditsia t. i. 'Skyline'	2 1/2" Cal.	B&B
3	SOMERSET MAPLE	Acer rubrum 'Somerset'	2 1/2" Cal.	B&B
1	REDMOND LINDEN	Tilia americana 'Redmond'	2 1/2" Cal.	B&B
1	LONDON PLANETREE	Platanus x acerifolia	2 1/2" Cal.	B&B
2	IVORY SILK TREE LILAC	Syringa reticulata 'Ivory Silk'	2" Cal.	B&B
2	RED JADE CRABAPPLE	Malus 'Red Jade'	1 3/4" Cal.	B&B
2	SENTINEL CRABAPPLE	Malus 'Sentinel'	1 3/4" Cal.	B&B
1	AUTUMN GOLD GINKGO	Ginkgo 'Autumn Gold'	2 1/2" Cal.	B&B
SHRUBS				
11	SNOWTIP ARBORVITAE	Thuja occidentalis 'Snowtip'	5' Hgt.	B&B
13	DENSE YEW	Taxus x media 'Densiformis'	24" Hgt.	B&B
16	BLUE RUG JUNIPER	Juniperus horizontalis 'Blue Rug'	18" Spr.	Cont.
18	BIRD'S NEST SPRUCE	Picea abies 'Nidiformis'	15" Spr.	Cont.
5	KOREAN SPICE VIBURNUM	Viburnum carlesii	24" Hgt.	Cont.
3	ANTHONY WATERER SPIREA	Spiraea 'Anthony Waterer'	24" Spr.	Cont.
23	BECKY SHASTA DAISY	Leucanthemum x superbum 'Becky'	Clump	#2 Cont.
25	BLACK-EYED SUSAN	Rudbeckia fulgida 'Goldsturm'	Clump	#2 Cont.
31	MAGNUS CONE FLOWER	Echinacea 'Magnus'	Clump	#2 Cont.
22	HAPPY RETURNS DAYLILY	Hemerocallis 'Happy Returns'	Clump	#2 Cont.
26	GREEN MOUNTAIN BOXWOOD	Buxus x 'Green Mountain'	24" Hgt.	

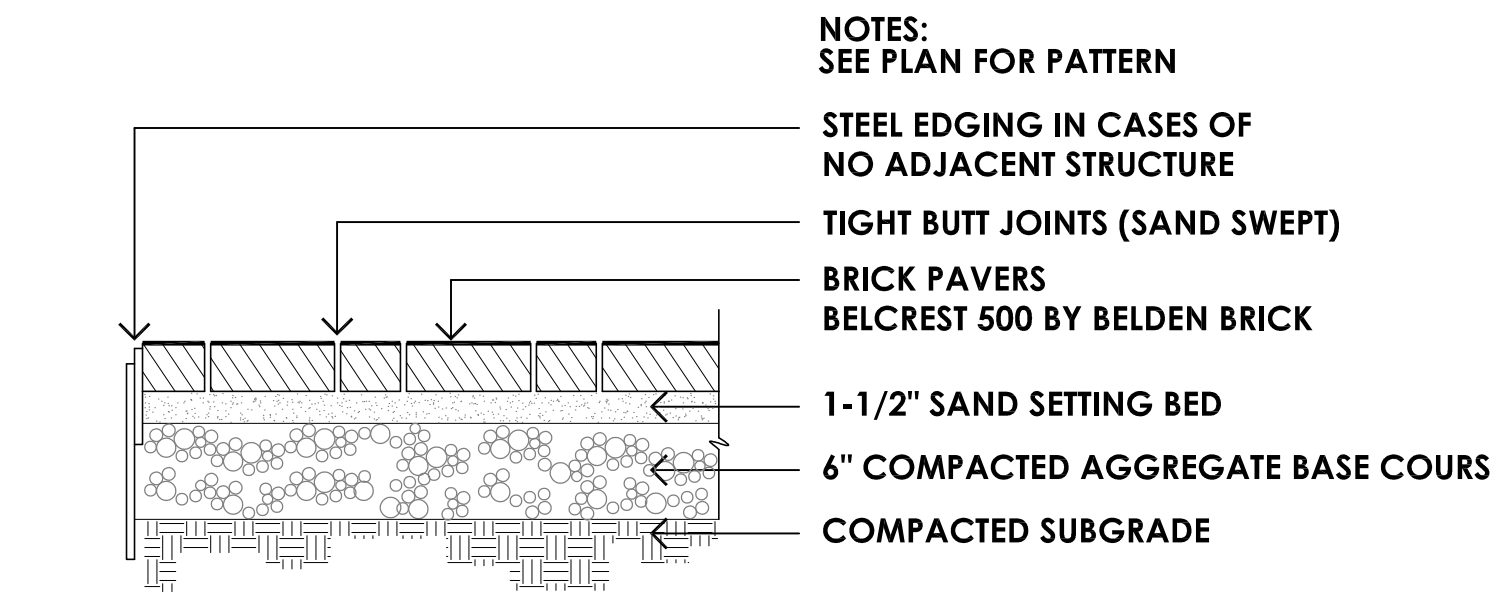


5 DRY LAID BRICK PAVEMENT
NTS

1 SITE LANDSCAPE PLAN
0' 10' 20' 40' NORTH

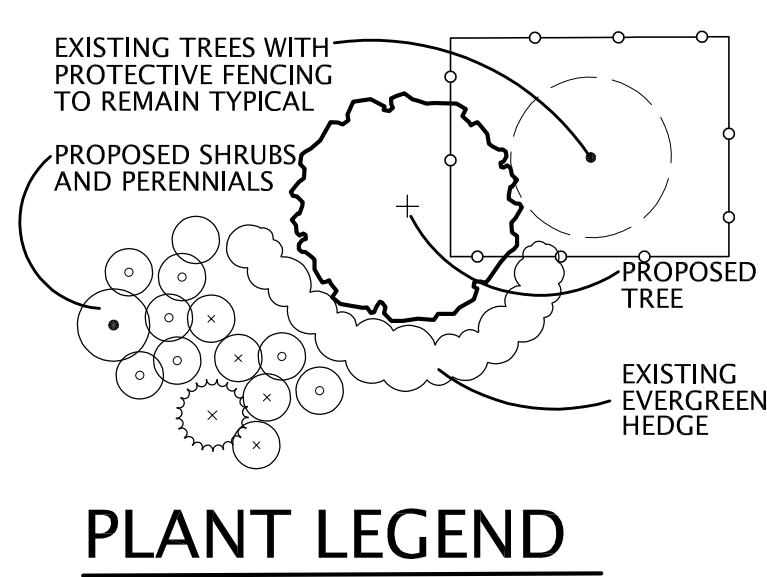


PLANT LEGEND

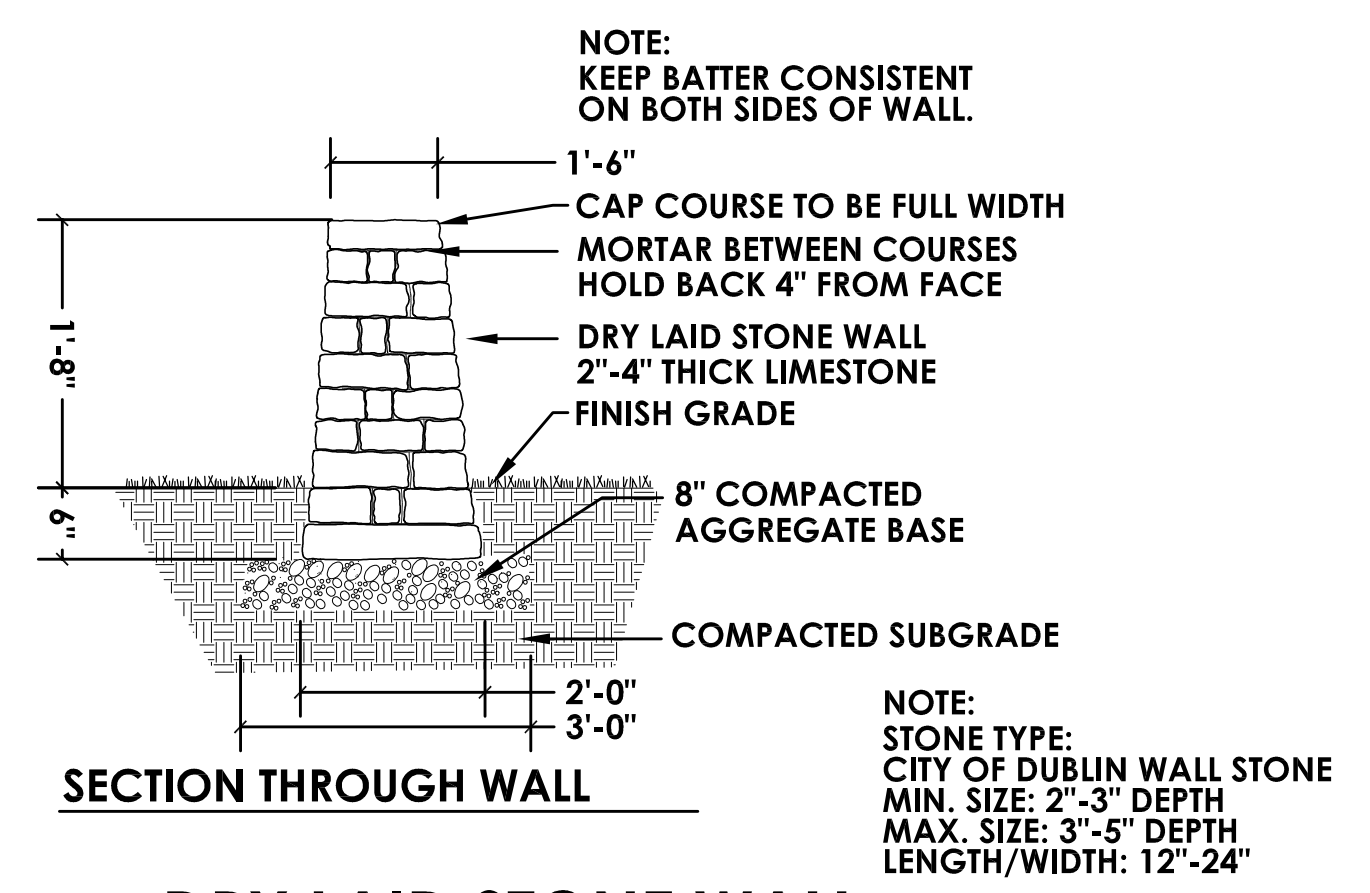


2 DRY LAID STONE WALL
NTS



3 6' SCARBOROUGH BENCH
BY LANDSCAPE FORMS

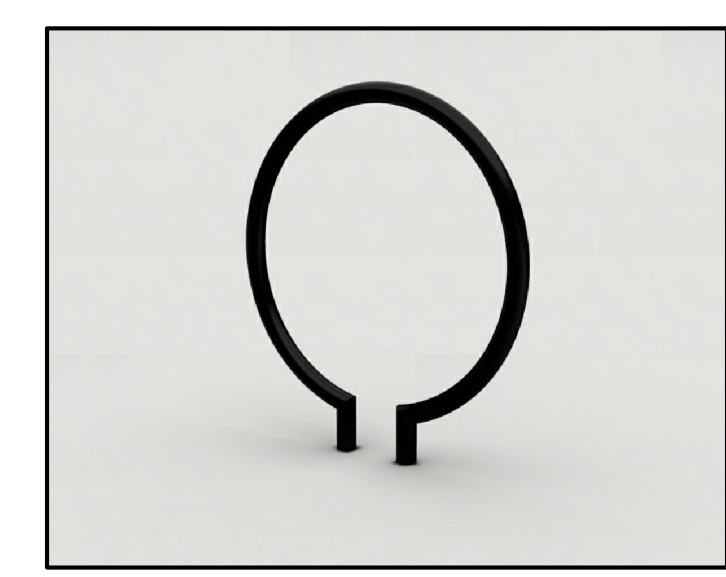

4 RING BIKE RACK
BY LANDSCAPE FORMS

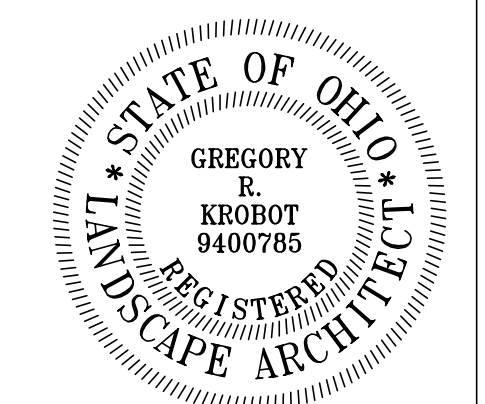

#	DATE	CHANGE DESCRIPTION


RENOVATION OF HEARTLAND BANK DUBLIN
5505 FRANTZ ROAD
DUBLIN, OH 43077
FOR
HEARTLAND BANK

300 SPRUCE STREET
SUITE 300
COLUMBUS, OHIO 43215
PHONE: (614) 461-4664
FAX: (614) 280-8881

SITE LANDSCAPE PLAN


11/30/2020
DRAWN BY: GJK | CHECKED BY: GJK
20022
L1.02
FINAL DEVELOPMENT PLAN

PROGRESS DRAWING NOT FOR CONSTRUCTION

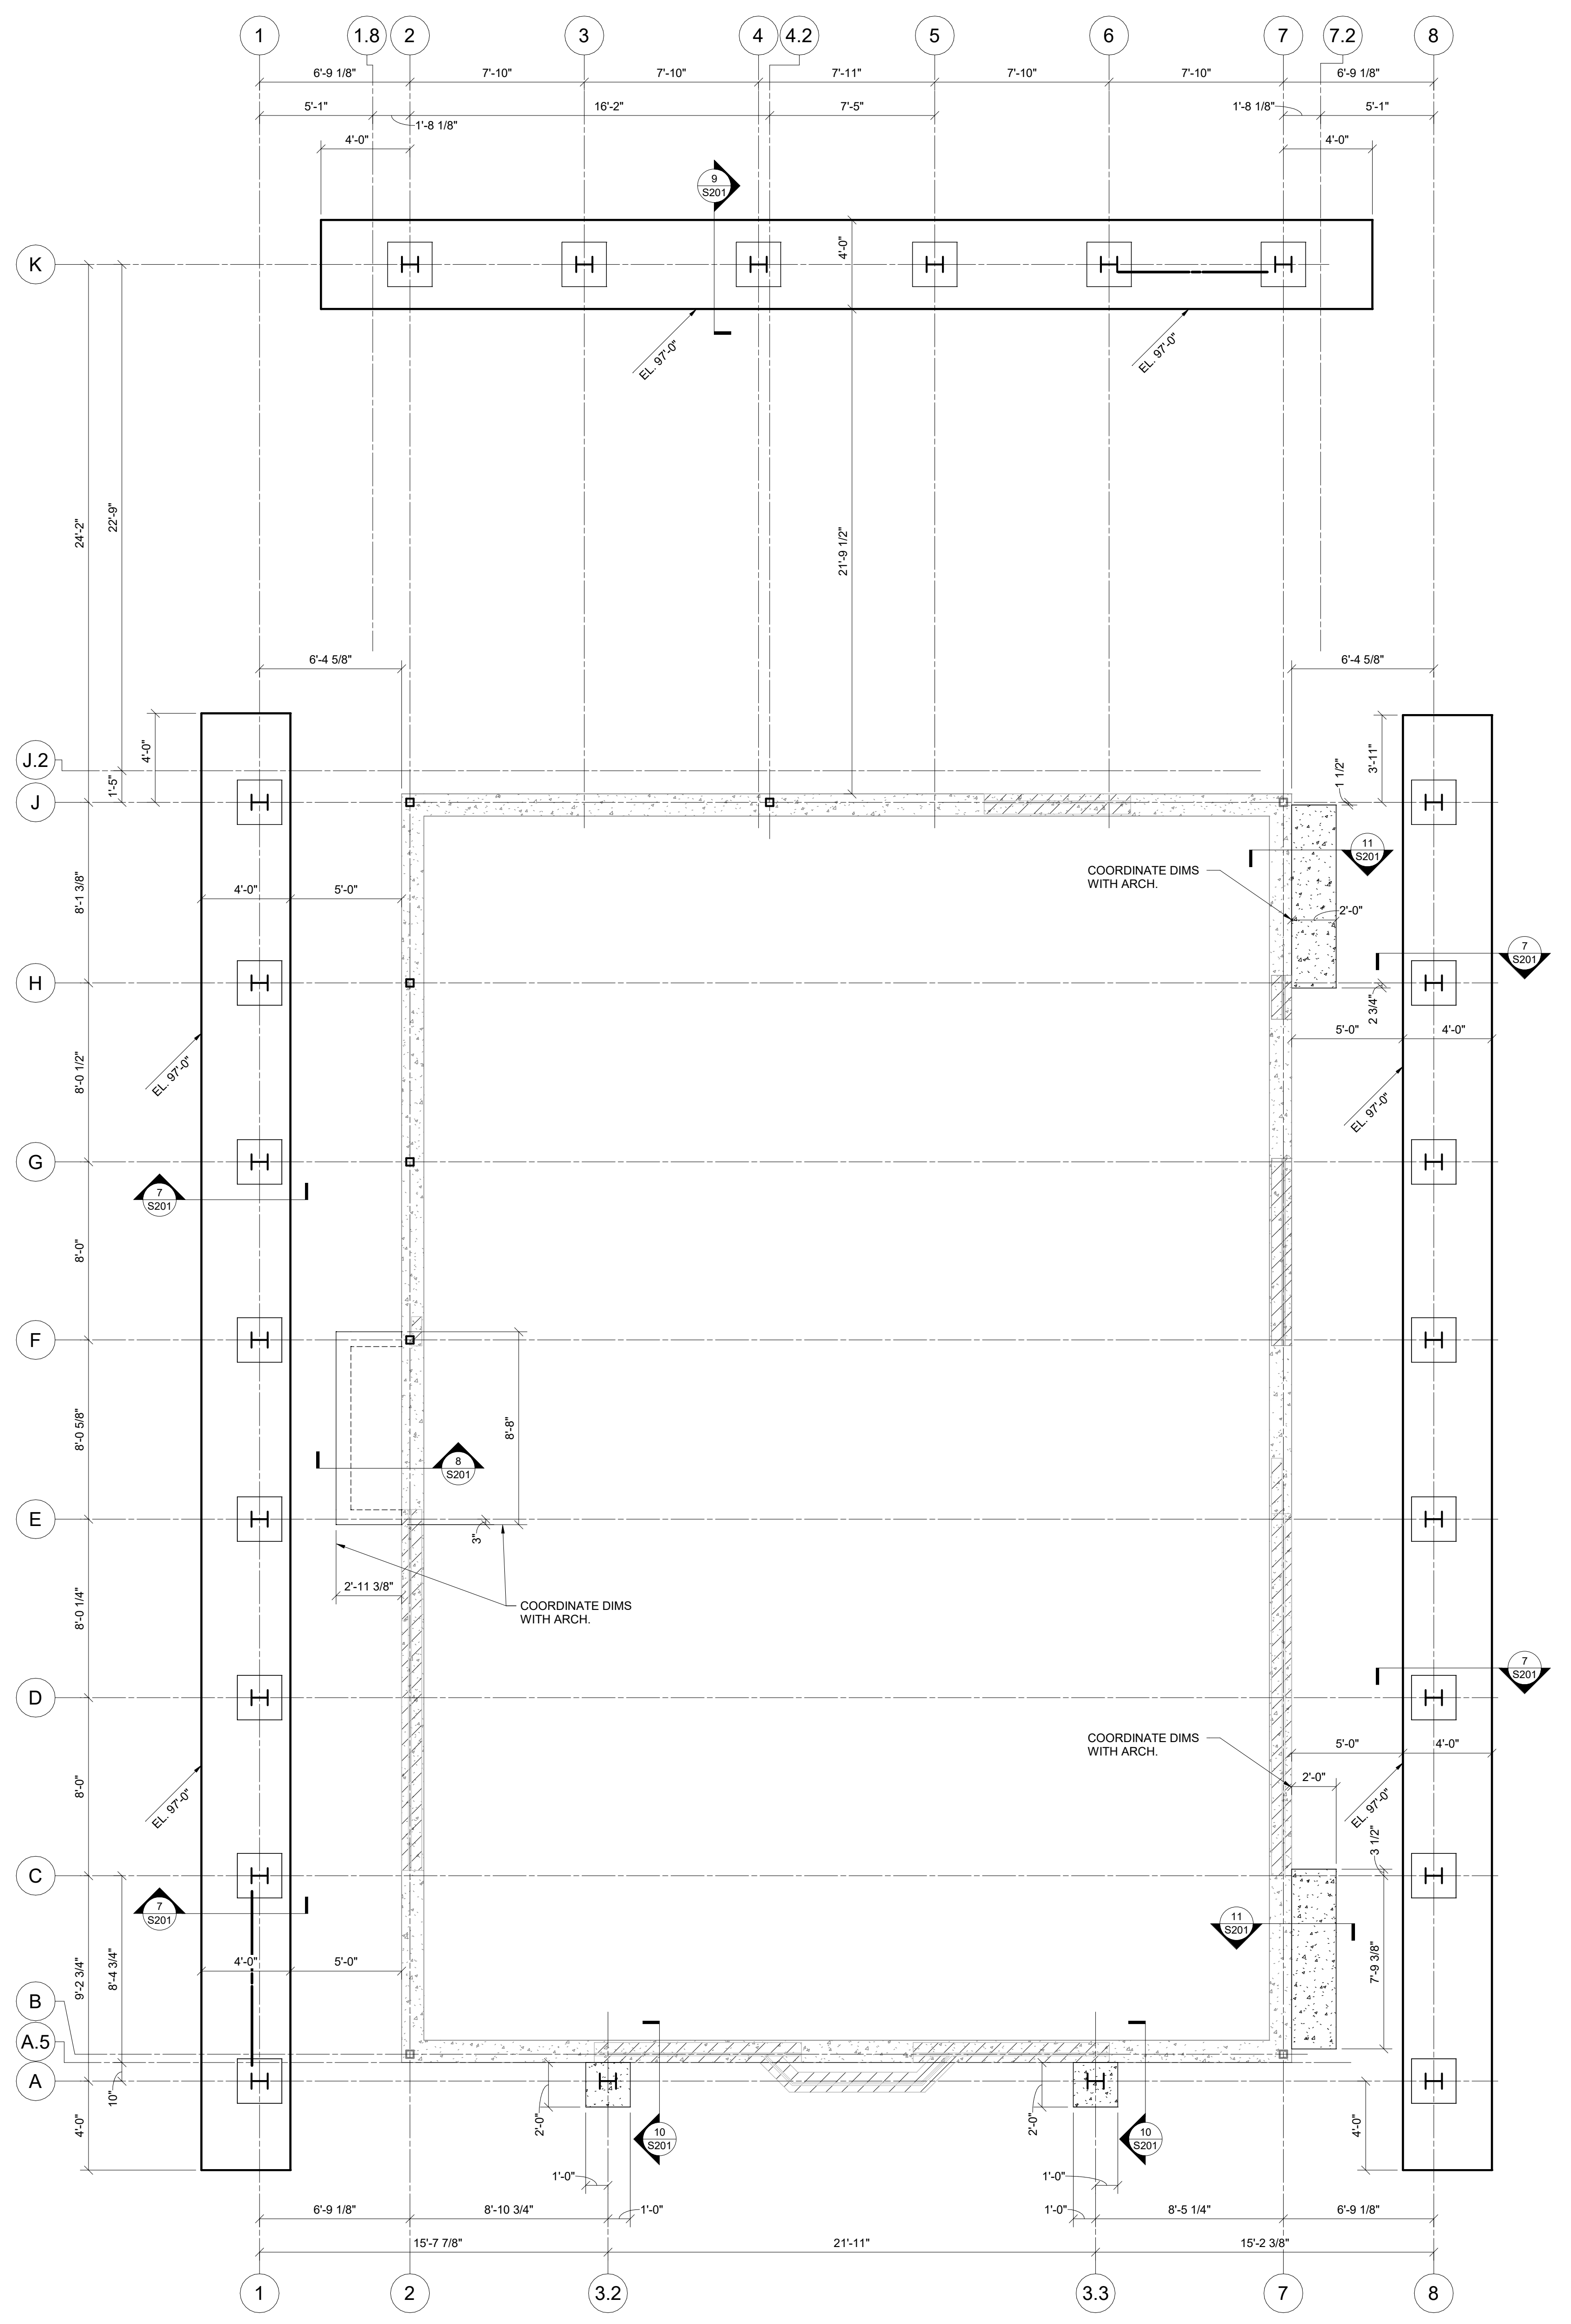

FOUNDATION/FIRST FLOOR FRAMING PLAN


1/4" = 1'-0"

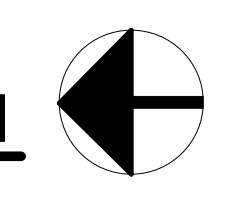

- FOUNDATION NOTES**
- DESIGN SOIL BEARING PRESSURE = 3,000 PSF. SEE S001 FOR REFERENCE SOILS REPORT INFORMATION. REFERENCE THIS REPORT FOR ANY REQUIRED SITE BUILDING PREPARATION PRIOR TO FOUNDATION AND/OR SLAB ON GROUND CONSTRUCTION. FOOTING LOCATIONS MAY BE REQUIRED TO EXTEND THROUGH EXISTING FILL, RESULTING IN THEM TO BEAR ON SUITABLE MATERIAL. OVER-ELEVATIONS ARE TO BE FILLED WITH LEAN CONCRETE UP TO THE PLANNED BOTTOM OF FOOTING ELEVATION. PLACE NO CONCRETE PRIOR TO INSPECTION AND APPROVAL OF BEARING SURFACES BY SOILS ENGINEER.
 - KEEP FOUNDATIONS FREE OF WATER AT ALL TIMES. REPLACE WEAKENED SOIL WITH LEAN CONCRETE OR FLOWABLE FILL.
 - BOTTOM OF FOOTINGS ARE TO BE AT LEAST 36 INCHES BELOW THE ADJACENT EXTERIOR FINISHED GRADE FOR Frost Protection.
 - ELEVATIONS SHOWN ON FOOTINGS INDICATE ELEVATION AT TOP OF FOOTING. REFERENCE ELEVATION TOP OF CONCRETE SLAB ELEVATION AS NOTED ON PLANS. COORDINATE ABSOLUTE ELEVATION OF TOP OF SLAB WITH SITE DRAWINGS.
 - PROVIDE CORNER BARS AT ALL FOOTING AND CONCRETE WALL INTERSECTIONS PER DETAIL S1021
 - SEE SECTION 41021 FOR TYPICAL INDOOR AND OUTDOOR MECHANICAL EQUIPMENT PADS.
 - EXISTING BUILDING STRUCTURE SHOWN IS BASED ON LIMITED FIELD INVESTIGATION. EXISTING CONDITIONS, DIMENSIONS, ELEVATIONS, ETC. ARE TO BE VERIFIED PRIOR TO CONSTRUCTION OR FABRICATION OF ANY MATERIAL BY CONTRACTOR PERFORMING WORK IN EXISTING AREAS. REPORT ANY DISCREPANCIES TO ARCHITECT IMMEDIATELY. DO NOT REMOVE EXISTING LOAD-BEARING WALLS, COLUMNS, OR ANY SUB-STRUCTURE WITHOUT THE PRIOR APPROVAL OF THE ARCHITECT. WHERE NEW STRUCTURE IS TO BE INSTALLED, PROVIDE SHORING AND BRACING AS REQUIRED TO PROPERLY SUPPORT THE REMAINING STRUCTURE UNTIL THE NEW STRUCTURE IS IN PLACE AND PROPERLY BRACED.
 - SEE SHEET S001 FOR GENERAL STRUCTURAL INFORMATION.

#	DATE	CHANGE DESCRIPTION


RENOVATION OF HEARTLAND BANK DUBLIN
 5303 FRANTZ ROAD,
 DUBLIN, OH 43017
 FOR
HEARTLAND BANK

 300 SPRUCE STREET
 SUITE 300
 COLUMBUS, OHIO 43215
 PHONE: (614) 461-4664
 FAX: (614) 280-8881

DRAWING TITLE:

1ST FLOOR FRAMING PLAN

PROGRESS DRAWING NOT FOR CONSTRUCTION	11/30/2020	
	DRAWN BY: Author	CHECKED BY: Checker
	2022	
	S101	
FINAL DEVELOPMENT PLAN		

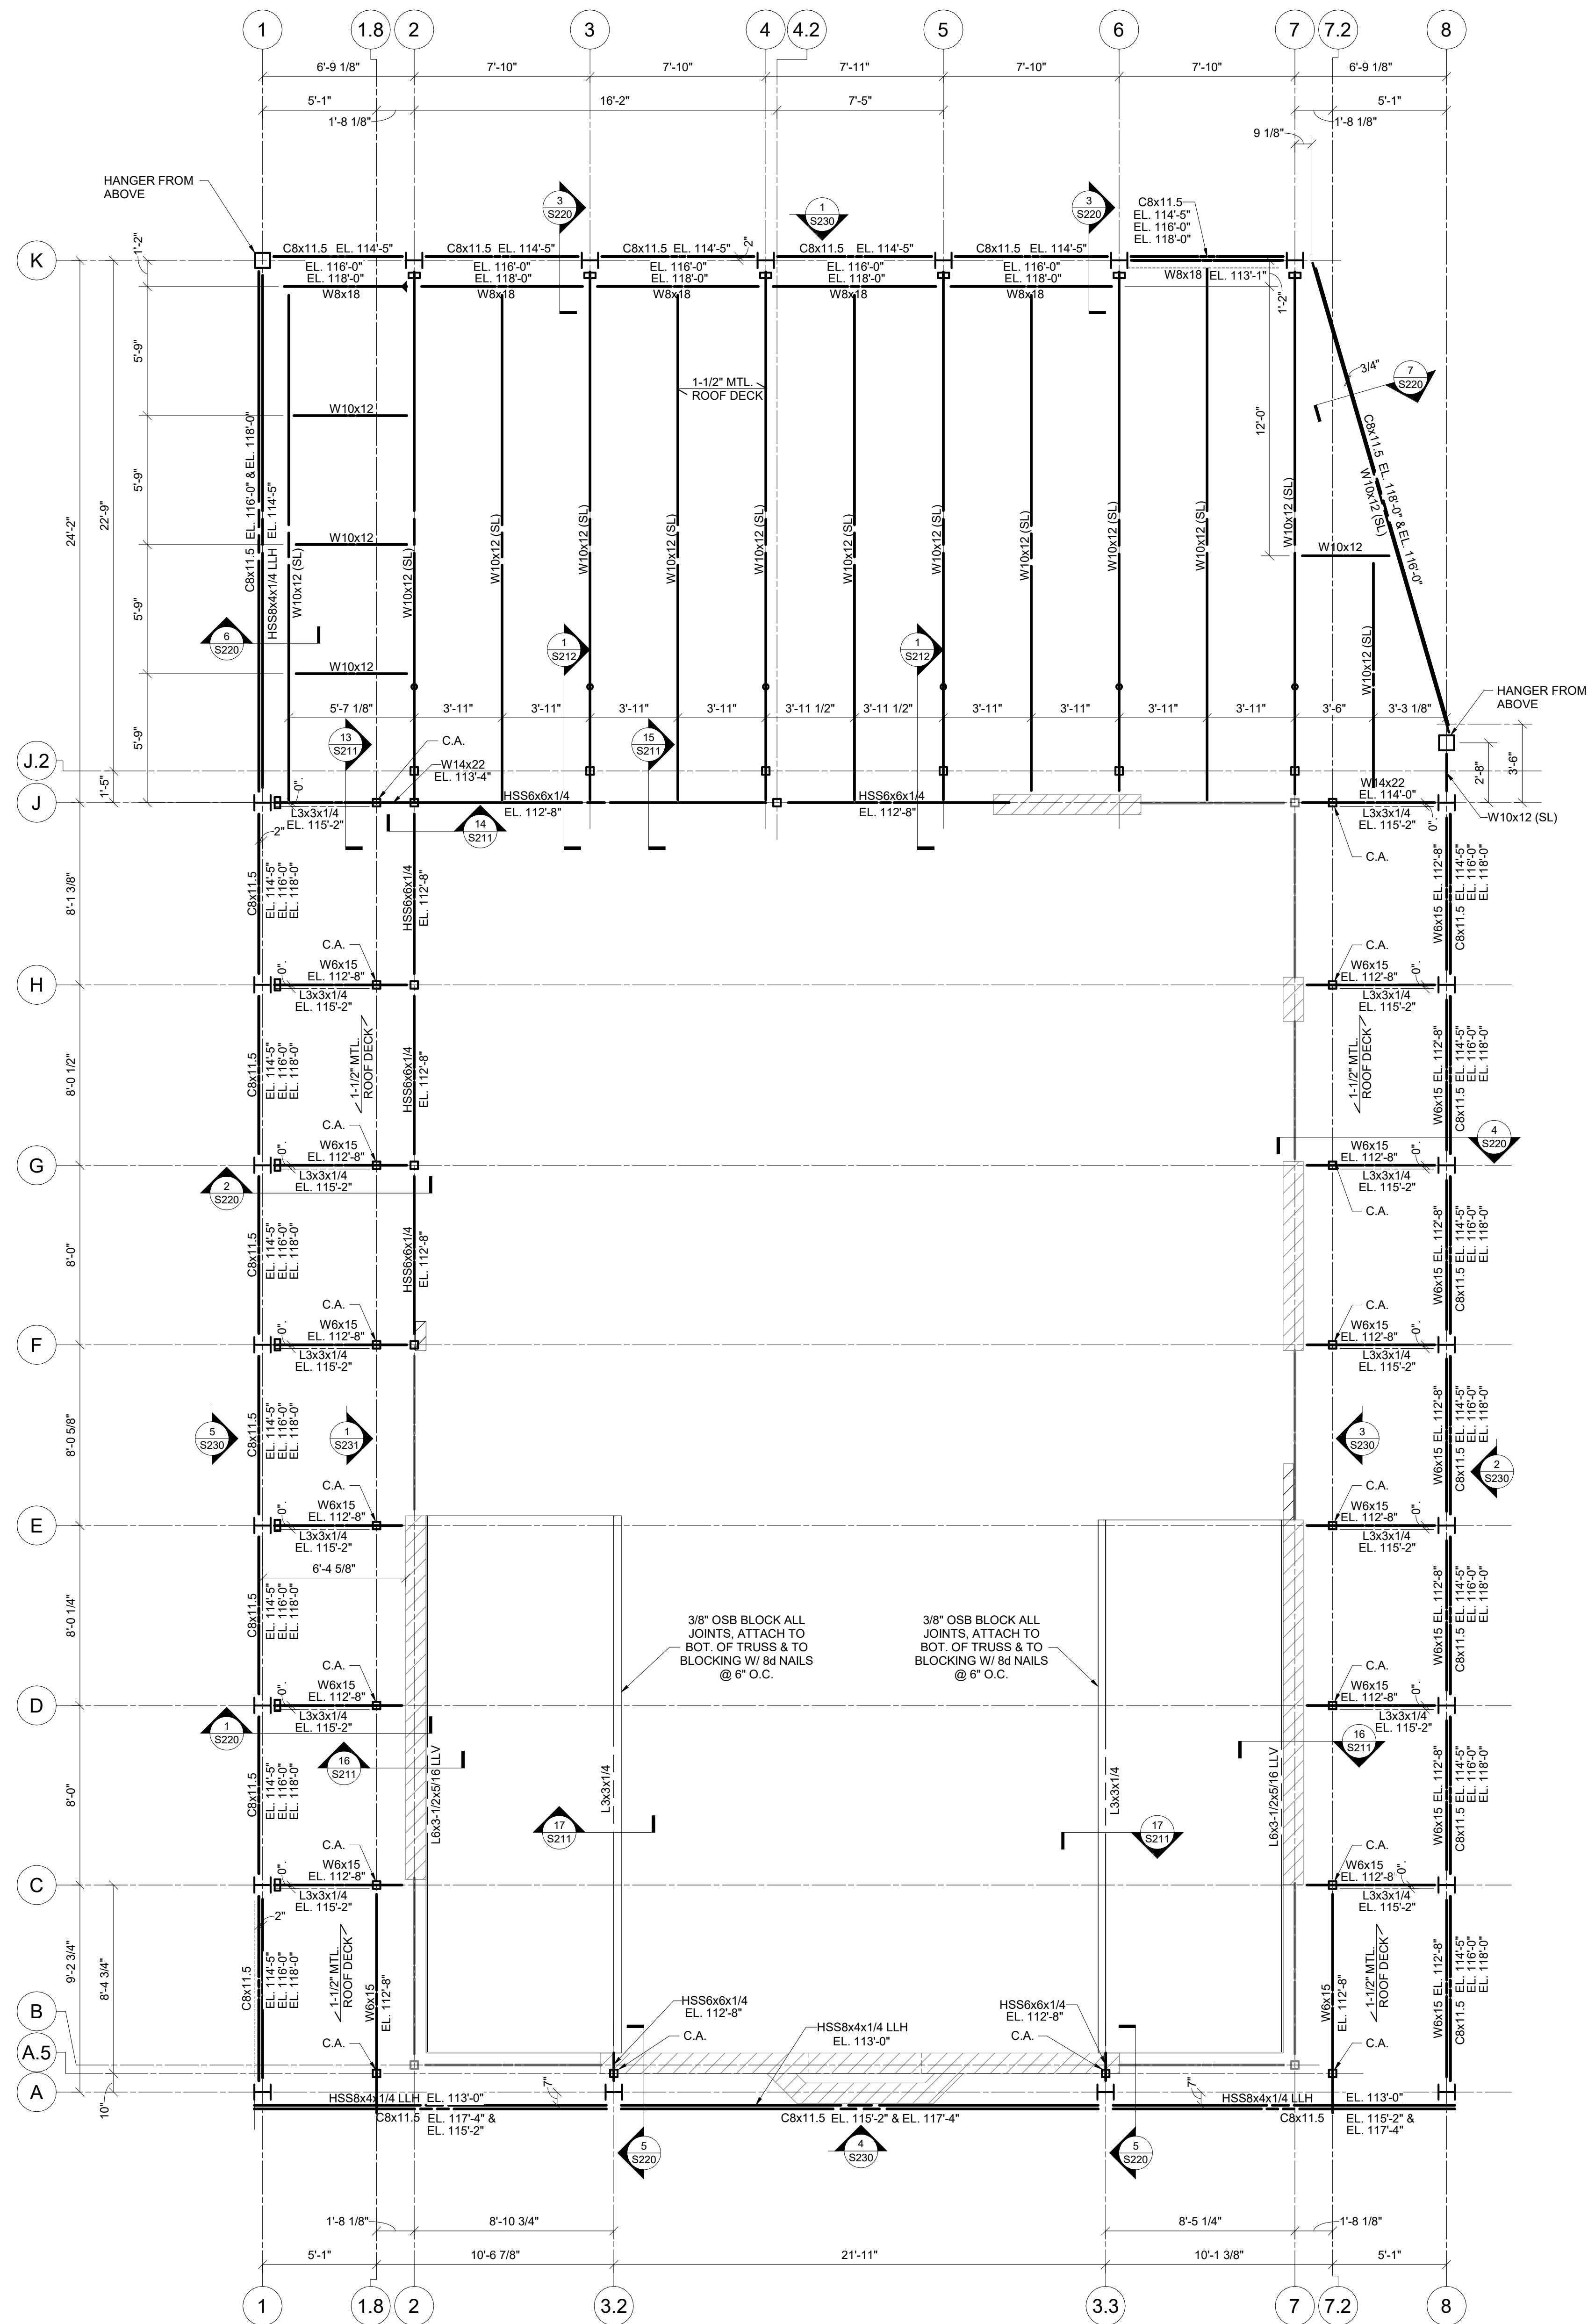


ROOF FRAMING PLAN

1/4" = 1'-0"

ROOF FRAMING NOTES

- DESIGN LIVE LOADS:
 - FLAT ROOF LIVE: 20 PSF
 - SLOPED ROOF LIVE: 16 PSF
 - FLAT ROOF SNOW: 20 PSF - DRIFT
 - SLOPED ROOF SNOW: 15 PSF
 - WIND (ASD NET UPLIFT): 15 PSF
 - COLLATERAL: 5 PSF
- ROOF CONSTRUCTION:
 - 1/2" x 16 GA WIDE RIB METAL DECK. SEE SECTION 3/510 FOR TYPICAL ATTACHMENT TO SUPPORTING STRUCTURE.
- TOP OF STEEL AS NOTED. REFERENCE ELEVATION 100'-0" TOP OF FIRST FLOOR SLAB ON GRADE.
- INDICATES MOMENT CONNECTION PER SECTIONS 6 & W5210.
- SEE S210 FOR TYPICAL STEEL FRAMING DETAILS.
- SEE ARCHITECTURAL DRAWINGS FOR ANY DIMENSIONS NOT INDICATED HEREIN.
- EXISTING BUILDING STRUCTURE SHOWN IS BASED ON ORIGINAL BUILDING DRAWINGS AND/OR LIMITED FIELD INVESTIGATION. EXISTING CONDITIONS, DIMENSIONS, ELEVATIONS, ETC. ARE TO BE VERIFIED PRIOR TO CONSTRUCTION OR FABRICATION OF ANY MATERIAL BY CONTRACTOR PERFORMING WORK IN EXISTING AREAS. REPORT ANY DISCREPANCIES TO ARCHITECT IMMEDIATELY. DO NOT REMOVE EXISTING LOAD-BEARING WALLS, COLUMNS OR ANY SUCH STRUCTURE WITHOUT THE PRIOR APPROVAL OF THE ARCHITECT. WHERE NEW STRUCTURE IS TO BE INSTALLED, PROVIDE SHORING AND BRACING AS REQUIRED TO PROPERLY SUPPORT THE REMAINING STRUCTURE UNTIL THE NEW STRUCTURE IS IN PLACE AND PROPERLY BRACED.
- SEE SHEET S001 FOR GENERAL STRUCTURAL INFORMATION.

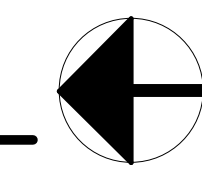

#	DATE	CHANGE DESCRIPTION


RENOVATION OF HEARTLAND BANK DUBLIN
 5303 FRANTZ ROAD,
 DUBLIN, OH 43017
 FOR
HEARTLAND BANK

MOODY-NOLAN
 300 SPRUCE STREET
 SUITE 300
 COLUMBUS, OHIO 43215
 PHONE: (614) 461-4664
 FAX: (614) 280-8881

DRAWING TITLE:

ROOF FRAMING PLAN

PROGRESS DRAWING NOT FOR CONSTRUCTION	11/30/2020
	DRAWN BY: Author CHECKED BY: Checker
	20022
	S102
	FINAL DEVELOPMENT PLAN

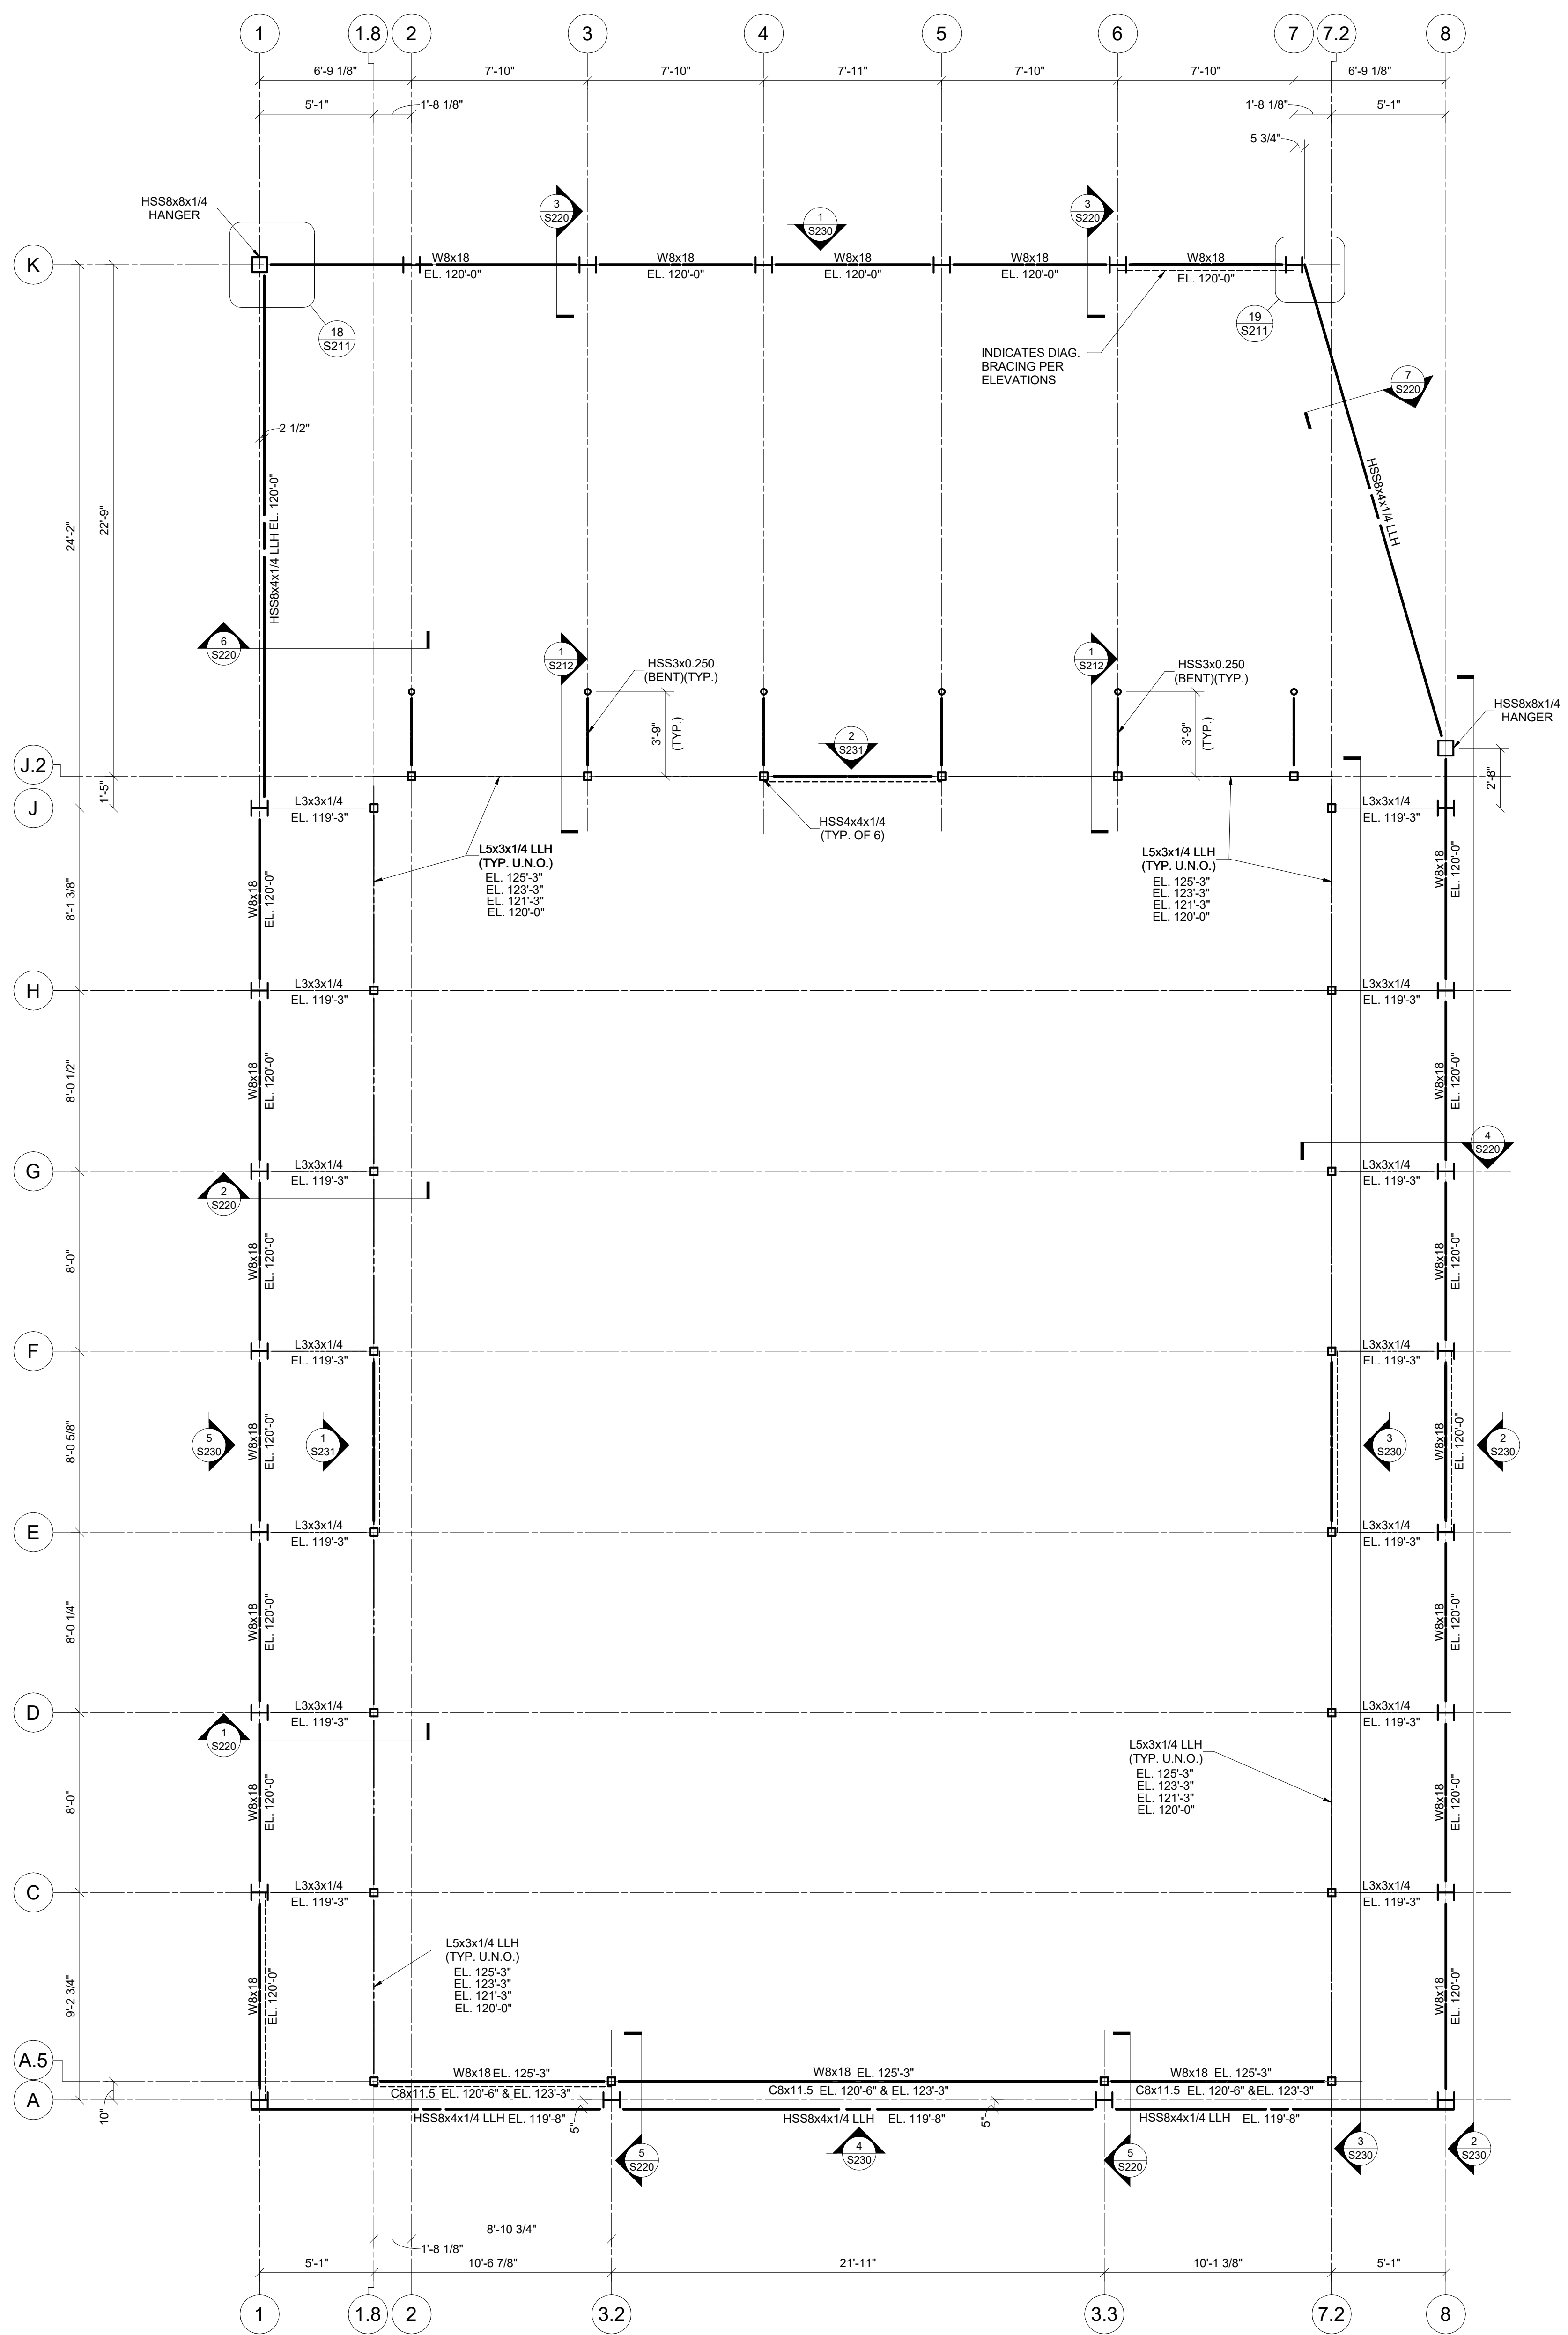

SCREENWALL FRAMING PLAN
1/4" = 1'-0"

#	DATE	CHANGE DESCRIPTION

RENOVATION OF HEARTLAND BANK DUBLIN
5303 FRANTZ ROAD,
DUBLIN OH - 43017
FOR
HEARTLAND BANK


MOODY-NOLAN 300 SPRUCE STREET
SUITE 300
COLUMBUS, OHIO 43215
PHONE: (614) 461-4664
FAX: (614) 280-8881

DRAWING TITLE:
SCREENWALL FRAMING PLAN


PROGRESS DRAWING NOT FOR CONSTRUCTION	11/30/2020
	DRAWN BY: Author CHECKED BY: Checker
	20022

S103

FINAL DEVELOPMENT PLAN

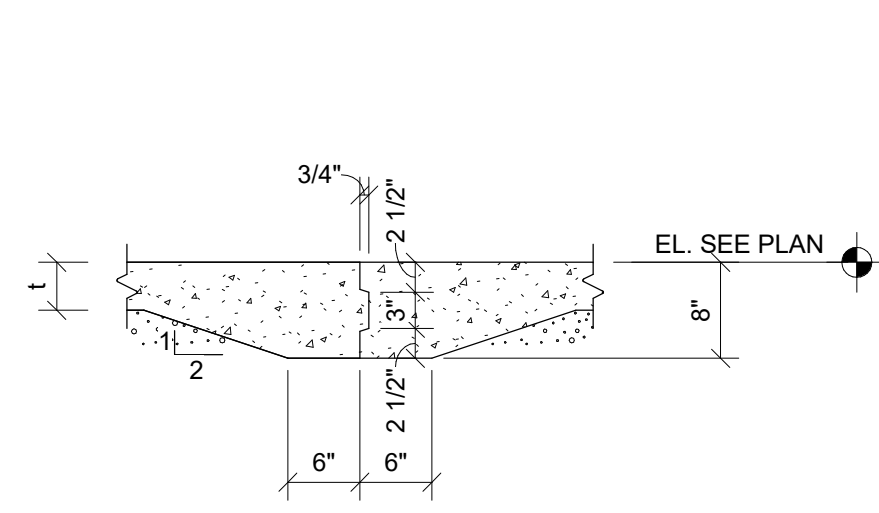


TYPICAL FLOOR CONSTRUCTION JOINT

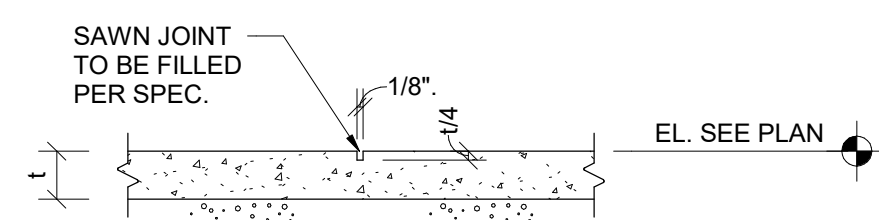

TYPICAL FLOOR CONTROL JOINT


SECTION 1

3/4" = 1'-0"

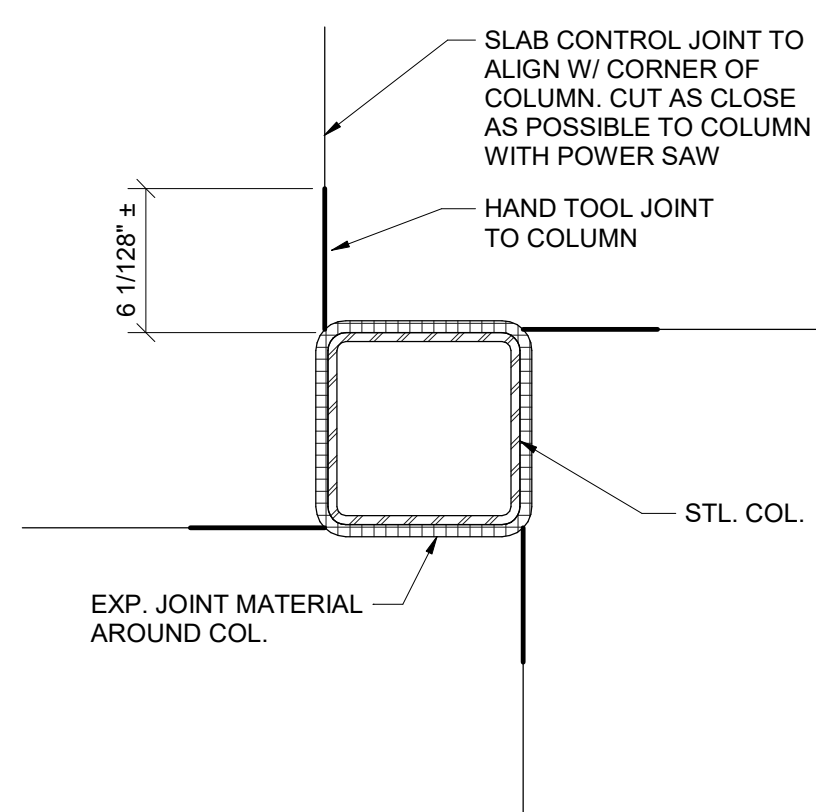

CONTROL JOINTS AT SQUARE COLUMN


SECTION 2

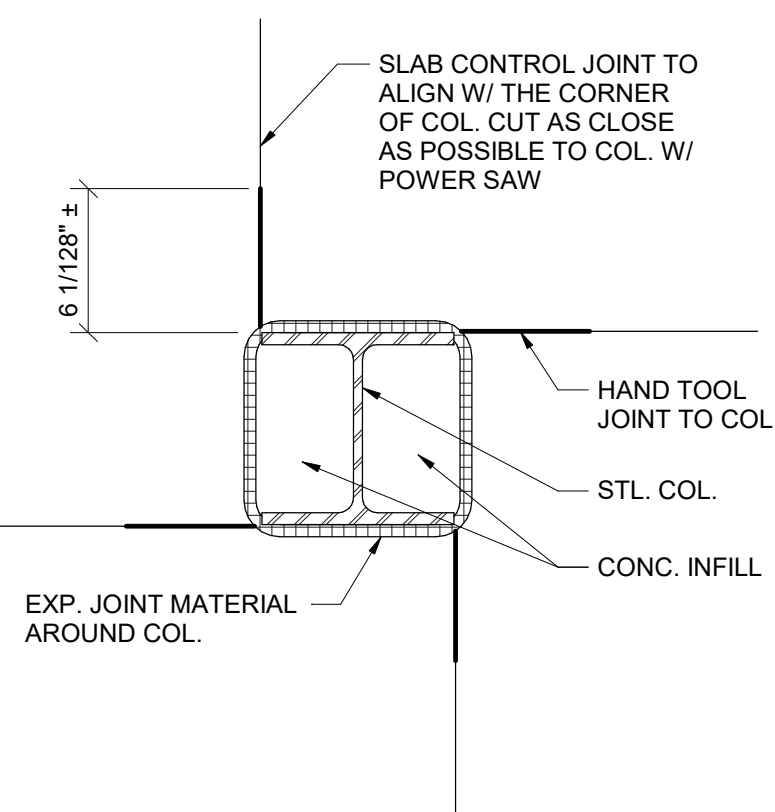

CONTROL JOINTS AT W COLUMN

SECTION 2


1 1/2" = 1'-0"

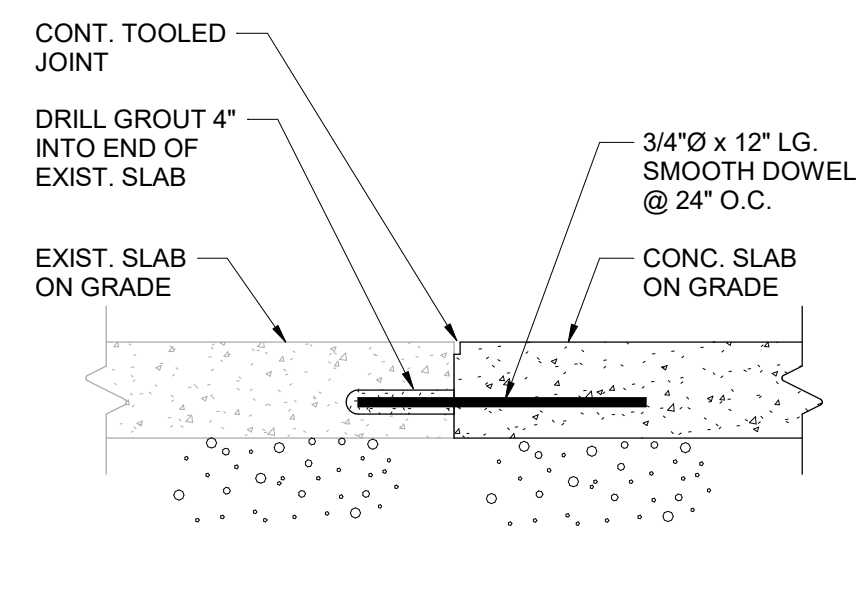

TYPICAL NEW-TO-EXISTING SLAB TRANSITION

SECTION 3

1 1/2" = 1'-0"

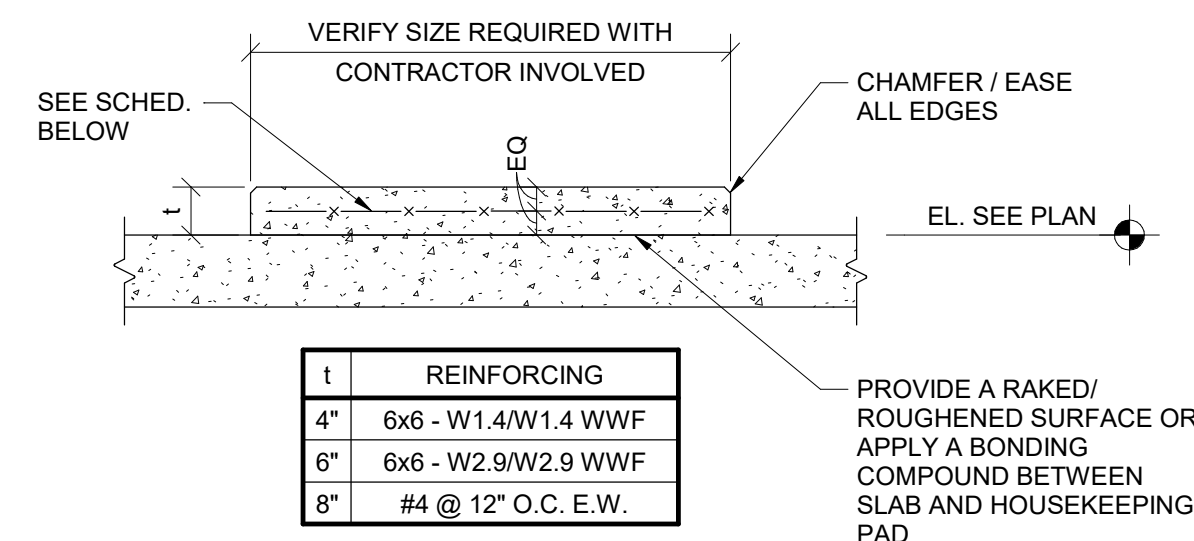


TYPICAL HOUSEKEEPING PADS FOR SLABS ON GRADE & STRUCTURAL DECK

SECTION 4

3/4" = 1'-0"


1	REINFORCING
4"	#6 - W1.4W1.4 WWF
6"	#6 - W2.9W2.9 WWF
8"	#4 @ 12" O.C. E.W.

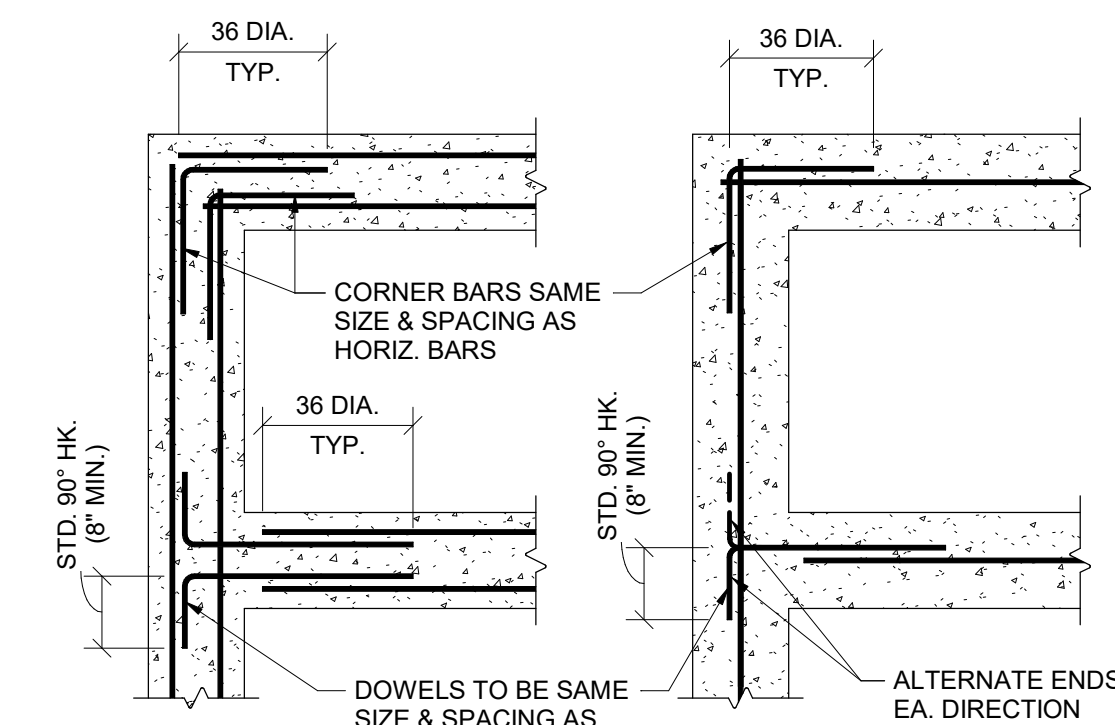

TYPICAL CORNER BARS FOR CONCRETE WALL AND FOOTING CONSTRUCTION

SECTION 5


3/4" = 1'-0"

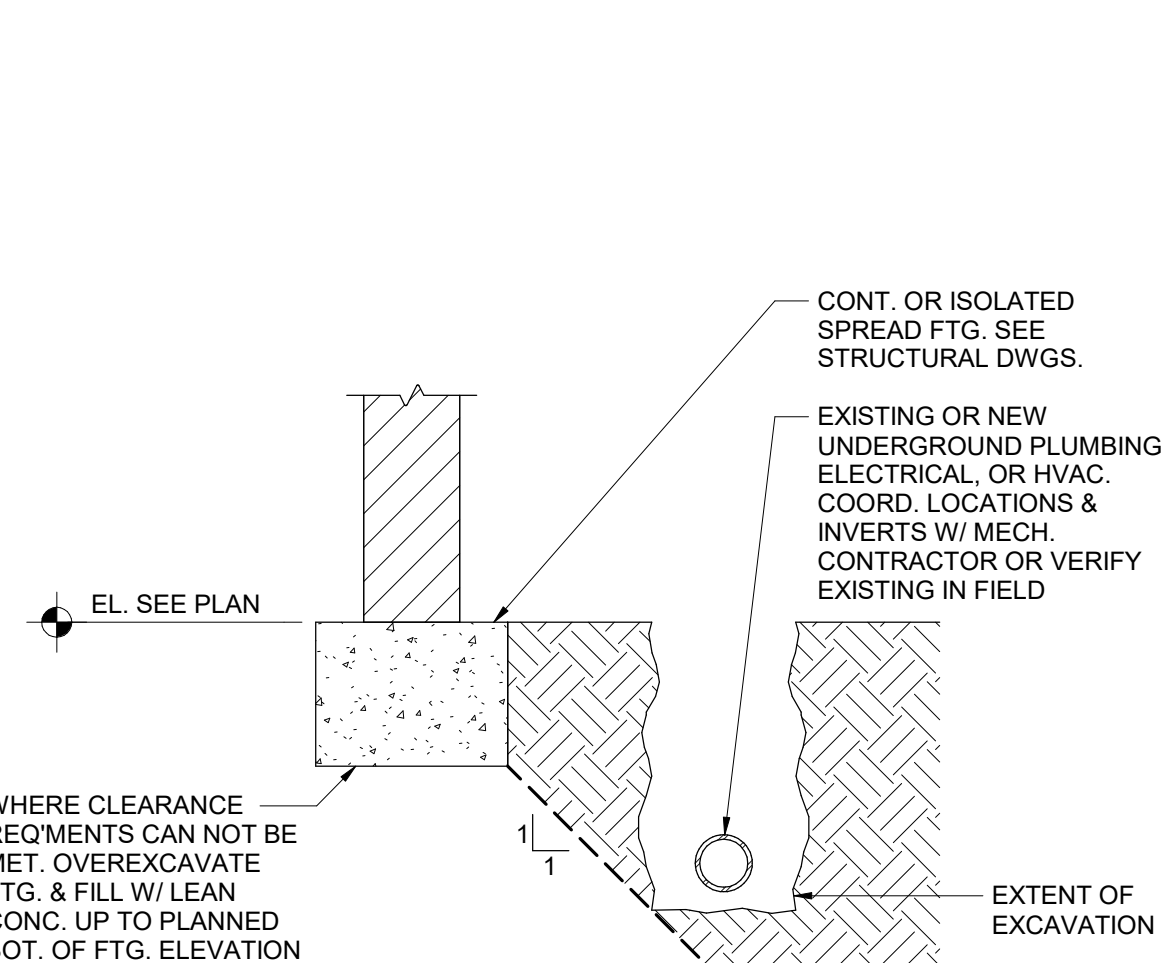

TYPICAL EXCAVATION CLEARANCE REQUIREMENTS


SECTION 6

3/4" = 1'-0"

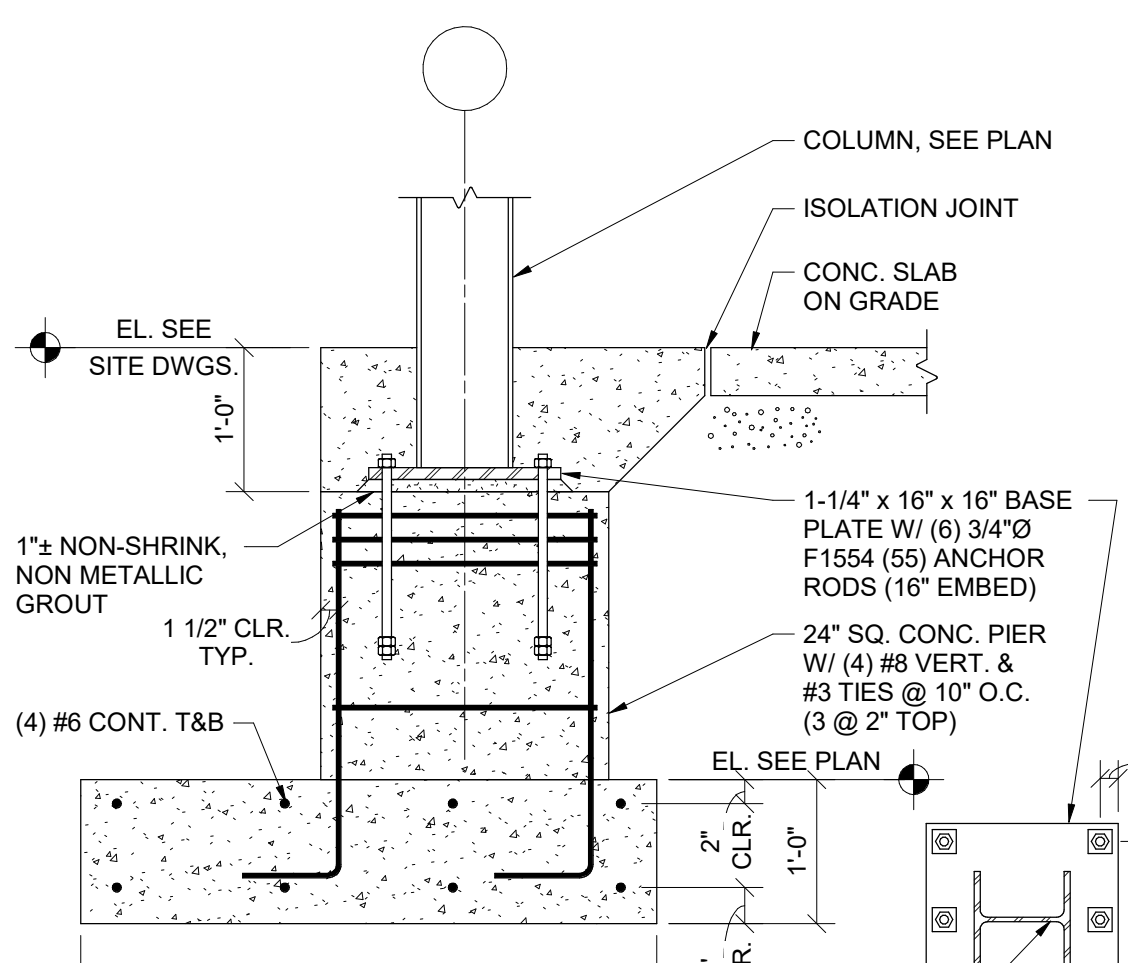


SECTION 7

3/4" = 1'-0"

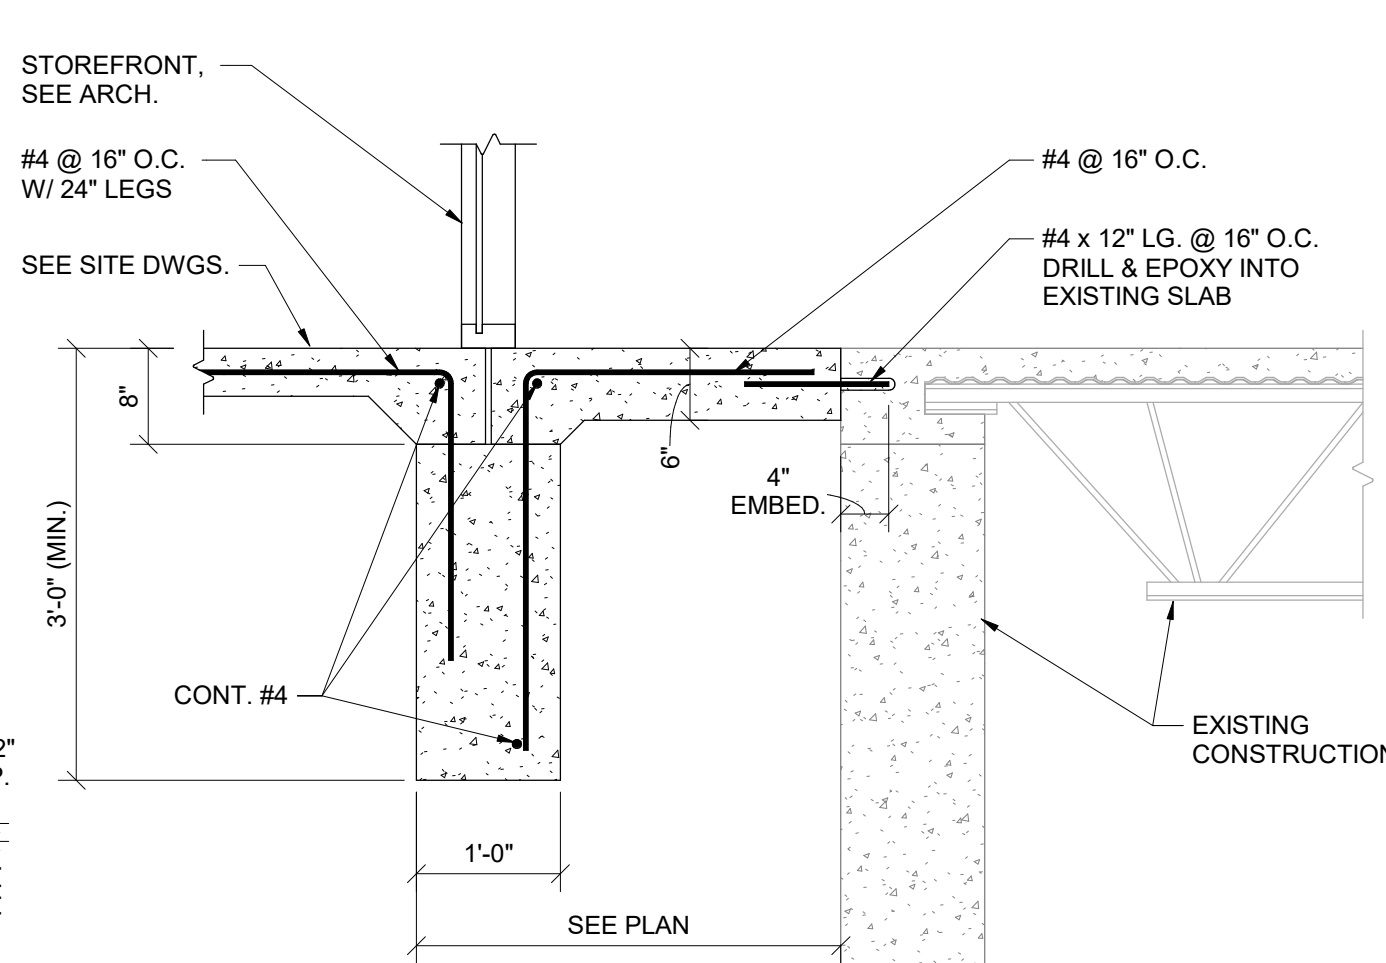


SECTION 8

3/4" = 1'-0"

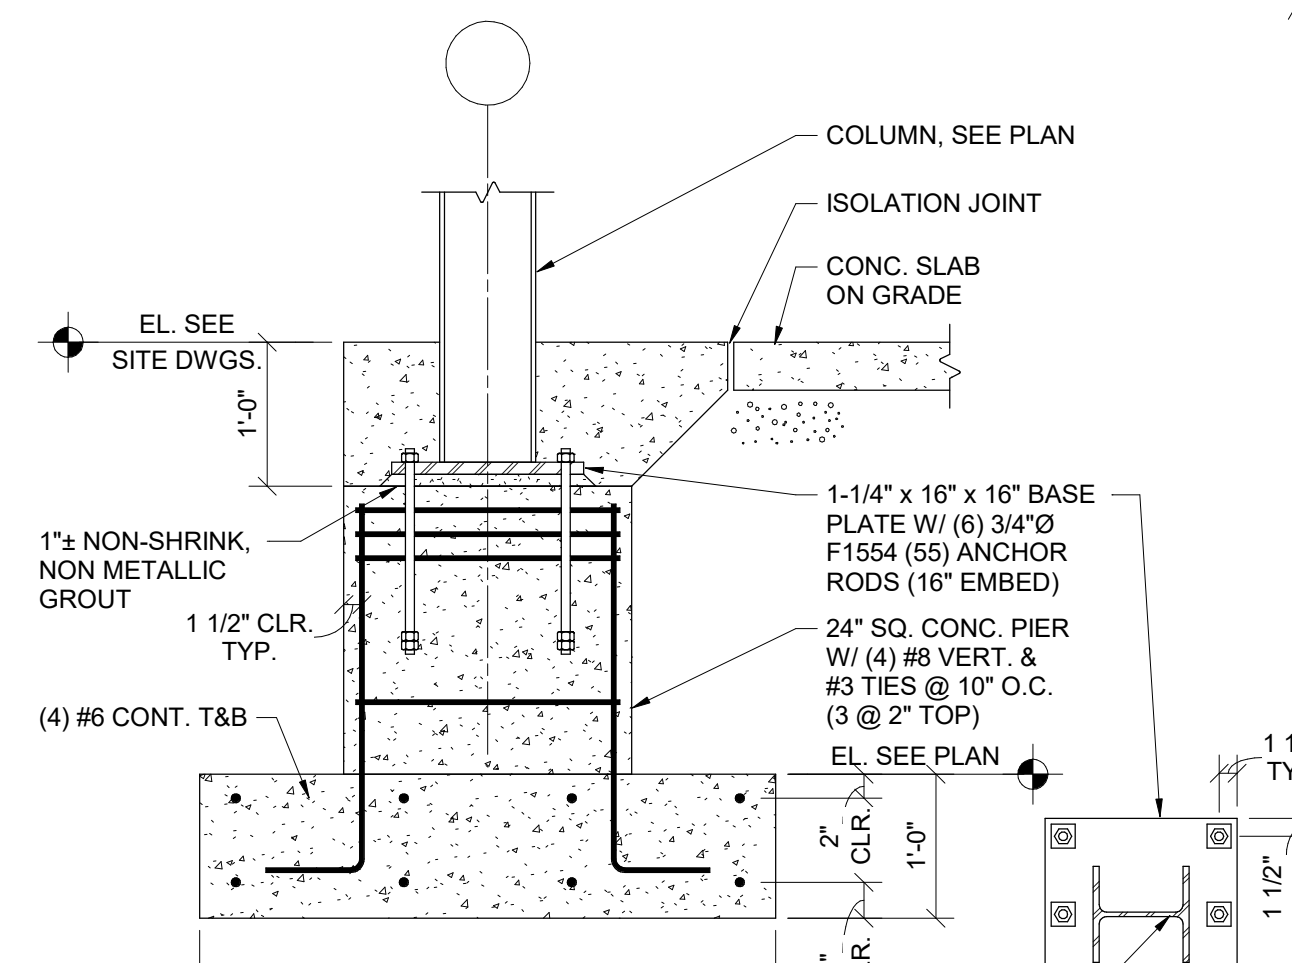


SECTION 9

3/4" = 1'-0"

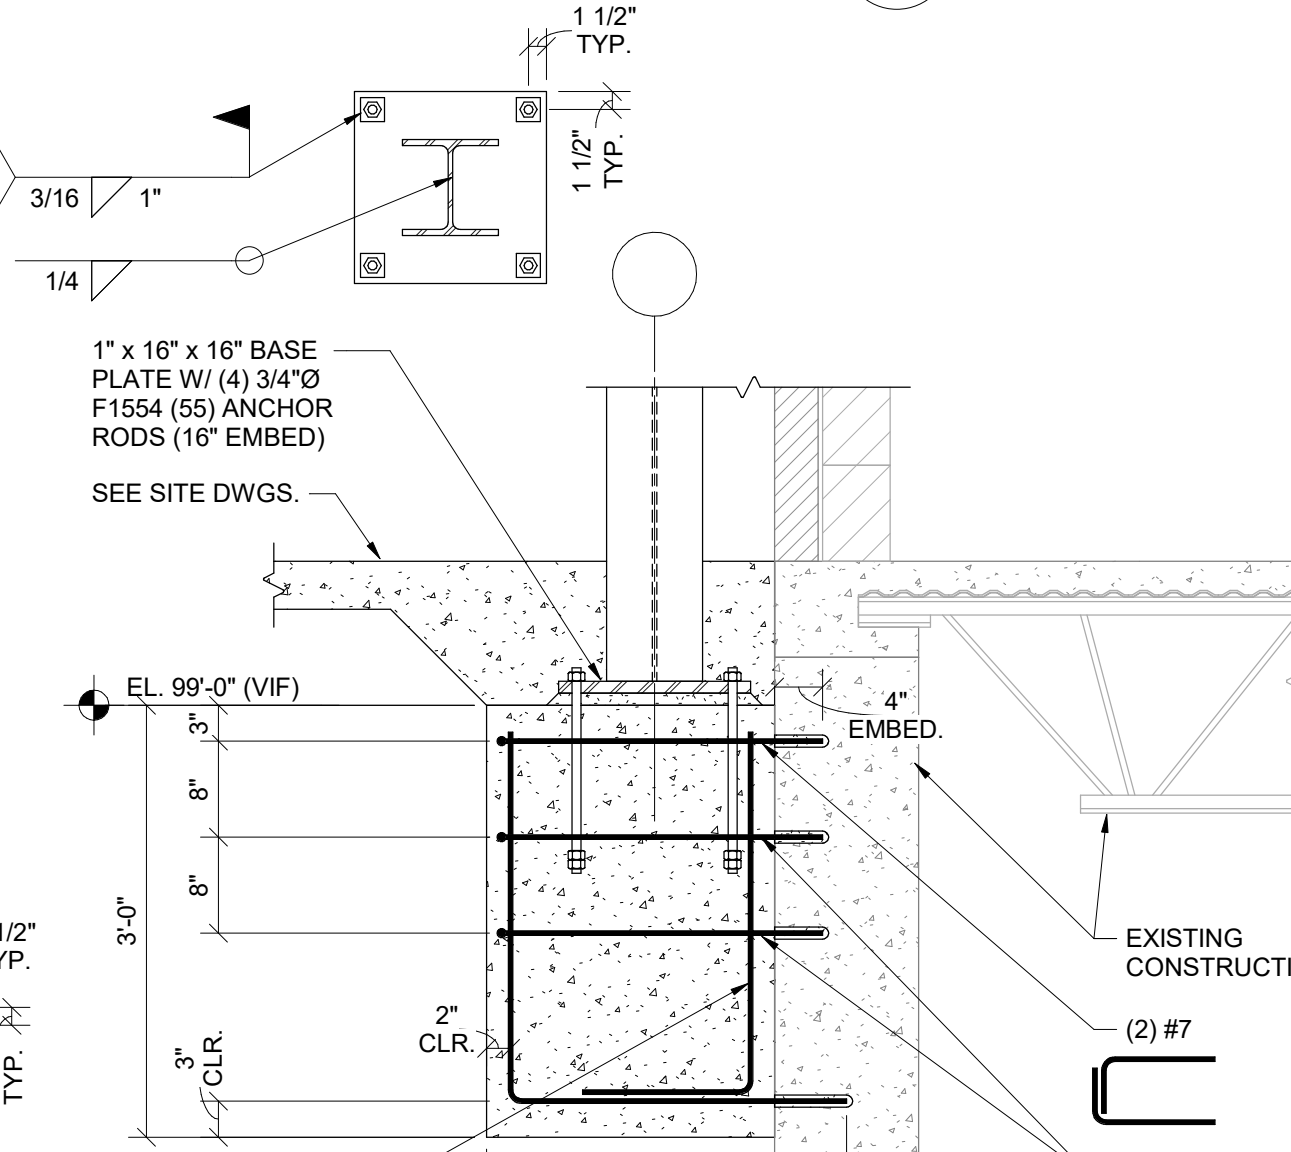

SECTION 10

3/4" = 1'-0"

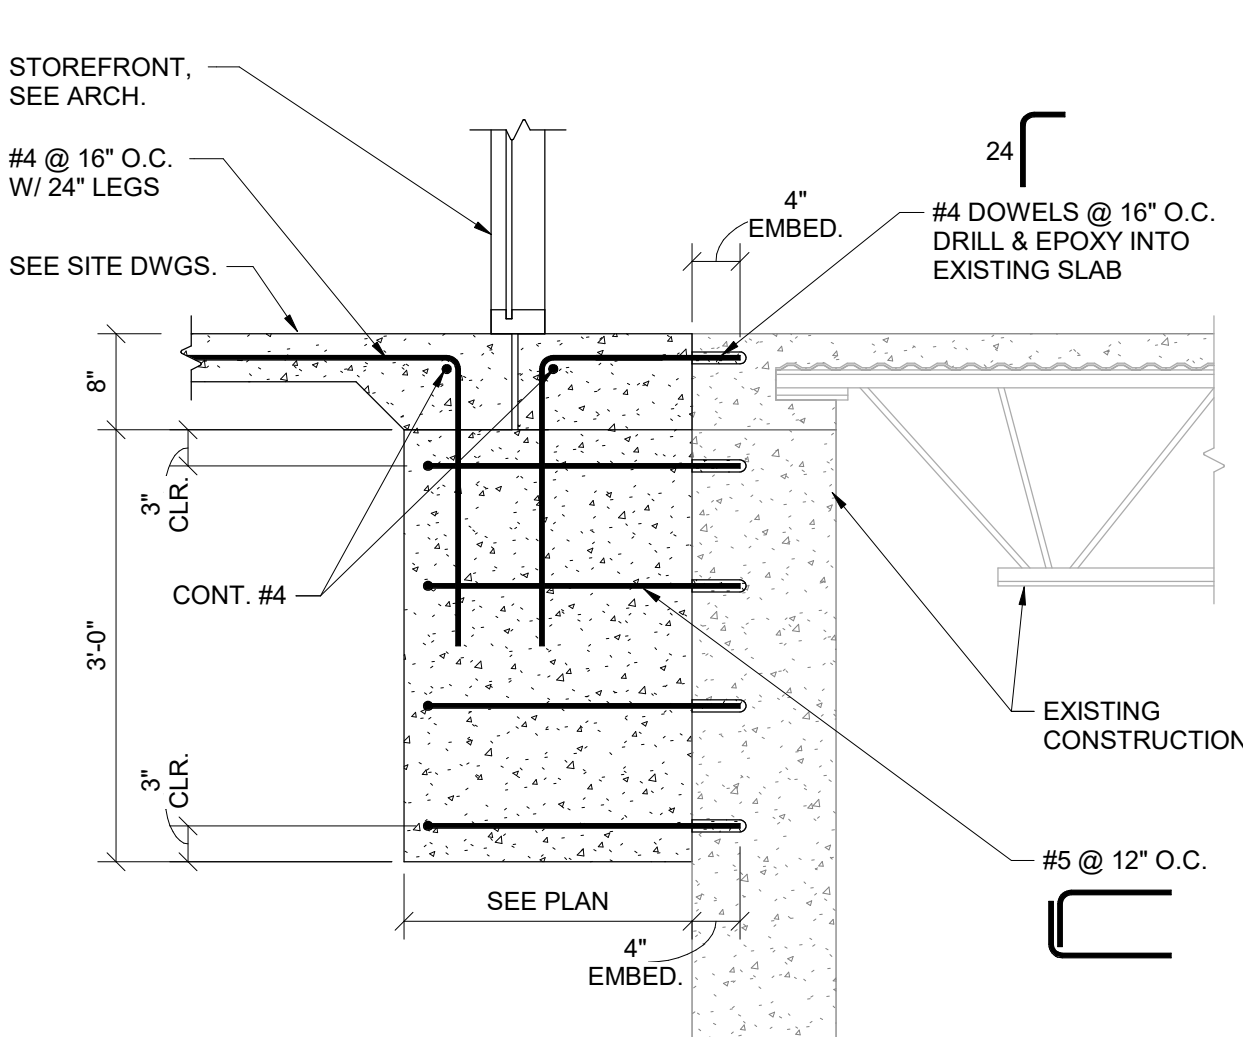

SECTION 11

3/4" = 1'-0"


#	DATE	CHANGE DESCRIPTION

RENOVATION OF HEARTLAND BANK DUBLIN
 5303 FRANTZ ROAD,
 DUBLIN, OH 43017
 FOR
HEARTLAND BANK





MOODY-NOLAN
 300 SPRUCE STREET
 SUITE 300
 COLUMBUS, OHIO 43215
 PHONE: (614) 461-4664
 FAX: (614) 280-8881

DRAWING TITLE:
FOUNDATION DETAILS

PROGRESS DRAWING NOT FOR CONSTRUCTION	11/30/2020
	DRAWN BY: Author CHECKED BY: Checker
	20022
	S201
FINAL DEVELOPMENT PLAN	

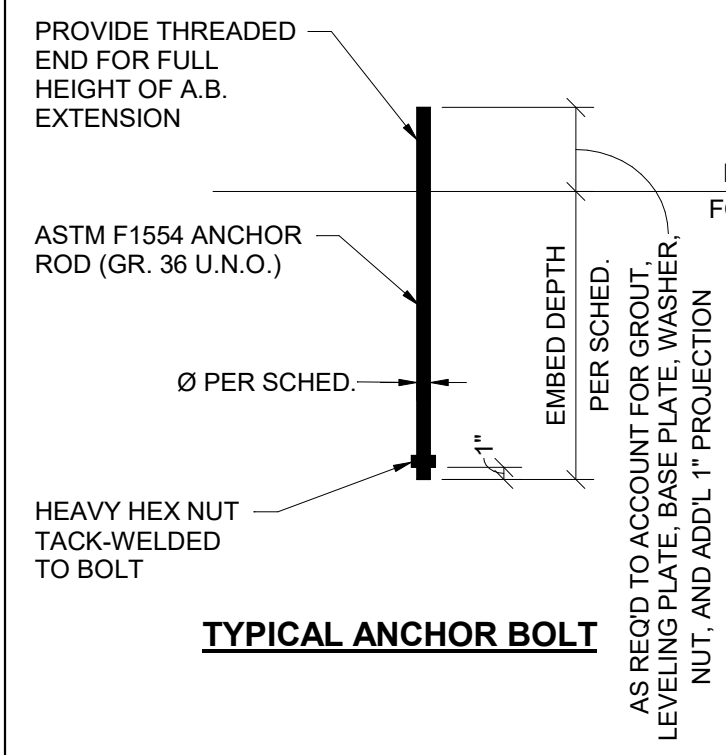

BASE PLATE DETAILING SCHEDULE			
BOLT SIZE	BASE PLATE HOLE SIZE	EDGE DISTANCE	PLATE WASHER
3/4"Ø	1-5/16"Ø	1-1/2"	1/4" x 2-1/2" SQ.
1"Ø	1-13/16"Ø	2"	3/8" x 3" SQ.
1-1/4"Ø	2-1/16"Ø	2"	1/2" x 3" SQ.
1-1/2"Ø	2-5/16"Ø	2-1/2"	1/2" x 3-1/2" SQ.
1-3/4"Ø	2-3/4"Ø	3"	5/8" x 4" SQ.
2"Ø	3-1/4"Ø	3-1/2"	3/4" x 5" SQ.

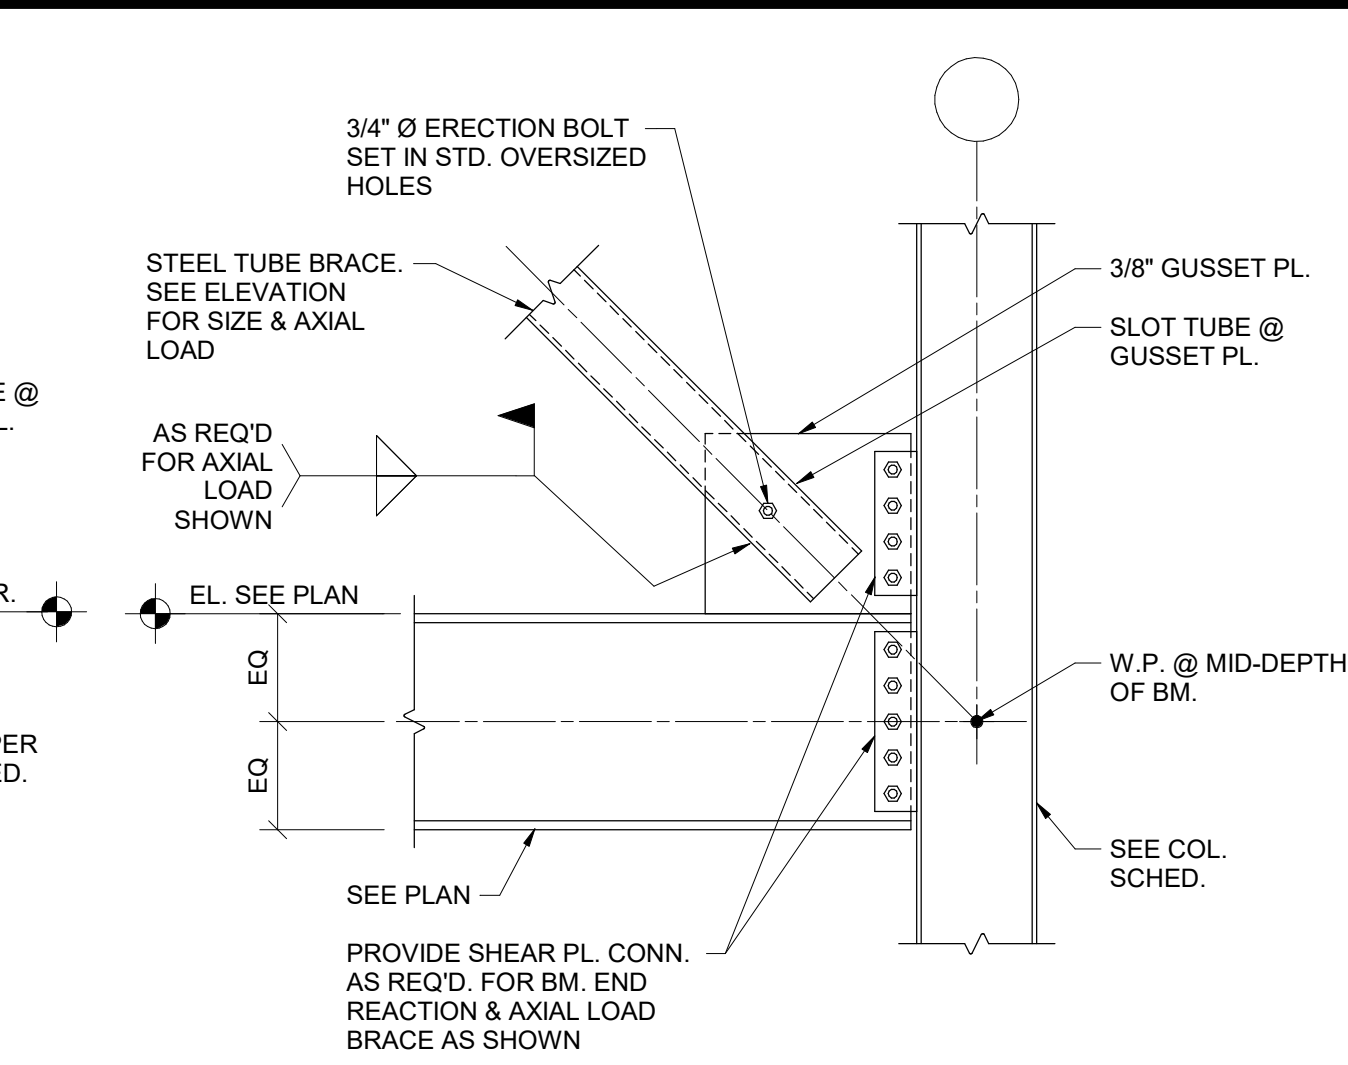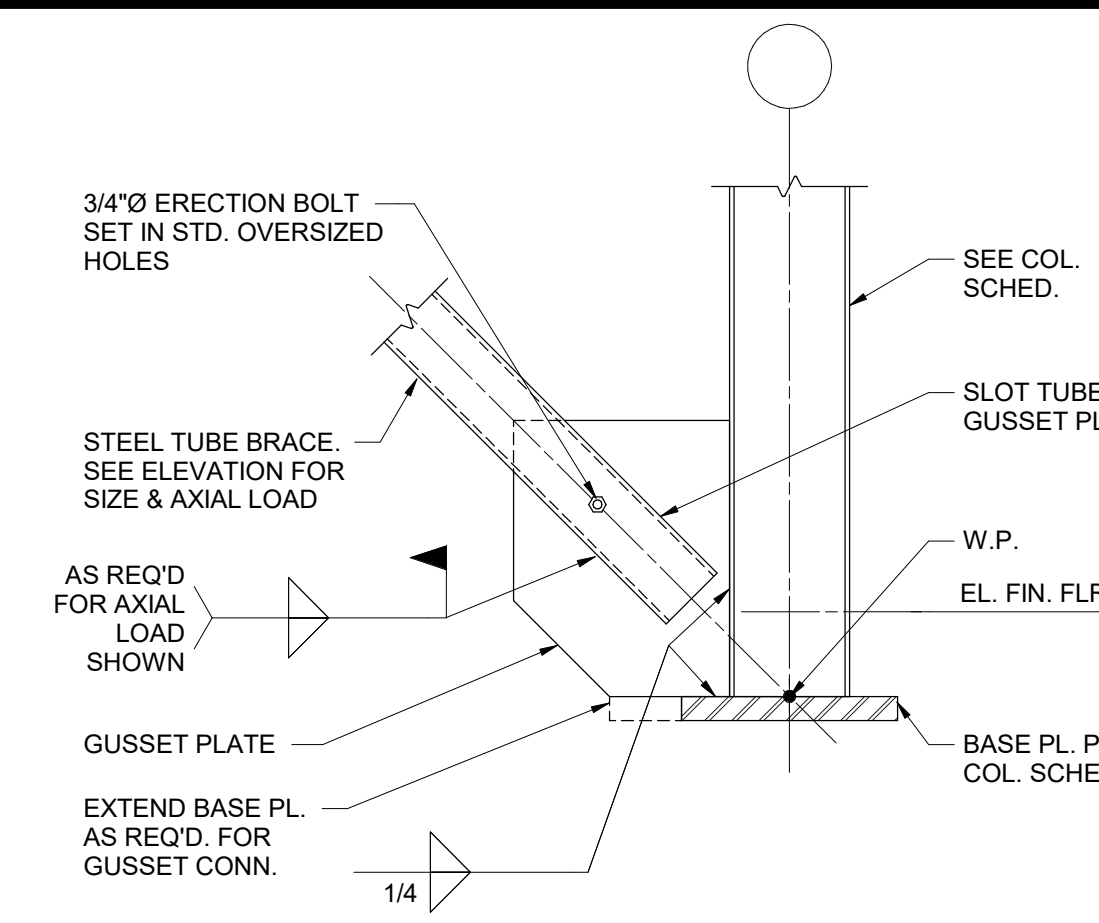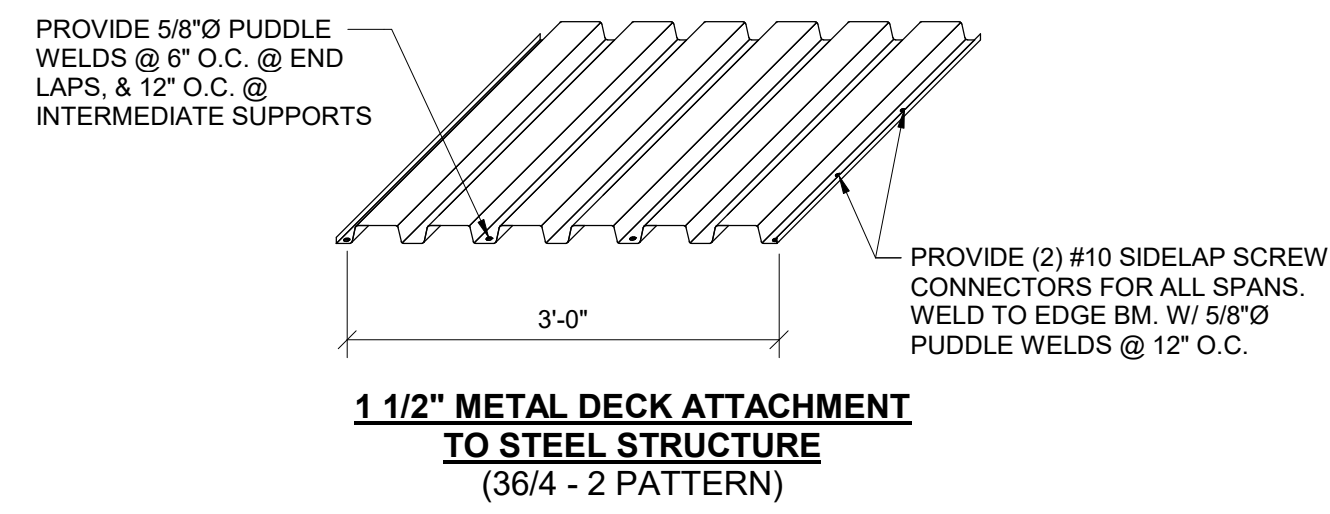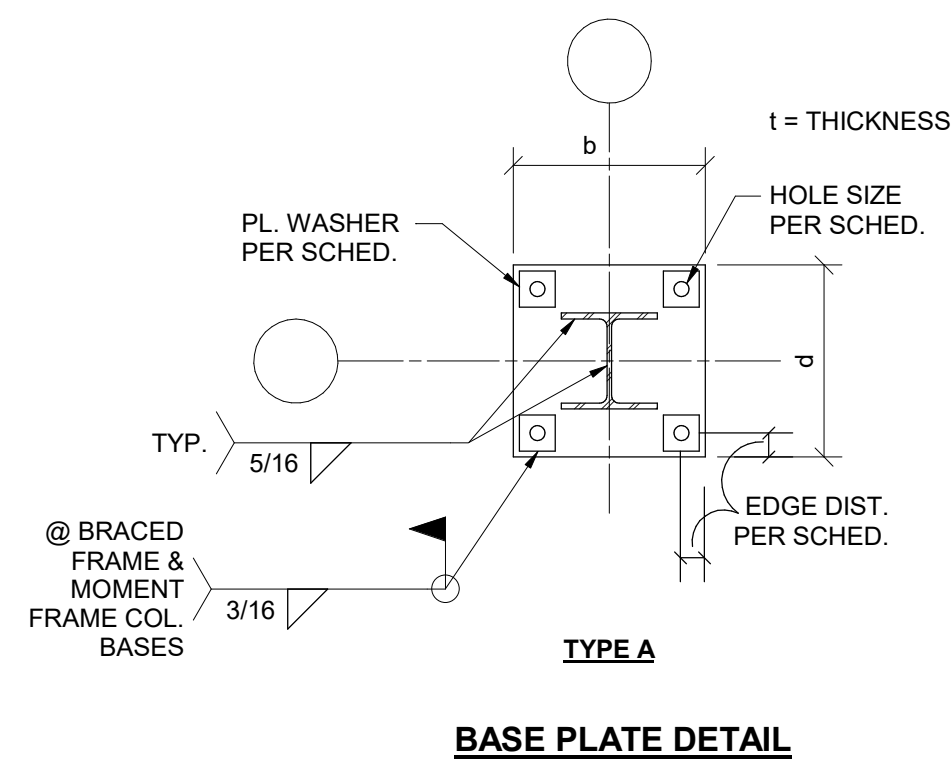







SECTION 1
3/4" = 1'-0"

SECTION 2
3/4" = 1'-0"

SECTION 3
3/4" = 1'-0"

SECTION 4
3/4" = 1'-0"

SECTION 5
3/4" = 1'-0"

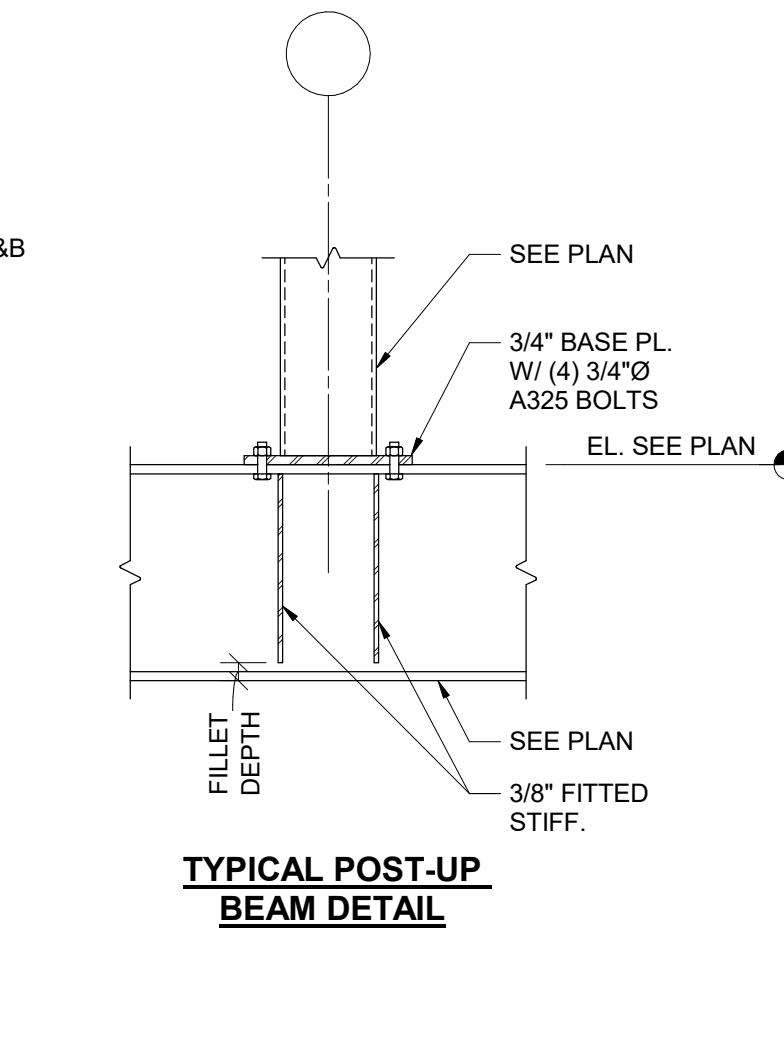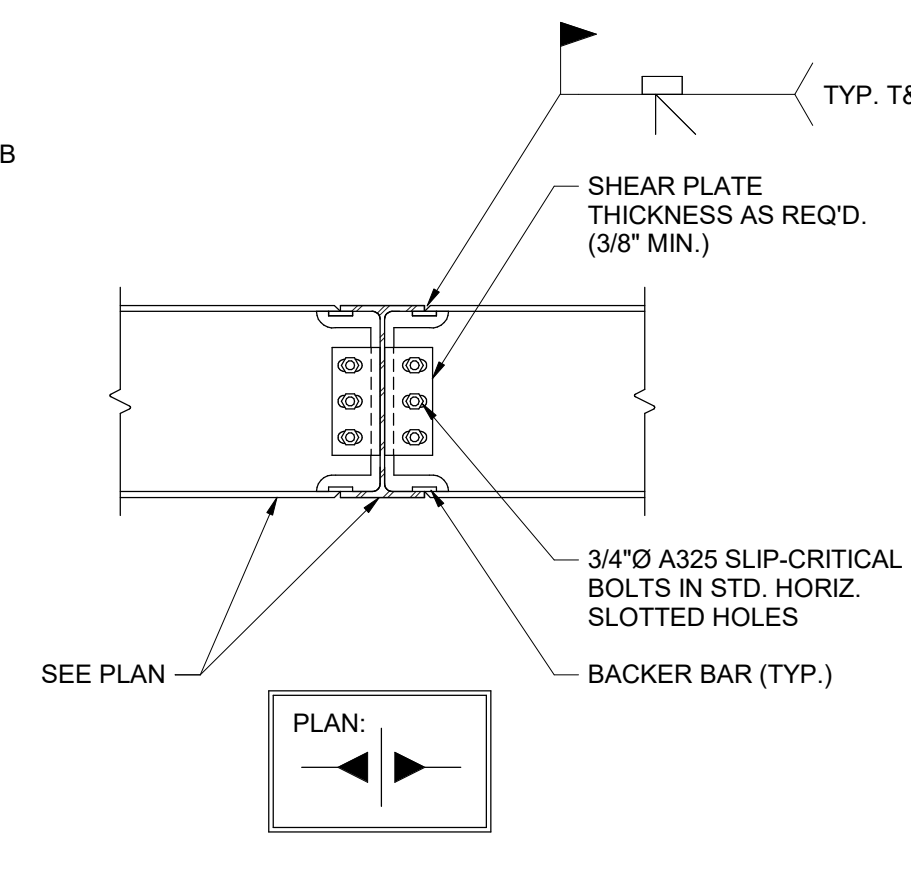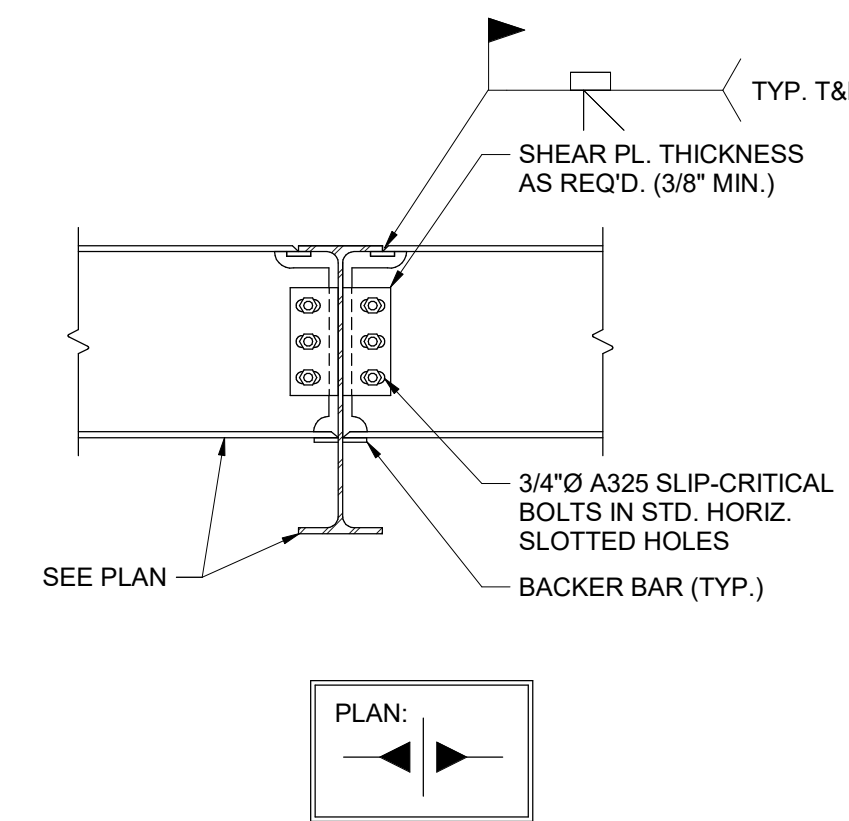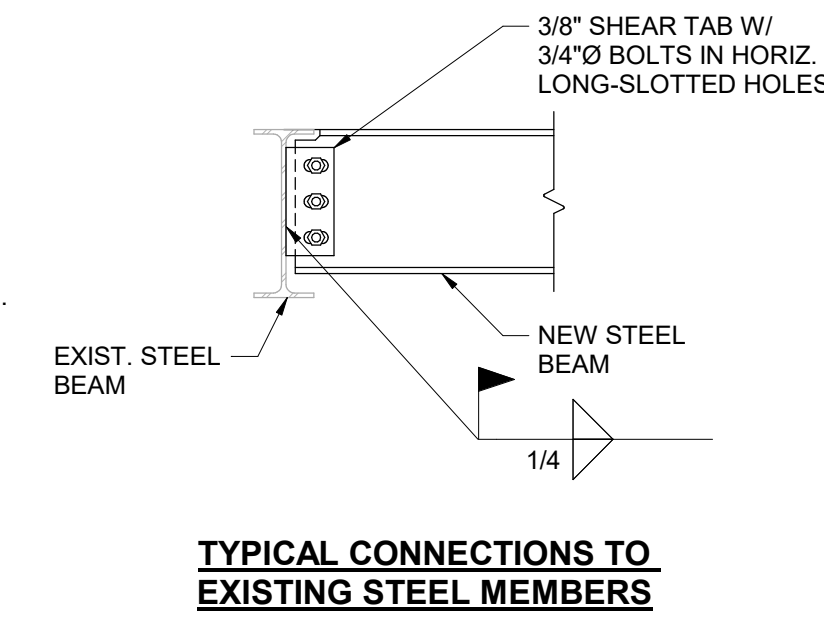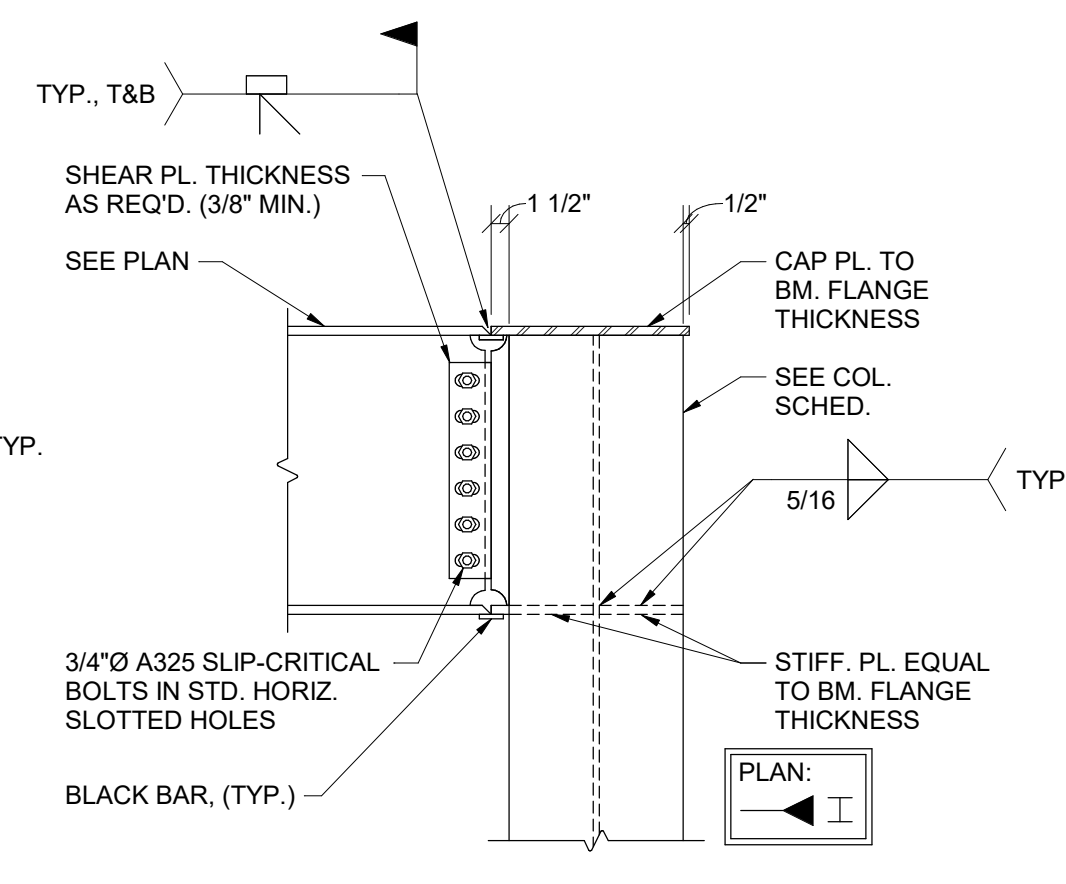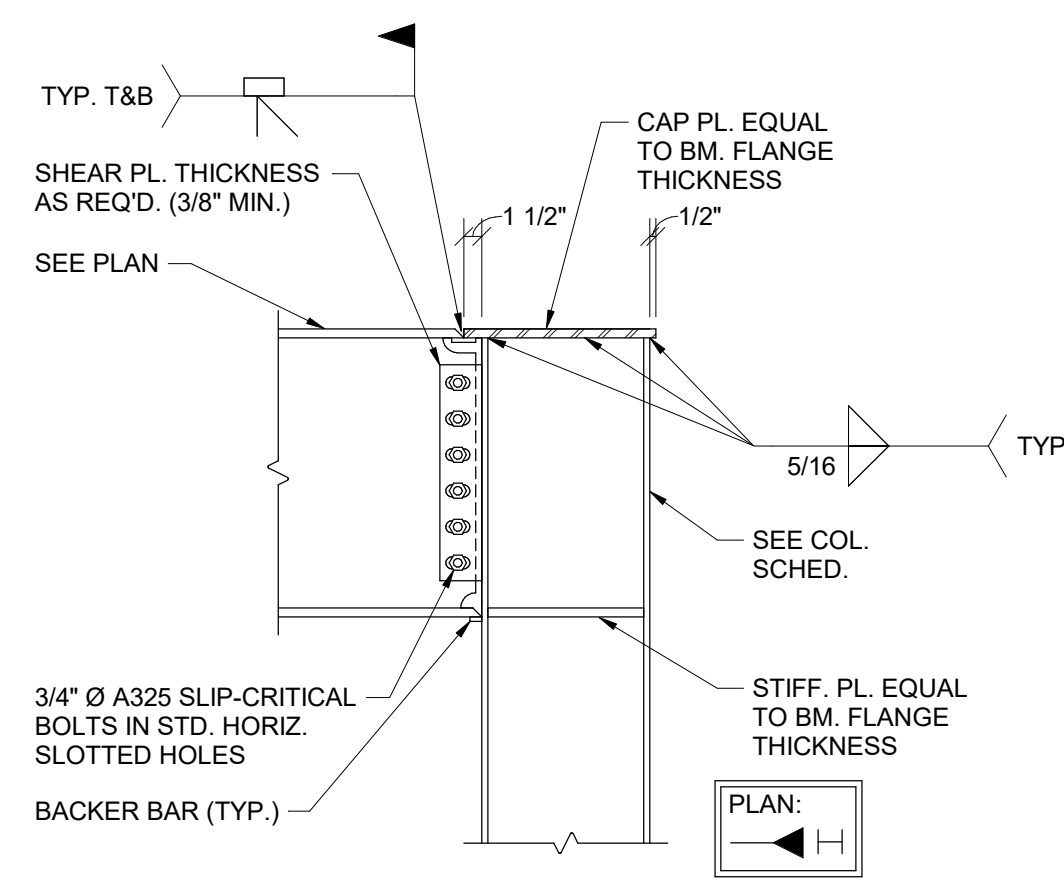

SECTION 6
3/4" = 1'-0"

SECTION 7
3/4" = 1'-0"

SECTION 8
3/4" = 1'-0"

SECTION 9
3/4" = 1'-0"

SECTION 10
3/4" = 1'-0"

SECTION 11
3/4" = 1'-0"

#	DATE	CHANGE DESCRIPTION




RENOVATION OF HEARTLAND BANK DUBLIN
5303 FRANTZ ROAD,
DUBLIN OH - 43017
FOR
HEARTLAND BANK

MOODY-NOLAN
300 SPRUCE STREET
SUITE 300
COLUMBUS, OHIO 43215
PHONE: (614) 461-4664
FAX: (614) 280-8881

DRAWING TITLE:

FRAMING DETAILS

PROGRESS DRAWING NOT FOR CONSTRUCTION	11/30/2020
	DRAWN BY: Author CHECKED BY: Checker
	20022
	S210
FINAL DEVELOPMENT PLAN	

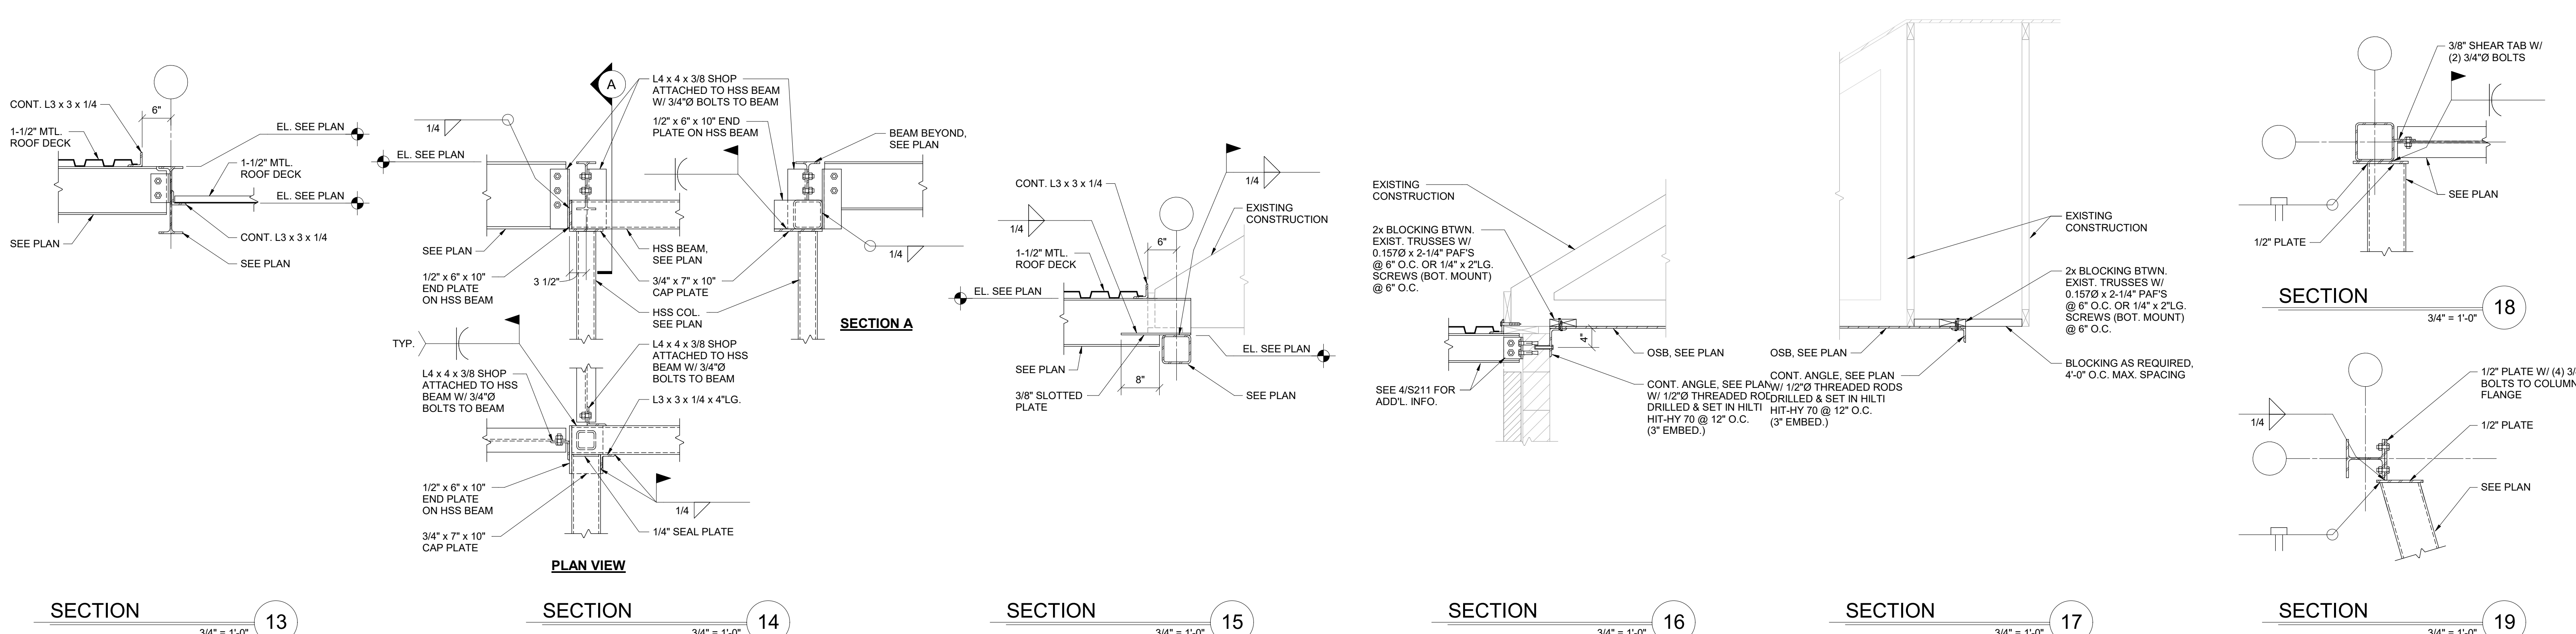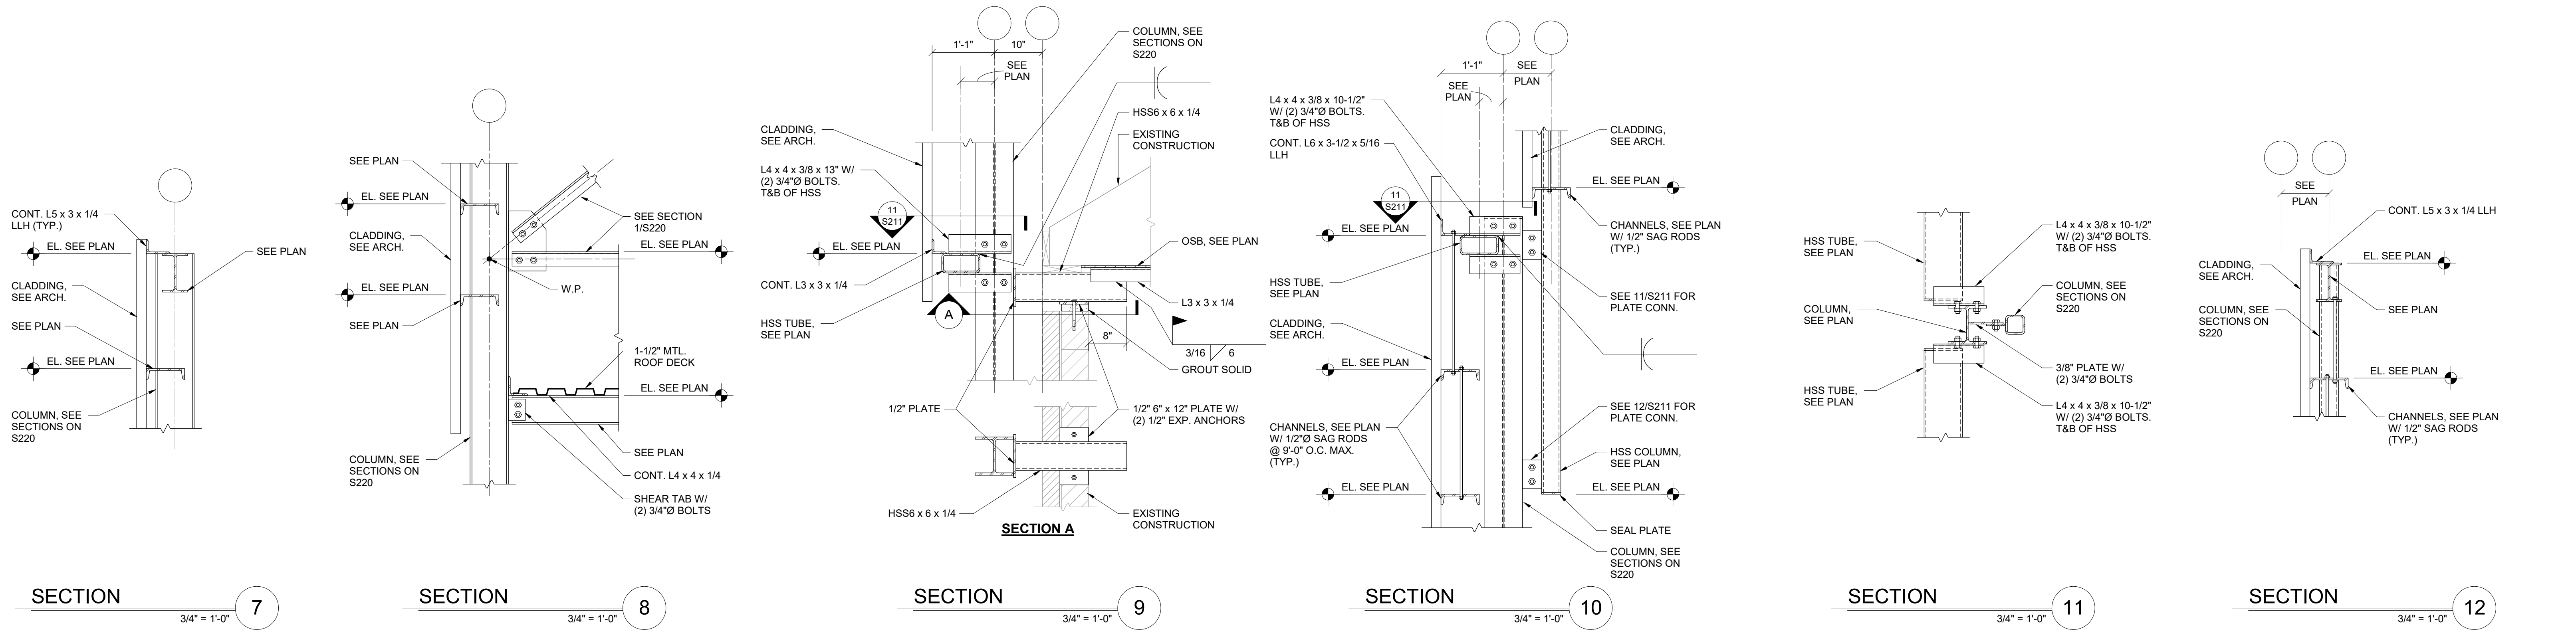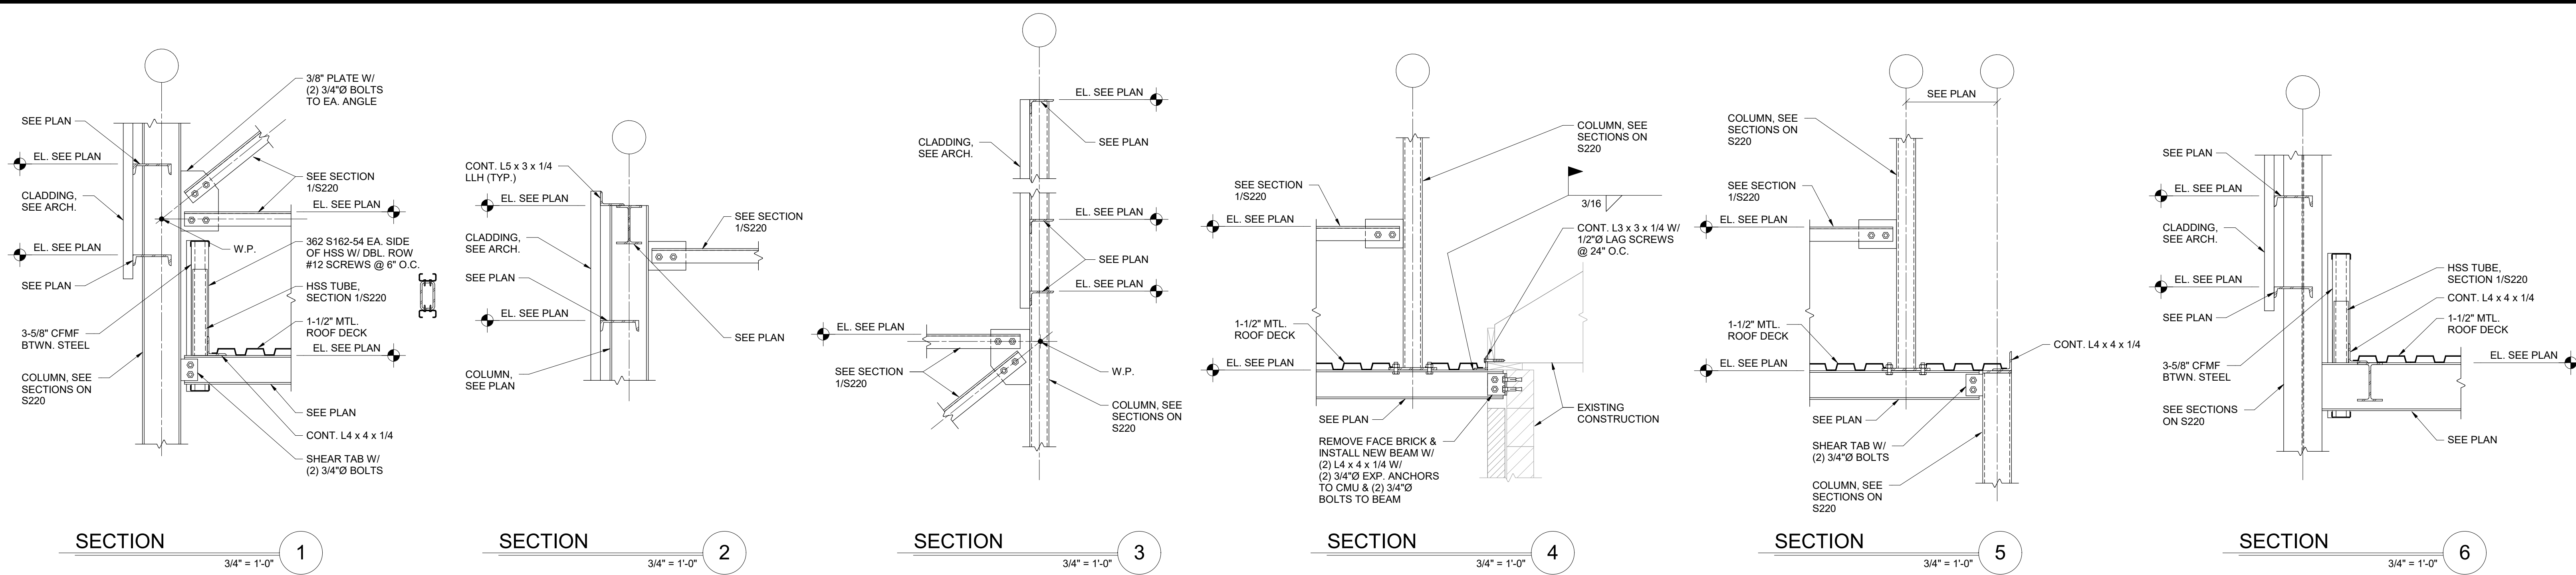

#	DATE	CHANGE DESCRIPTION


RENOVATION OF HEARTLAND BANK DUBLIN
 5303 FRANTZ ROAD,
 DUBLIN OH - 43017
 FOR
HEARTLAND BANK

MOODY-NOLAN
 300 SPRUCE STREET
 SUITE 300
 COLUMBUS, OHIO 43215
 PHONE: (614) 461-4664
 FAX: (614) 280-8881

DRAWING TITLE: **FRAMING DETAILS**

11/30/2020
 DRAWN BY: Author CHECKED BY: Checker
 20022
S211
 FINAL DEVELOPMENT PLAN

PROGRESS DRAWING NOT FOR CONSTRUCTION

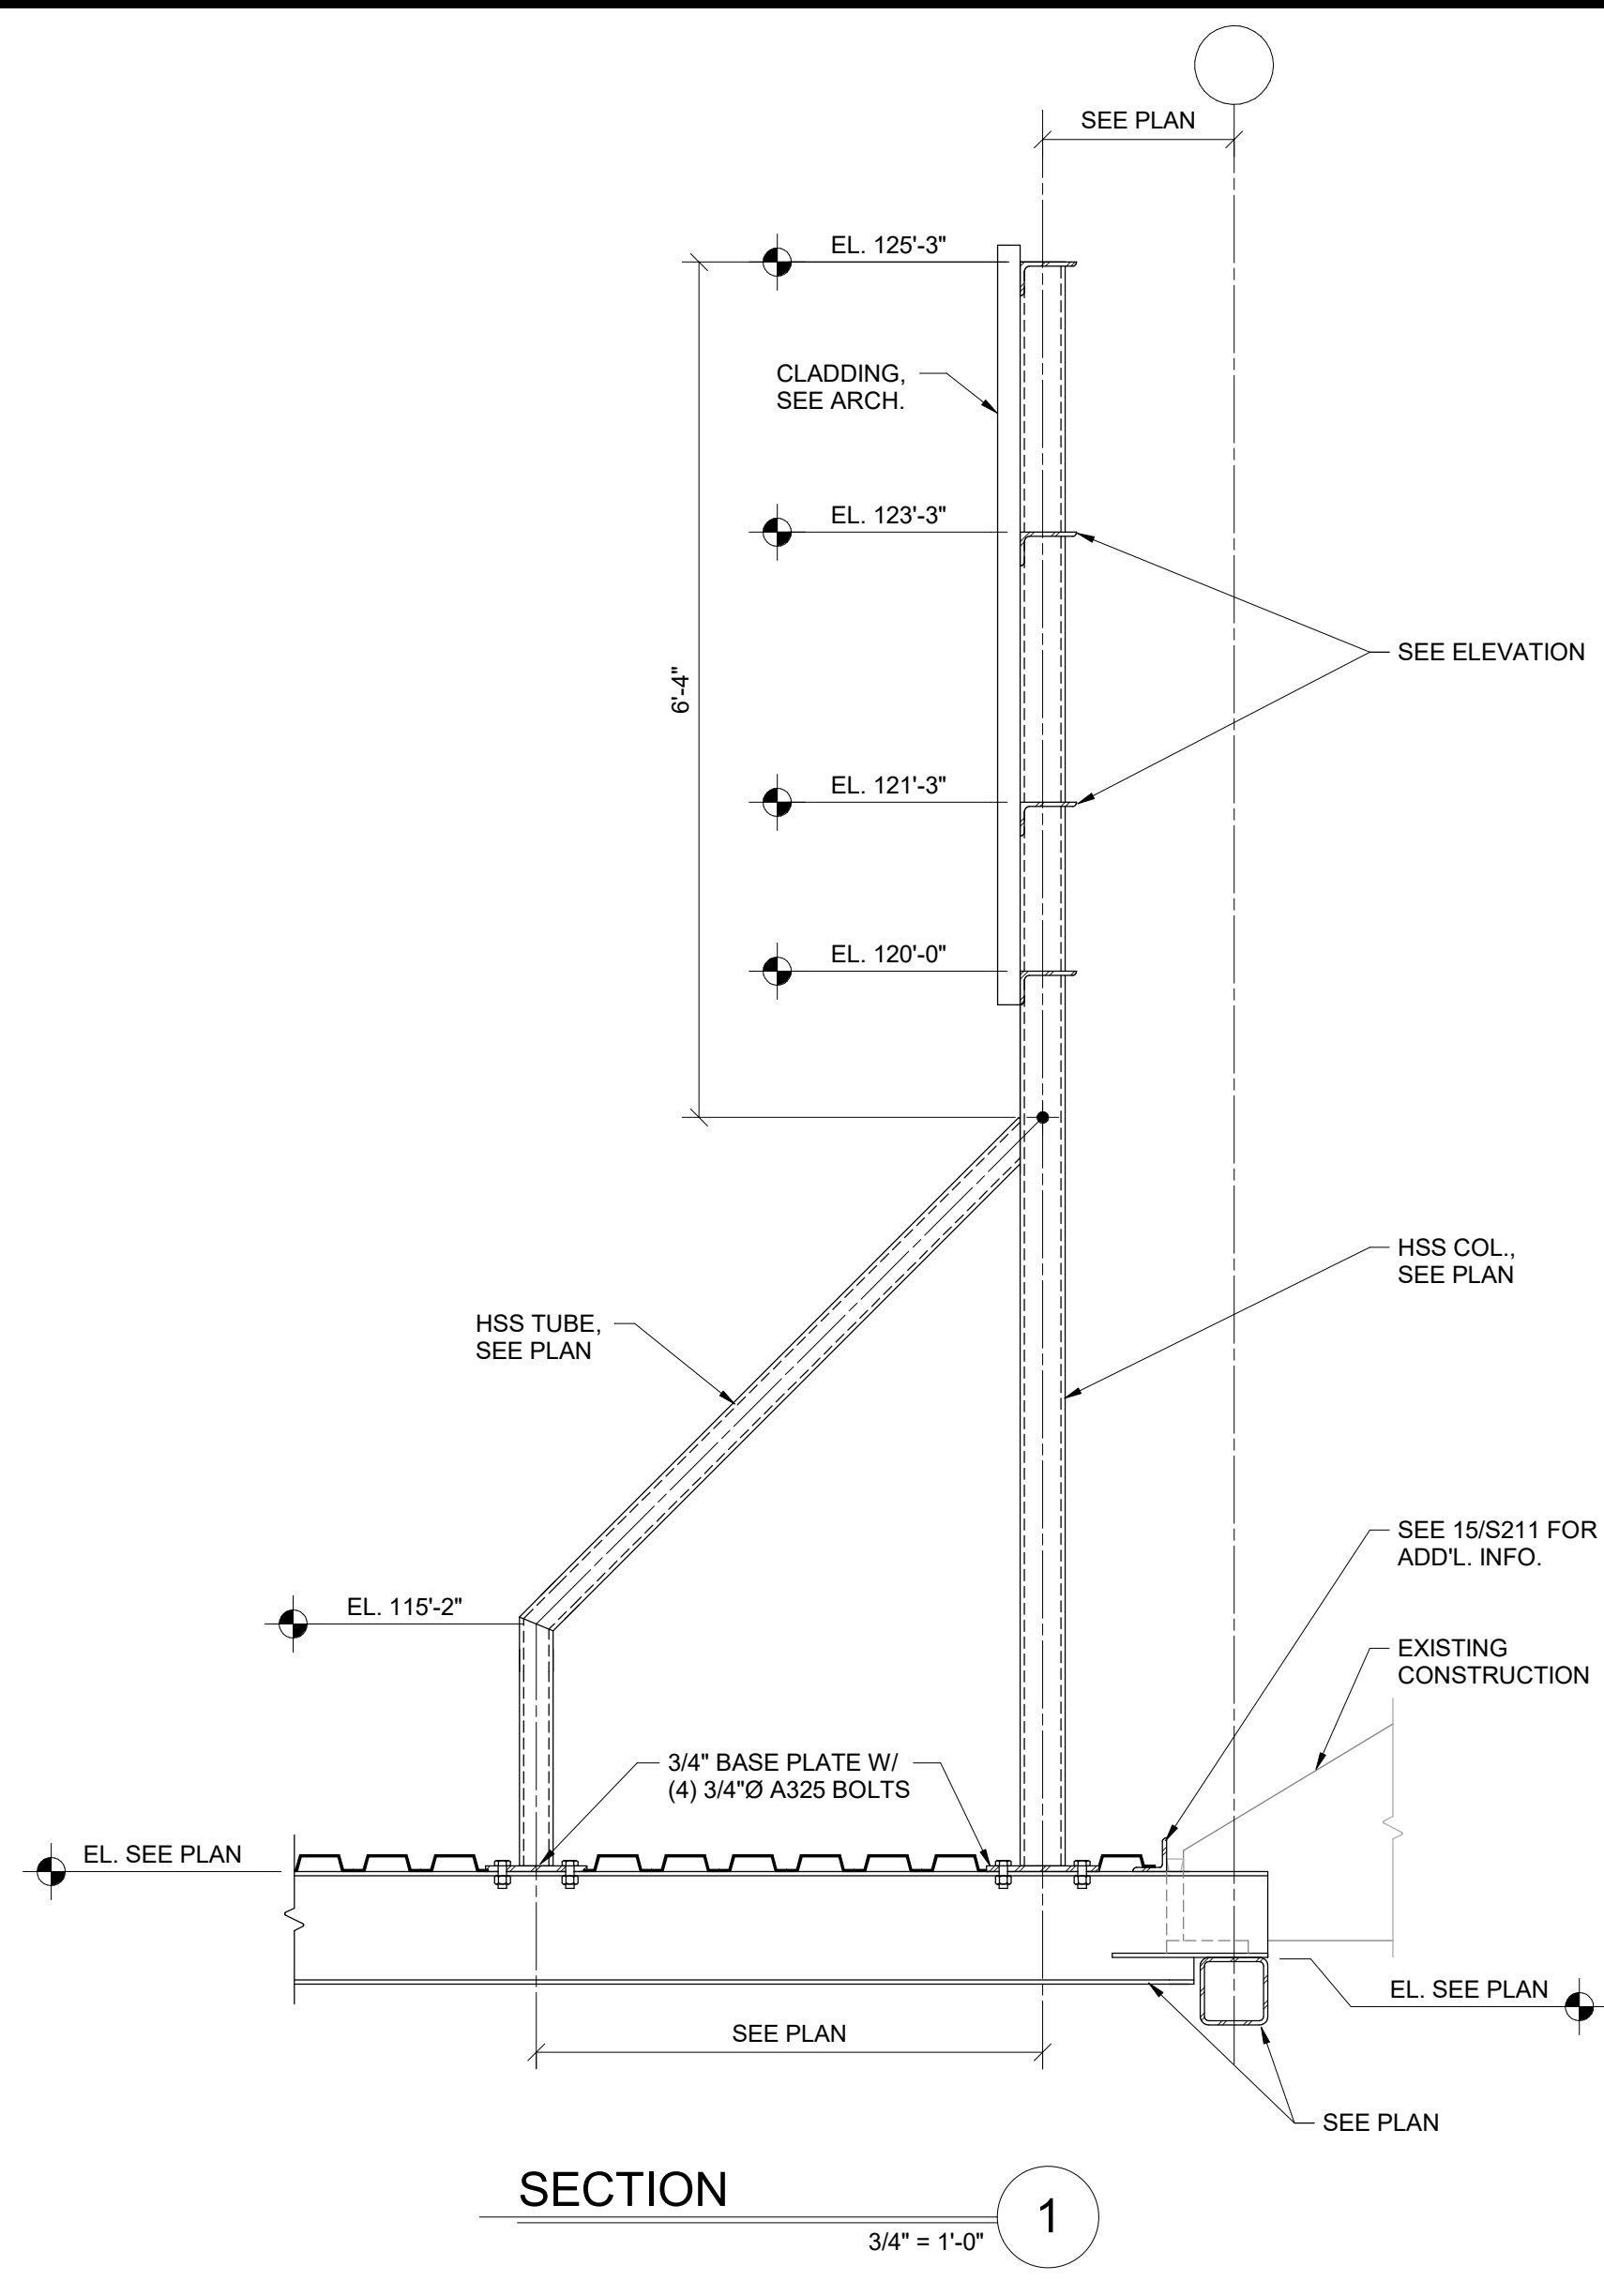

SECTION 1
3/4" = 1'-0"

#	DATE	CHANGE DESCRIPTION


RENOVATION OF HEARTLAND BANK DUBLIN
 6300 FRANTZ ROAD,
 DUBLIN OH - 43017
 FOR
HEARTLAND BANK

MOODY-NOLAN
 300 SPRUCE STREET
 SUITE 300
 COLUMBUS, OHIO 43215
 PHONE: (614) 461-4664
 FAX: (614) 280-8881


DRAWING TITLE:
FRAMING DETAILS

PROGRESS DRAWING NOT FOR CONSTRUCTION	11/30/2020
	DRAWN BY: Author CHECKED BY: Checker
	20022
	S212


FINAL DEVELOPMENT PLAN

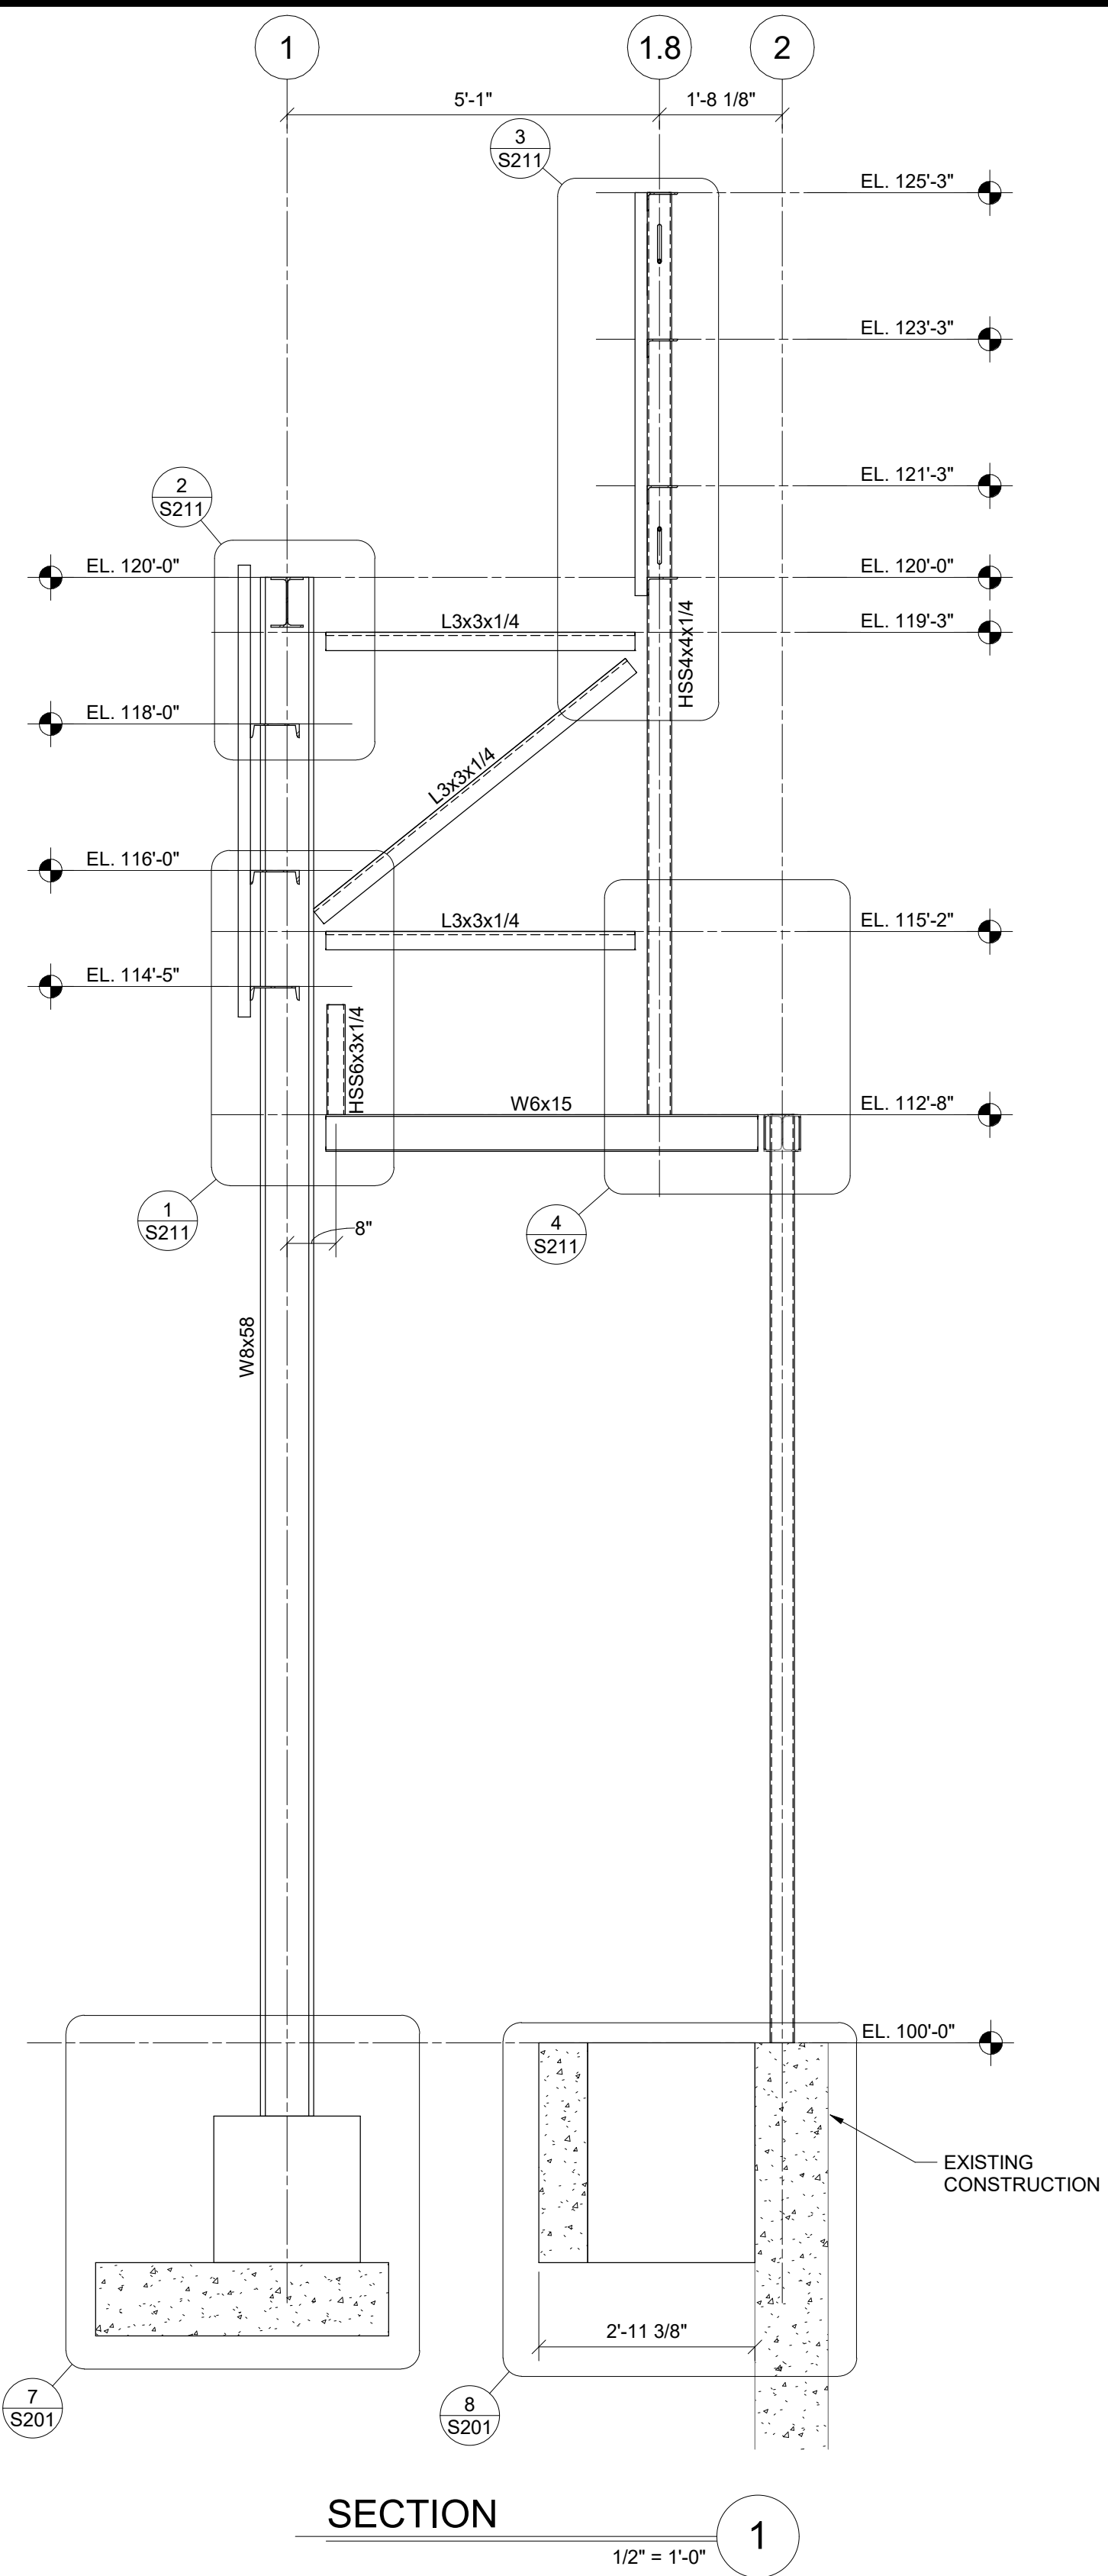


SECTION 1
1/2" = 1'-0"

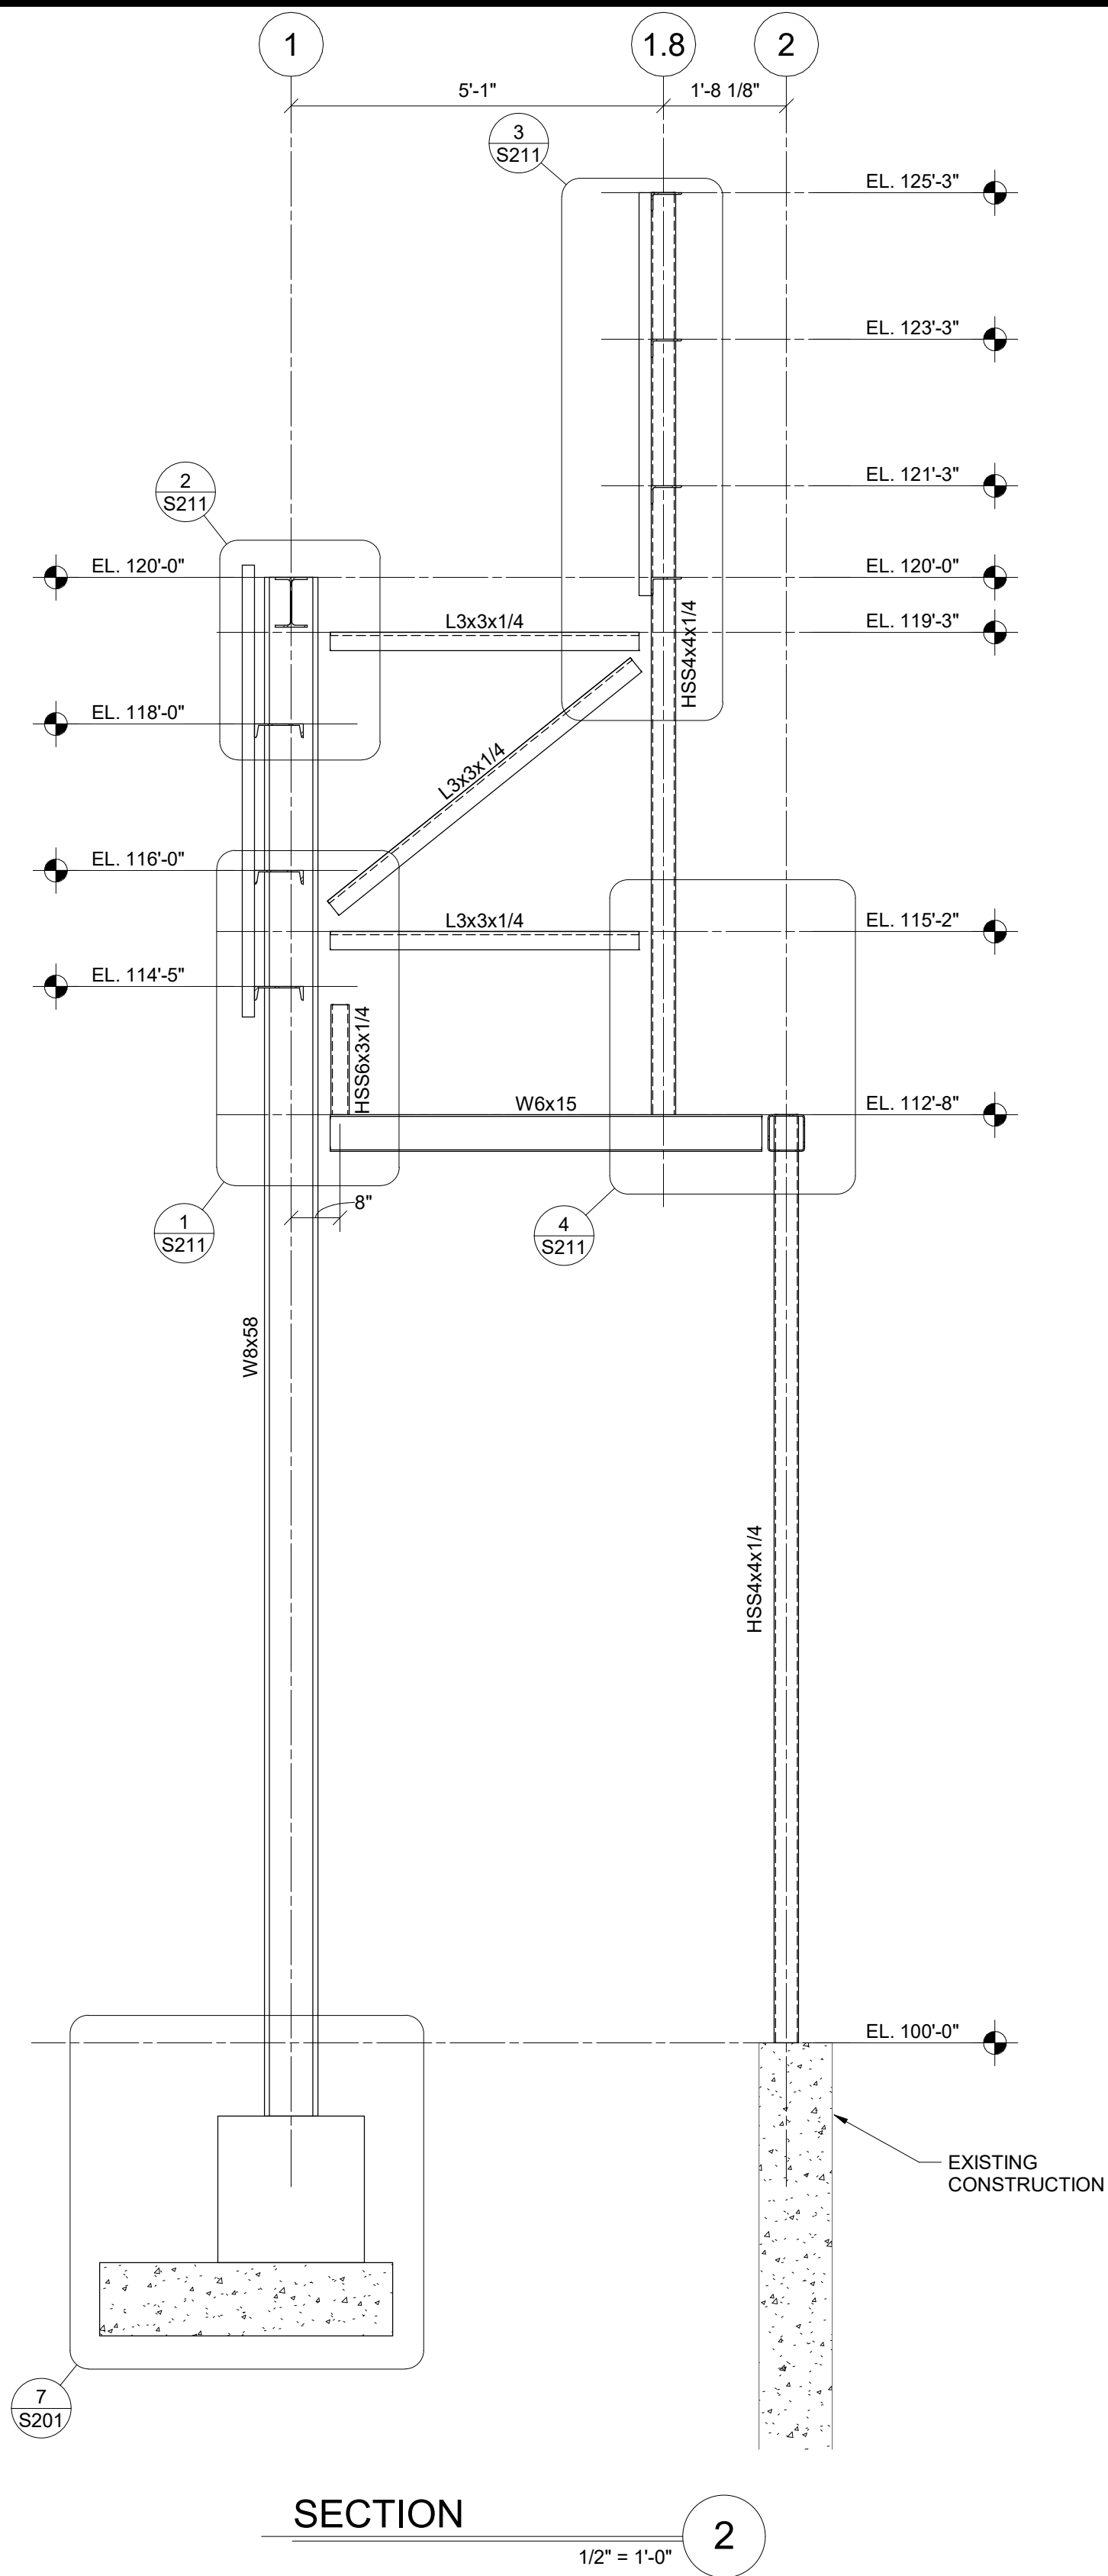


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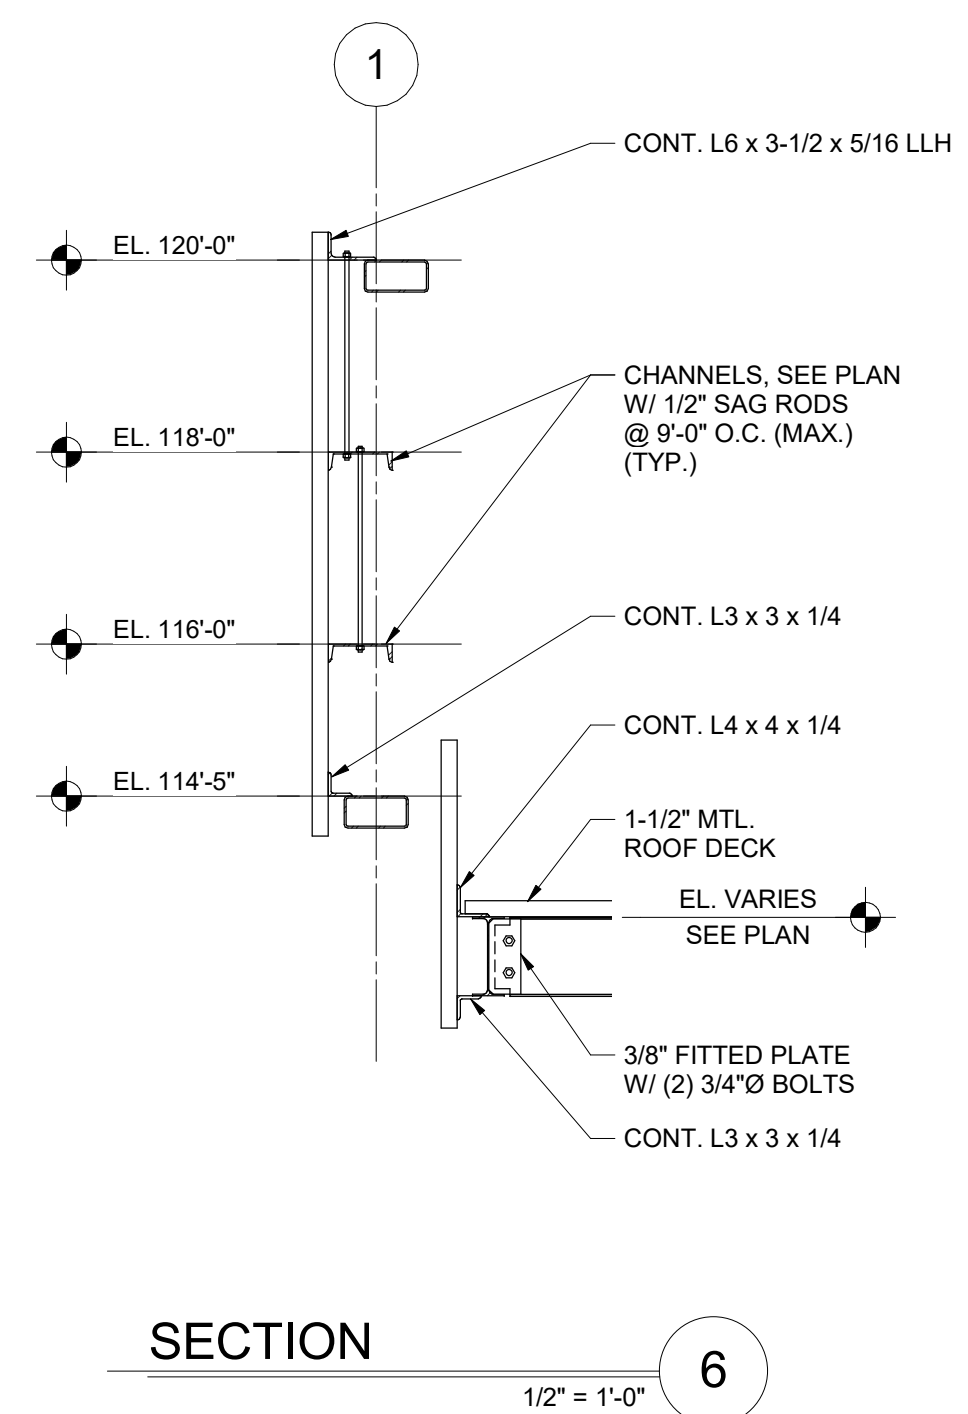
SECTION 3
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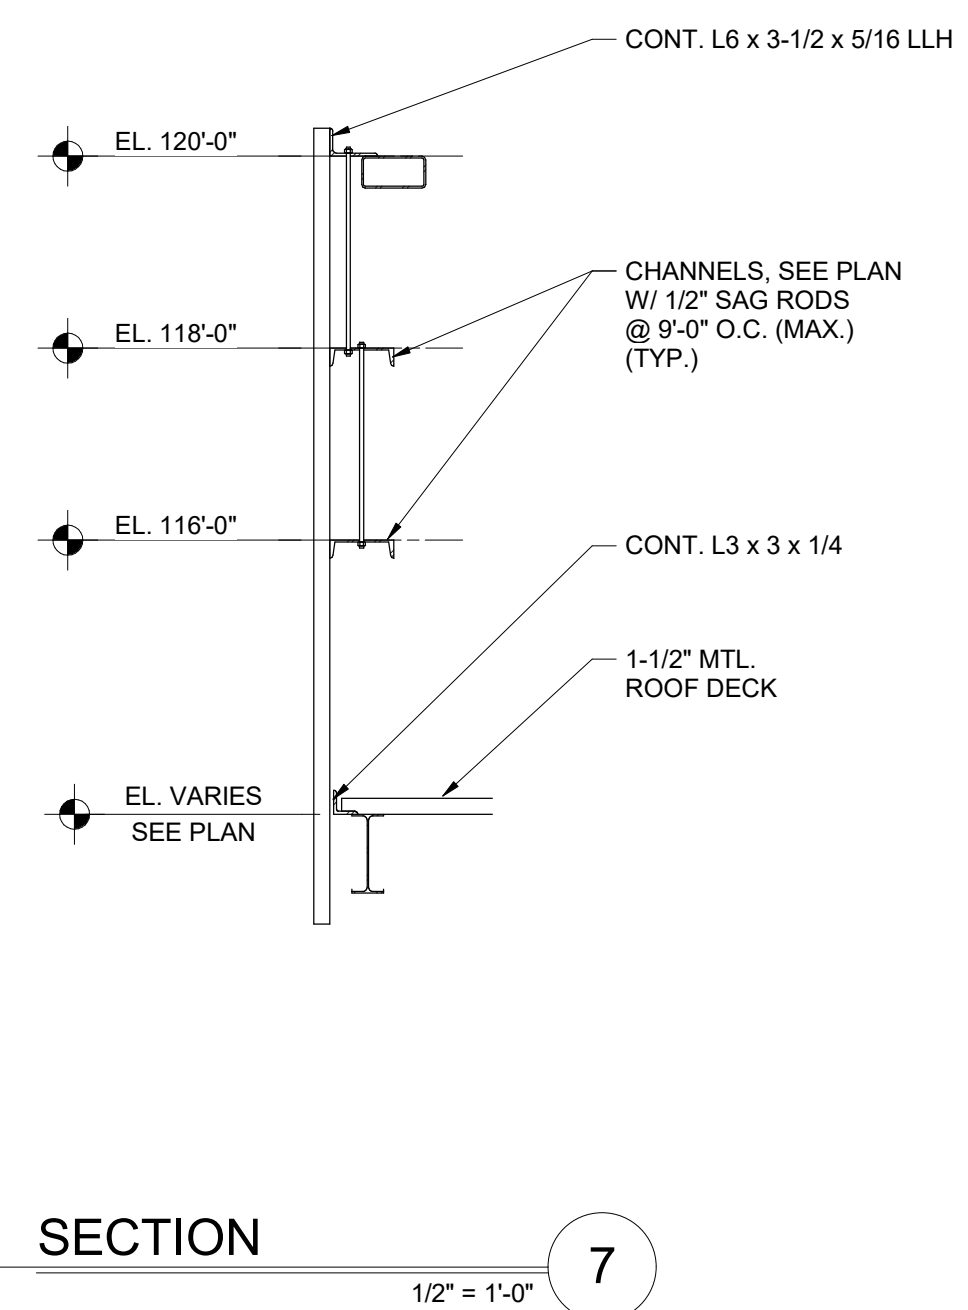
SECTION 4
1/2" = 1'-0"

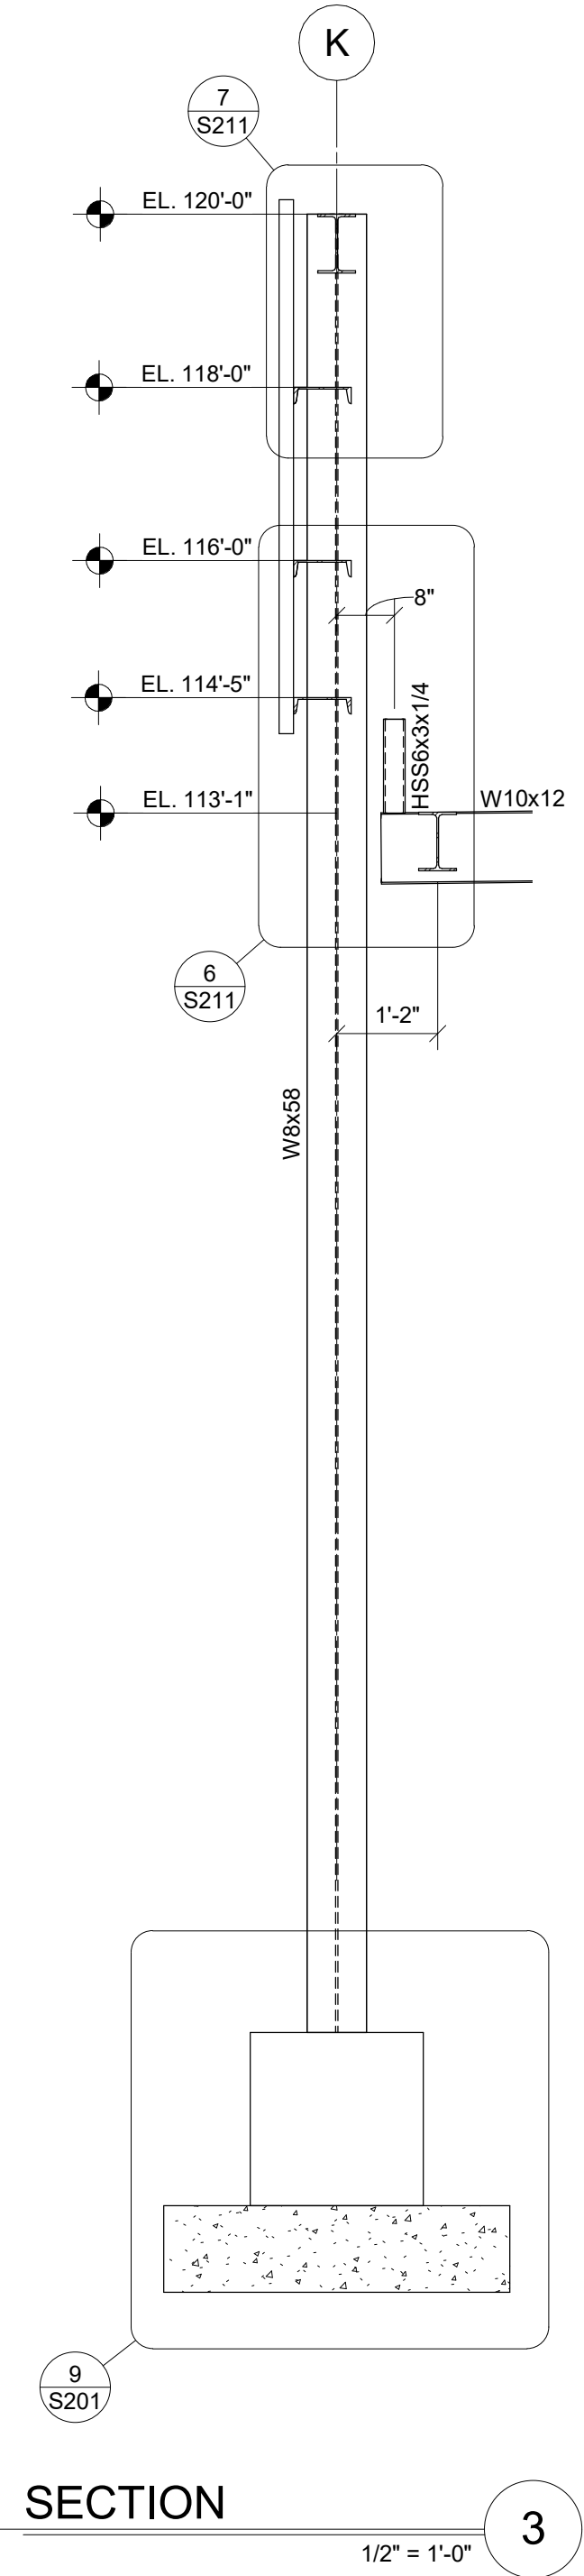

SECTION 5
1/2" = 1'-0"

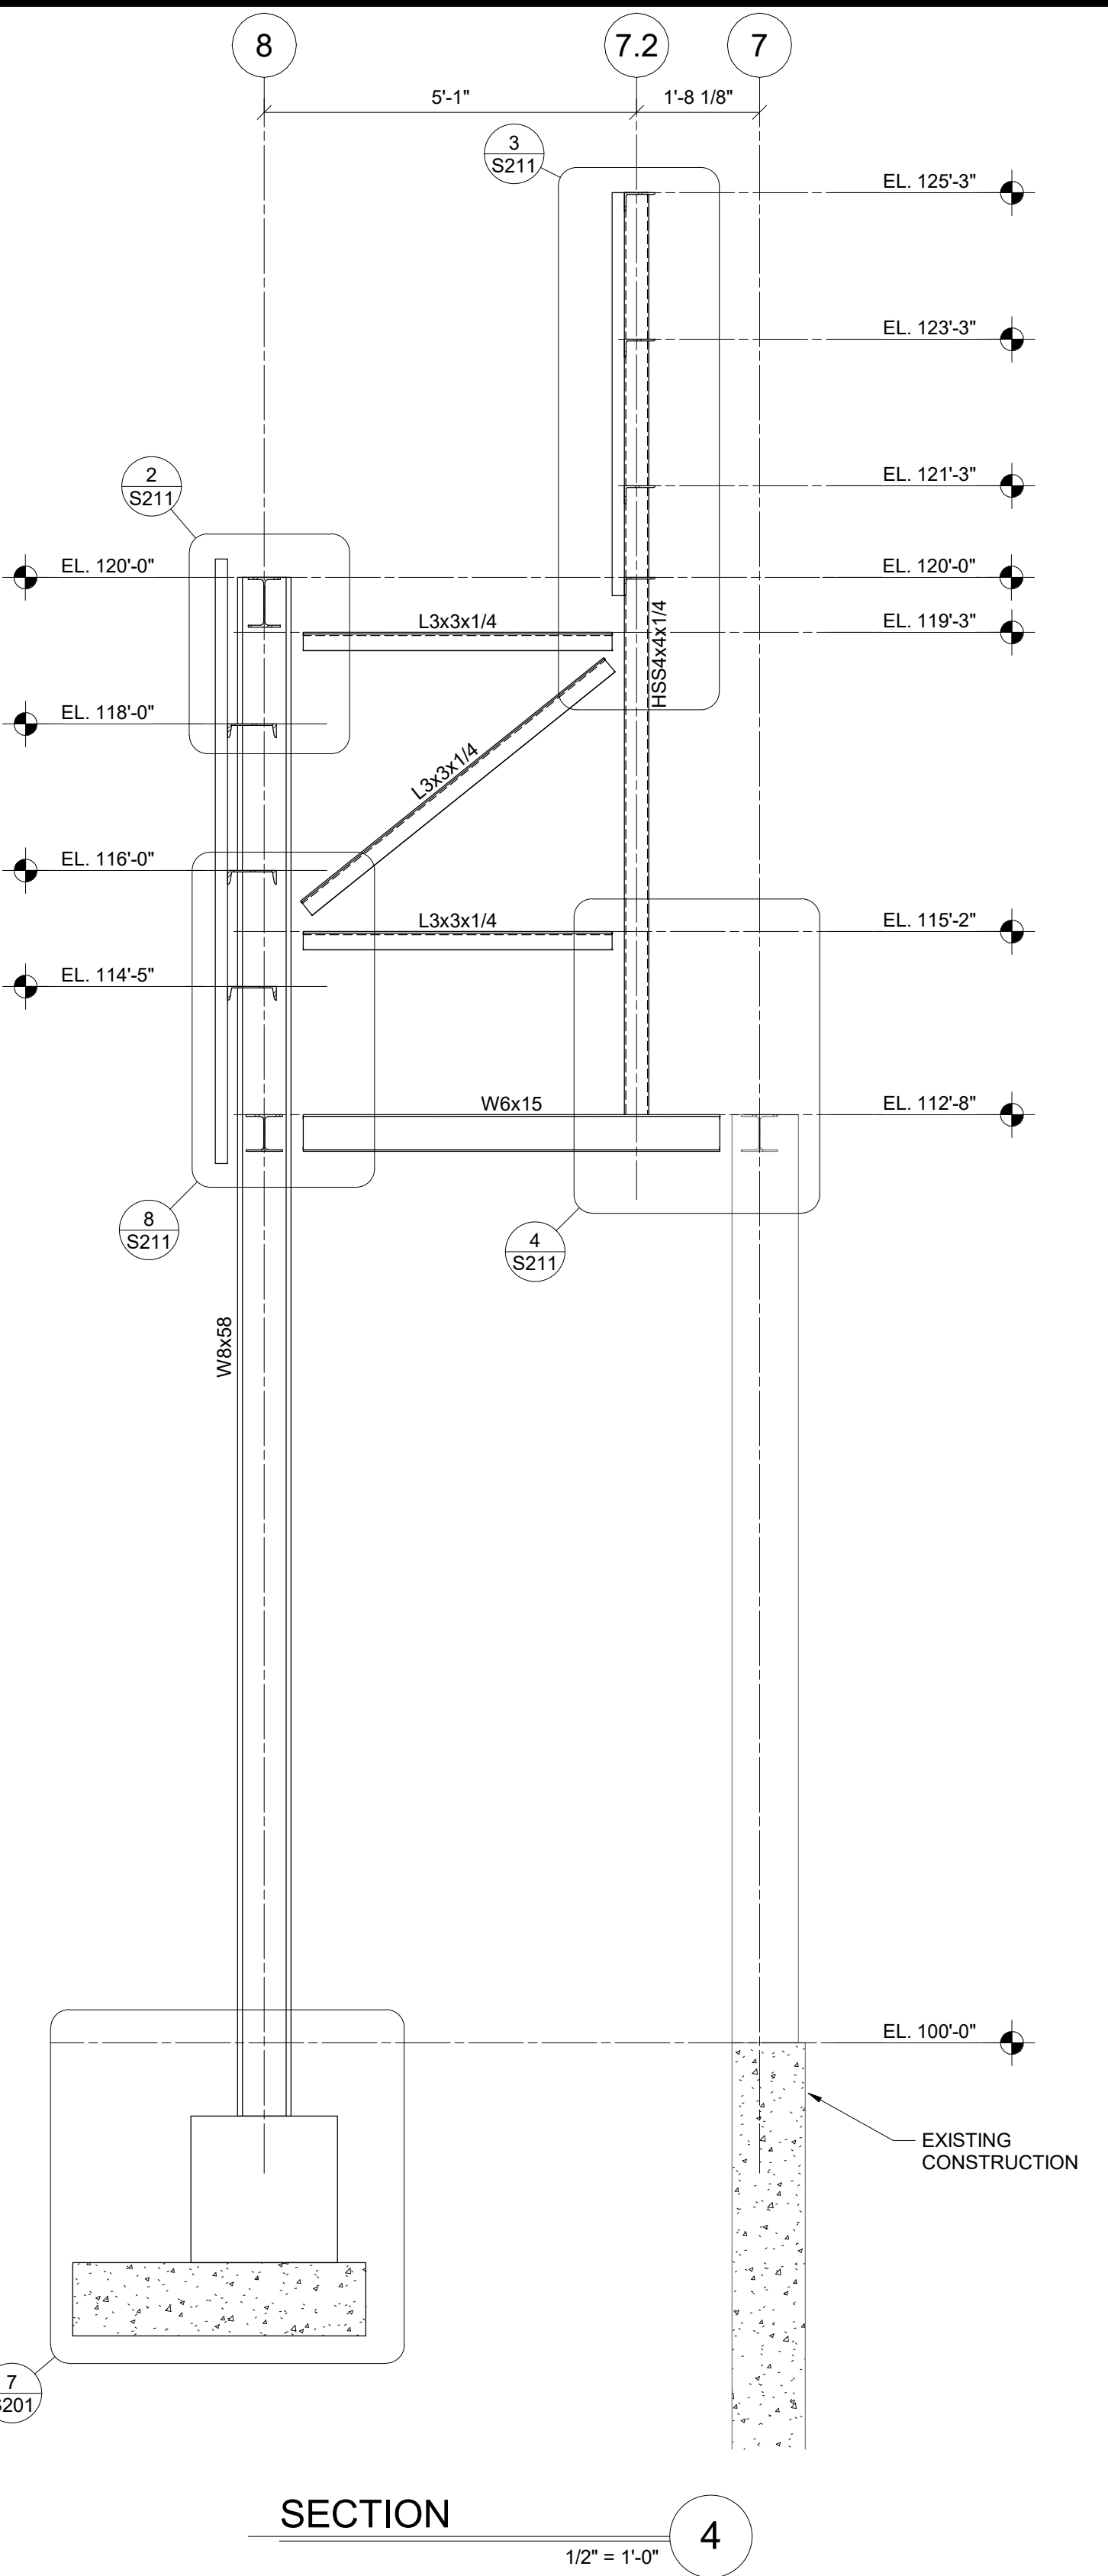

SECTION 6
1/2" = 1'-0"

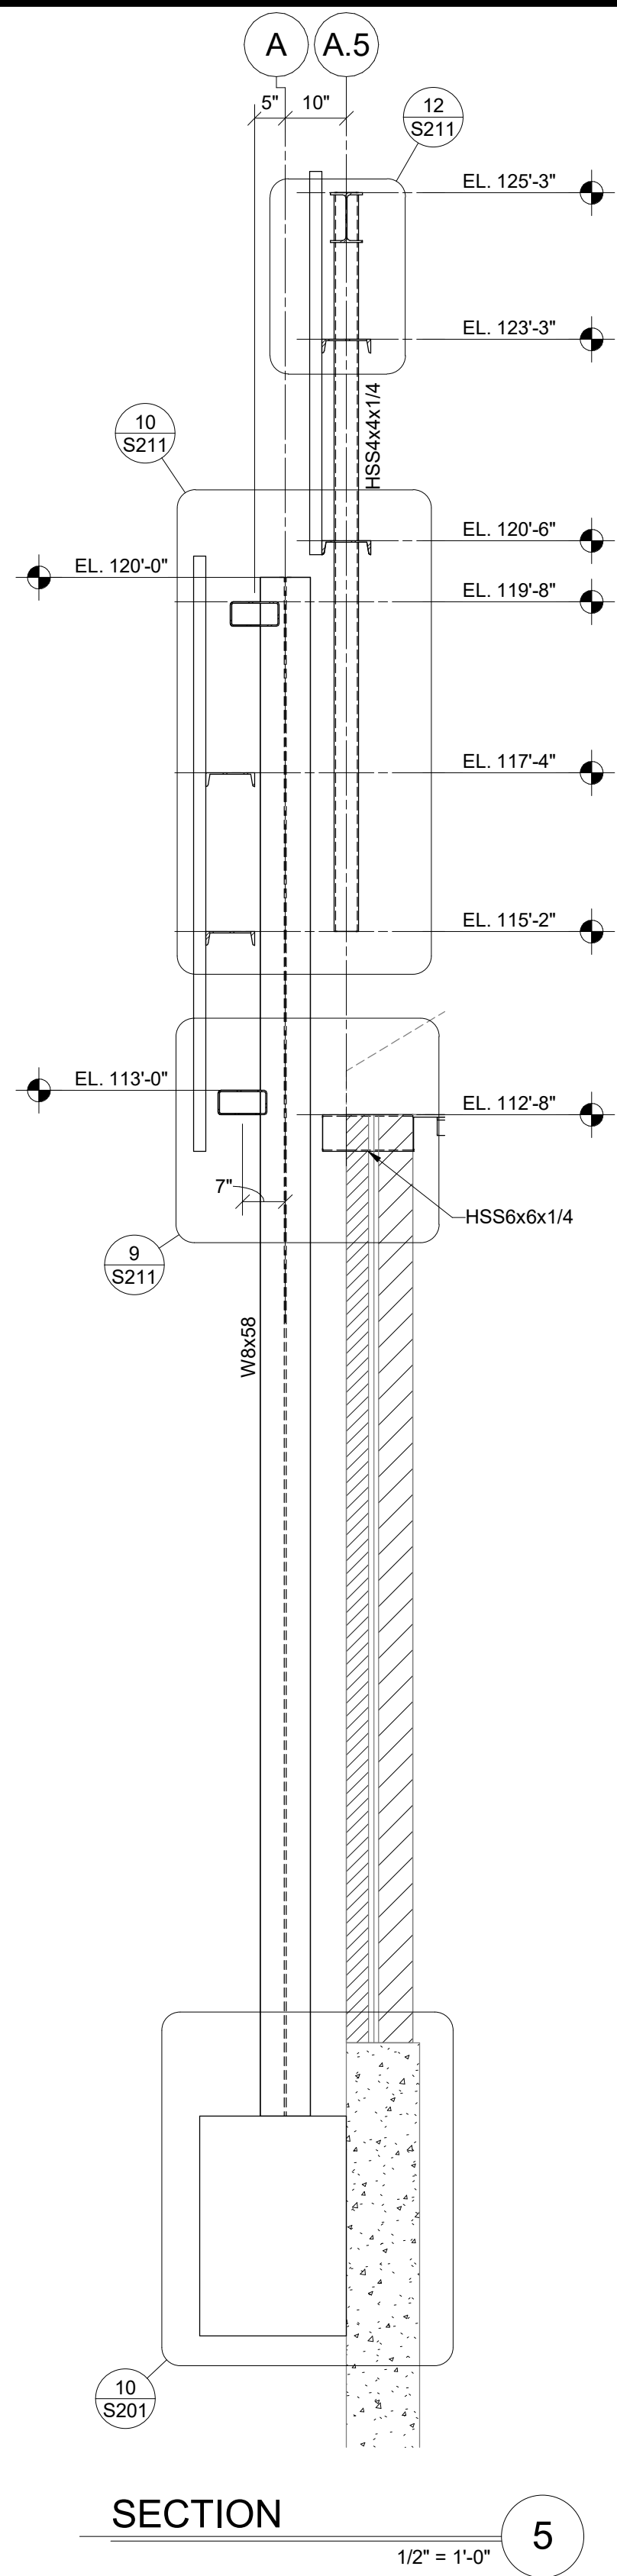

SECTION 7
1/2" = 1'-0"

#	DATE	CHANGE DESCRIPTION


RENOVATION OF HEARTLAND BANK DUBLIN
5303 FRANTZ ROAD,
DUBLIN OH - 43017
FOR
HEARTLAND BANK

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300 SPRUCE STREET
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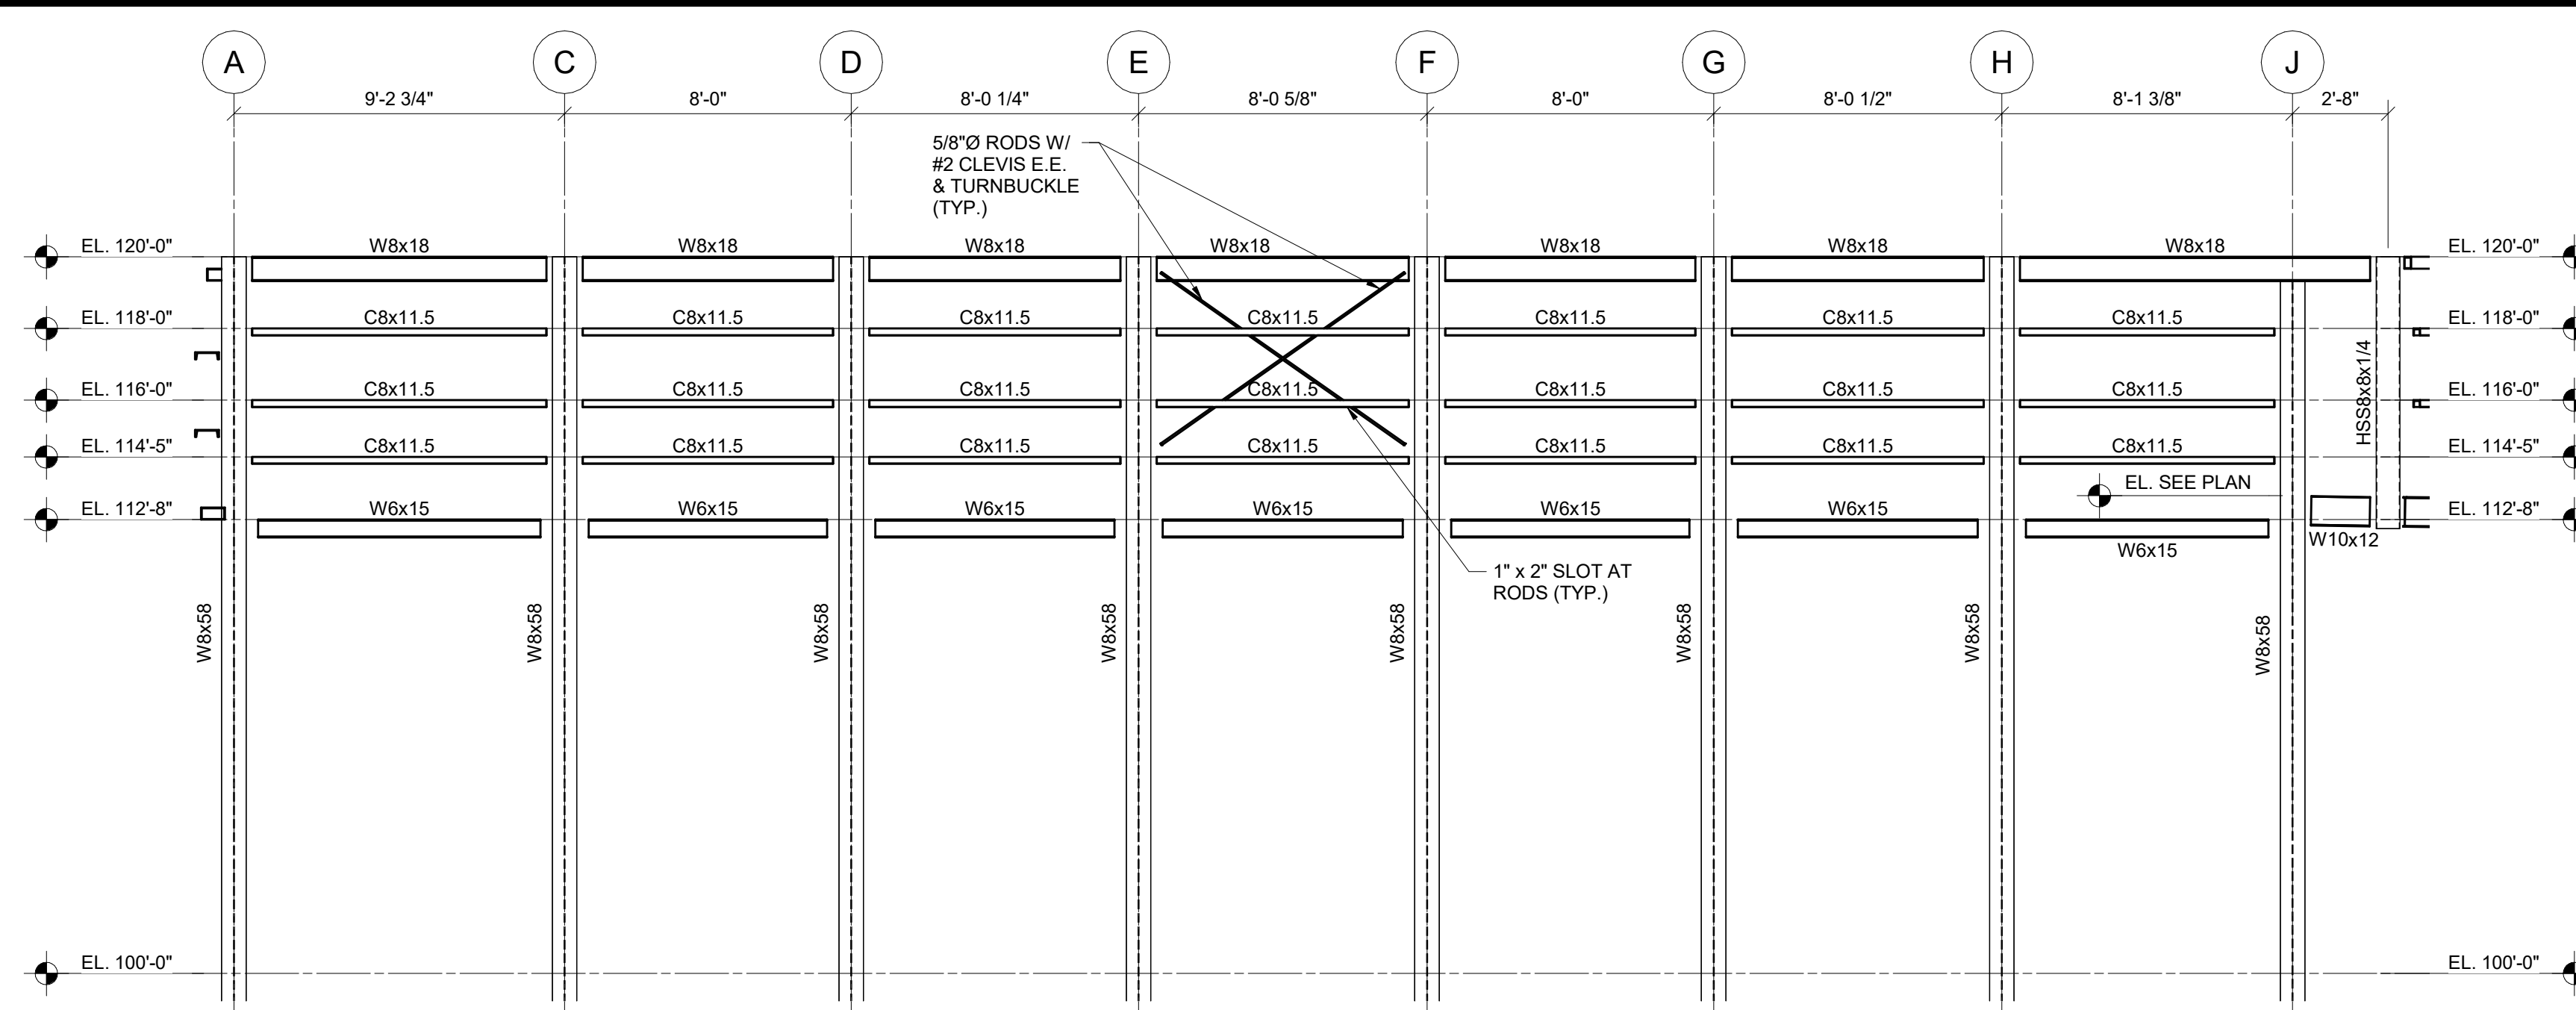
DRAWING TITLE:

FRAMING DETAILS


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	DRAWN BY: Author CHECKED BY: Checker
	20022
	S220
	FINAL DEVELOPMENT PLAN

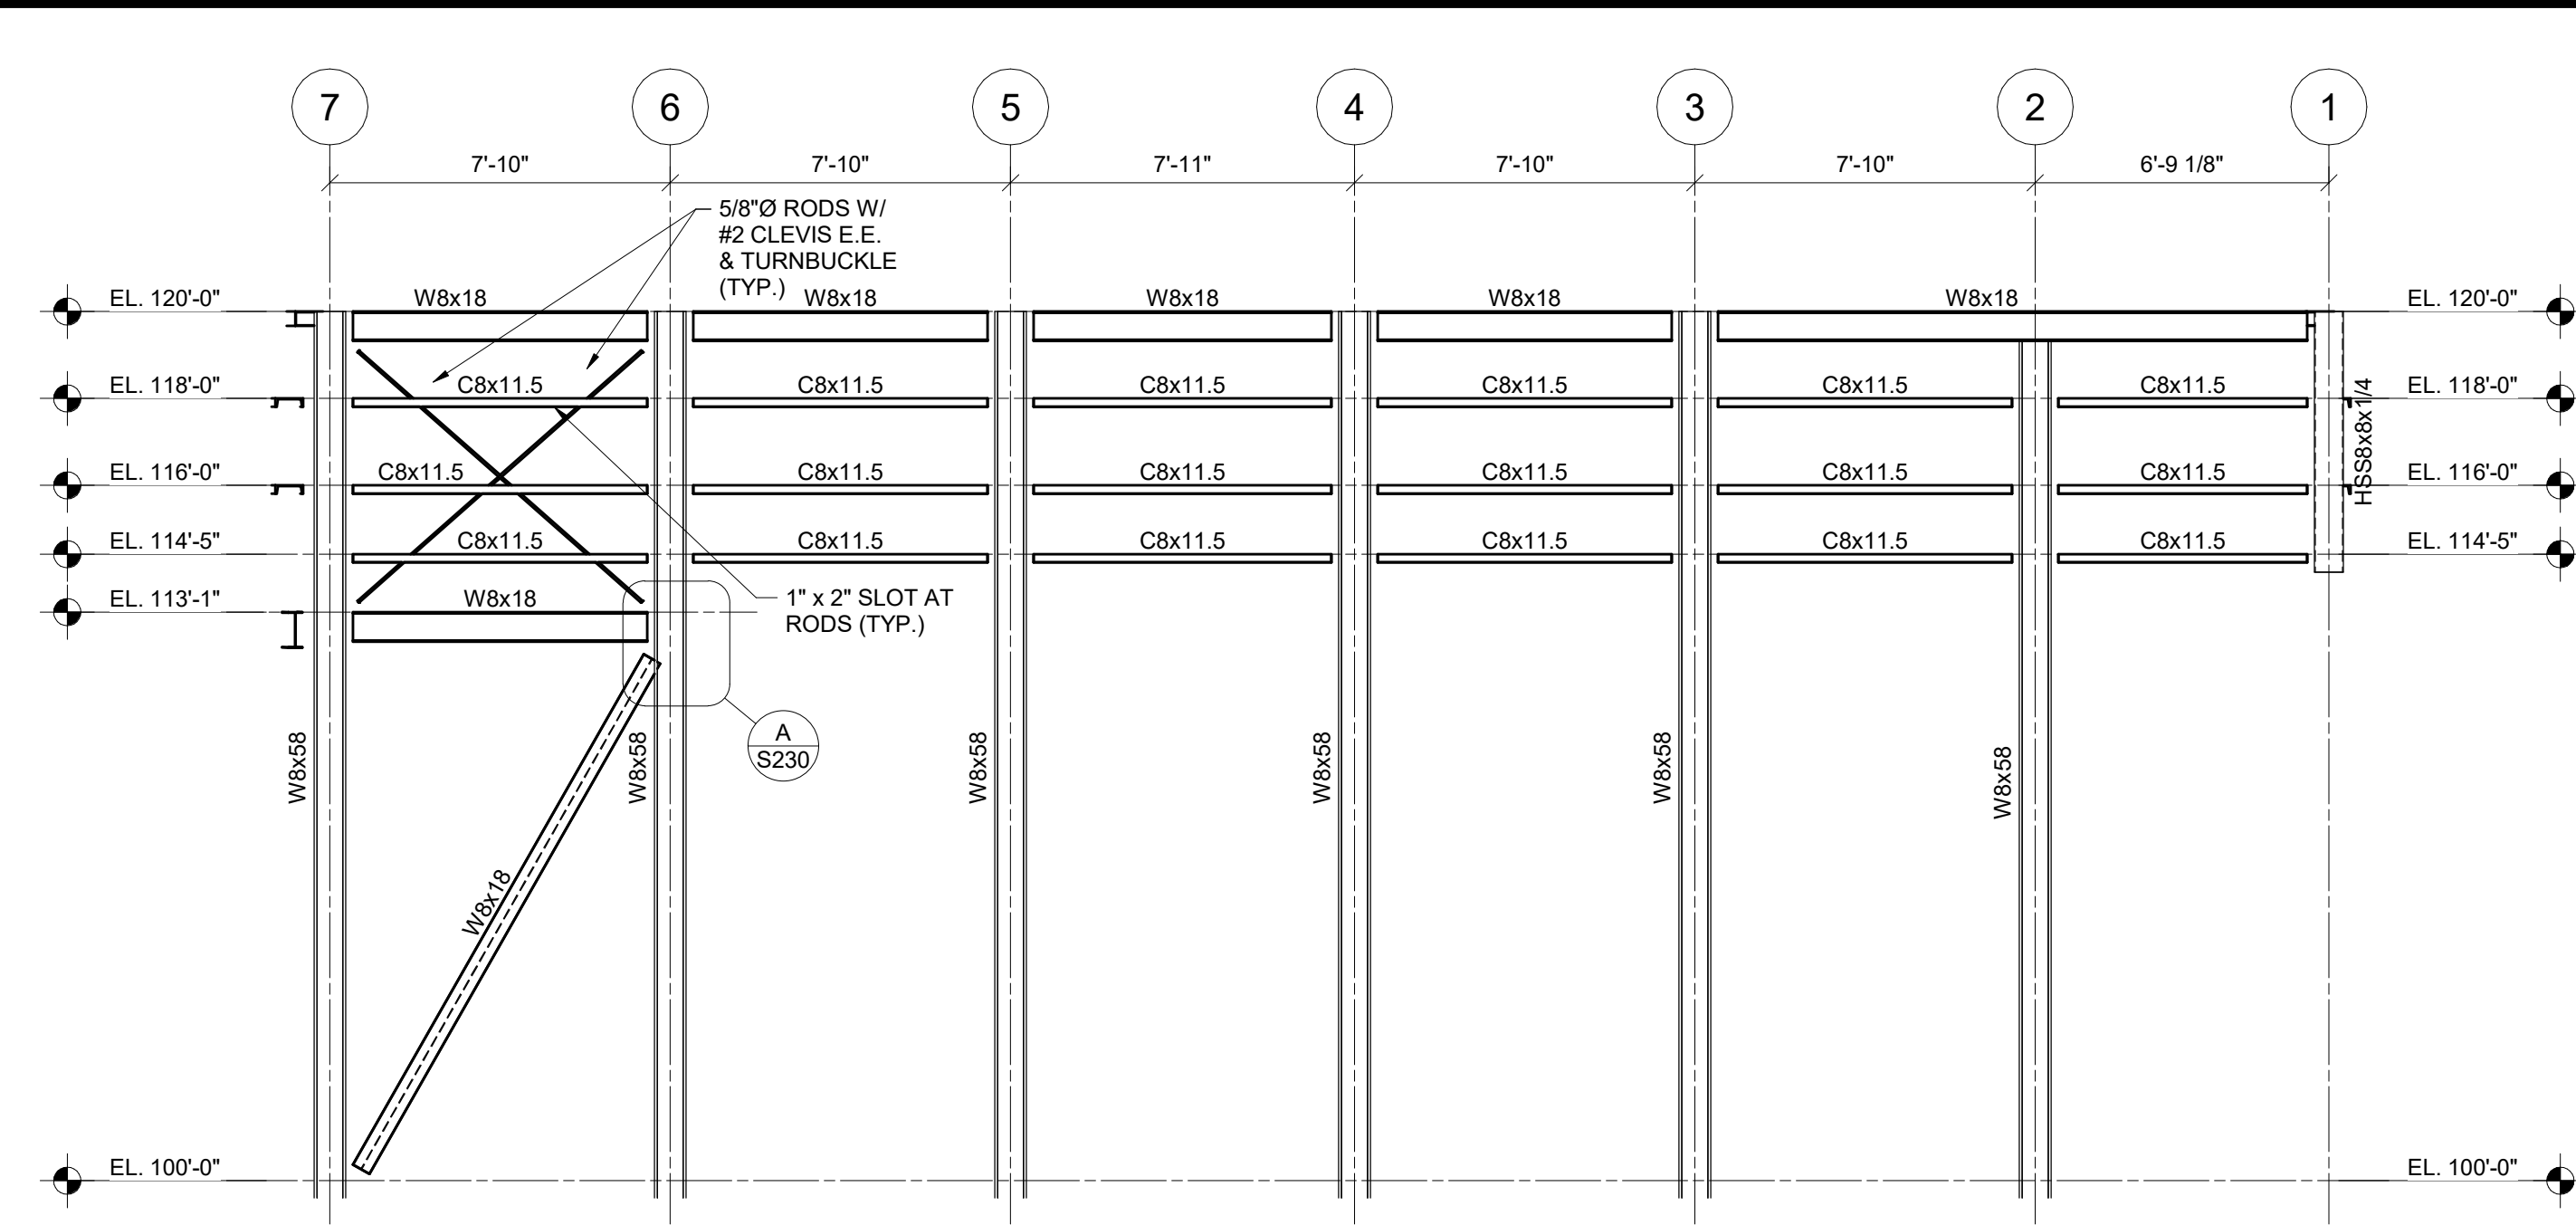


ELEVATION LINE K
1/4" = 1'-0"




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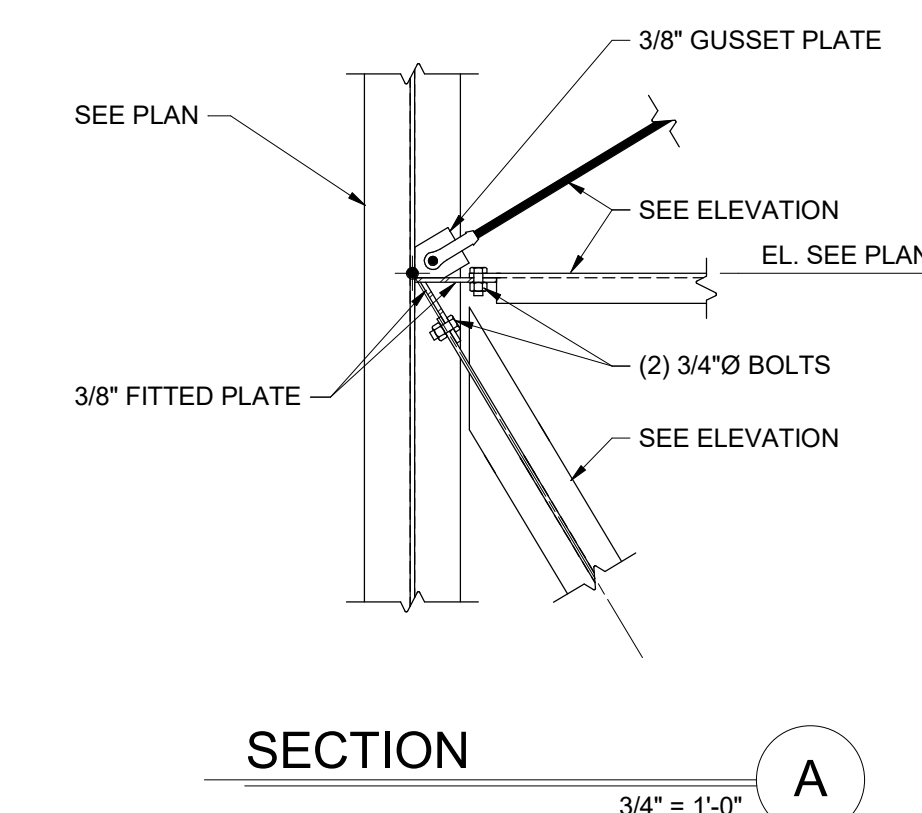
ELEVATION LINE 7.2
1/4" = 1'-0"

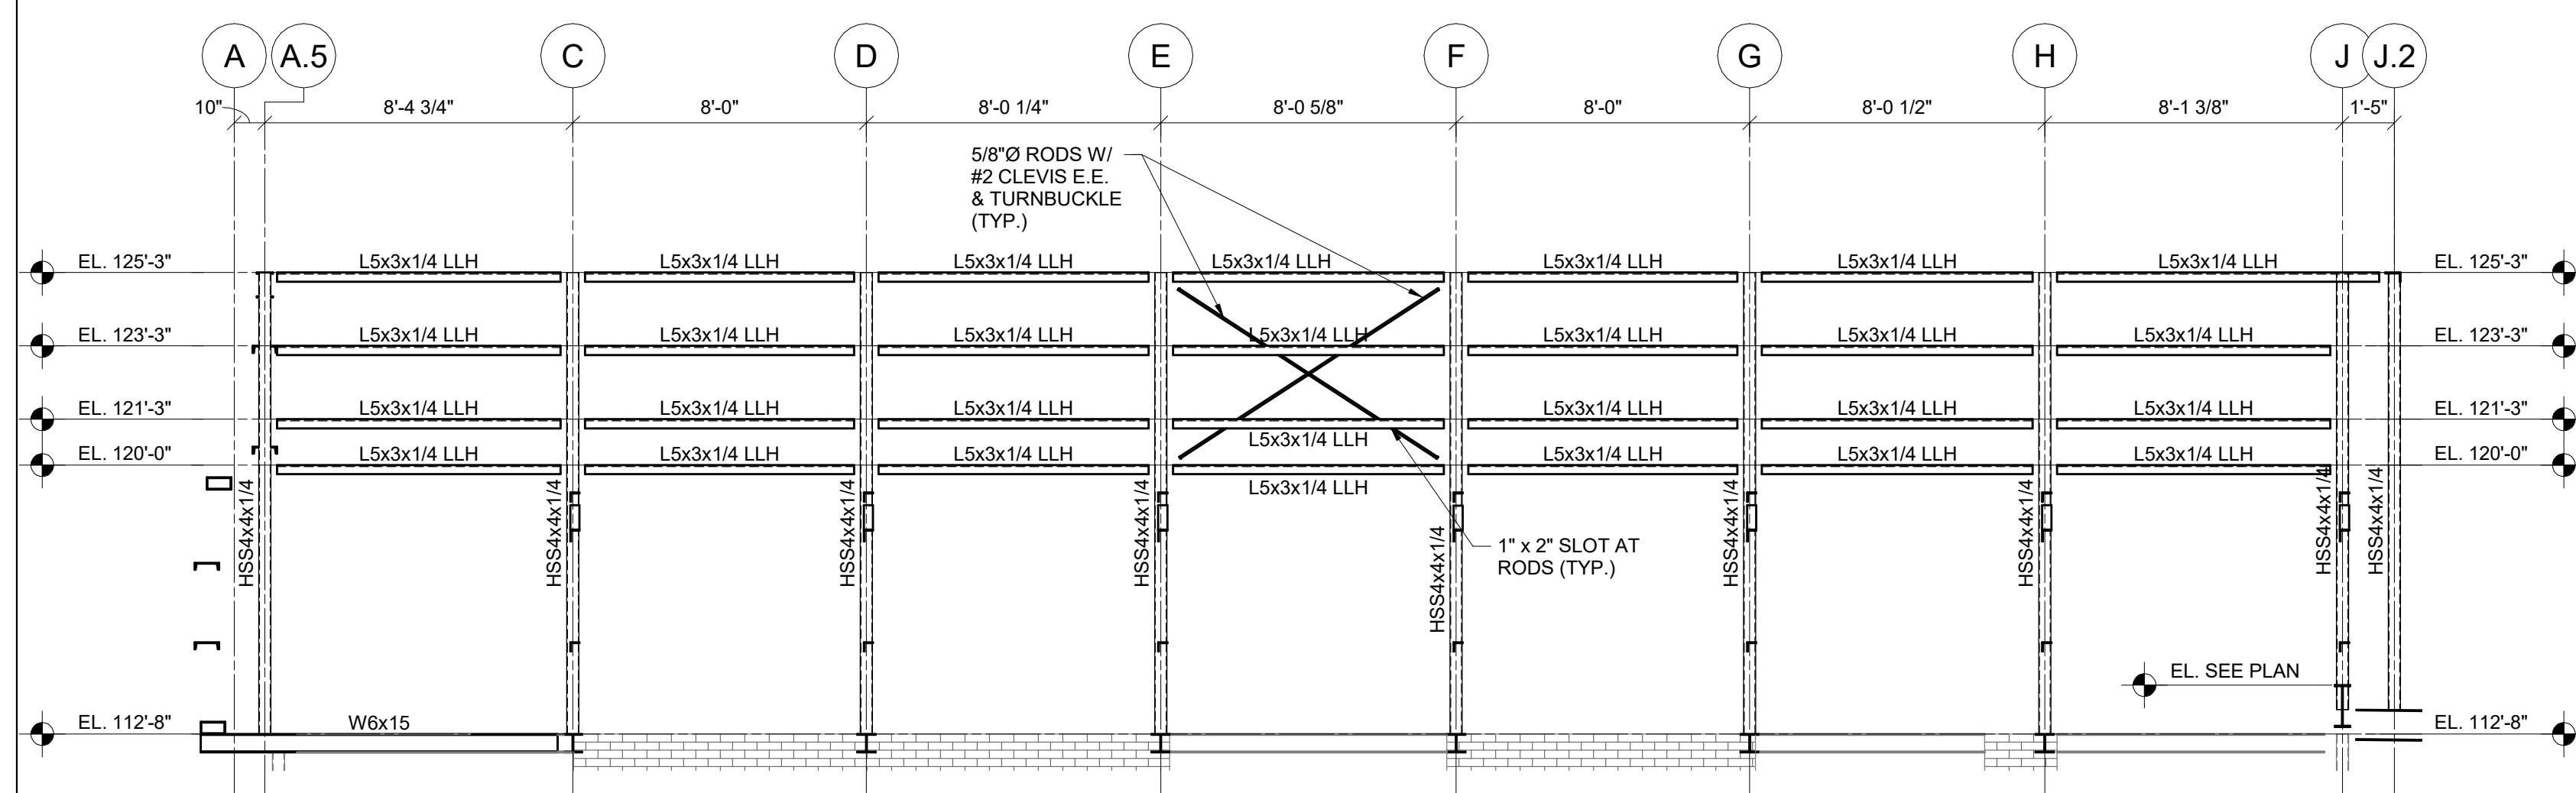

ELEVATION LINE A
1/4" = 1'-0"

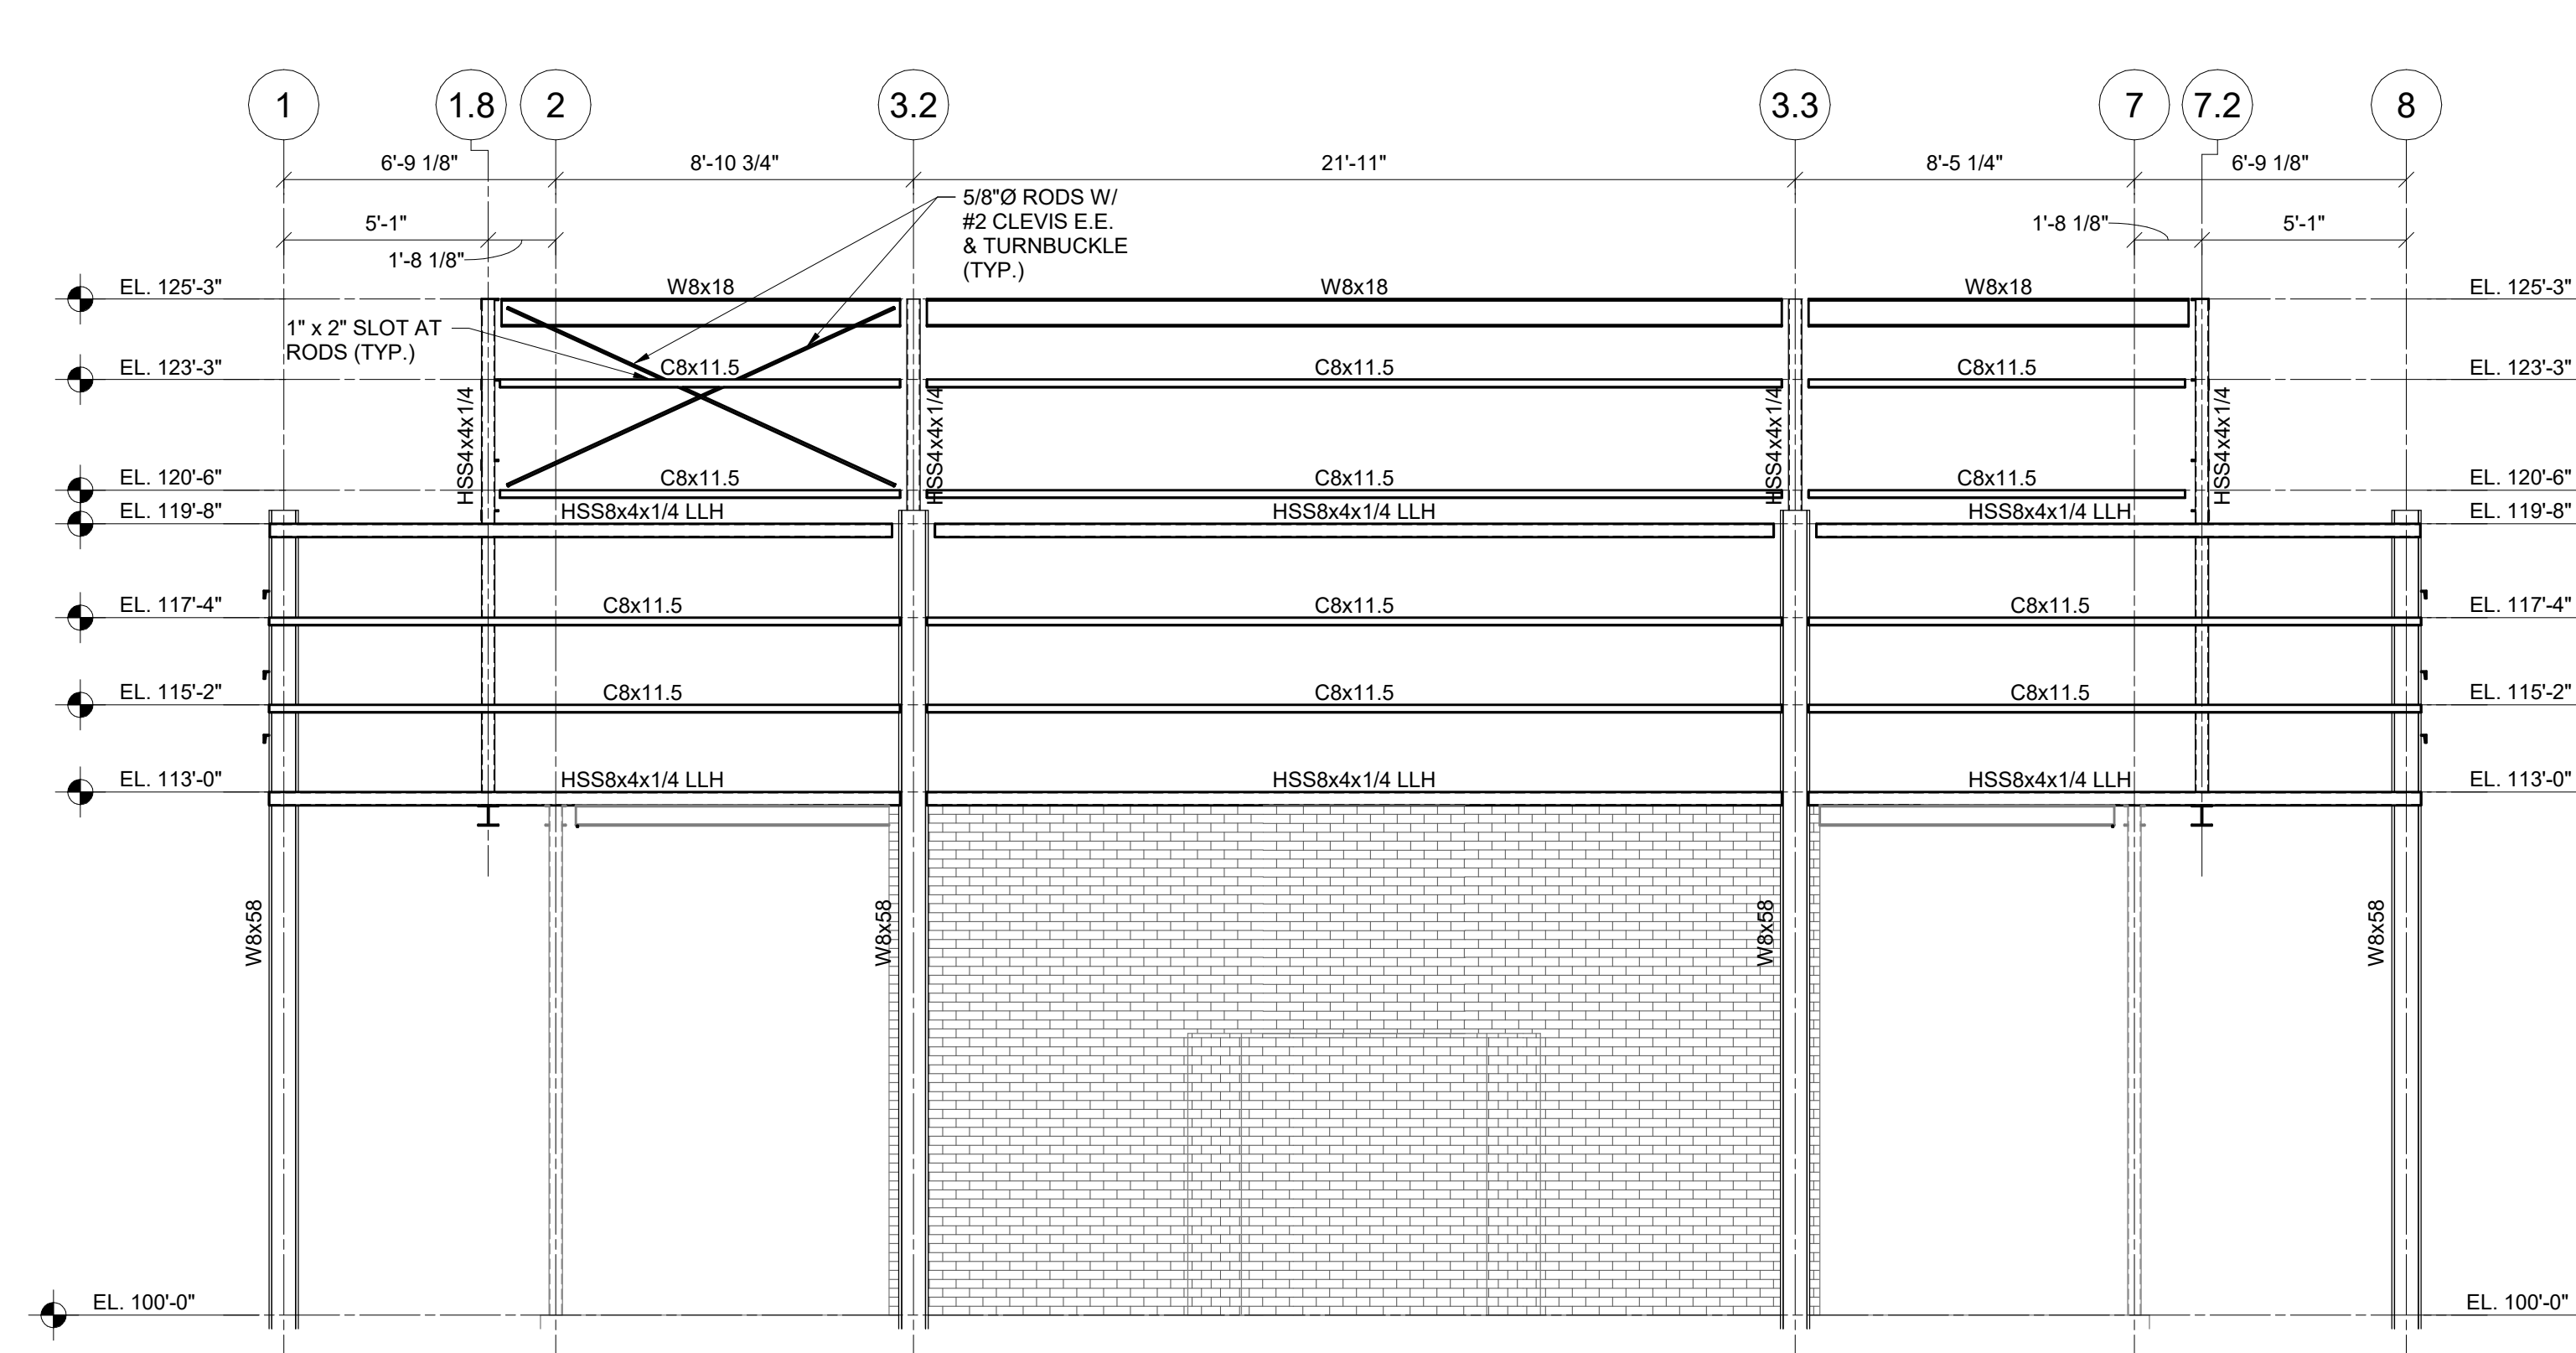

ELEVATION LINE 1
1/4" = 1'-0"

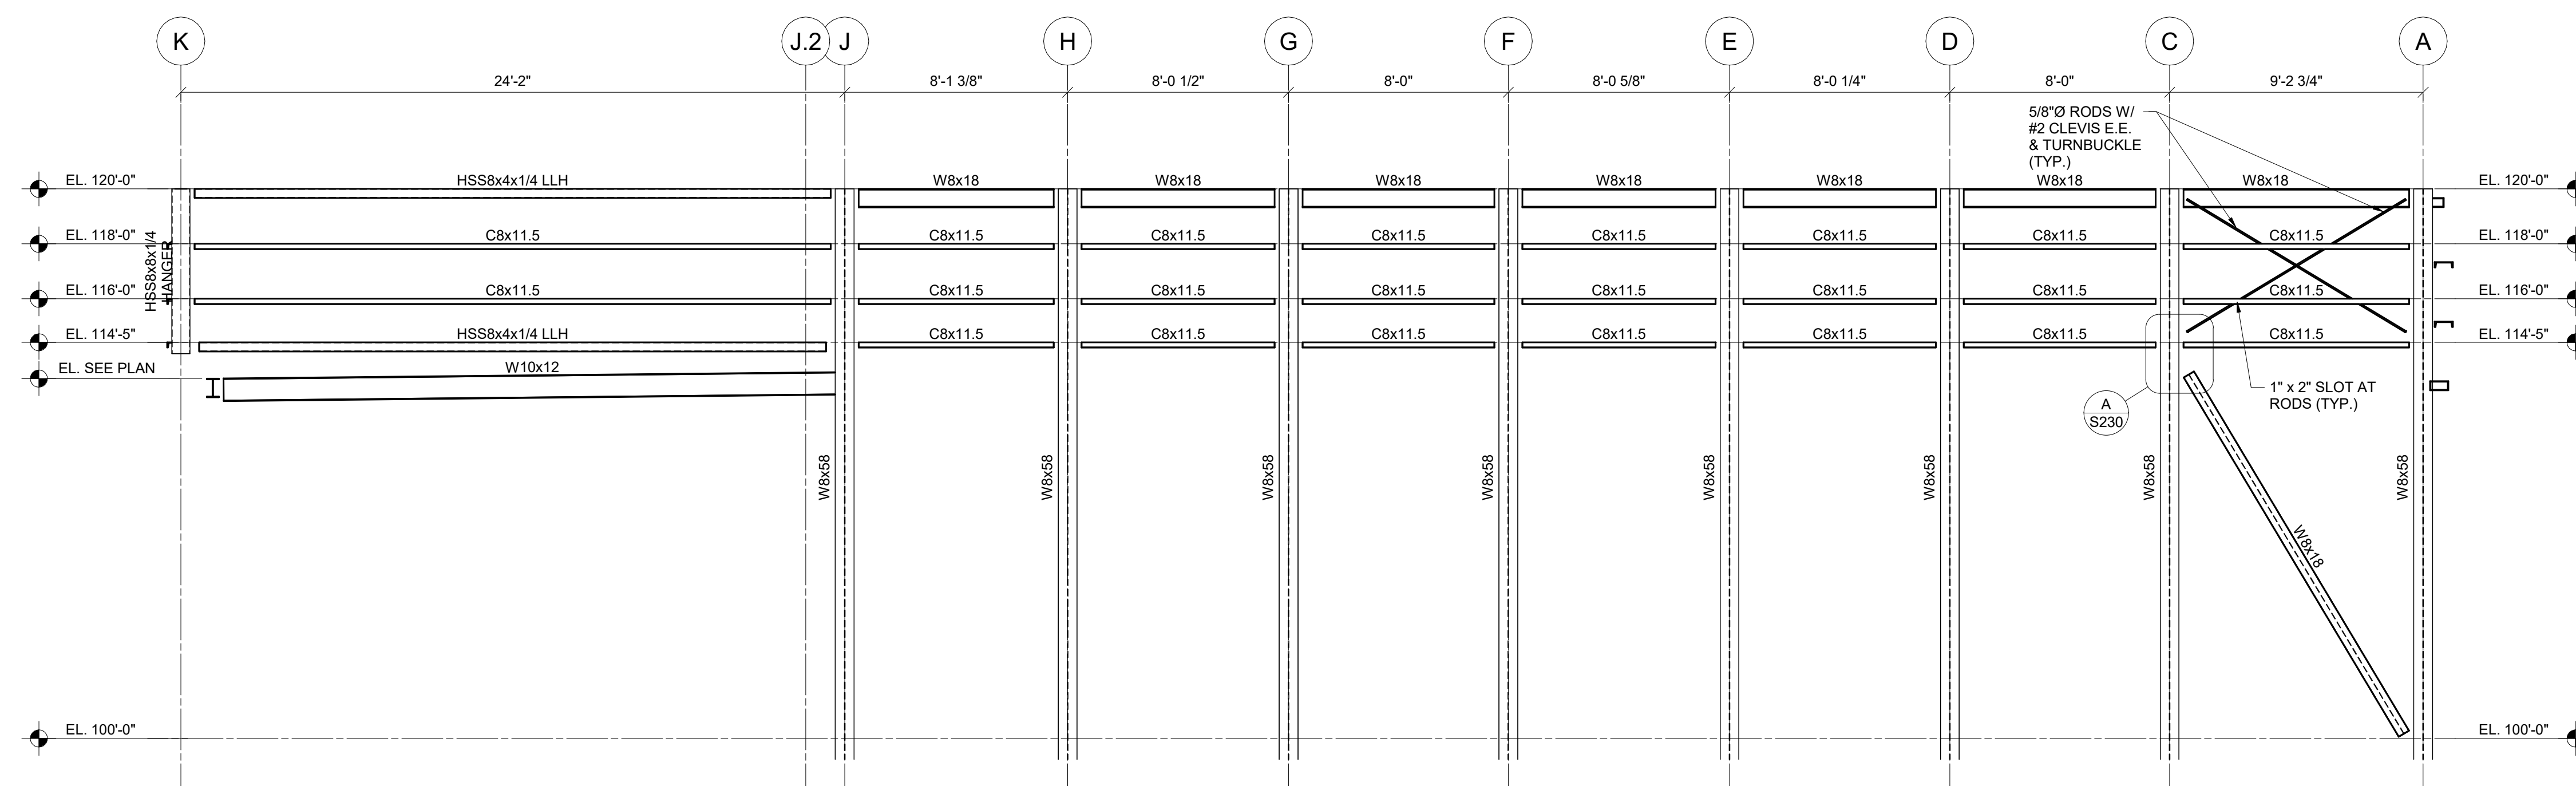

#	DATE	CHANGE DESCRIPTION

RENOVATION OF HEARTLAND BANK DUBLIN
5303 FRANTZ ROAD, DUBLIN OH - 43017
FOR HEARTLAND BANK

MOODY-NOLAN
300 SPRUCE STREET
SUITE 300
COLUMBUS, OHIO 43215
PHONE: (614) 461-4664
FAX: (614) 280-8881

DRAWING TITLE: **FRAMING ELEVATIONS**


11/30/2020
DRAWN BY: Author CHECKED BY: Checker

20022


S230

FINAL DEVELOPMENT PLAN

PROGRESS DRAWING NOT FOR CONSTRUCTION

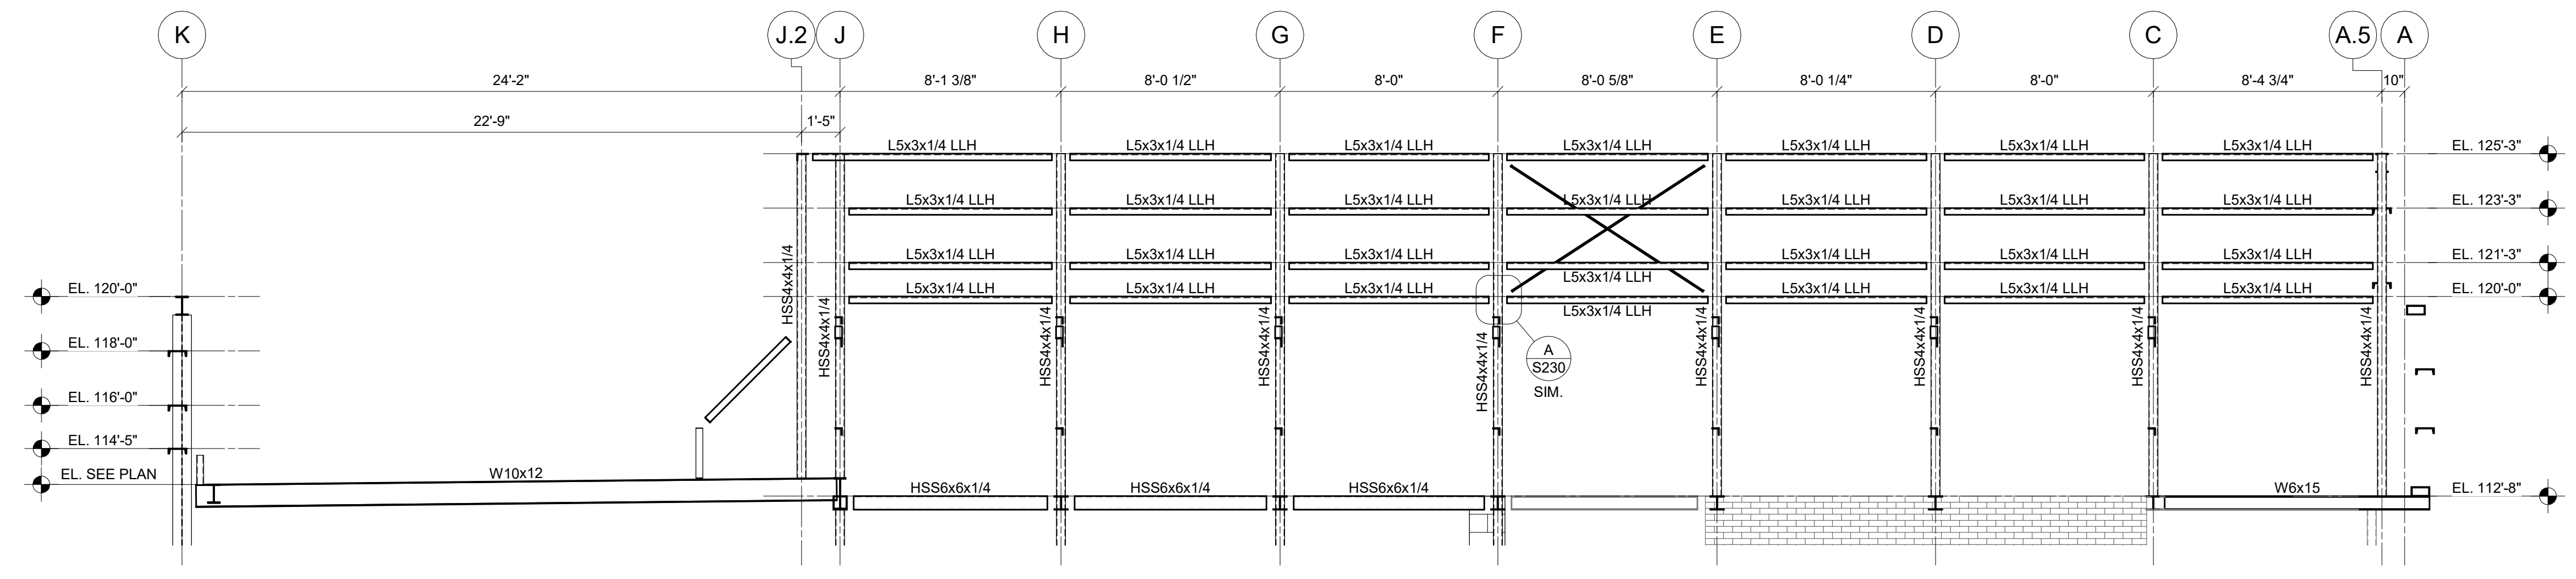

ELEVATION LINE 1.8
1/4" = 1'-0"

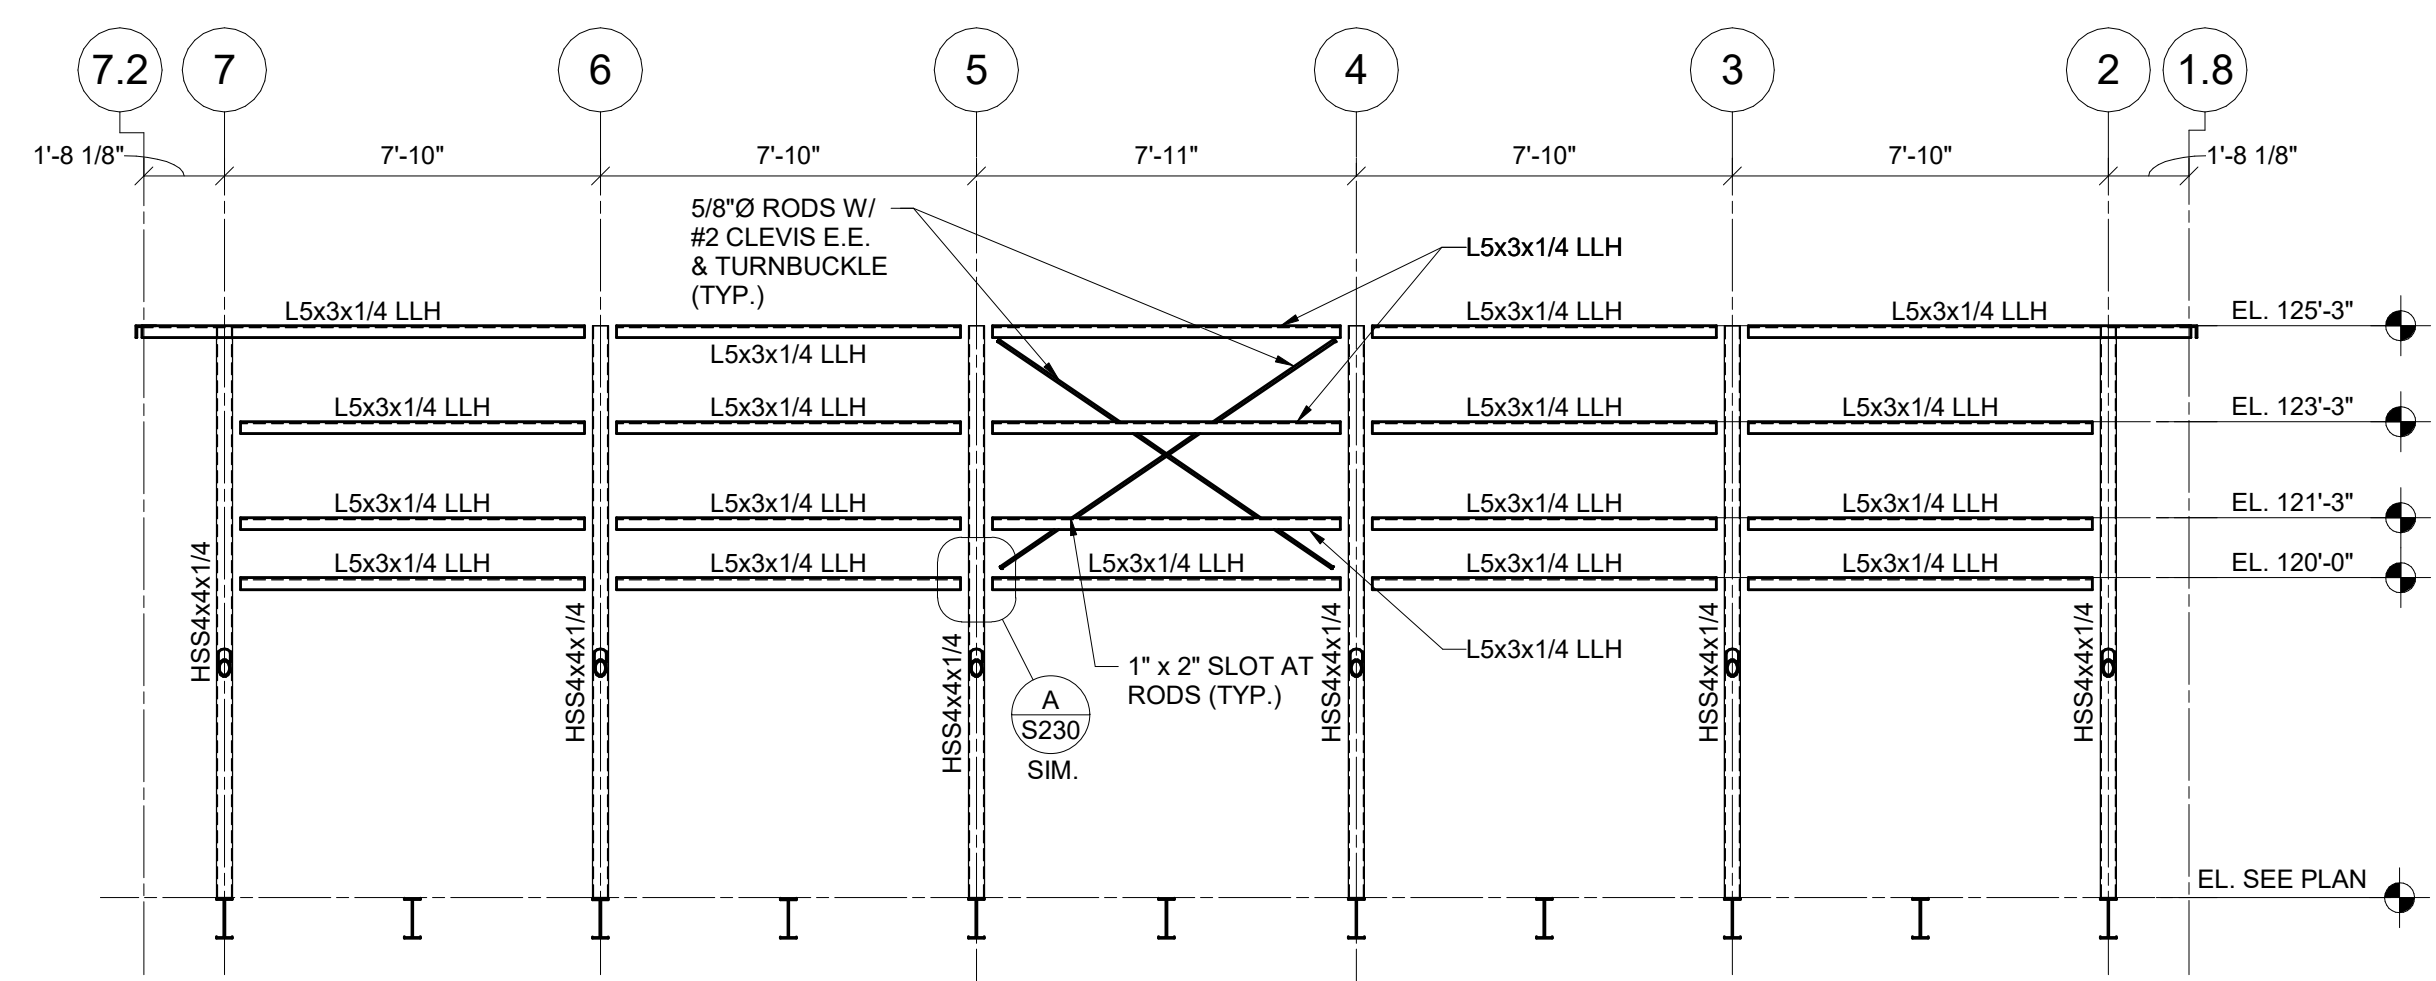

ELEVATION 2
1/4" = 1'-0"

#	DATE	CHANGE DESCRIPTION


RENOVATION OF HEARTLAND BANK DUBLIN
 6300 FRANTZ ROAD,
 DUBLIN OH - 43017
 FOR
HEARTLAND BANK

MOODY-NOLAN
 300 SPRUCE STREET
 SUITE 300
 COLUMBUS, OHIO 43215
 PHONE: (614) 461-4664
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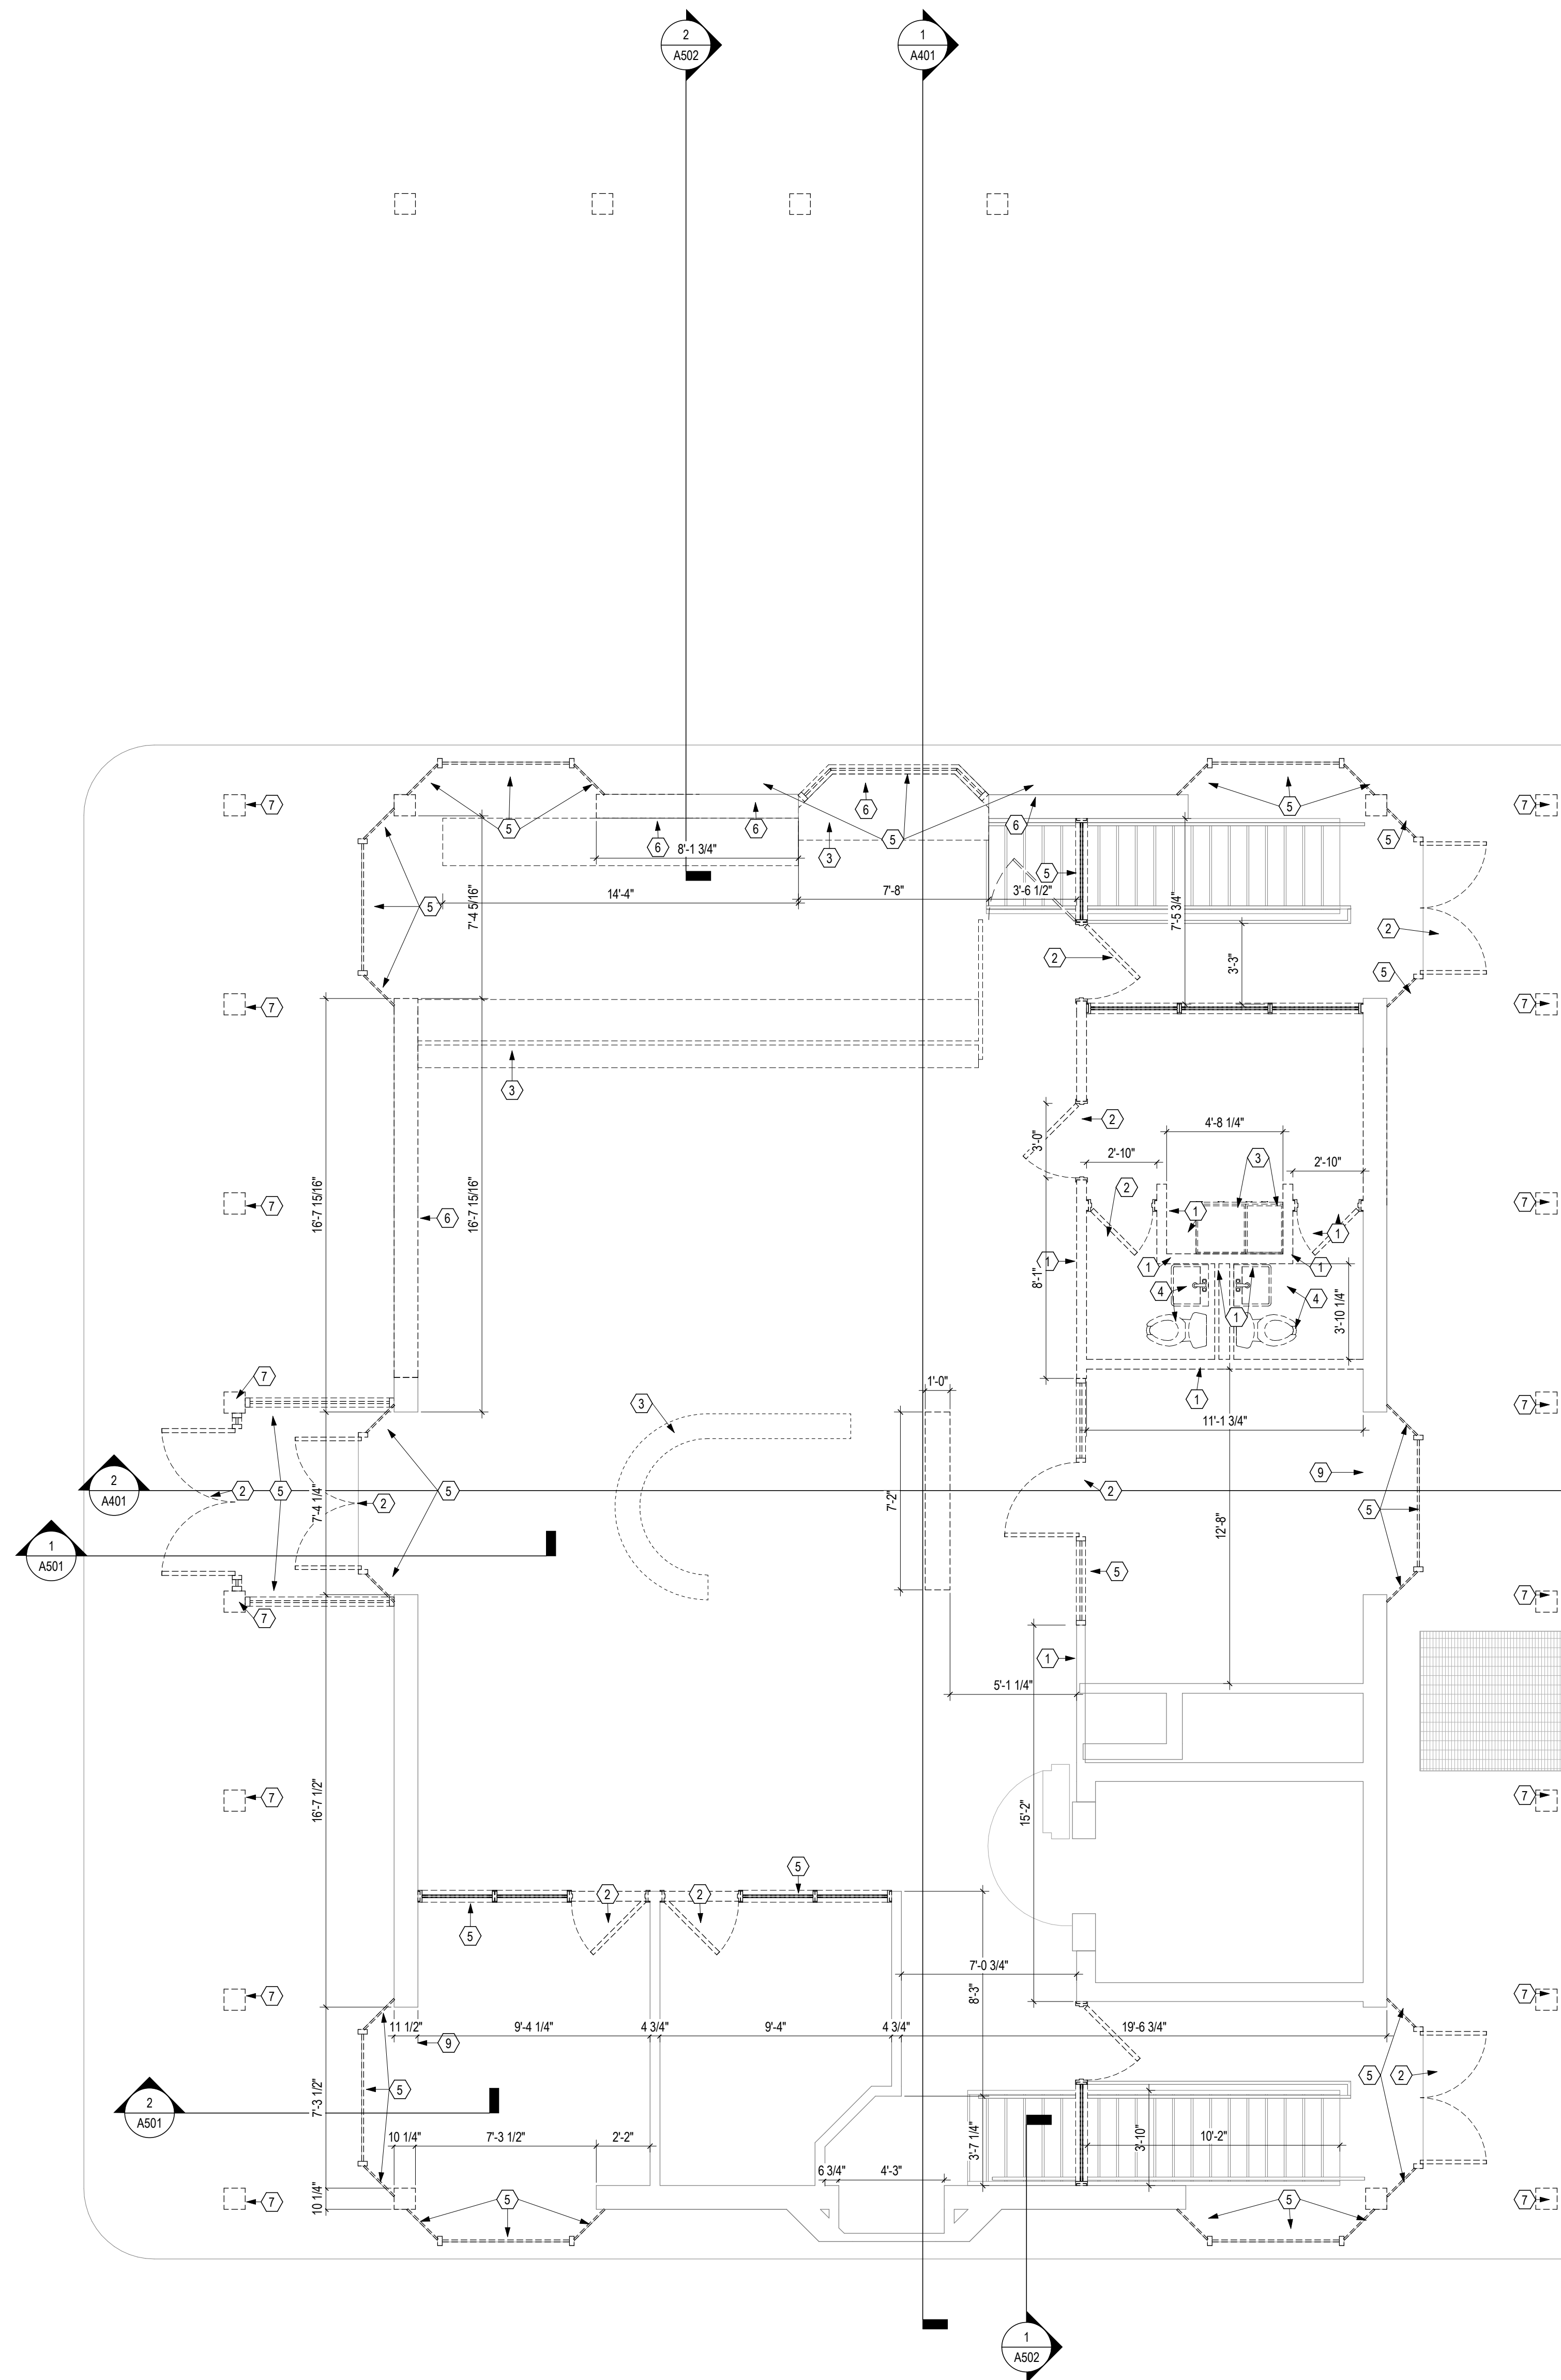
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FRAMING ELEVATIONS

PROGRESS DRAWING NOT FOR CONSTRUCTION	11/30/2020
	DRAWN BY: Author CHECKED BY: Checker
	20022
	S231

FINAL DEVELOPMENT PLAN

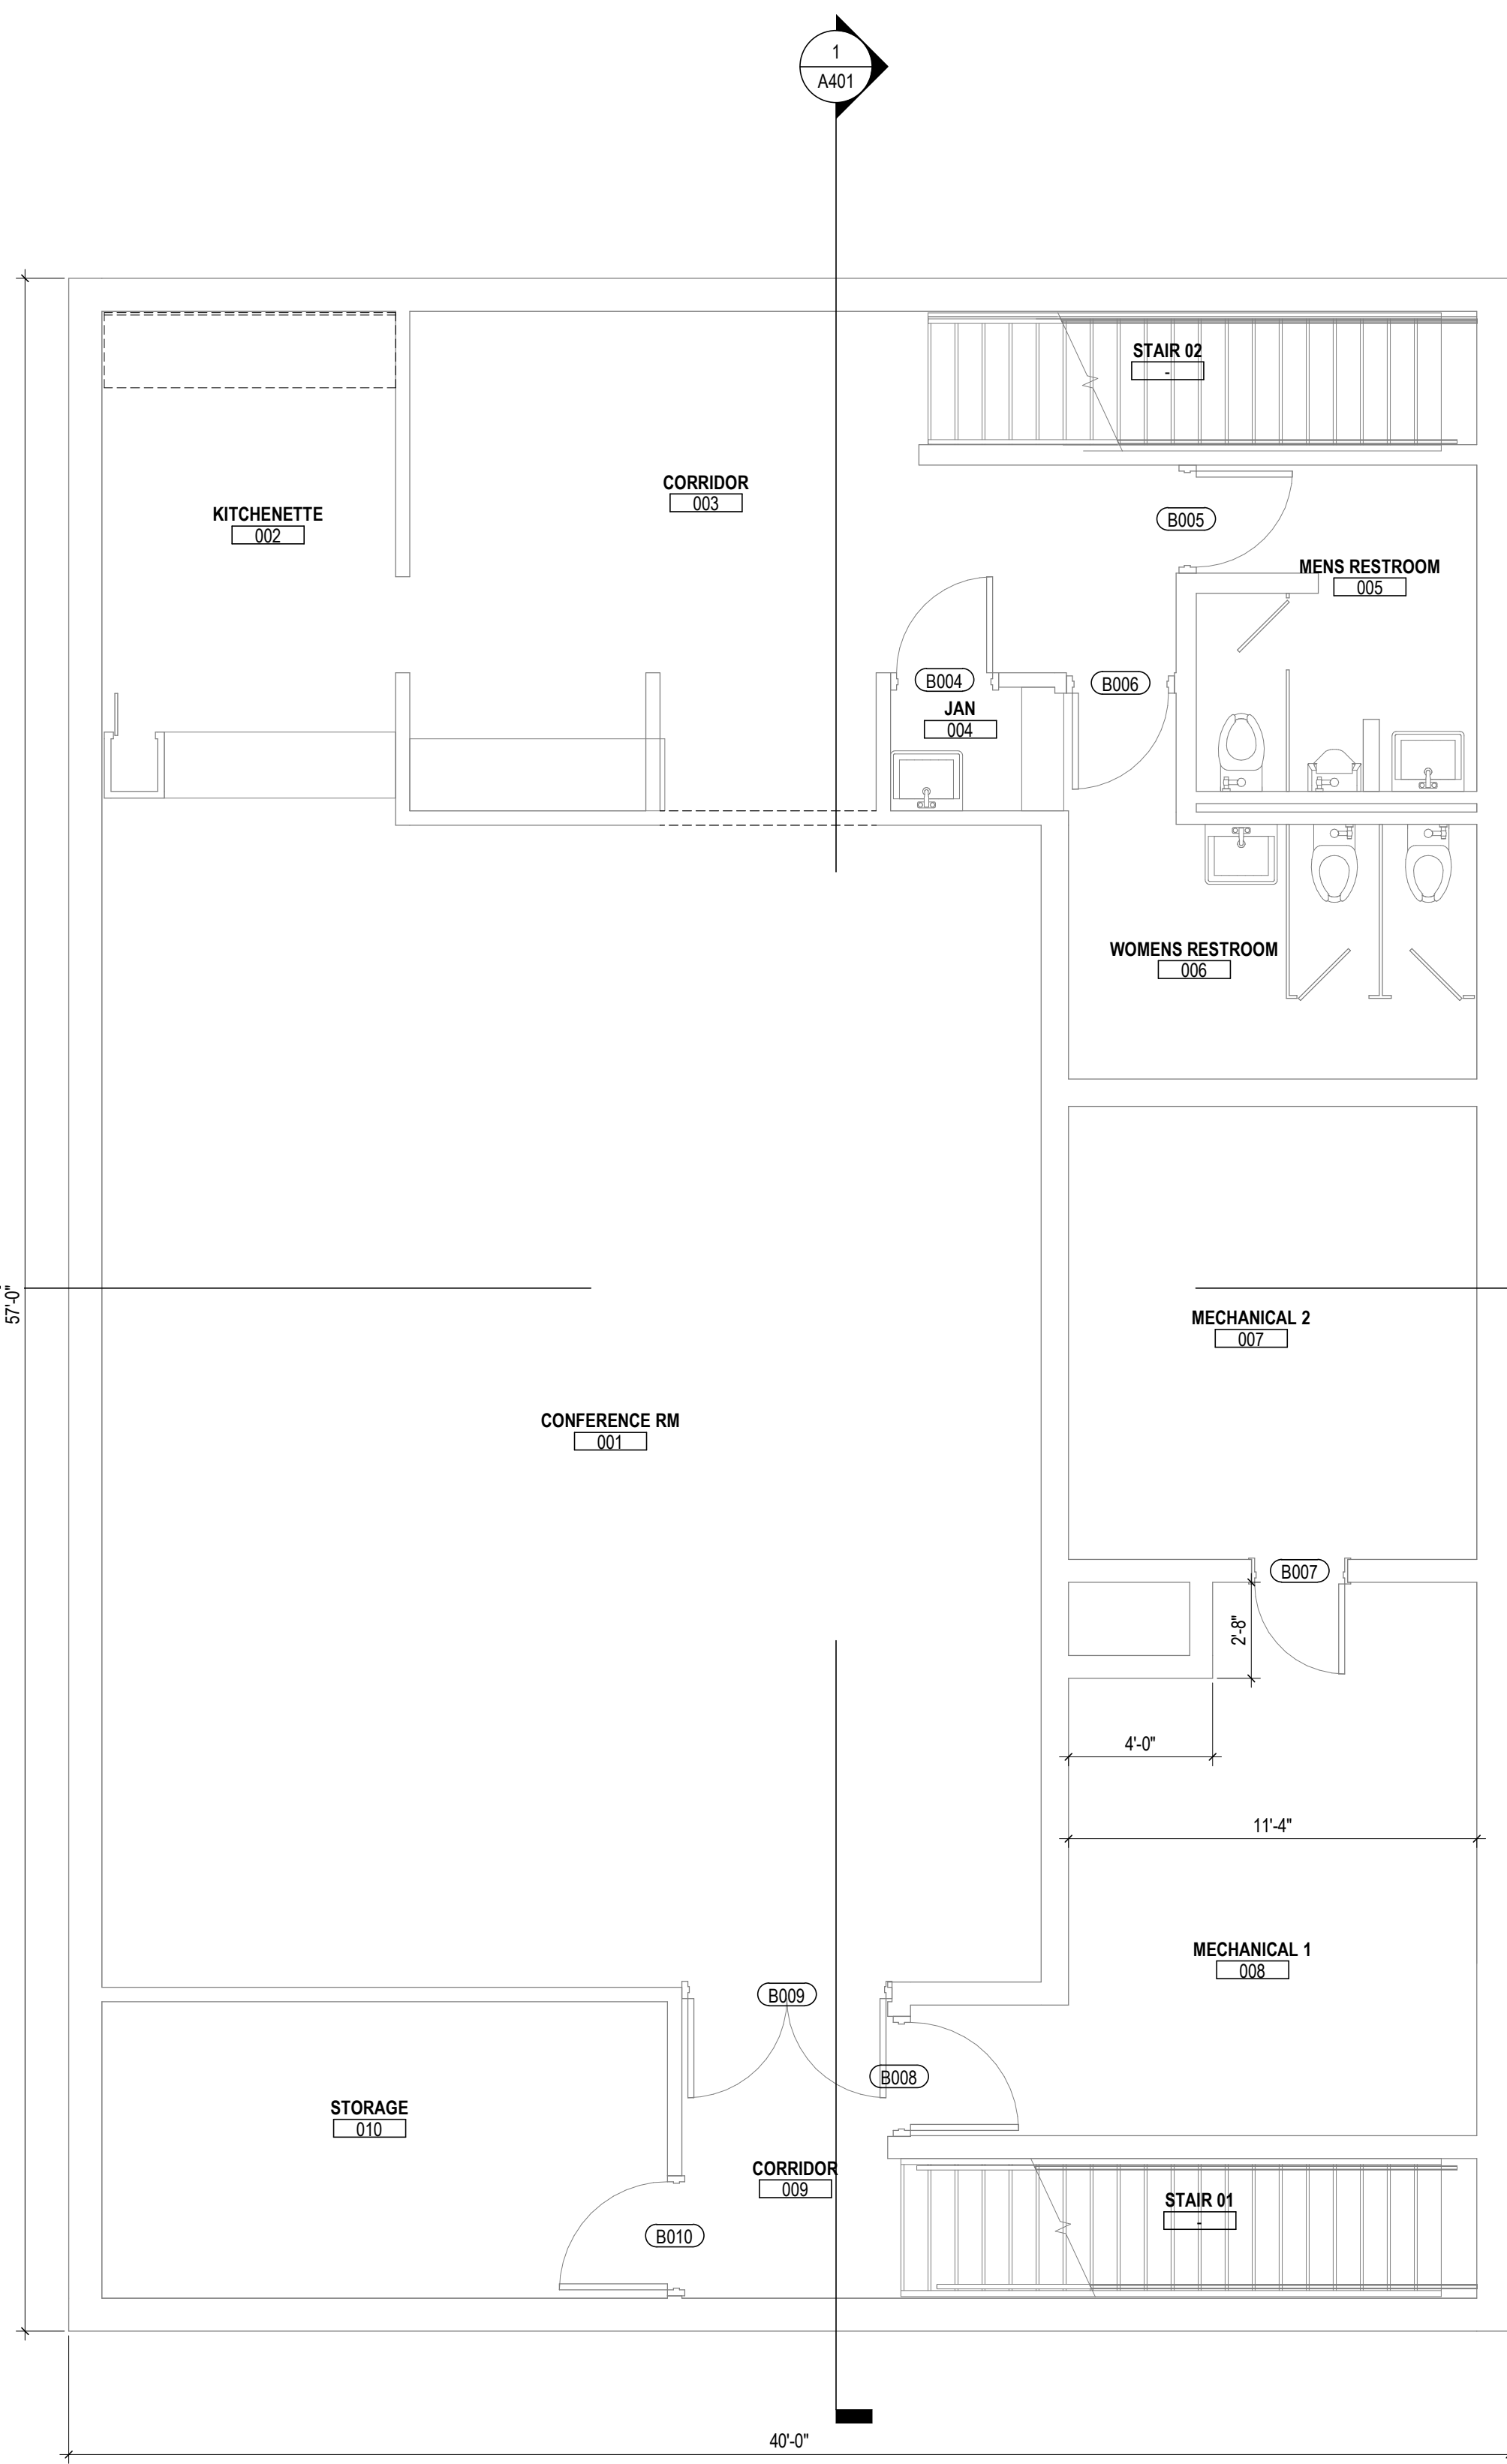

2 BASEMENT
 1/4" = 1'-0"



1 FIRST FLOOR
 1/4" = 1'-0"

GENERAL NOTES - DEMOLITION PLANS

DEMOLITION LEGEND

- XXX ROOM NUMBER
- CONSTRUCTION TO REMAIN
- - - CONSTRUCTION TO BE REMOVED
- DOOR TO REMAIN
- - - DOOR TO BE REMOVED

CODED DEMOLITION NOTES

1. REMOVE EXISTING WALL IN ITS ENTIRETY.
2. REMOVE EXISTING DOOR, HARDWARE AND FRAME IN ITS ENTIRETY.
3. REMOVE EXISTING CASEWORK IN ITS ENTIRETY.
4. REMOVE EXISTING PLUMBING FIXTURE, COORDINATE W/ RELATED WORK ON PLUMBING DRAWINGS.
5. REMOVE EXISTING STOREFRONT WINDOW.
6. REMOVE EXISTING EXTERIOR WALL.
7. REMOVE EXISTING WOOD COLUMNS. SEE STRUCTURAL.
8. REMOVE ENTIRE DRIVE-THRU ROOF. INCLUDES ALL ROOFING MATERIALS, DECKING, STRUCTURAL FRAMING. SEE STRUCTURAL DRAWINGS FOR ADDITIONAL INFORMATION.
9. REMOVE A PORTION OF EXISTING WALL.
10. REMOVE A PORTION OF THE CHIMNEY. HOW MUCH? - REVIEW W/ MECH.
11. REMOVE EAST & WEST PORCH ROOF CANOPIES ENTIRELY INCLUDING ROOFING, DECK AND STRUCTURAL FRAMING. SEE STRUCTURAL DRAWINGS FOR MODIFICATION OF EXISTING ROOF TRUSS CANTILEVER. SEE ROOF DETAILS FOR EXISTING BUILDING SLATE ROOFING TO REMAIN.
12. REMOVE EXISTING BAY WINDOW - WALL AND ROOF IN THEIR ENTIRETY.
13. REMOVE EXISTING FASCIA AND RECESSED GUTTER BACK TO ROOF RIM JOIST FRAMING.
14. EXISTING SLATE ROOFING TO REMAIN. REMOVE 1ST TWO COURSES OF ROOF SLATE FOR 1/2" IN TO NEW ROOFING. REPLACE ONLY ONE COURSE OF EXISTING SLATE OVER NEW ROOF OVERLAP. SEE ROOFING DETAILS.

#	DATE	CHANGE DESCRIPTION

RENOVATION OF HEARTLAND BANK DUBLIN
 5303 PRANTZ ROAD
 DUBLIN, OH 43017
 FOR
HEARTLAND BANK

MOODY-NOLAN
 300 SPRUCE STREET
 SUITE 300
 COLUMBUS, OHIO 43215
 PHONE: (614) 461-4664
 FAX: (614) 280-8881

DRAWING TITLE:

DEMO PLAN

PROGRESS DRAWING
 NOT FOR CONSTRUCTION


11/30/2020

DRAWN BY: Author CHECKED BY: Checker

20022


AD101

FINAL DEVELOPMENT PLAN

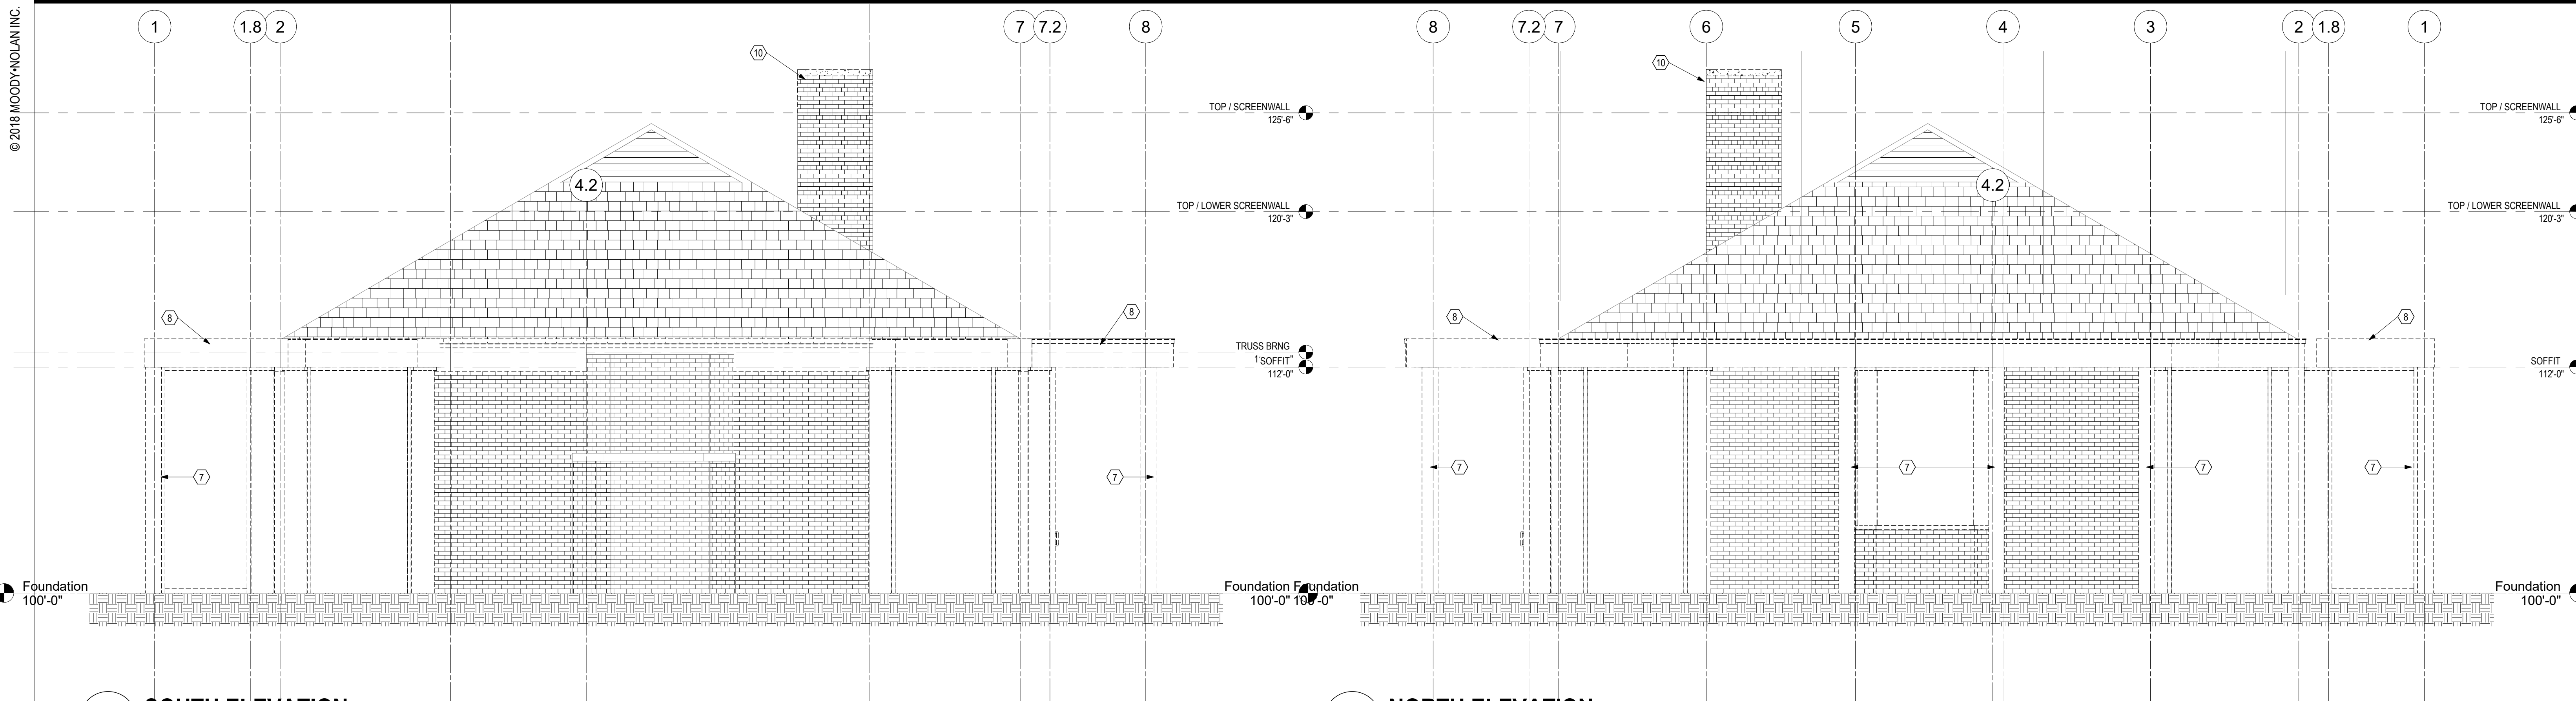


3 SOUTH ELEVATION
1/4" = 1'-0"

2 NORTH ELEVATION
1/4" = 1'-0"

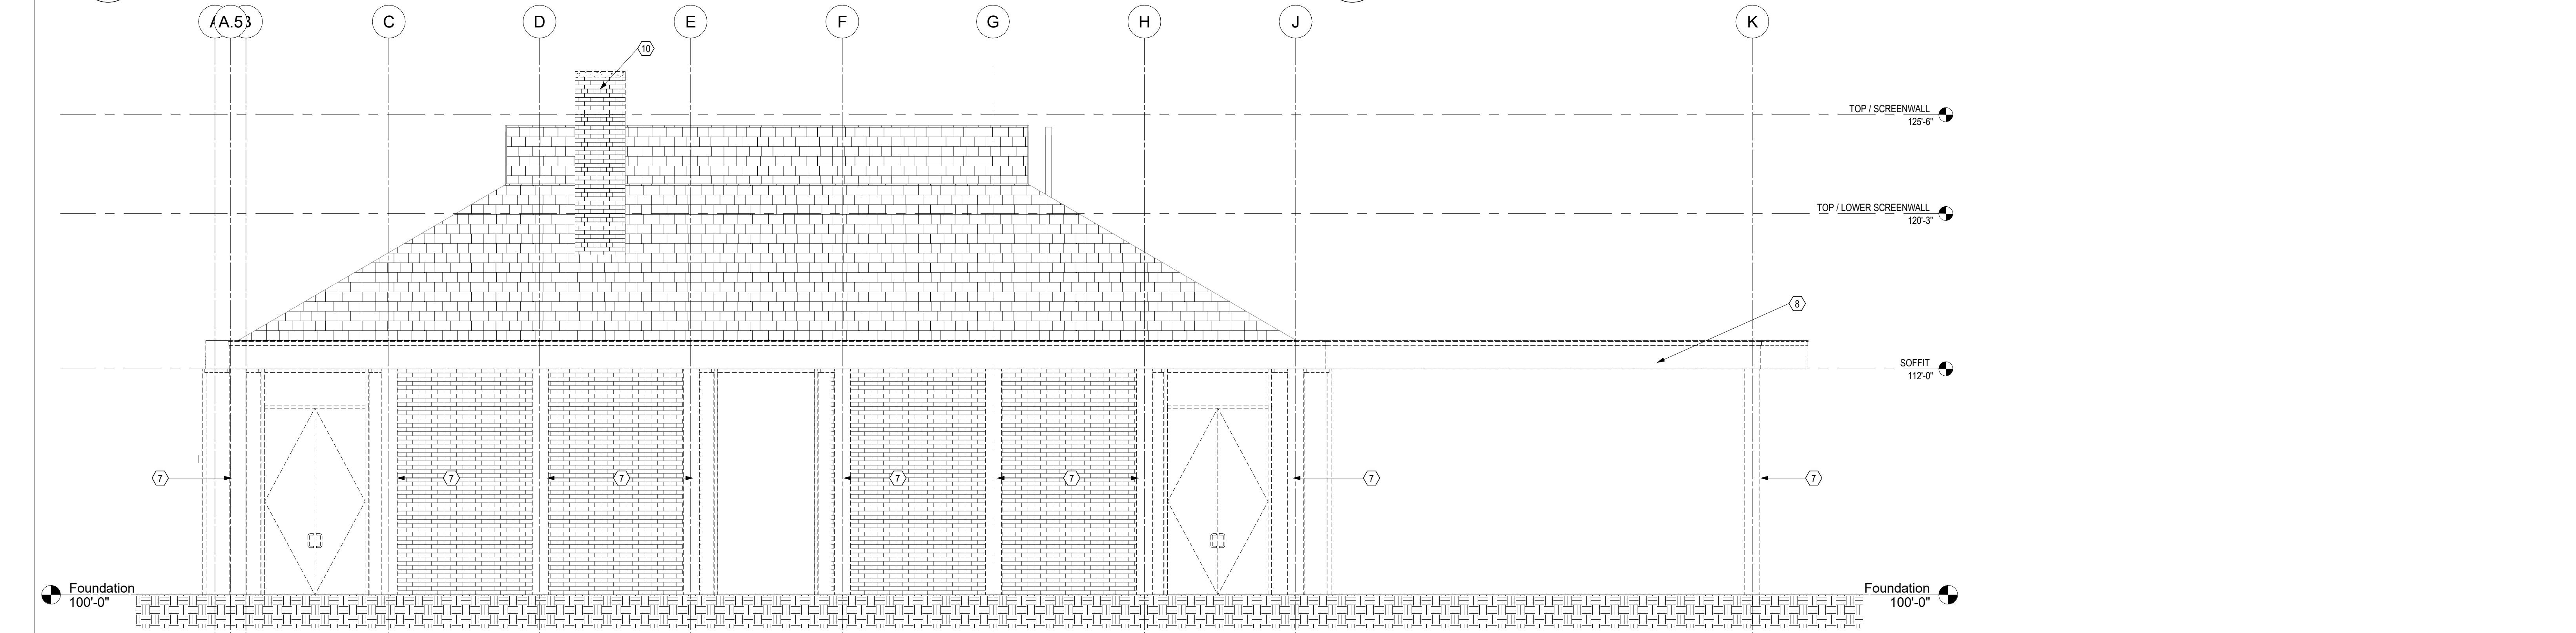

1 EAST ELEVATION
1/4" = 1'-0"

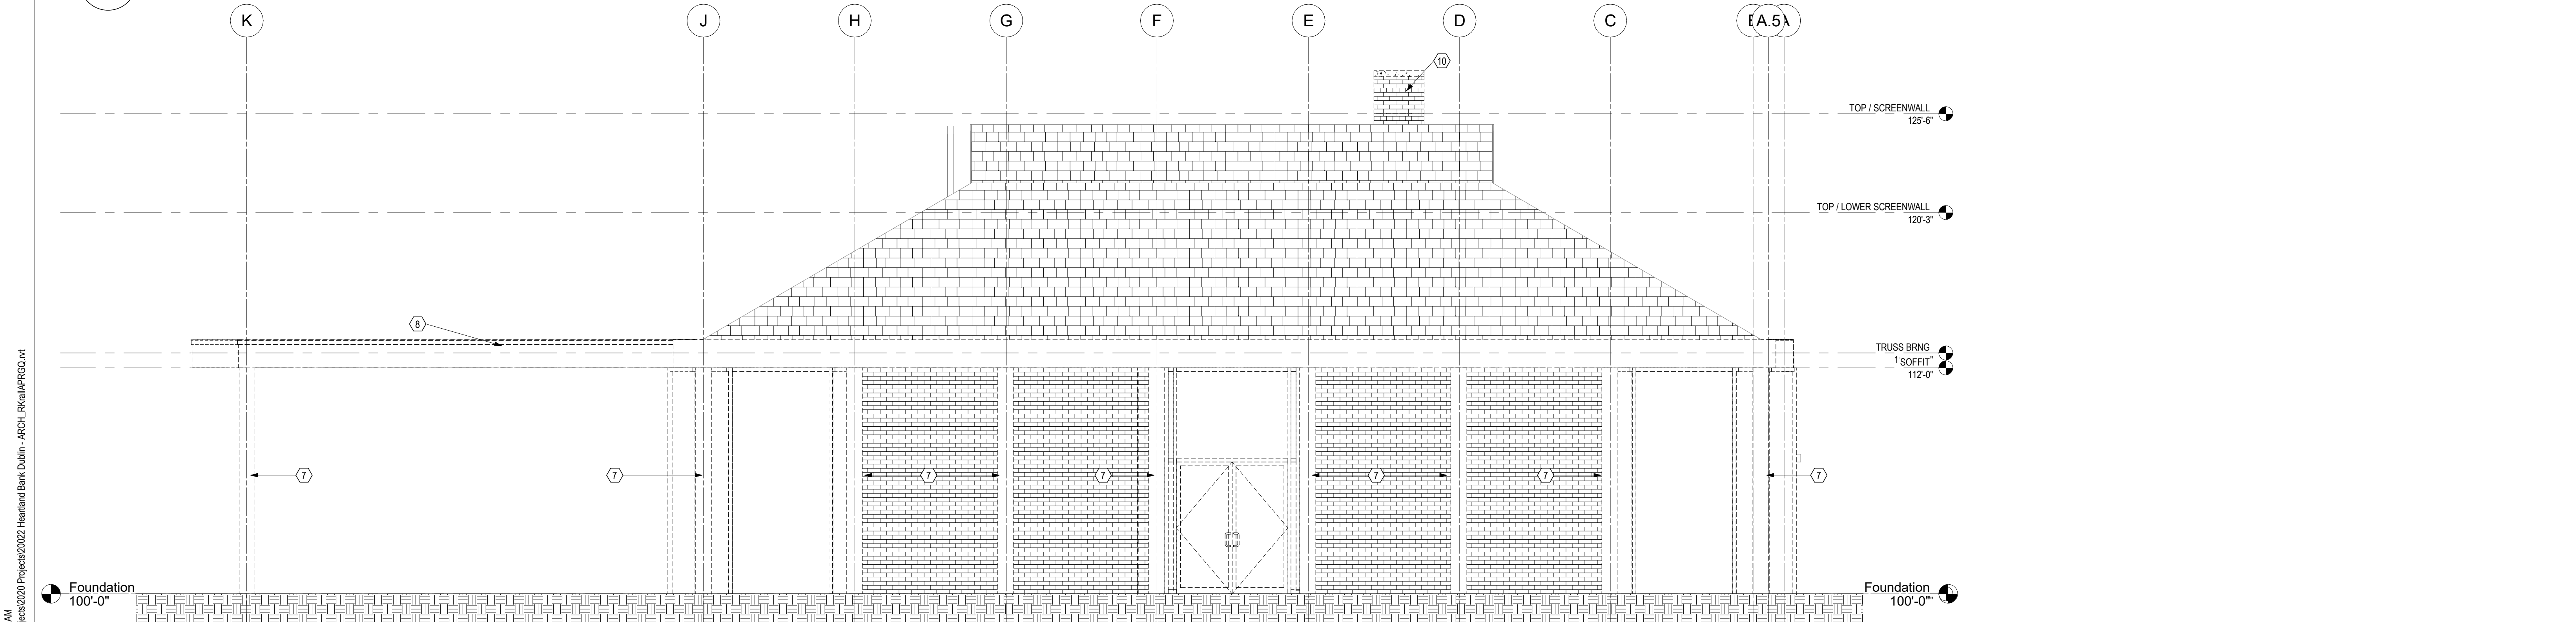

4 WEST ELEVATION
1/4" = 1'-0"

GENERAL NOTES - DEMOLITION PLANS

DEMOLITION LEGEND

XXX	ROOM NUMBER
---	CONSTRUCTION TO REMAIN
---	CONSTRUCTION TO BE REMOVED
---	DOOR TO REMAIN
---	DOOR TO BE REMOVED

CODED DEMOLITION NOTES

1. REMOVE EXISTING WALL IN ITS ENTIRETY.
2. REMOVE EXISTING DOOR, HARDWARE AND FRAME IN ITS ENTIRETY.
3. REMOVE EXISTING CASEWORK IN ITS ENTIRETY.
4. REMOVE EXISTING PLUMBING FIXTURE. COORDINATE w/ RELATED WORK ON PLUMBING DRAWINGS.
5. REMOVE EXISTING STOREFRONT WINDOW.
6. REMOVE EXISTING EXTERIOR WALL.
7. REMOVE EXISTING WOOD COLUMNS. SEE STRUCTURAL.
8. REMOVE ENTIRE DRIVE-THRU ROOF. INCLUDES ALL ROOFING MATERIALS, DECKING, STRUCTURAL FRAMING. SEE STRUCTURAL DRAWINGS FOR ADDITIONAL INFORMATION.
9. REMOVE A PORTION OF EXISTING WALL.
10. REMOVE A PORTION OF THE CHIMNEY. **HOW MUCH? - REVIEW W/ MECH.**
11. REMOVE EAST & WEST PORCH ROOF CANOPIES ENTIRELY INCLUDING ROOFING, DECK AND STRUCTURAL FRAMING. SEE STRUCTURAL DRAWINGS FOR MODIFICATION OF EXISTING ROOF TRUSS CANTILEVER. SEE ROOF DETAILS FOR EXISTING BUILDING SLATE ROOFING TO REMAIN.
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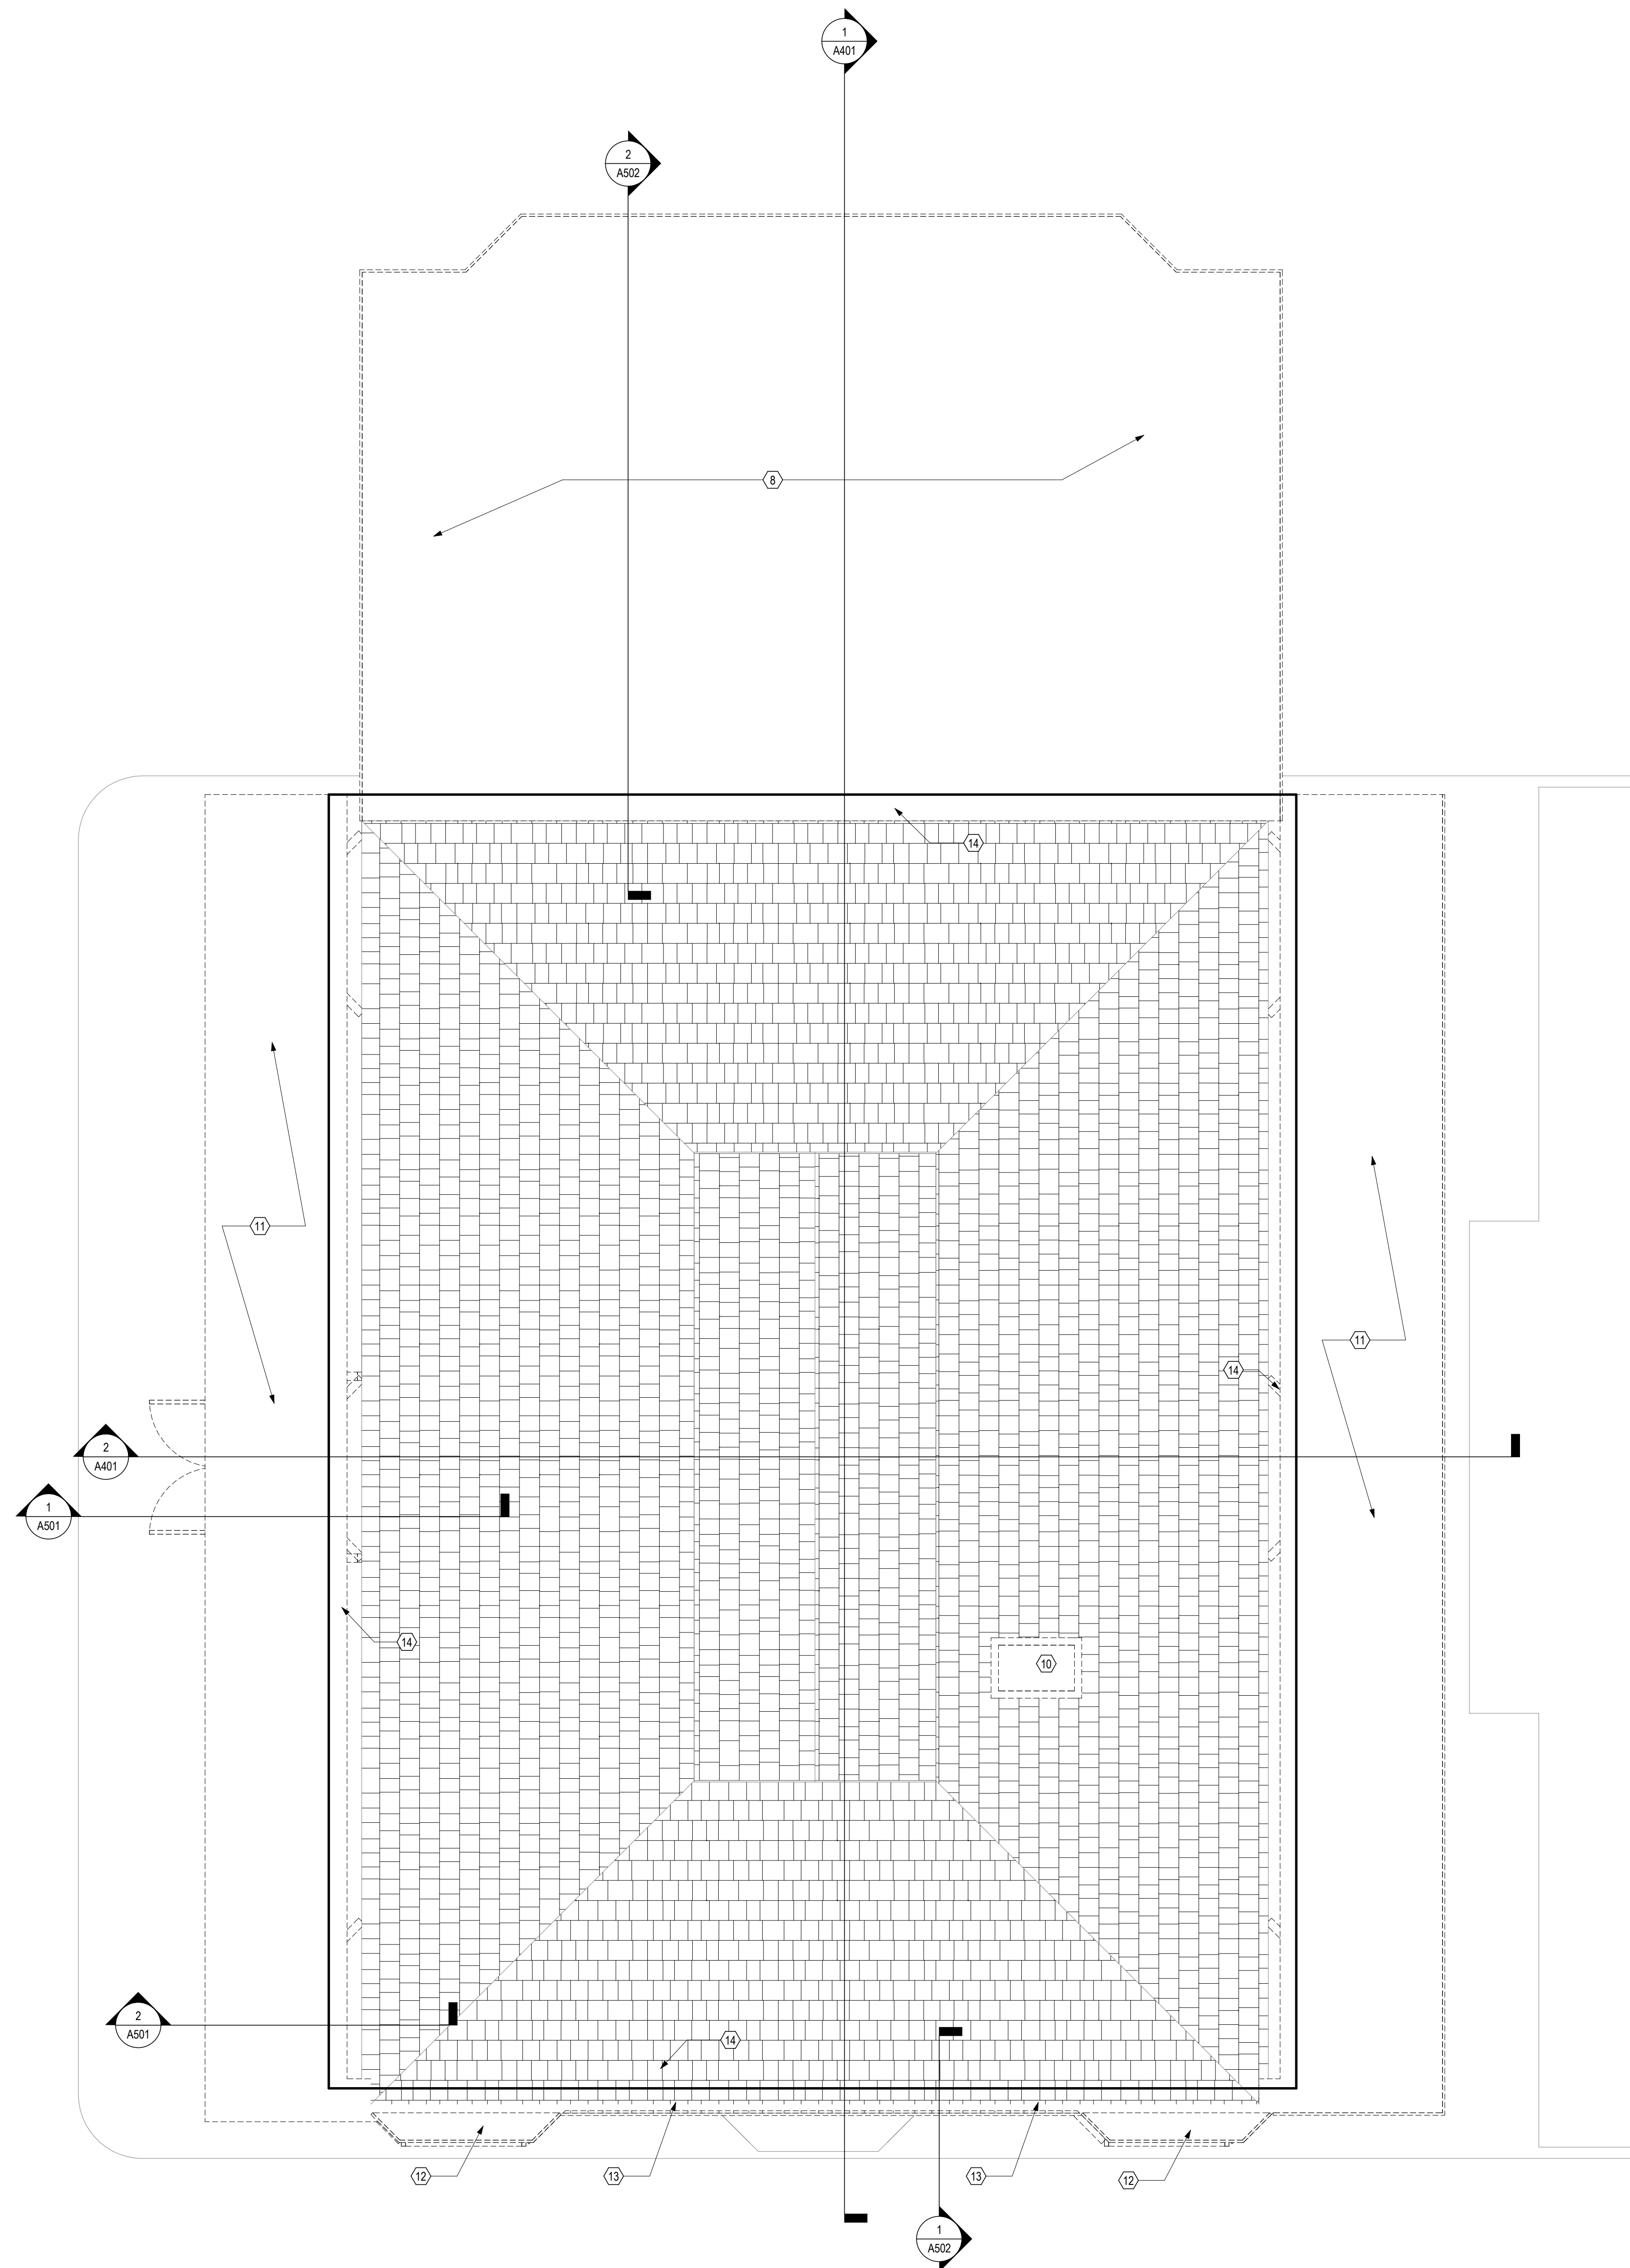
#	DATE	CHANGE DESCRIPTION

RENOVATION OF HEARTLAND BANK DUBLIN
5500 PRANTZ ROAD
DUBLIN, OH 43017
FOR
HEARTLAND BANK

MOODY-NOLAN
300 SPRUCE STREET
SUITE 300
COLUMBUS, OHIO 43215
PHONE: (614) 461-4664
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DEMO ELEVATIONS

PROGRESS DRAWING NOT FOR CONSTRUCTION	11/30/2020 DRAWN BY: Author CHECKED BY: Checker
	2022
	AD102 FINAL DEVELOPMENT PLAN



GENERAL NOTES - DEMOLITION PLANS

DEMOLITION LEGEND

XXX	ROOM NUMBER
—	CONSTRUCTION TO REMAIN
- - -	CONSTRUCTION TO BE REMOVED
—	DOOR TO REMAIN
- - -	DOOR TO BE REMOVED

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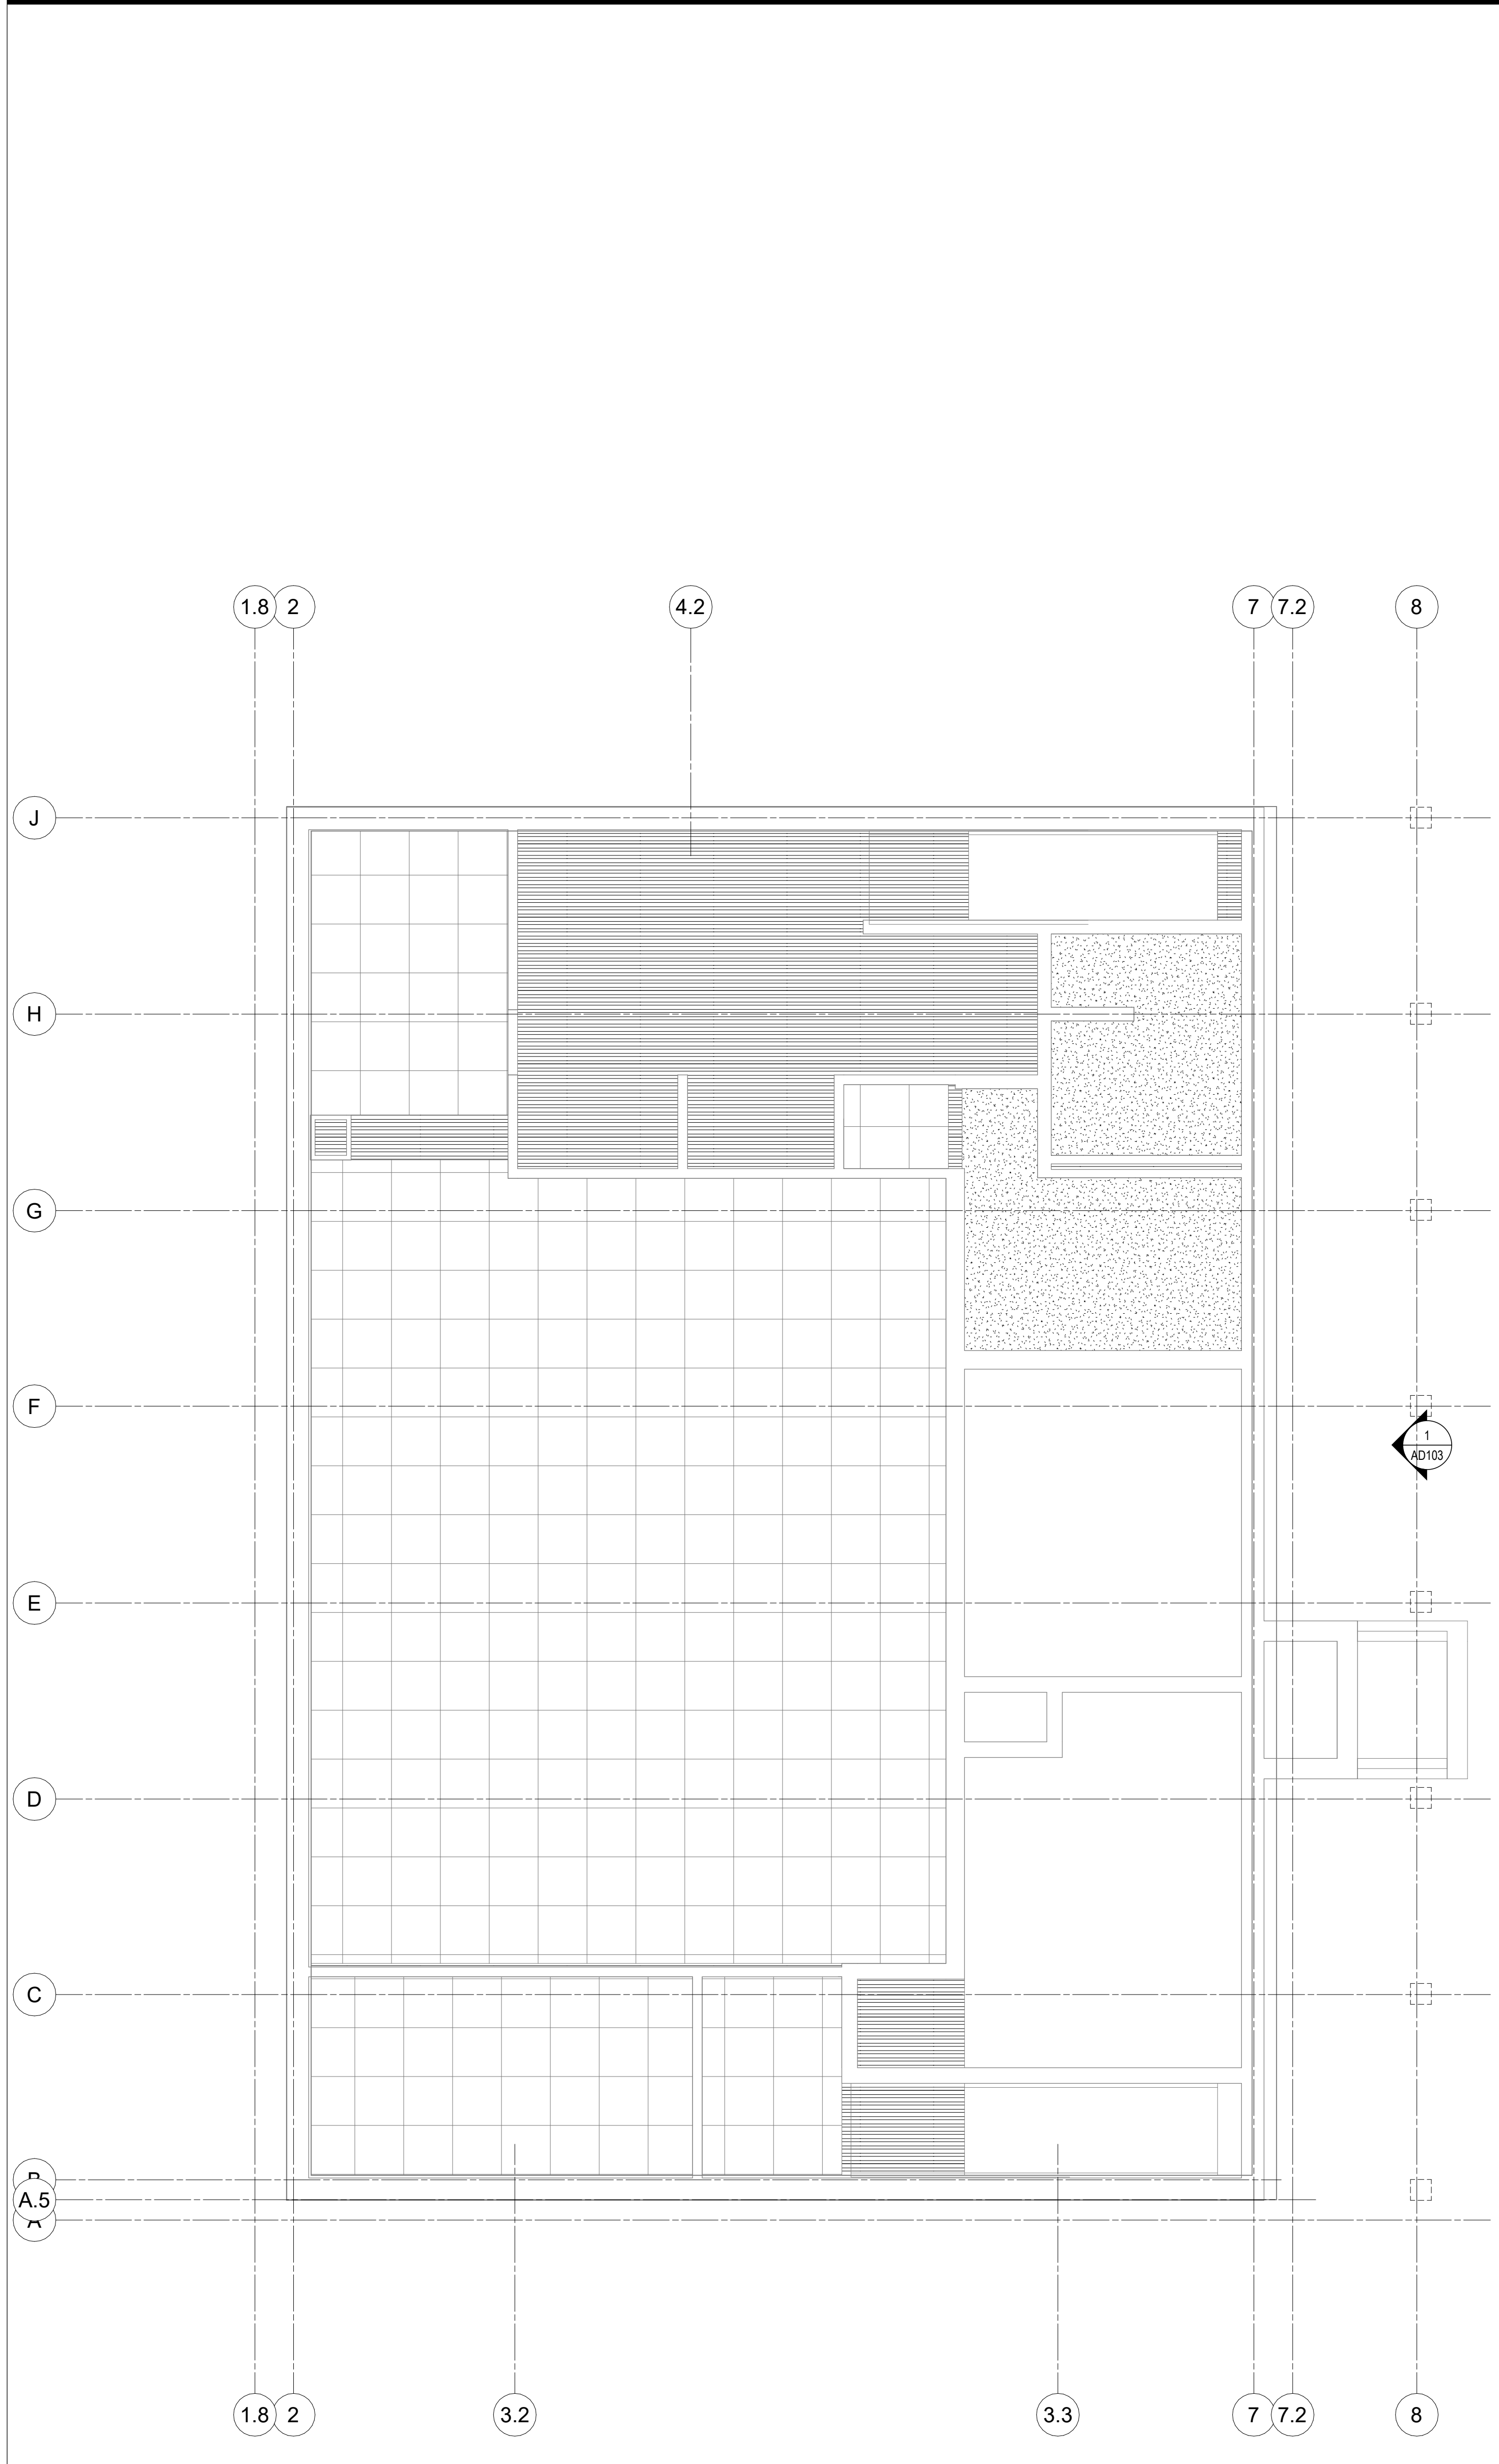
RENOVATION OF HEARTLAND BANK DUBLIN
 6303 FRANTZ ROAD
 DUBLIN, OH 43017
 FOR
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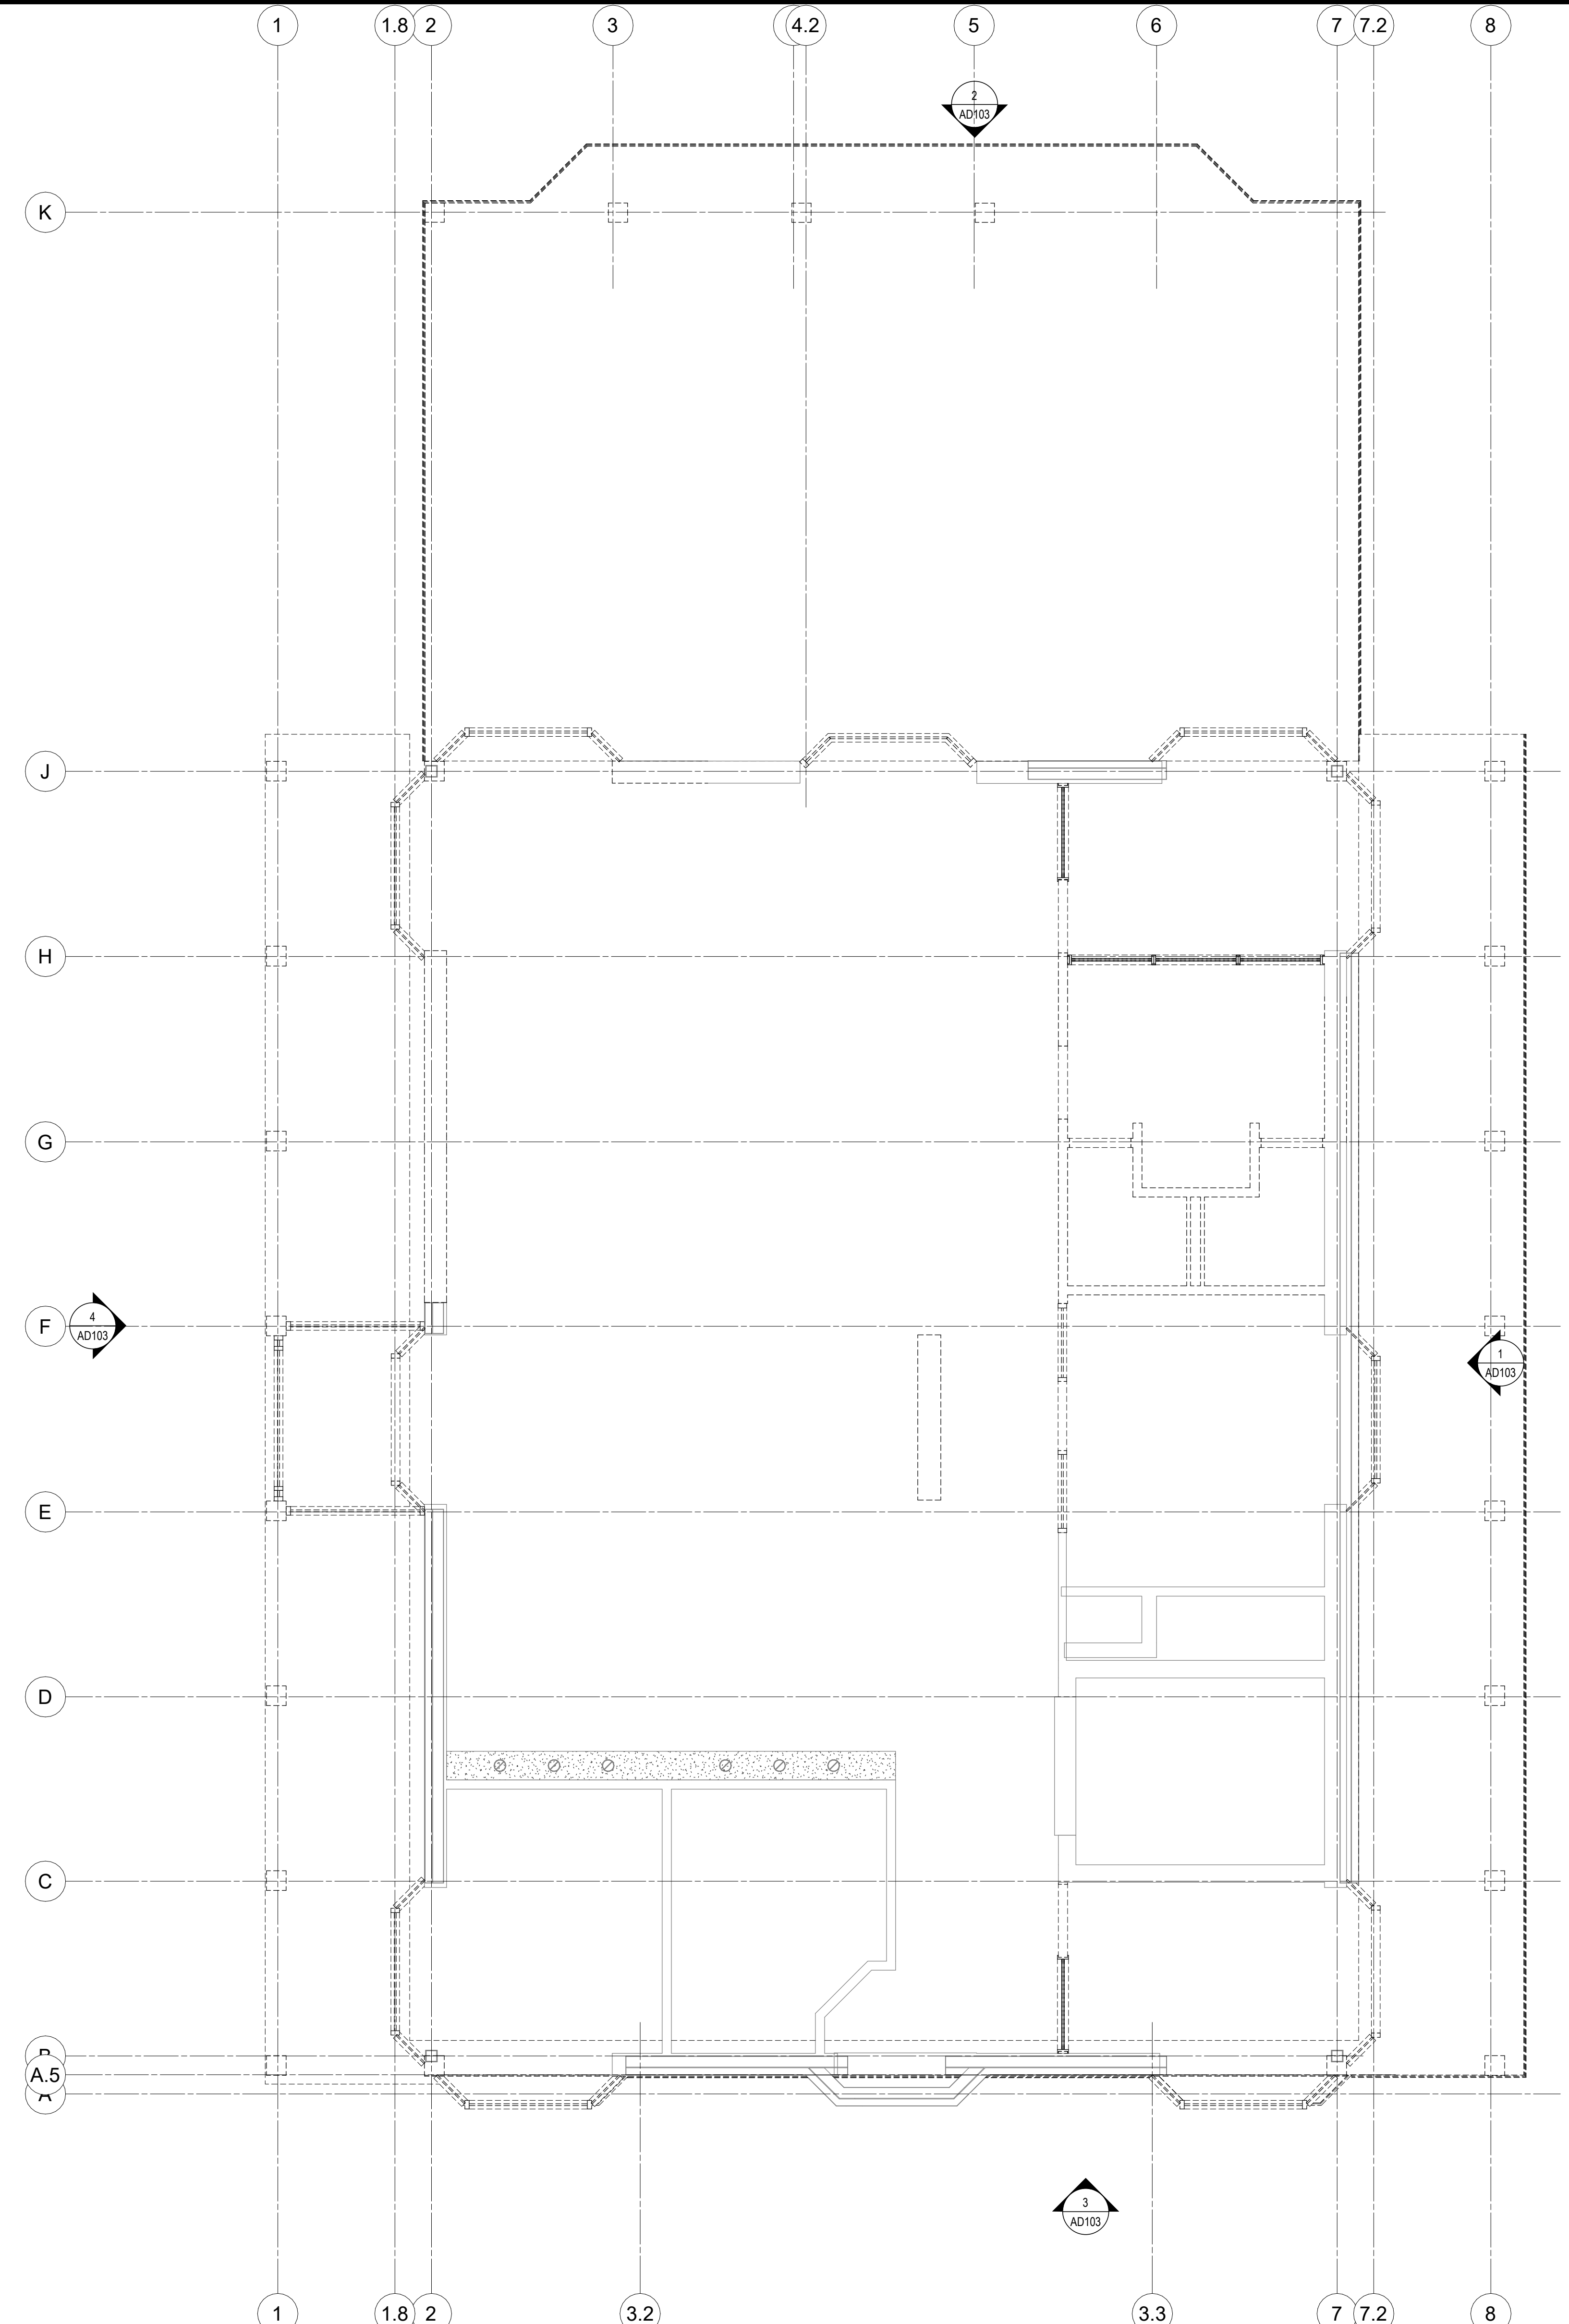
ROOF DEMO PLAN

PROGRESS DRAWING NOT FOR CONSTRUCTION	11/30/2020
	DRAWN BY: Author CHECKED BY: Checker
	20022
	AD103
FINAL DEVELOPMENT PLAN	

1 PLAN ROOF DEMO PLAN
 1/4" = 1'-0"



2 BASEMENT FLOOR DEMO RCP
 1/4" = 1'-0"



1 FIRST FLOOR DEMO RCP
 1/4" = 1'-0"

GENERAL NOTES - DEMOLITION PLANS

DEMOLITION LEGEND

- XXX ROOM NUMBER
- CONSTRUCTION TO REMAIN
- - - CONSTRUCTION TO BE REMOVED
- DOOR TO REMAIN
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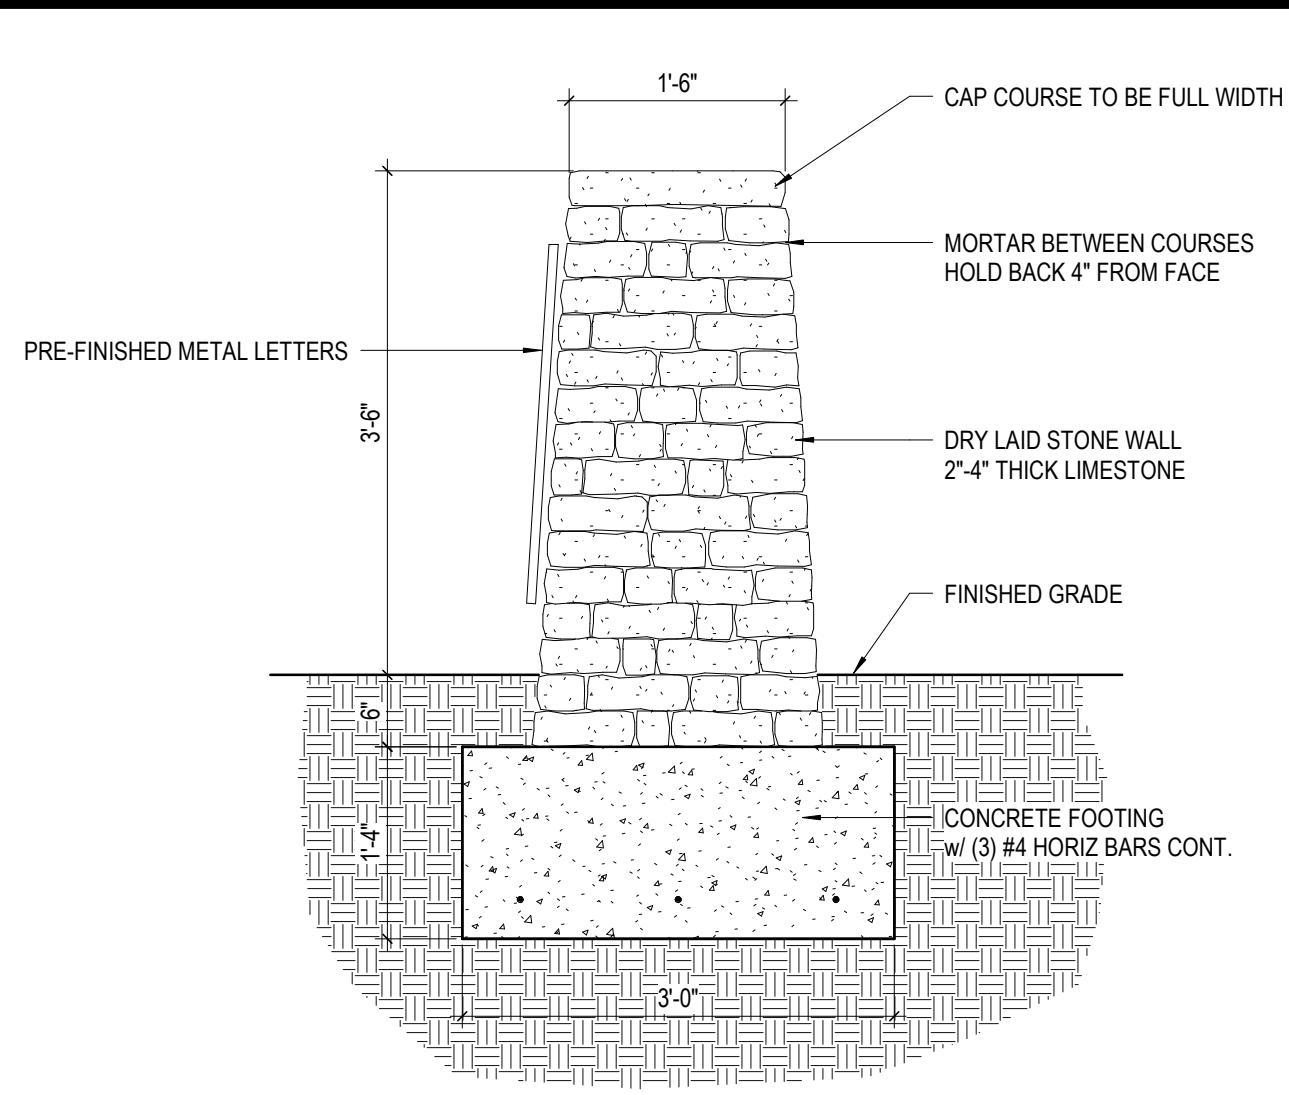
RENOVATION OF HEARTLAND BANK DUBLIN
 5500 FRANTZ ROAD
 DUBLIN, OH 43017
 FOR
HEARTLAND BANK

MOODY-NOLAN 300 SPRUCE STREET
 SUITE 300
 COLUMBUS, OHIO 43215
 PHONE: (614) 461-4664
 FAX: (614) 280-8881

DRAWING TITLE:

DEMO RCP


PROGRESS DRAWING NOT FOR CONSTRUCTION	11/30/2020
	DRAWN BY: Author CHECKED BY: Checker
	20022
AD201	
FINAL DEVELOPMENT PLAN	



2 SECTION
 MONUMENT SIGN
 3/4" = 1'-0"

STATE RT. #33

FRANTZ ROAD

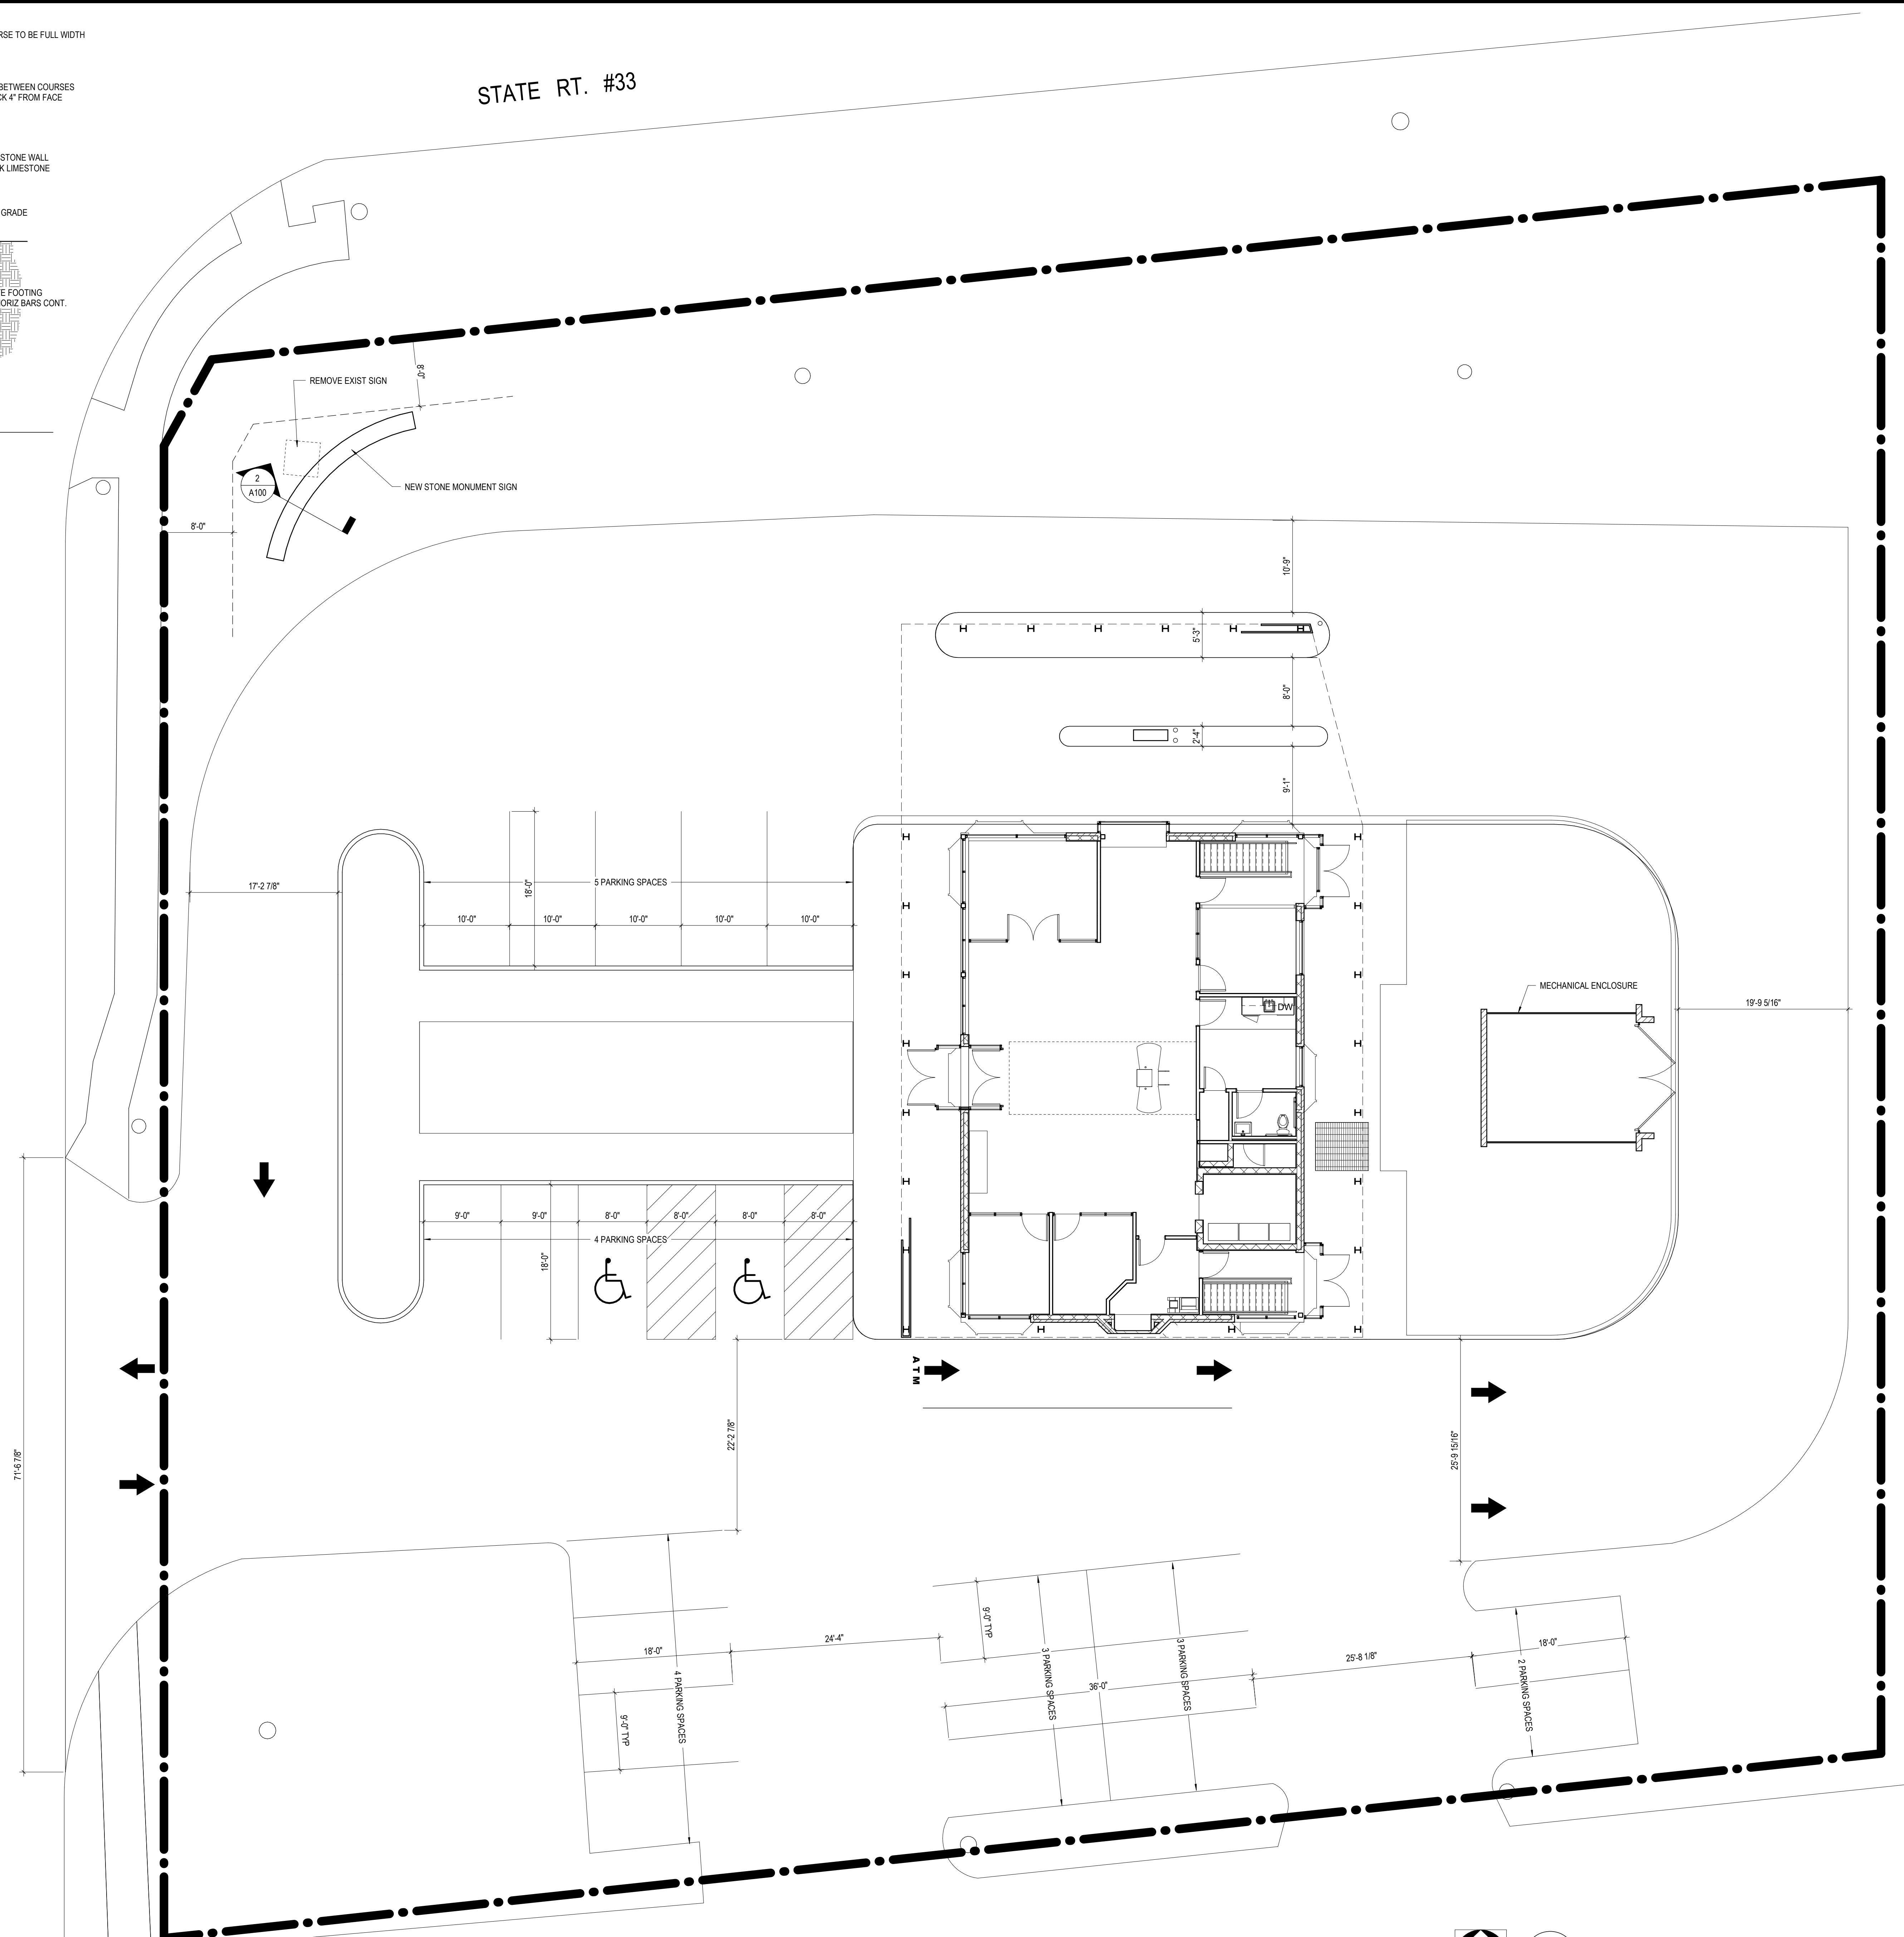

1 ARCHITECTURAL SITE PLAN
 1/8" = 1'-0"

BASEMENT - 2,106 SF
 FIRST FLOOR - 2,330 SF
 TOTAL BUILDING - 4,436 SF
 TOTAL PARKING - 22 SPACES
 REQUIRED PARKING (4436/1000x2.5) - 12 SPACES


#	DATE	CHANGE DESCRIPTION

RENOVATION OF HEARTLAND BANK DUBLIN
 5300 FRANTZ ROAD
 DUBLIN, OH 43017
 FOR
HEARTLAND BANK

MOODY-NOLAN
 300 SPRUCE STREET
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ARCHITECTURAL SITE PLAN

PROGRESS DRAWING NOT FOR CONSTRUCTION	11/30/2020
	DRAWN BY: Author CHECKED BY: Checker
	20022
A100	
FINAL DEVELOPMENT PLAN	

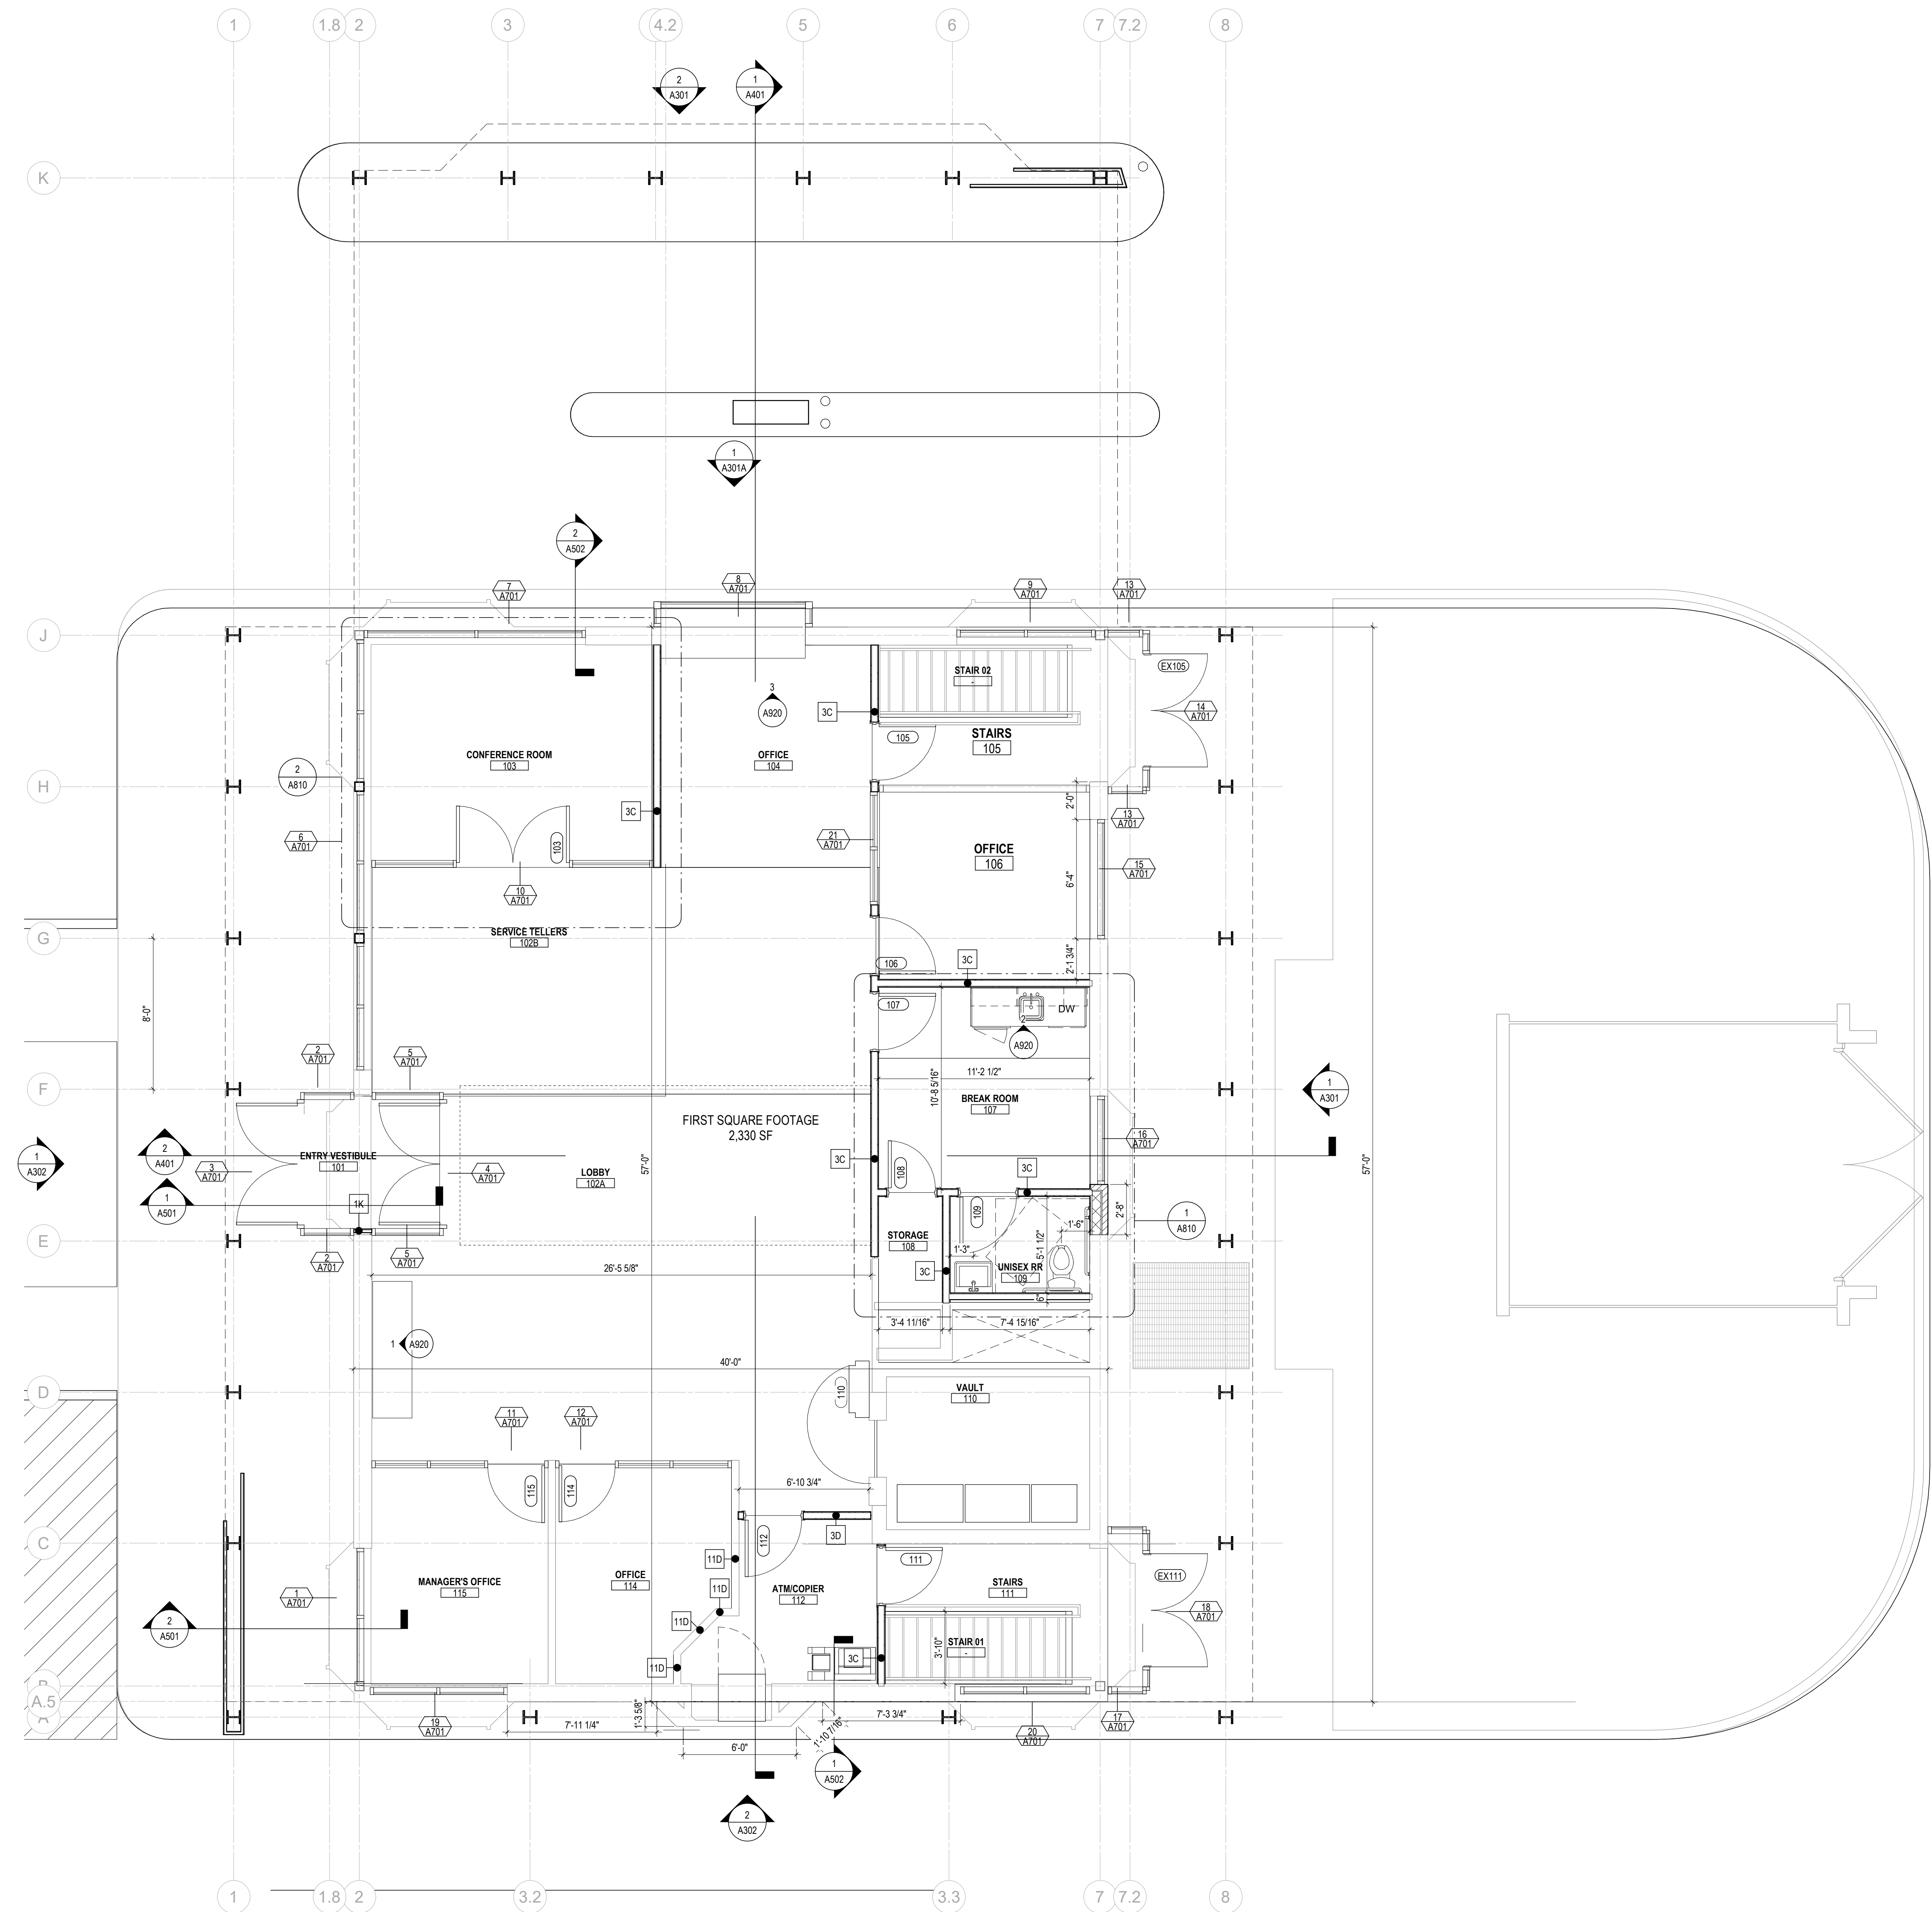

1 FIRST FLOOR PLAN
 1/4" = 1'-0"


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RENOVATION OF HEARTLAND BANK DUBLIN
 6500 PRANTZ ROAD
 DUBLIN, OH 43017
 FOR
HEARTLAND BANK


 **MOODY-NOLAN**
 300 SPRUCE STREET
 SUITE 300
 COLUMBUS, OHIO 43215
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DRAWING TITLE:
FIRST FLOOR PLAN

PROGRESS DRAWING NOT FOR CONSTRUCTION	11/30/2020 DRAWN BY: Author CHECKED BY: Checker
	20022
	A102 FINAL DEVELOPMENT PLAN



2 RCP OVERALL BASEMENT RCP
 1/4" = 1'-0"

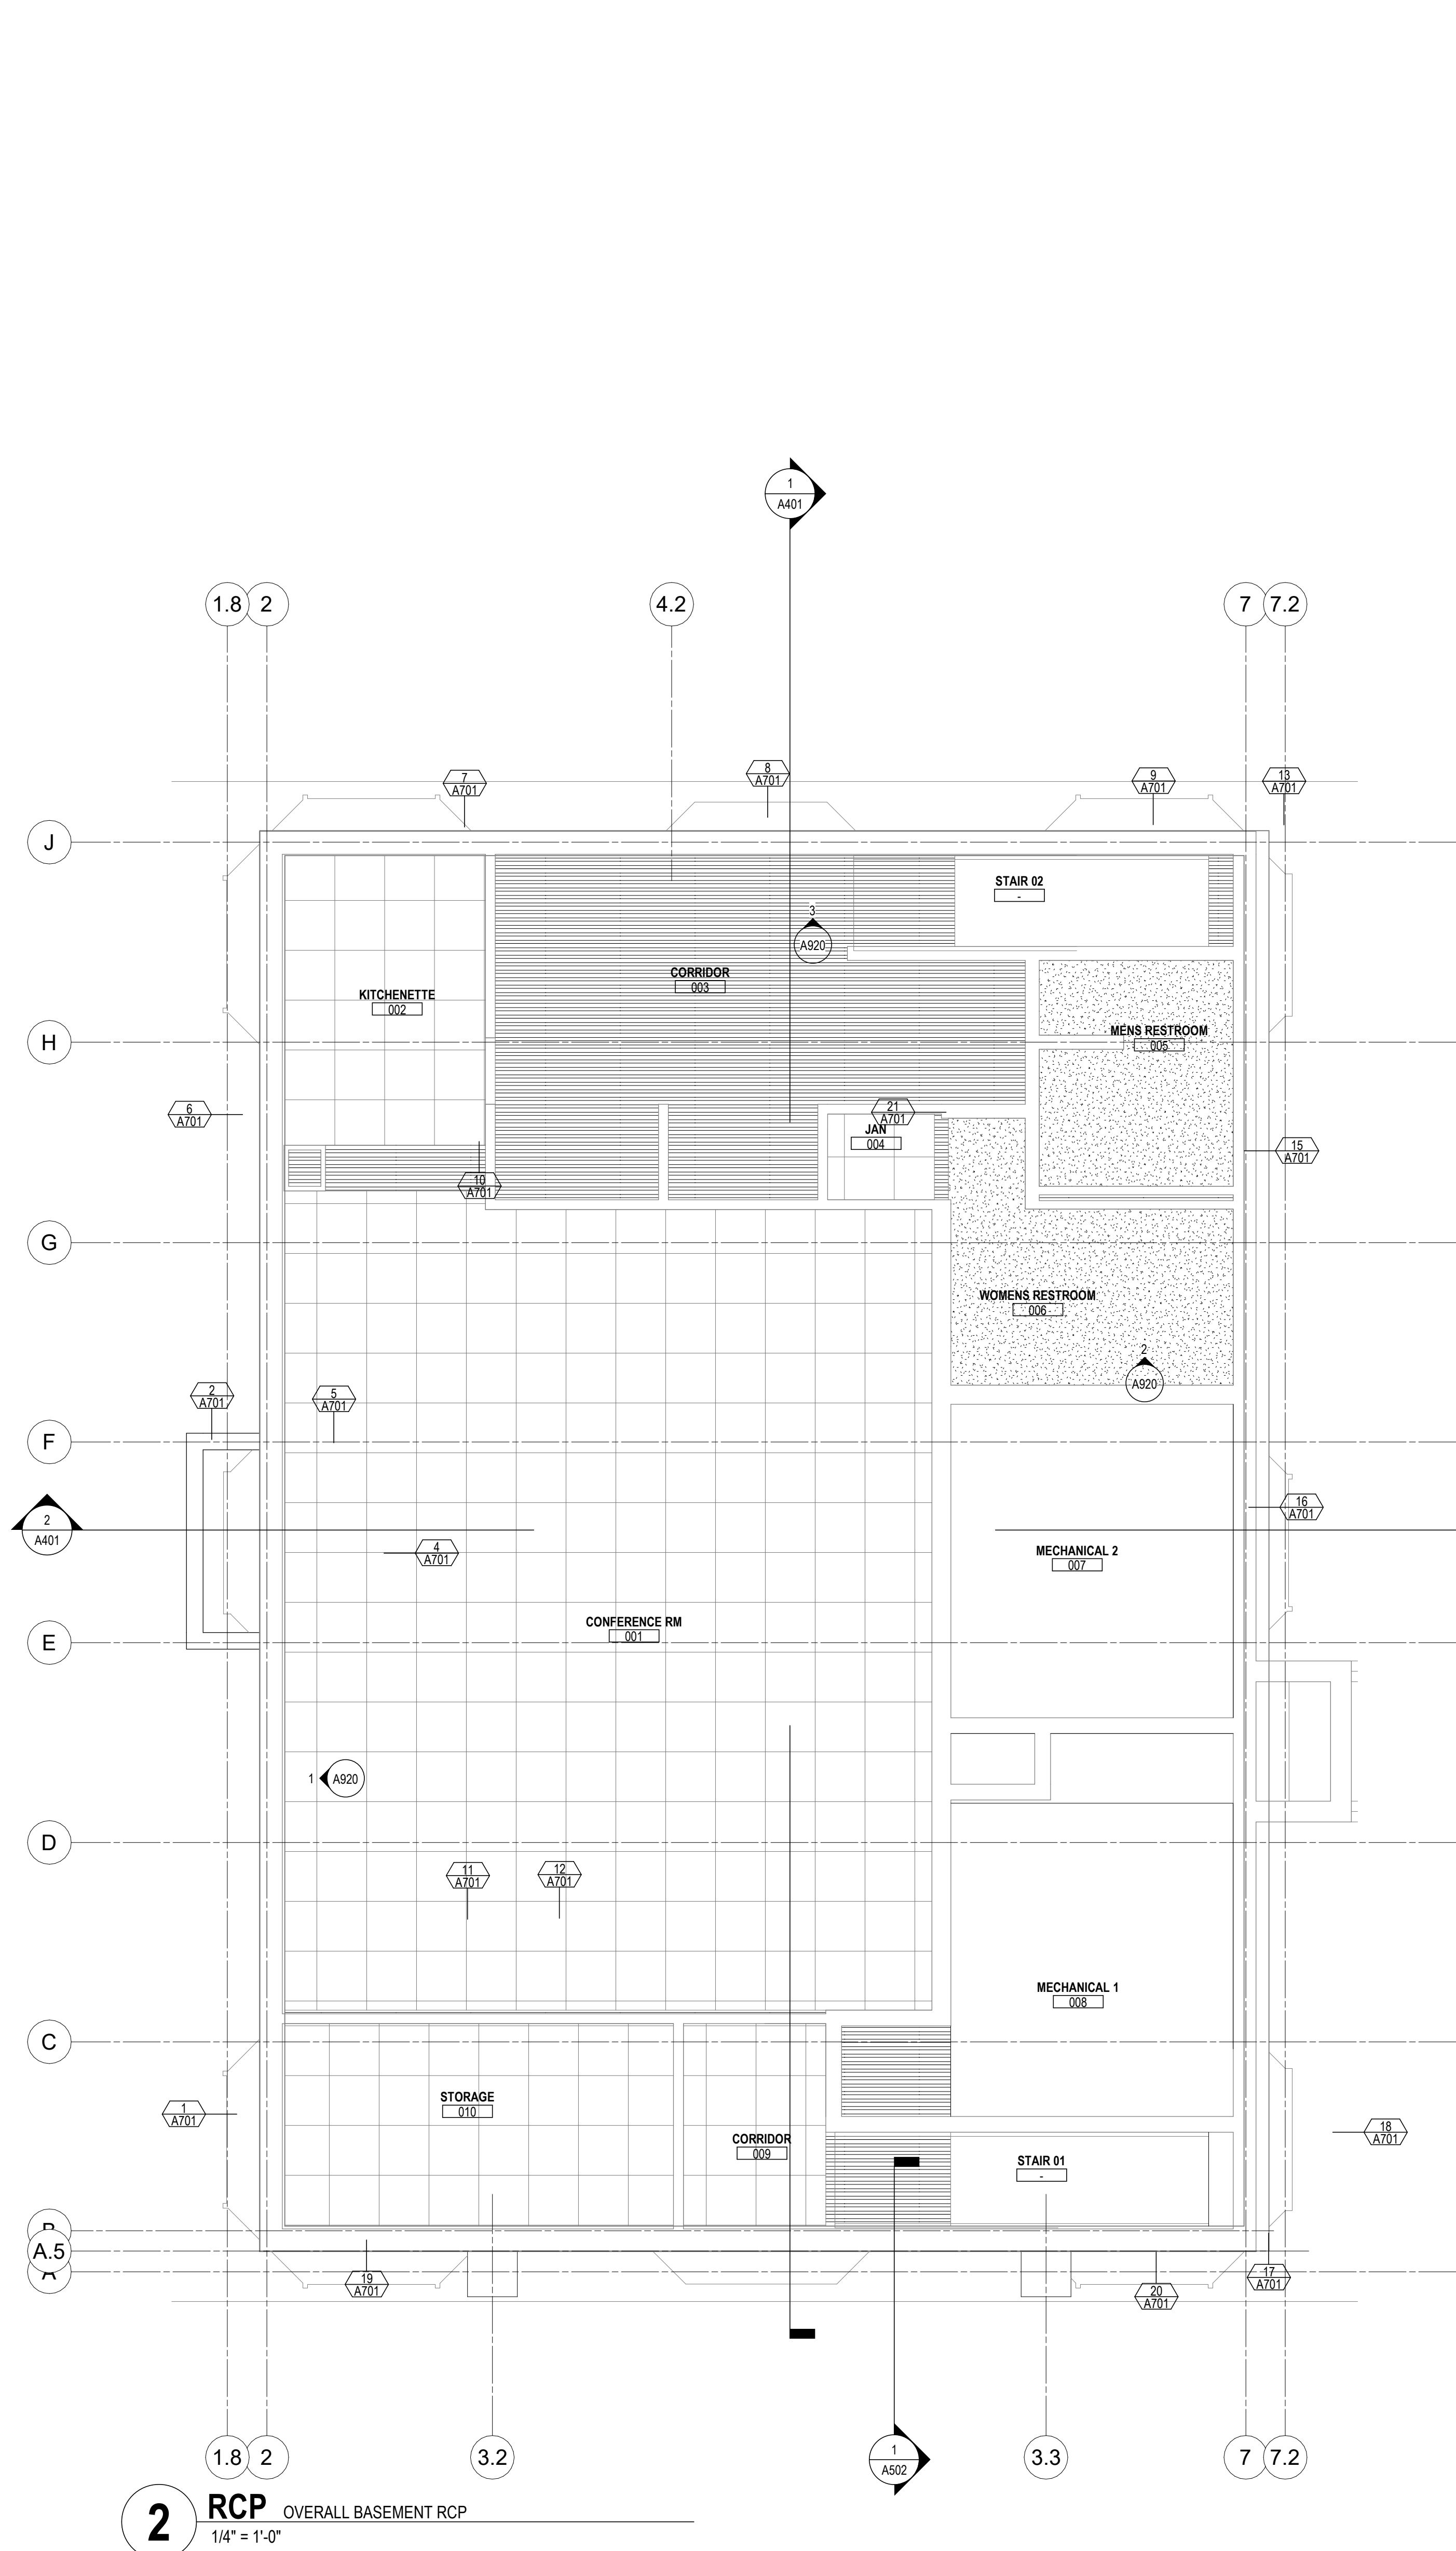

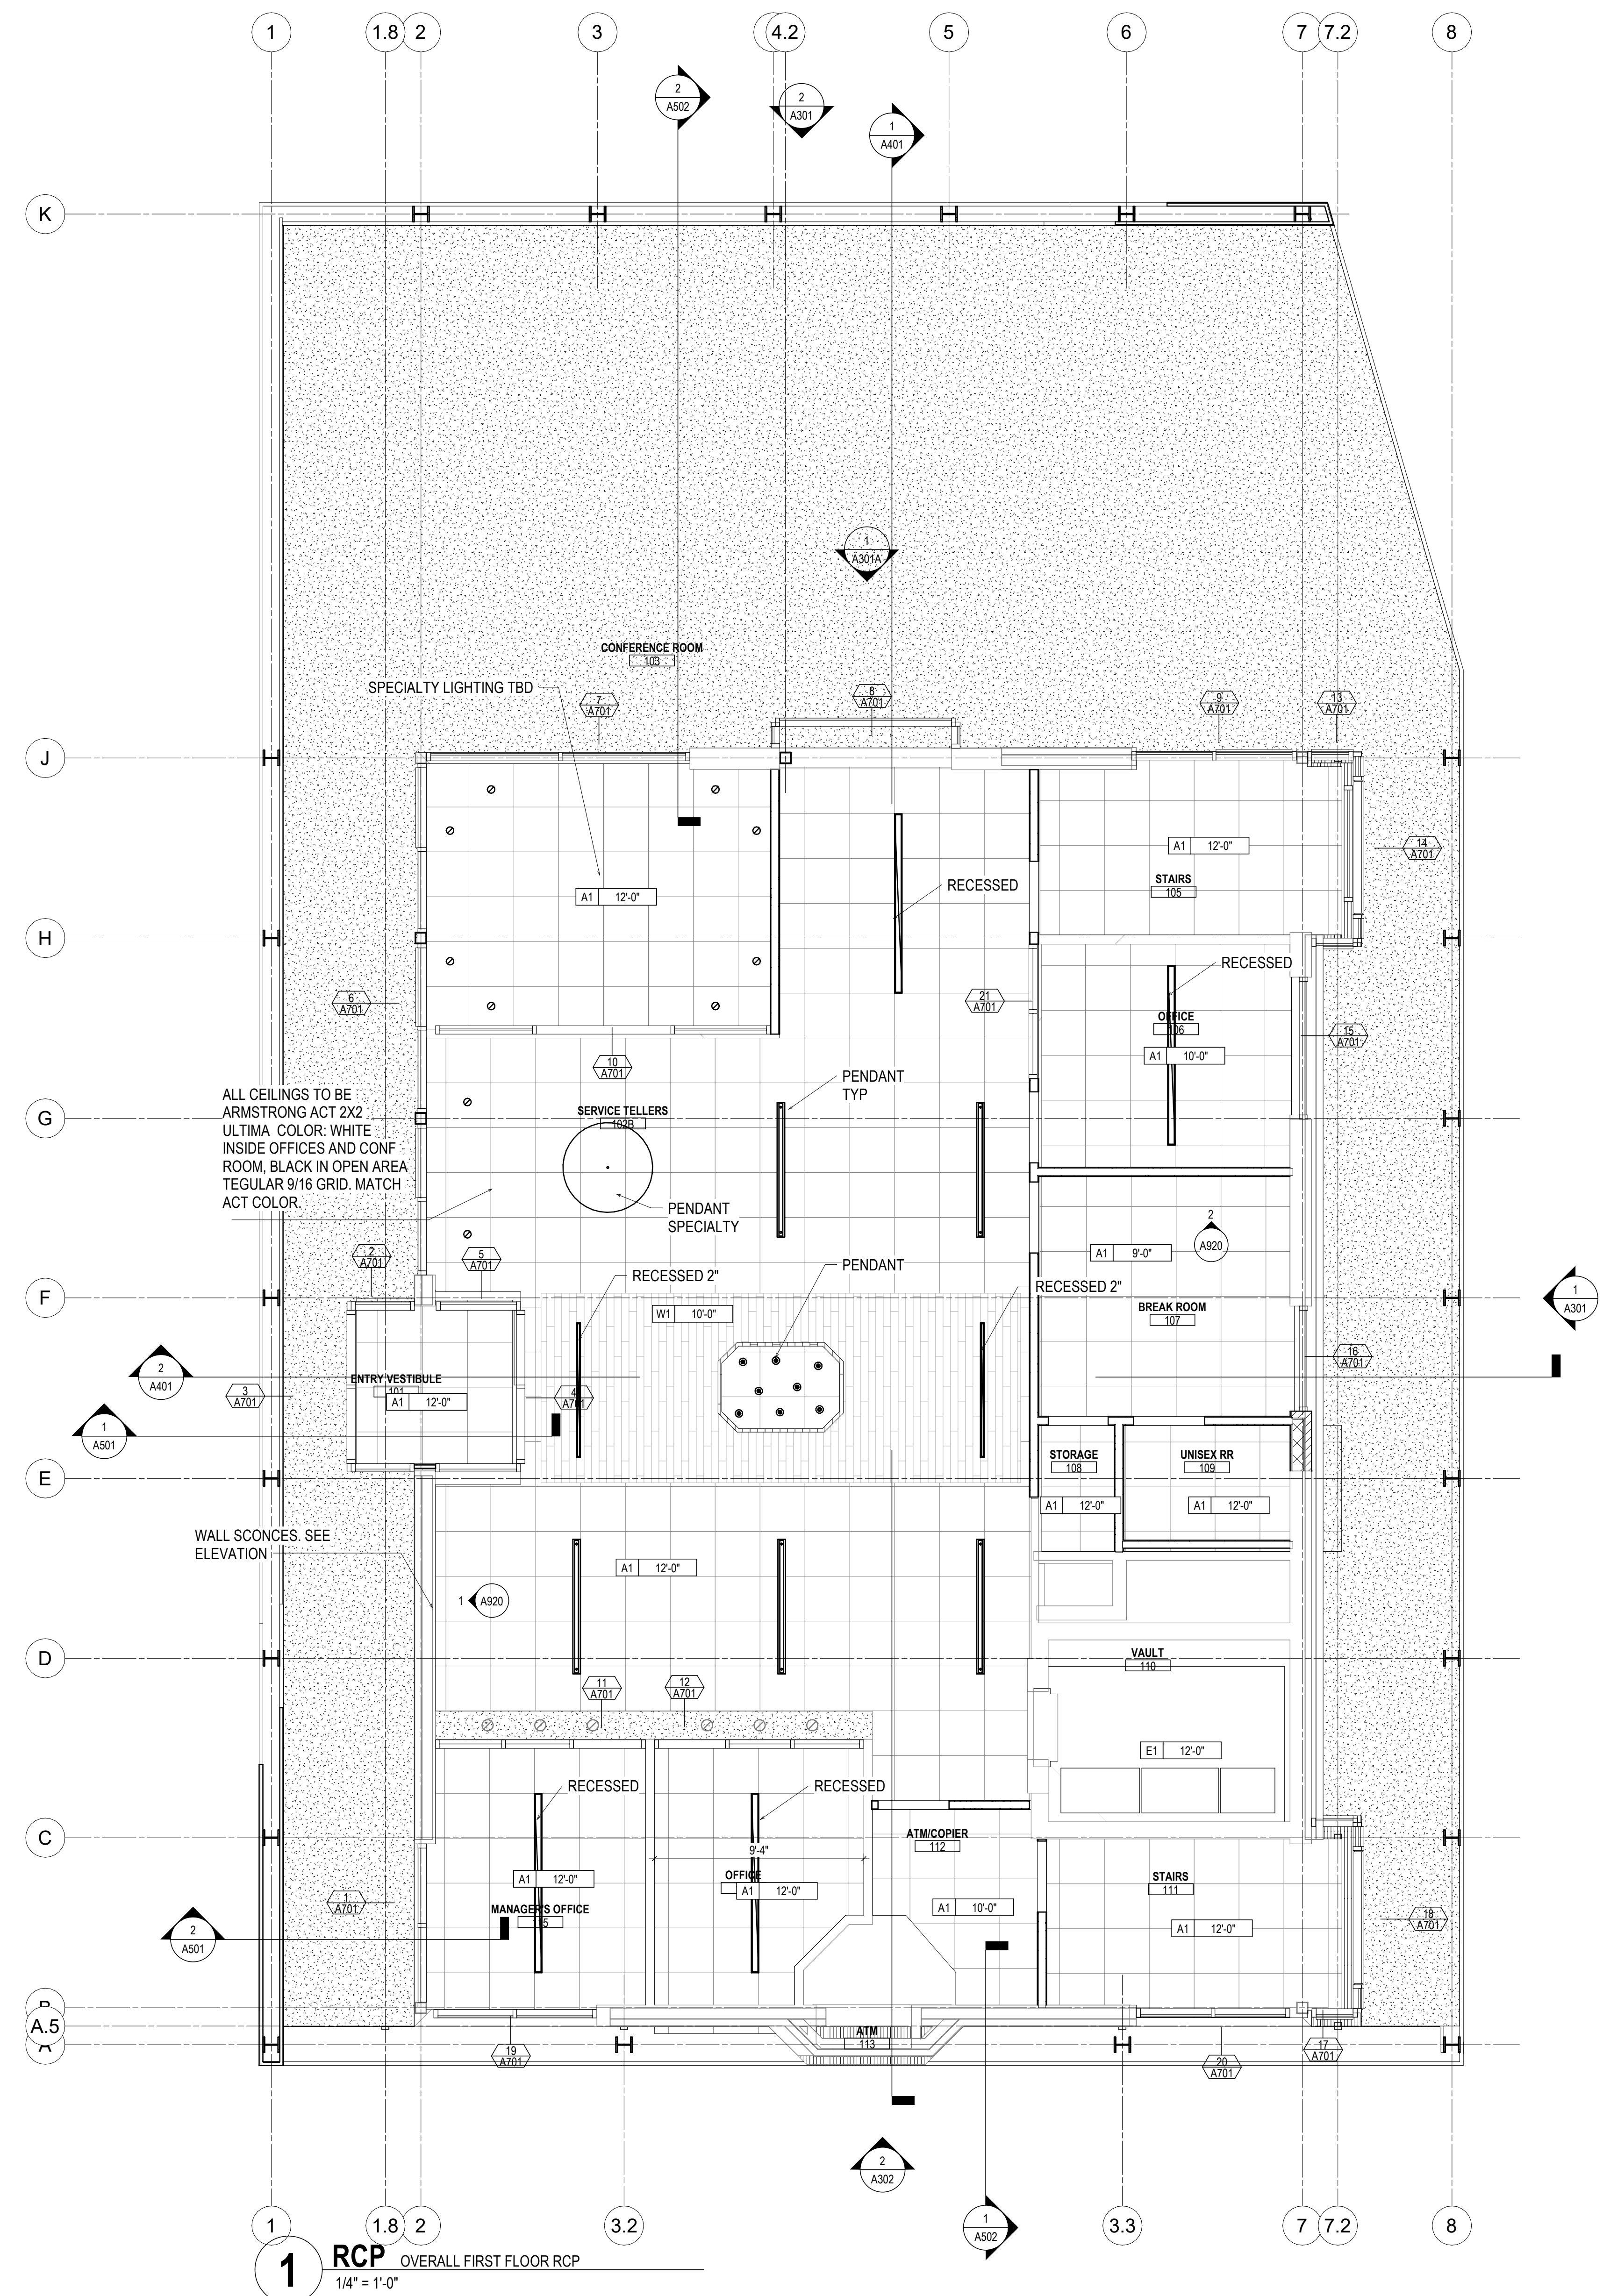1 RCP OVERALL FIRST FLOOR RCP
 1/4" = 1'-0"

RCP GENERAL NOTES

1. PAINT DESIGNATED FOR EXPOSED OVERHEAD STRUCTURE IS TO INCLUDE ALL EXPOSED COMPONENTS INCLUDING (BUT NOT EXCLUSIVE TO) DECKING, STRUCTURAL MEMBERS, MECHANICAL AND ELECTRICAL DELIVERY SYSTEMS, FIRE PROTECTION SYSTEMS (EXCLUDING SPRINKLER HEADS), AND ALL OTHER MISCELLANEOUS BUILDING SYSTEMS LOCATED OVERHEAD. EACH OF THE AFOREMENTIONED CATEGORIES IS TO INCLUDE ANY AND ALL ASSOCIATED SUPPORTS, FASTENERS, HANGERS, STRUTS, BRACES, BRACKETS, ETC.
2. LIGHT FIXTURES SHOWN TO INDICATE PROPOSED FIXTURES & GENERAL DESIGN INTENT.
3. FINISHED CEILING HEIGHTS ARE MARKED FROM TOP OF FINISH FLOOR (UNLESS NOTED OTHERWISE).
4. COORDINATE LOCATION OF FIXTURES WITH MECHANICAL, ELECTRICAL, PLUMBING, FIRE SUPPRESSION AND TECHNOLOGY DRAWINGS. ANY CONFLICT BETWEEN TRADES, NOTIFY ARCHITECT PRIOR TO INSTALLATION.
5. FACE OF BULKHEADS ARE TO ALIGN WITH FACE OF ADJACENT WALLS TO WHICH BULKHEADS ARE PARALLEL. UNLESS NOTED OTHERWISE OR DIMENSIONED.
6. ALL GYPSUM BOARD SOFFITS & CEILINGS TO BE PAINTED FLAT CEILING WHITE (UNLESS NOTED OTHERWISE).
7. ALL GYPSUM SOFFITS IN FOOD SERVICE AREAS TO BE PAINTED WITH A SATIN FINISH.
8. PAINT DUCTWORK INSIDE AIR GRILLES FLAT BLACK.
9. CEILING GRIDS ARE CENTERED ON ROOM, U.N.O. OR DIMENSIONED.
10. WHERE EXIT SIGNS OCCUR OVER A DOOR OR PAIR OF DOORS, CENTER SIGN ON DOOR OPENING.
11. ALL CEILING DEVICES TO BE CENTERED IN TILE, U.N.O.

CODED NOTE LEGEND

- ① ALIGN FEATURES
- ② OPEN TO ABOVE
- ③ TBD
- ④ TBD
- ⑤ TBD

RCP LEGEND

- A1 ACOUSTIC CEILING TYPE 1: 2x2 LAY-IN CEILING
- A2 ACOUSTIC CEILING TYPE 2: 2x4 LAY-IN CEILING
- E1 EXPOSED STRUCTURE ABOVE
- G1 GYPSUM BOARD CEILING OR SOFFIT
- 2x2 FLUORESCENT LIGHT FIXTURE (SHADING DENOTES EMERGENCY FIXTURE)
- 2x4 FLUORESCENT LIGHT FIXTURE (SHADING DENOTES EMERGENCY FIXTURE)
- 1x4 FLUORESCENT LIGHT FIXTURE (SHADING DENOTES EMERGENCY FIXTURE)
- 1x8 FLUORESCENT LIGHT FIXTURE (SHADING DENOTES EMERGENCY FIXTURE)
- RECESSED CAN LIGHT
- SURFACE MOUNTED LIGHT
- LINEAR COVE LIGHT
- EXIT LIGHT WITH DIRECTIONAL ARROW
- EXIT LIGHT
- SUPPLY DIFFUSER
- LINEAR DIFFUSER
- EXHAUST/RETURN GRILLE
- SPEAKER
- CEILING TAG WITH HEIGHT

NOTE: COORDINATE ARCHITECTURAL REFLECTED CEILING PLANS WITH THE MECHANICAL AND ELECTRICAL DRAWINGS FOR NUMBER OF AND LOCATIONS OF AND TYPES OF FIXTURES AND GRILLES. NOT ALL ITEMS SHOWN ON LEGEND MAY BE PRESENT IN PROJECT.

KEYNOTE LEGEND

KEY VALUE	KEYNOTE TEXT

RCP CEILING SCHEDULE


CEILING TYPE SCHEDULE		
TYPE	DATE	DESCRIPTION
#A1		CHANGE DESCRIPTION
E1		
G1		
WT		WOOD PLANK

RENOVATION OF HEARTLAND BANK DUBLIN
 5303 PRANTZ ROAD
 DUBLIN, OH 43017
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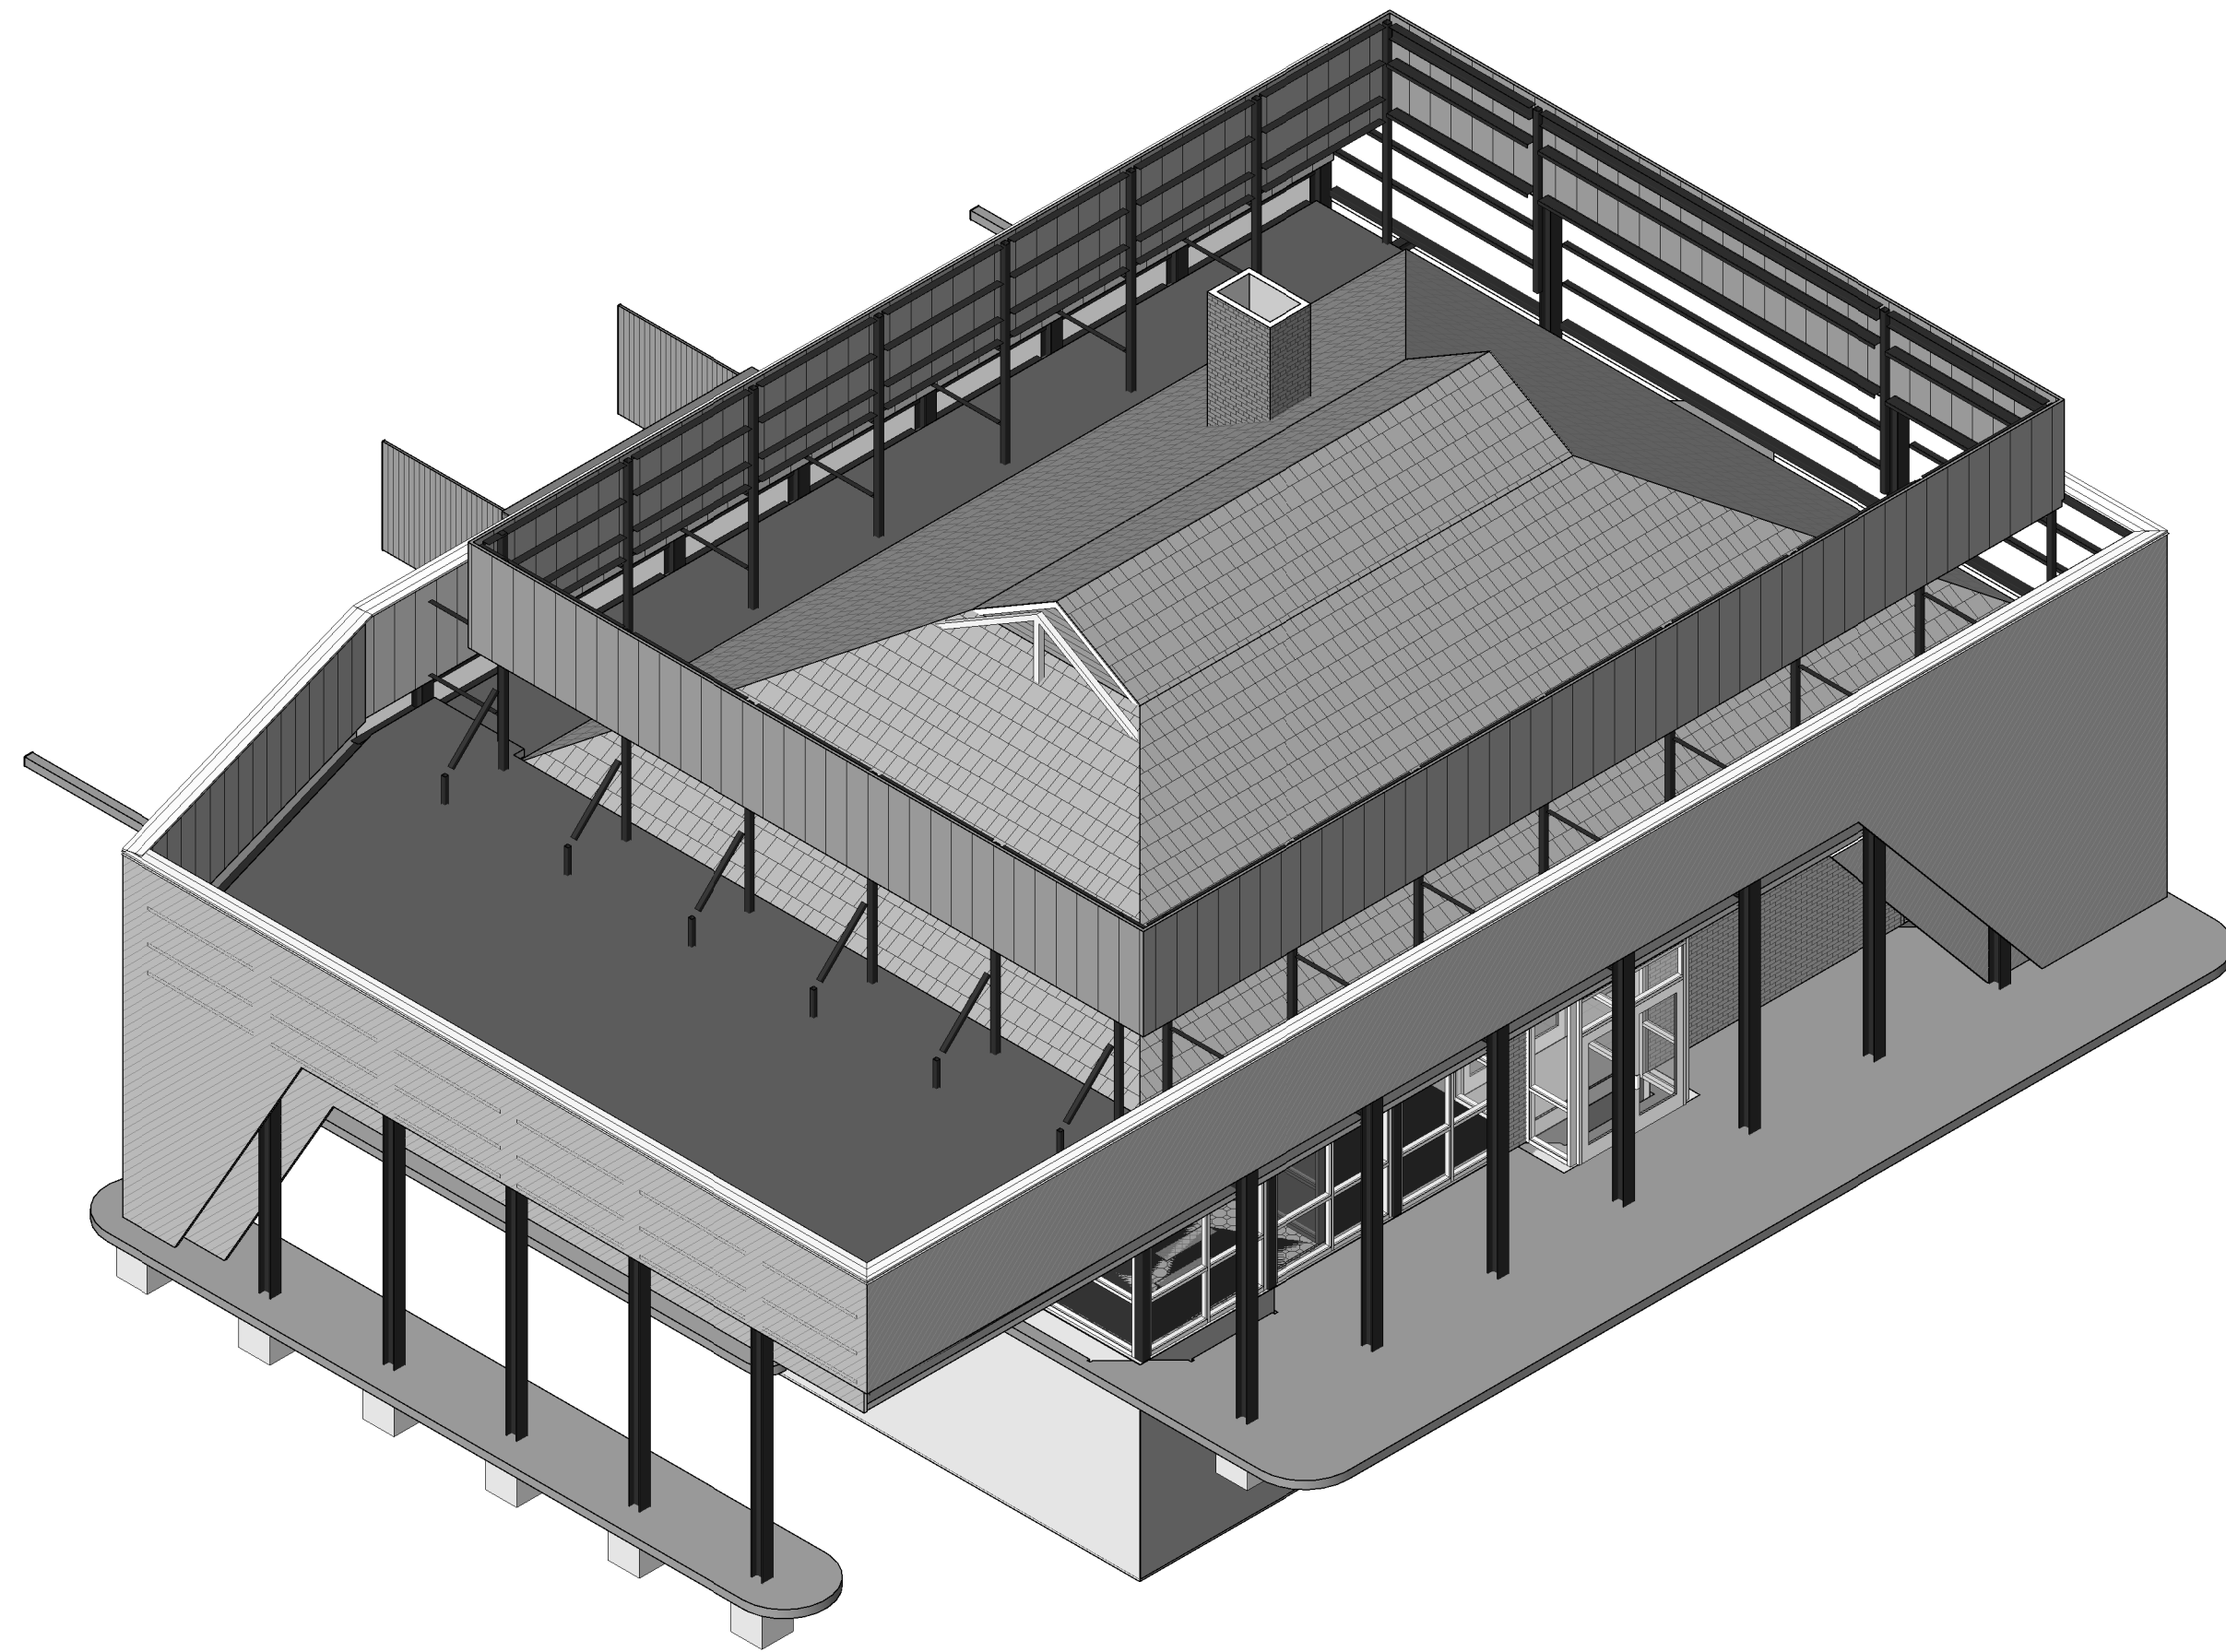
300 SPRUCE STREET
 SUITE 300
 COLUMBUS, OHIO 43215
 PHONE: (614) 461-4664
 FAX: (614) 280-8881

RCP - OVERALL

PROGRESS DRAWING NOT FOR CONSTRUCTION	11/30/2020 DRAWN BY: xxx CHECKED BY: xxx
	2022
	A201 FINAL DEVELOPMENT PLAN

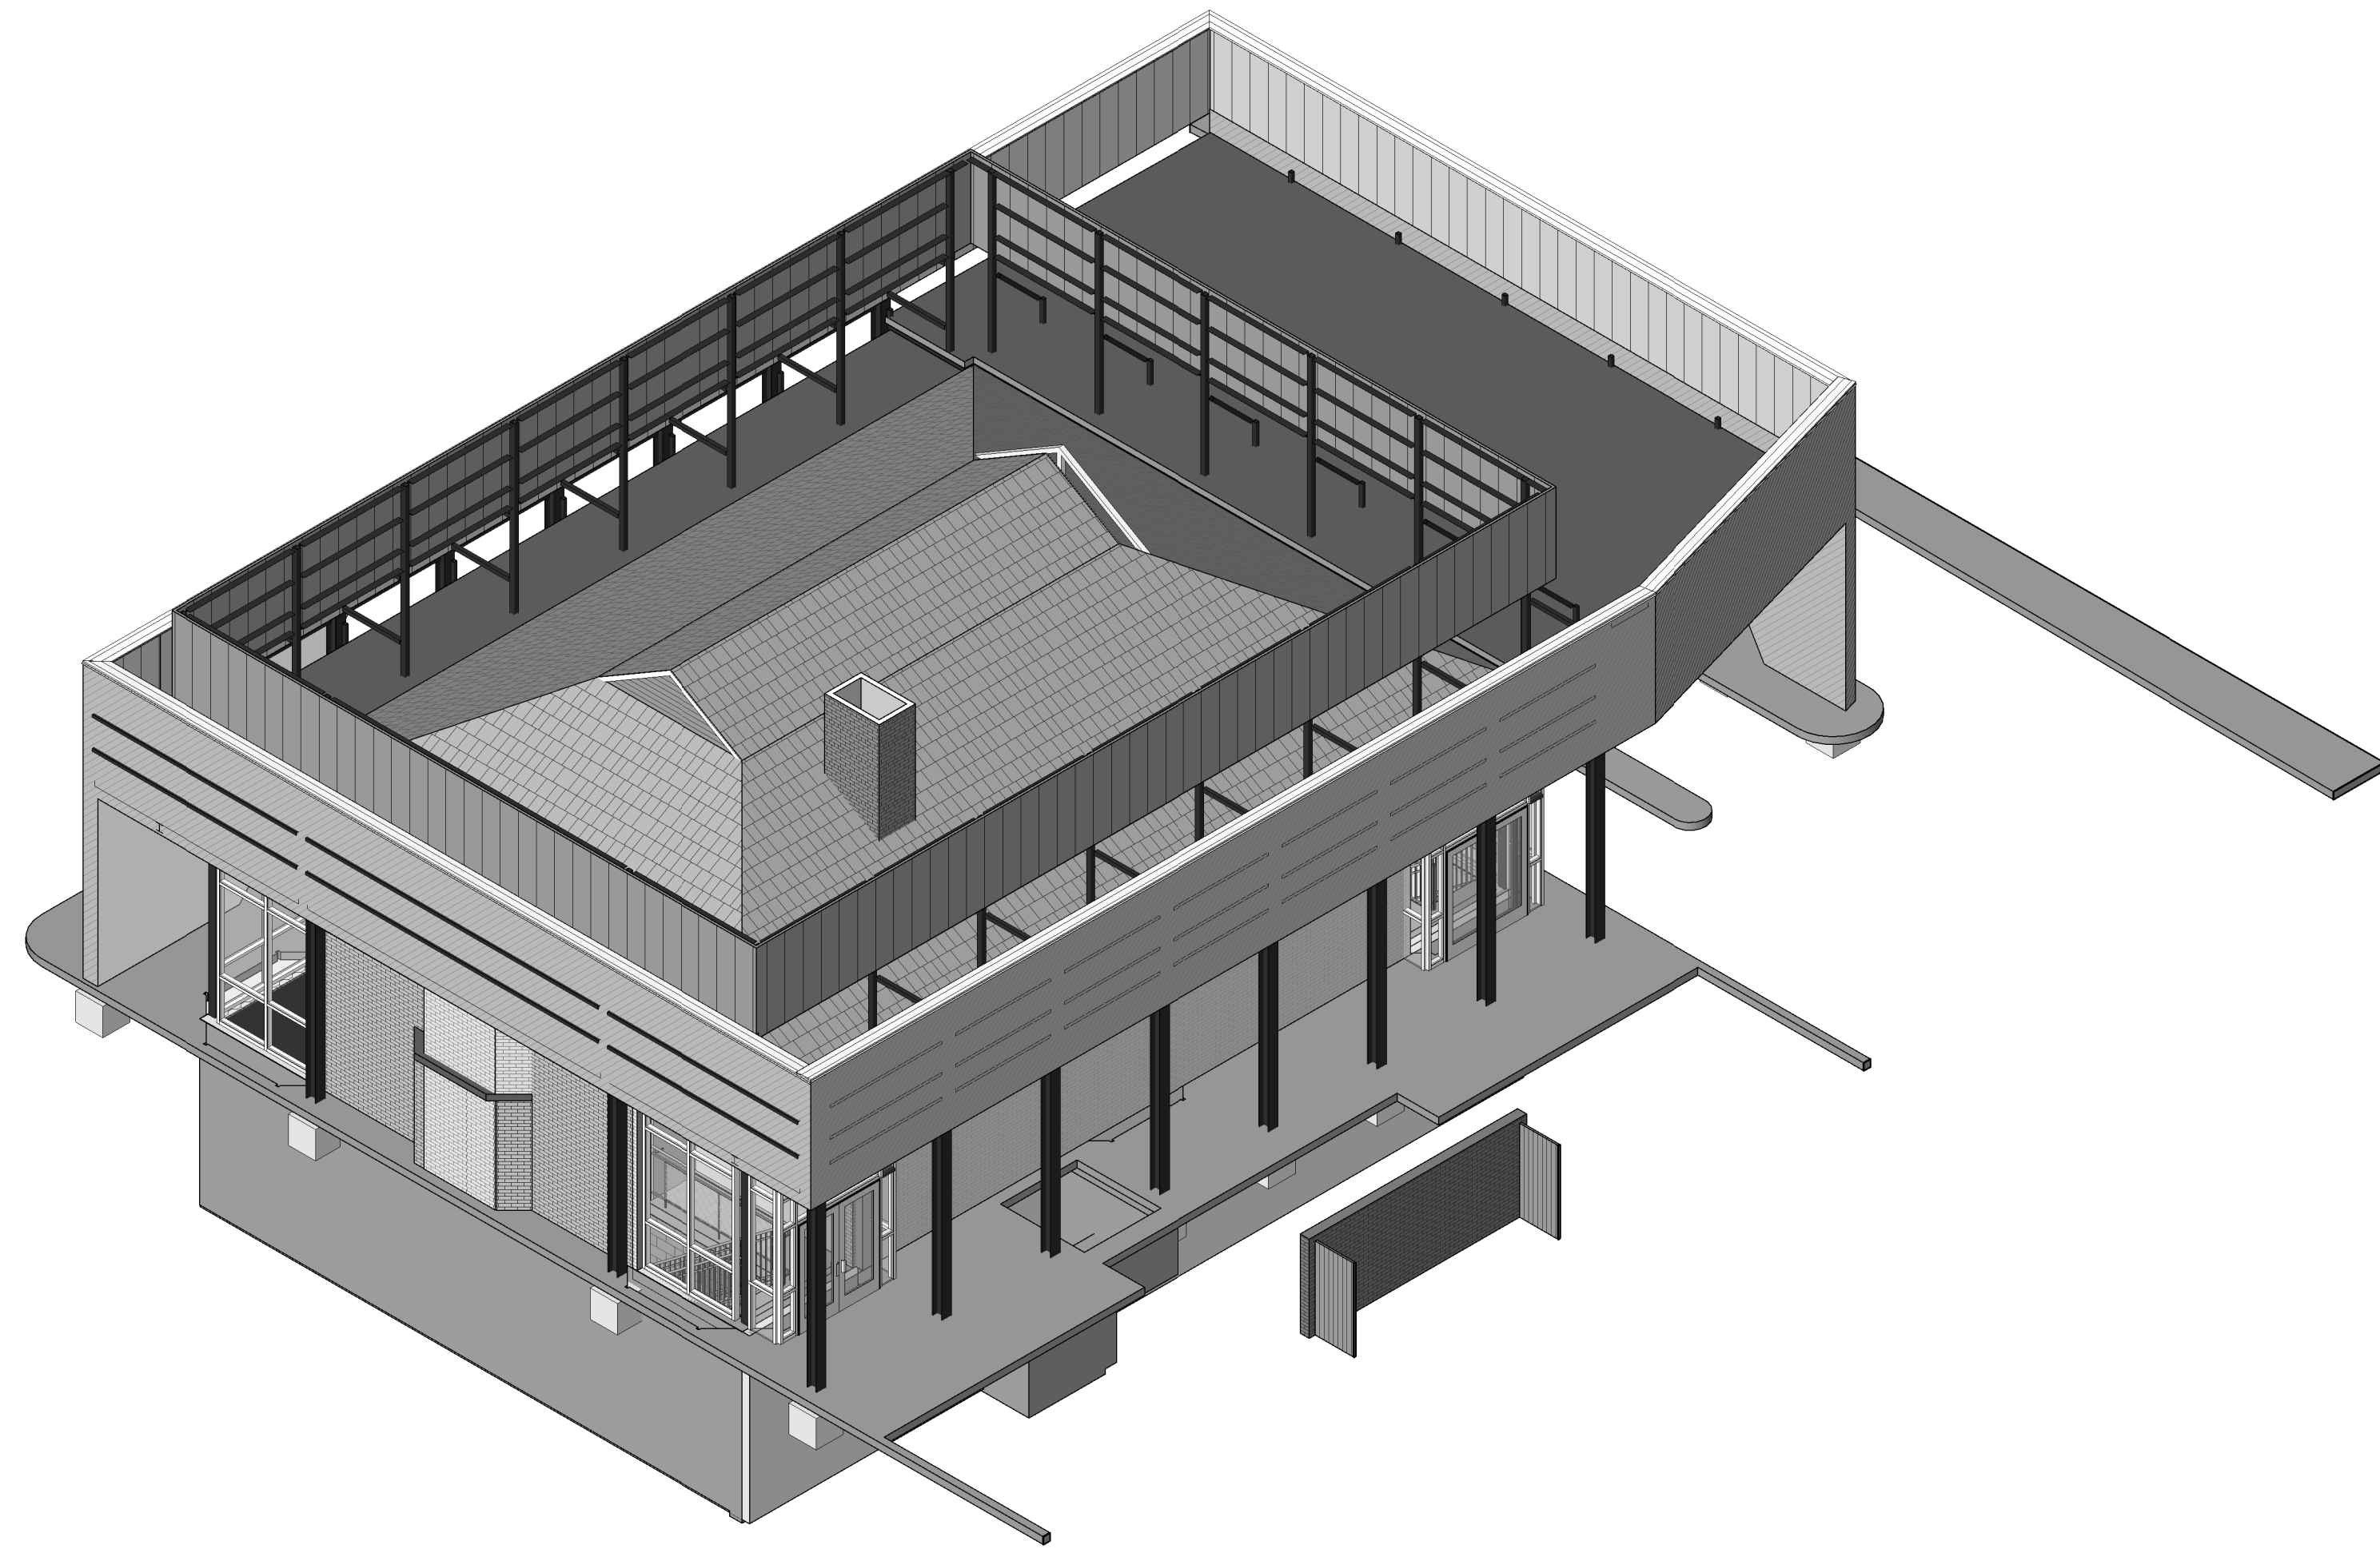


1 3D AXON - SE



2 3D AXON - NW

#	DATE	CHANGE DESCRIPTION


RENOVATION OF HEARTLAND BANK DUBLIN
 6000 FRANTZ ROAD
 DUBLIN, OH 43017
 FOR
HEARTLAND BANK

 300 SPRUCE STREET
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DRAWING TITLE:

AXONOMETRIC VIEWS


PROGRESS DRAWING NOT FOR CONSTRUCTION	11/30/2020	
	DRAWN BY: Author	CHECKED BY: Checker
	20022	
	A300	
FINAL DEVELOPMENT PLAN		

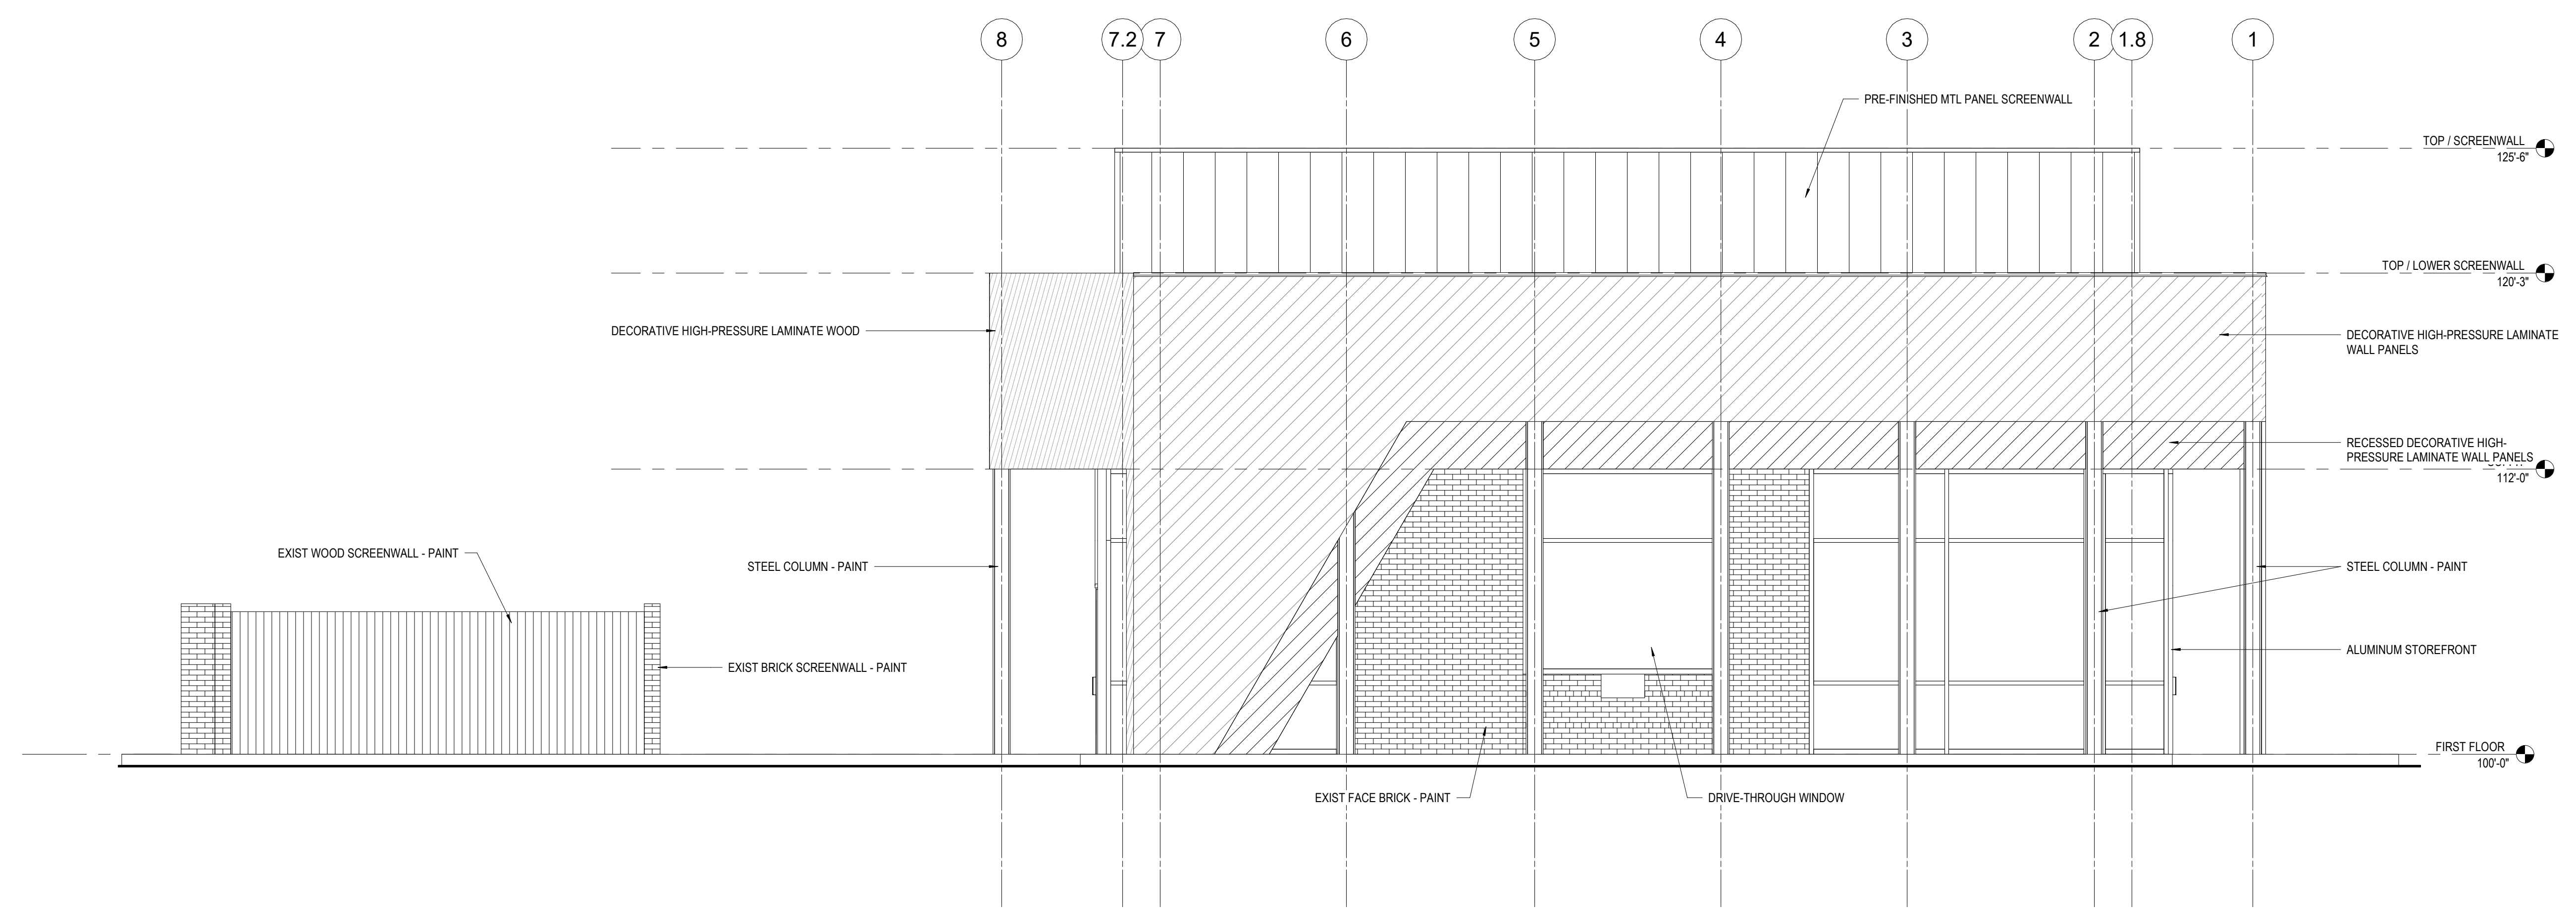

2 ELEVATION NORTH
1/4" = 1'-0" REF: 1 / A102

MATERIAL QUANTITIES - NORTH ELEVATION
 TOTAL - 1,318 SF
 BRICK - 151 SF (11.5%)
 STOREFRONT - 385 SF (29.2%)
 DECORATIVE HIGH-PRESSURE LAMINATE PANELS - 554 SF (42.0%)
 METAL SCREENWALL PANELS - 228 SF (17.3%)

TRANSPARENCY PERCENTAGES AT BUILDING
 NORTH ELEVATION - 385 SF GLAZING / 536 SF = 71.8%

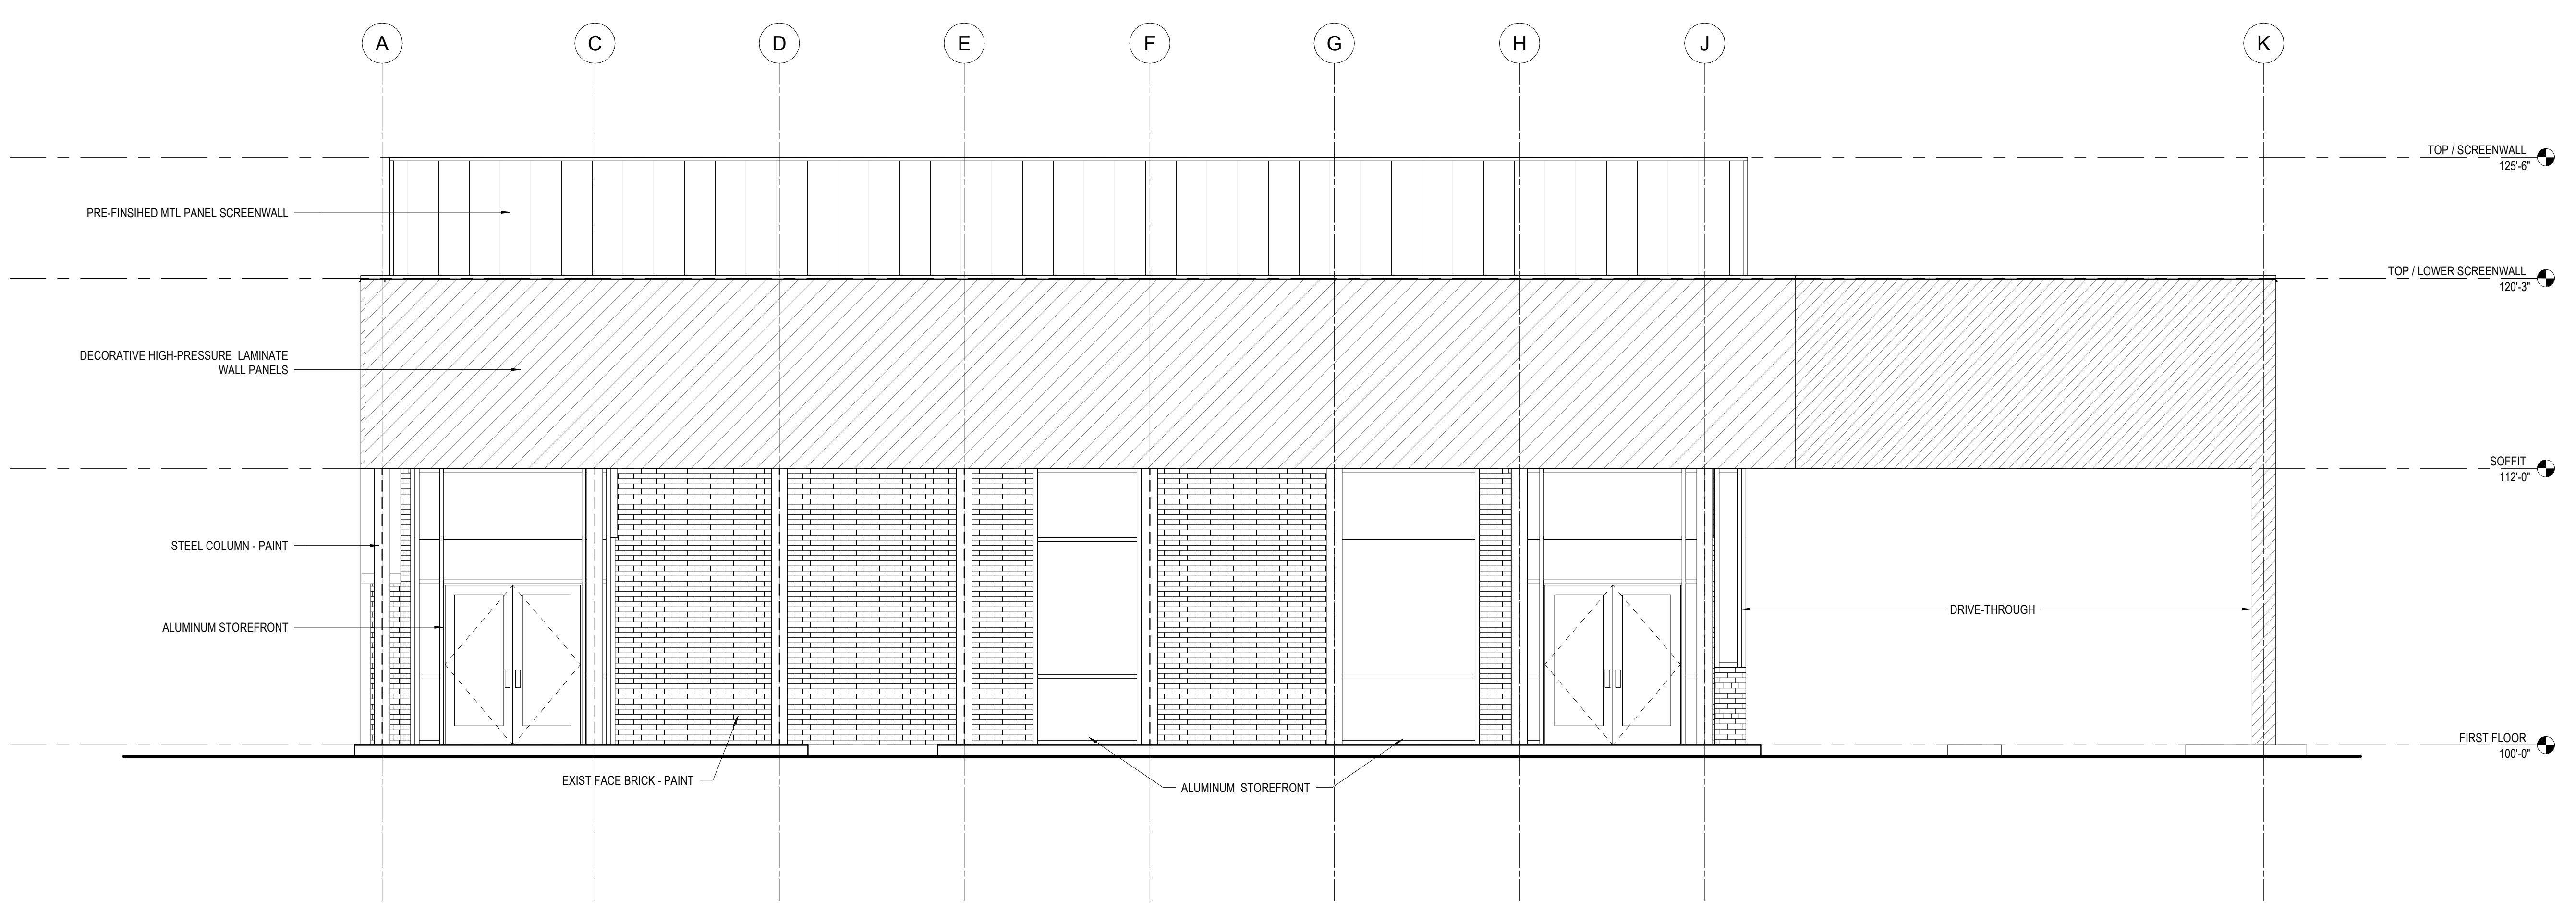

1 ELEVATION EAST
1/4" = 1'-0" REF: 1 / A102

MATERIAL QUANTITIES - EAST ELEVATION
 TOTAL - 1,692 SF
 BRICK - 370 SF (21.9%)
 STOREFRONT - 314 SF (18.5%)
 DECORATIVE HIGH-PRESSURE LAMINATE PANELS - 705 SF (41.6%)
 METAL SCREENWALL PANELS - 303 SF (18.0%)

TRANSPARENCY PERCENTAGES AT BUILDING
 EAST ELEVATION - 314 SF GLAZING / 684 SF = 45.9%

KEY VALUE	KEYNOTE TEXT
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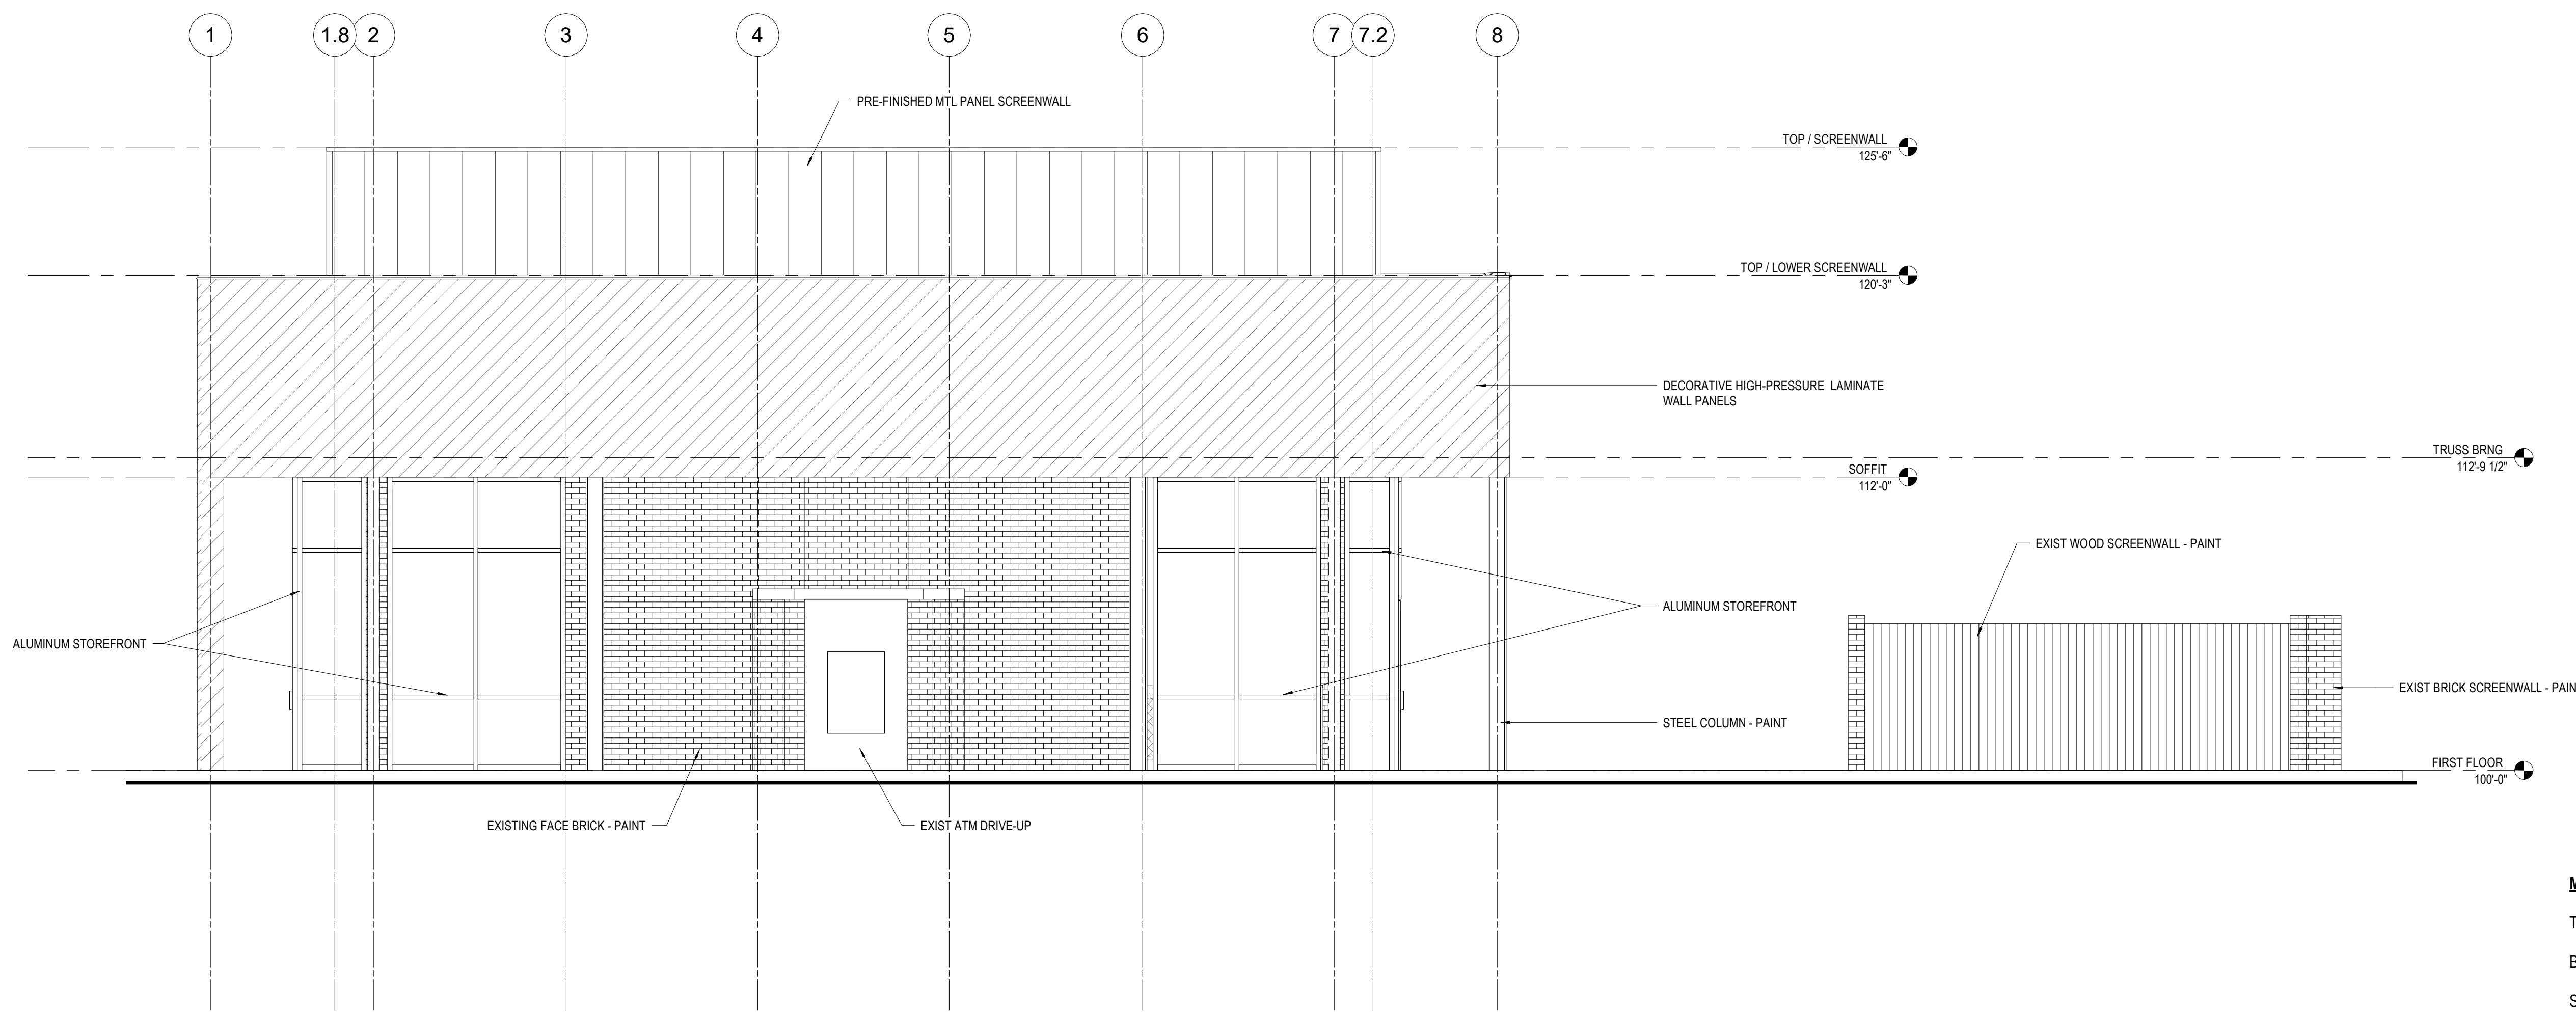
#	DATE	CHANGE DESCRIPTION
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RENOVATION OF HEARTLAND BANK DUBLIN
 5500 FRANTZ ROAD
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 FAX: (614) 280-8881

EXTERIOR ELEVATIONS - OVERALL


PROGRESS DRAWING NOT FOR CONSTRUCTION	11/30/2020
	DRAWN BY: xxx CHECKED BY: xxx
	20022
	A301
	FINAL DEVELOPMENT PLAN



2 ELEVATION SOUTH
1/4" = 1'-0" REF: 1 / A102

MATERIAL QUANTITIES - SOUTH ELEVATION
 TOTAL - 1,170 SF
 BRICK - 298 SF (25.5%)
 STOREFRONT - 182 SF (15.5%)
 DECORATIVE HIGH-PRESSURE LAMINATE PANELS - 462 SF (39.5%)
 METAL SCREENWALL PANELS - 228 SF (19.5%)

TRANSPARENCY PERCENTAGES AT BUILDING
 SOUTH ELEVATION - 182 SF GLAZING / 480 SF = 37.9%

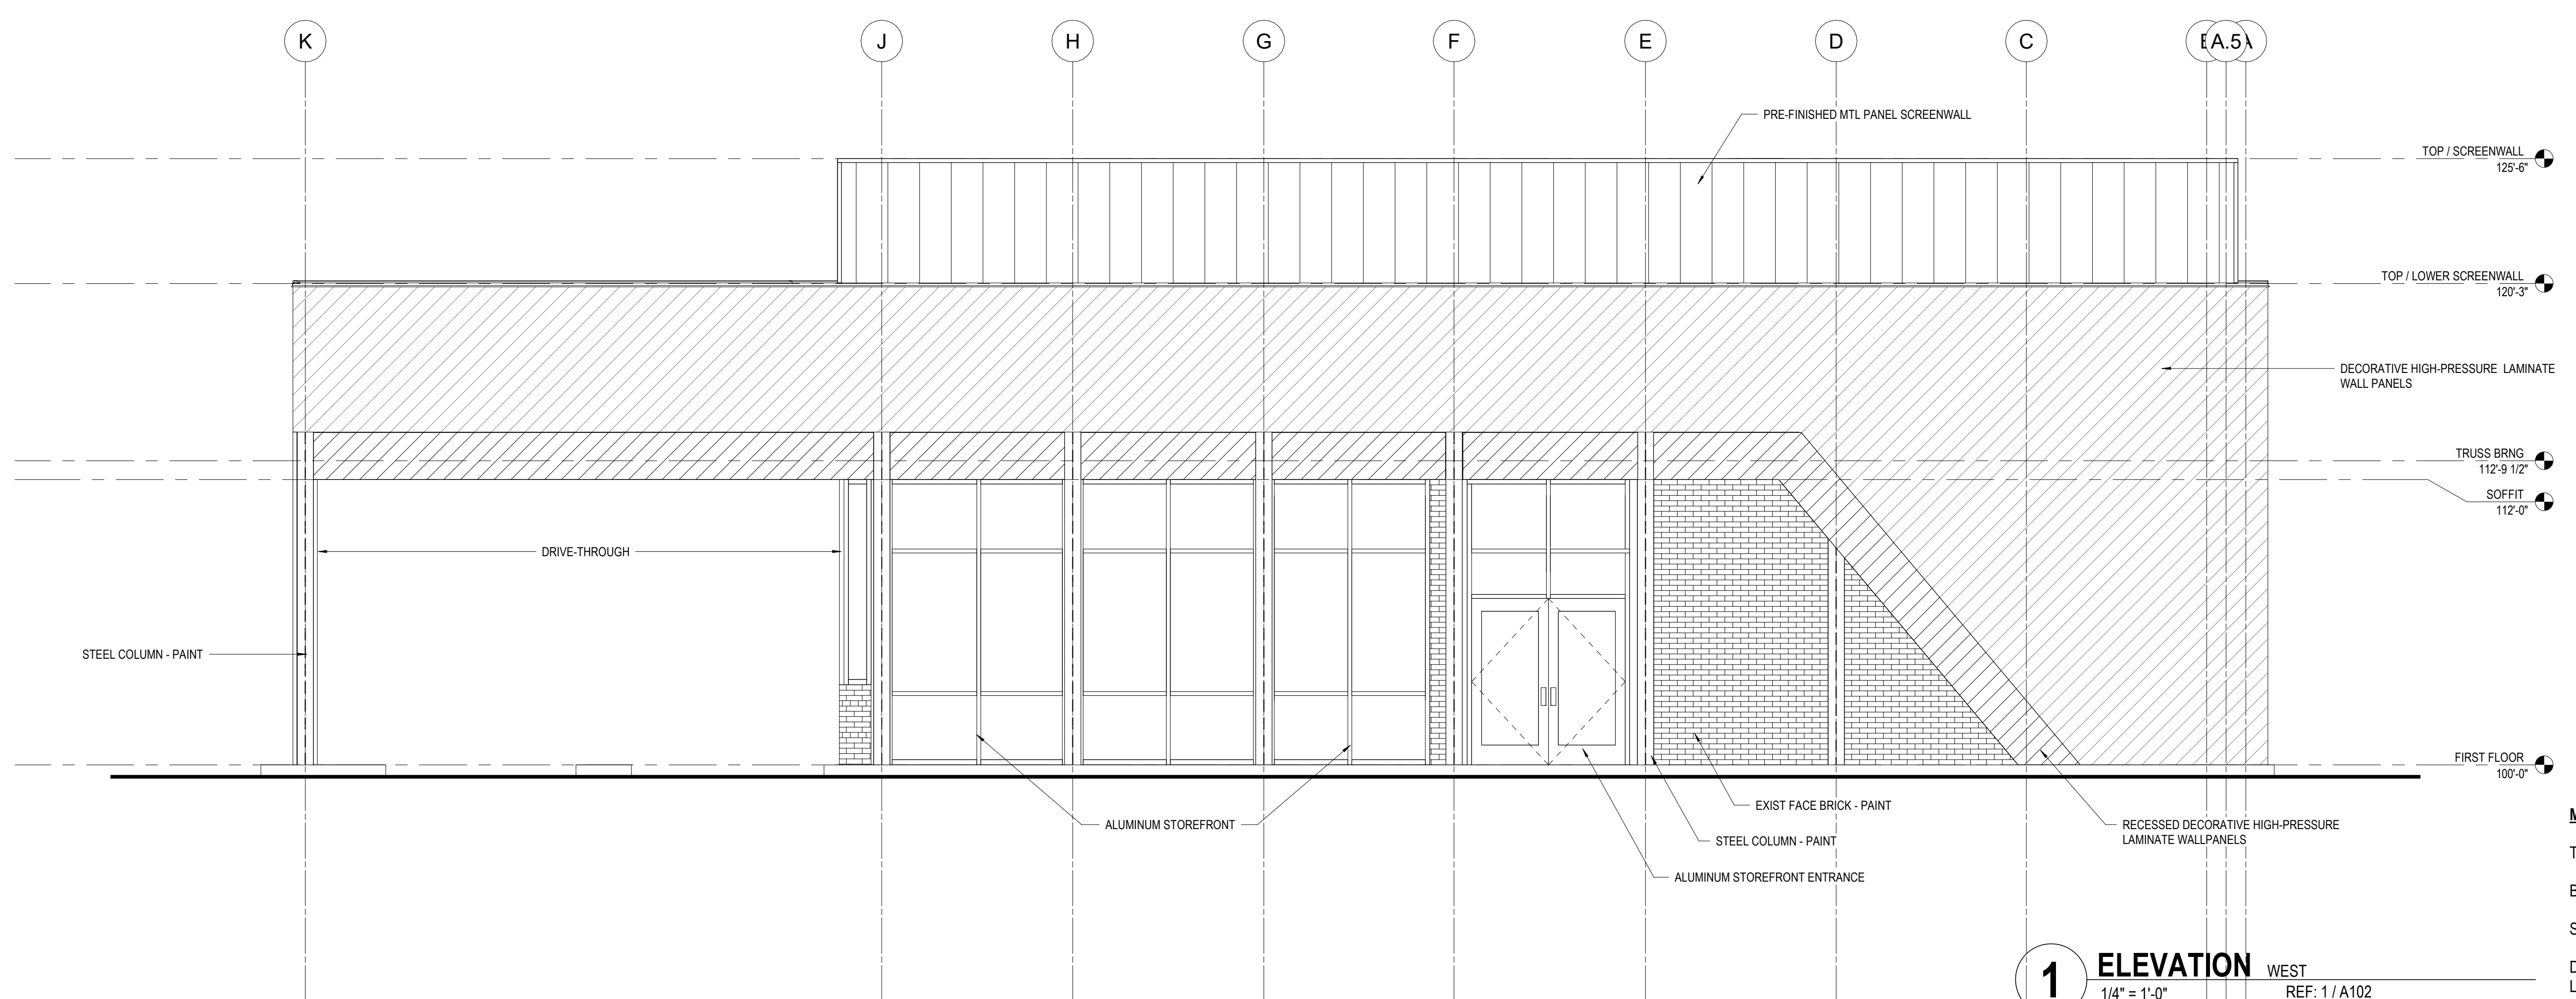

1 ELEVATION WEST
1/4" = 1'-0" REF: 1 / A102

MATERIAL QUANTITIES - EAST ELEVATION
 TOTAL - 1,861 SF
 BRICK - 248 SF (13.3%)
 STOREFRONT - 436 SF (23.4%)
 DECORATIVE HIGH-PRESSURE LAMINATE PANELS - 874 SF (47.0%)
 METAL SCREENWALL PANELS - 303 SF (16.3%)

TRANSPARENCY PERCENTAGES AT BUILDING
 WEST ELEVATION - 436 SF GLAZING / 684 SF = 63.7%


#	DATE	CHANGE DESCRIPTION

RENOVATION OF HEARTLAND BANK DUBLIN
 5500 PRANTZ ROAD
 DUBLIN, OH 43017
 FOR
HEARTLAND BANK


MOODY-NOLAN
 300 SPRUCE STREET
 SUITE 300
 COLUMBUS, OHIO 43215
 PHONE: (614) 461-4664
 FAX: (614) 280-8881

DRAWING TITLE:
EXTERIOR ELEVATIONS - OVERALL

PROGRESS DRAWING NOT FOR CONSTRUCTION	11/30/2020	
	DRAWN BY: XXXX	CHECKED BY: XXXX
	20022	
A302		FINAL DEVELOPMENT PLAN

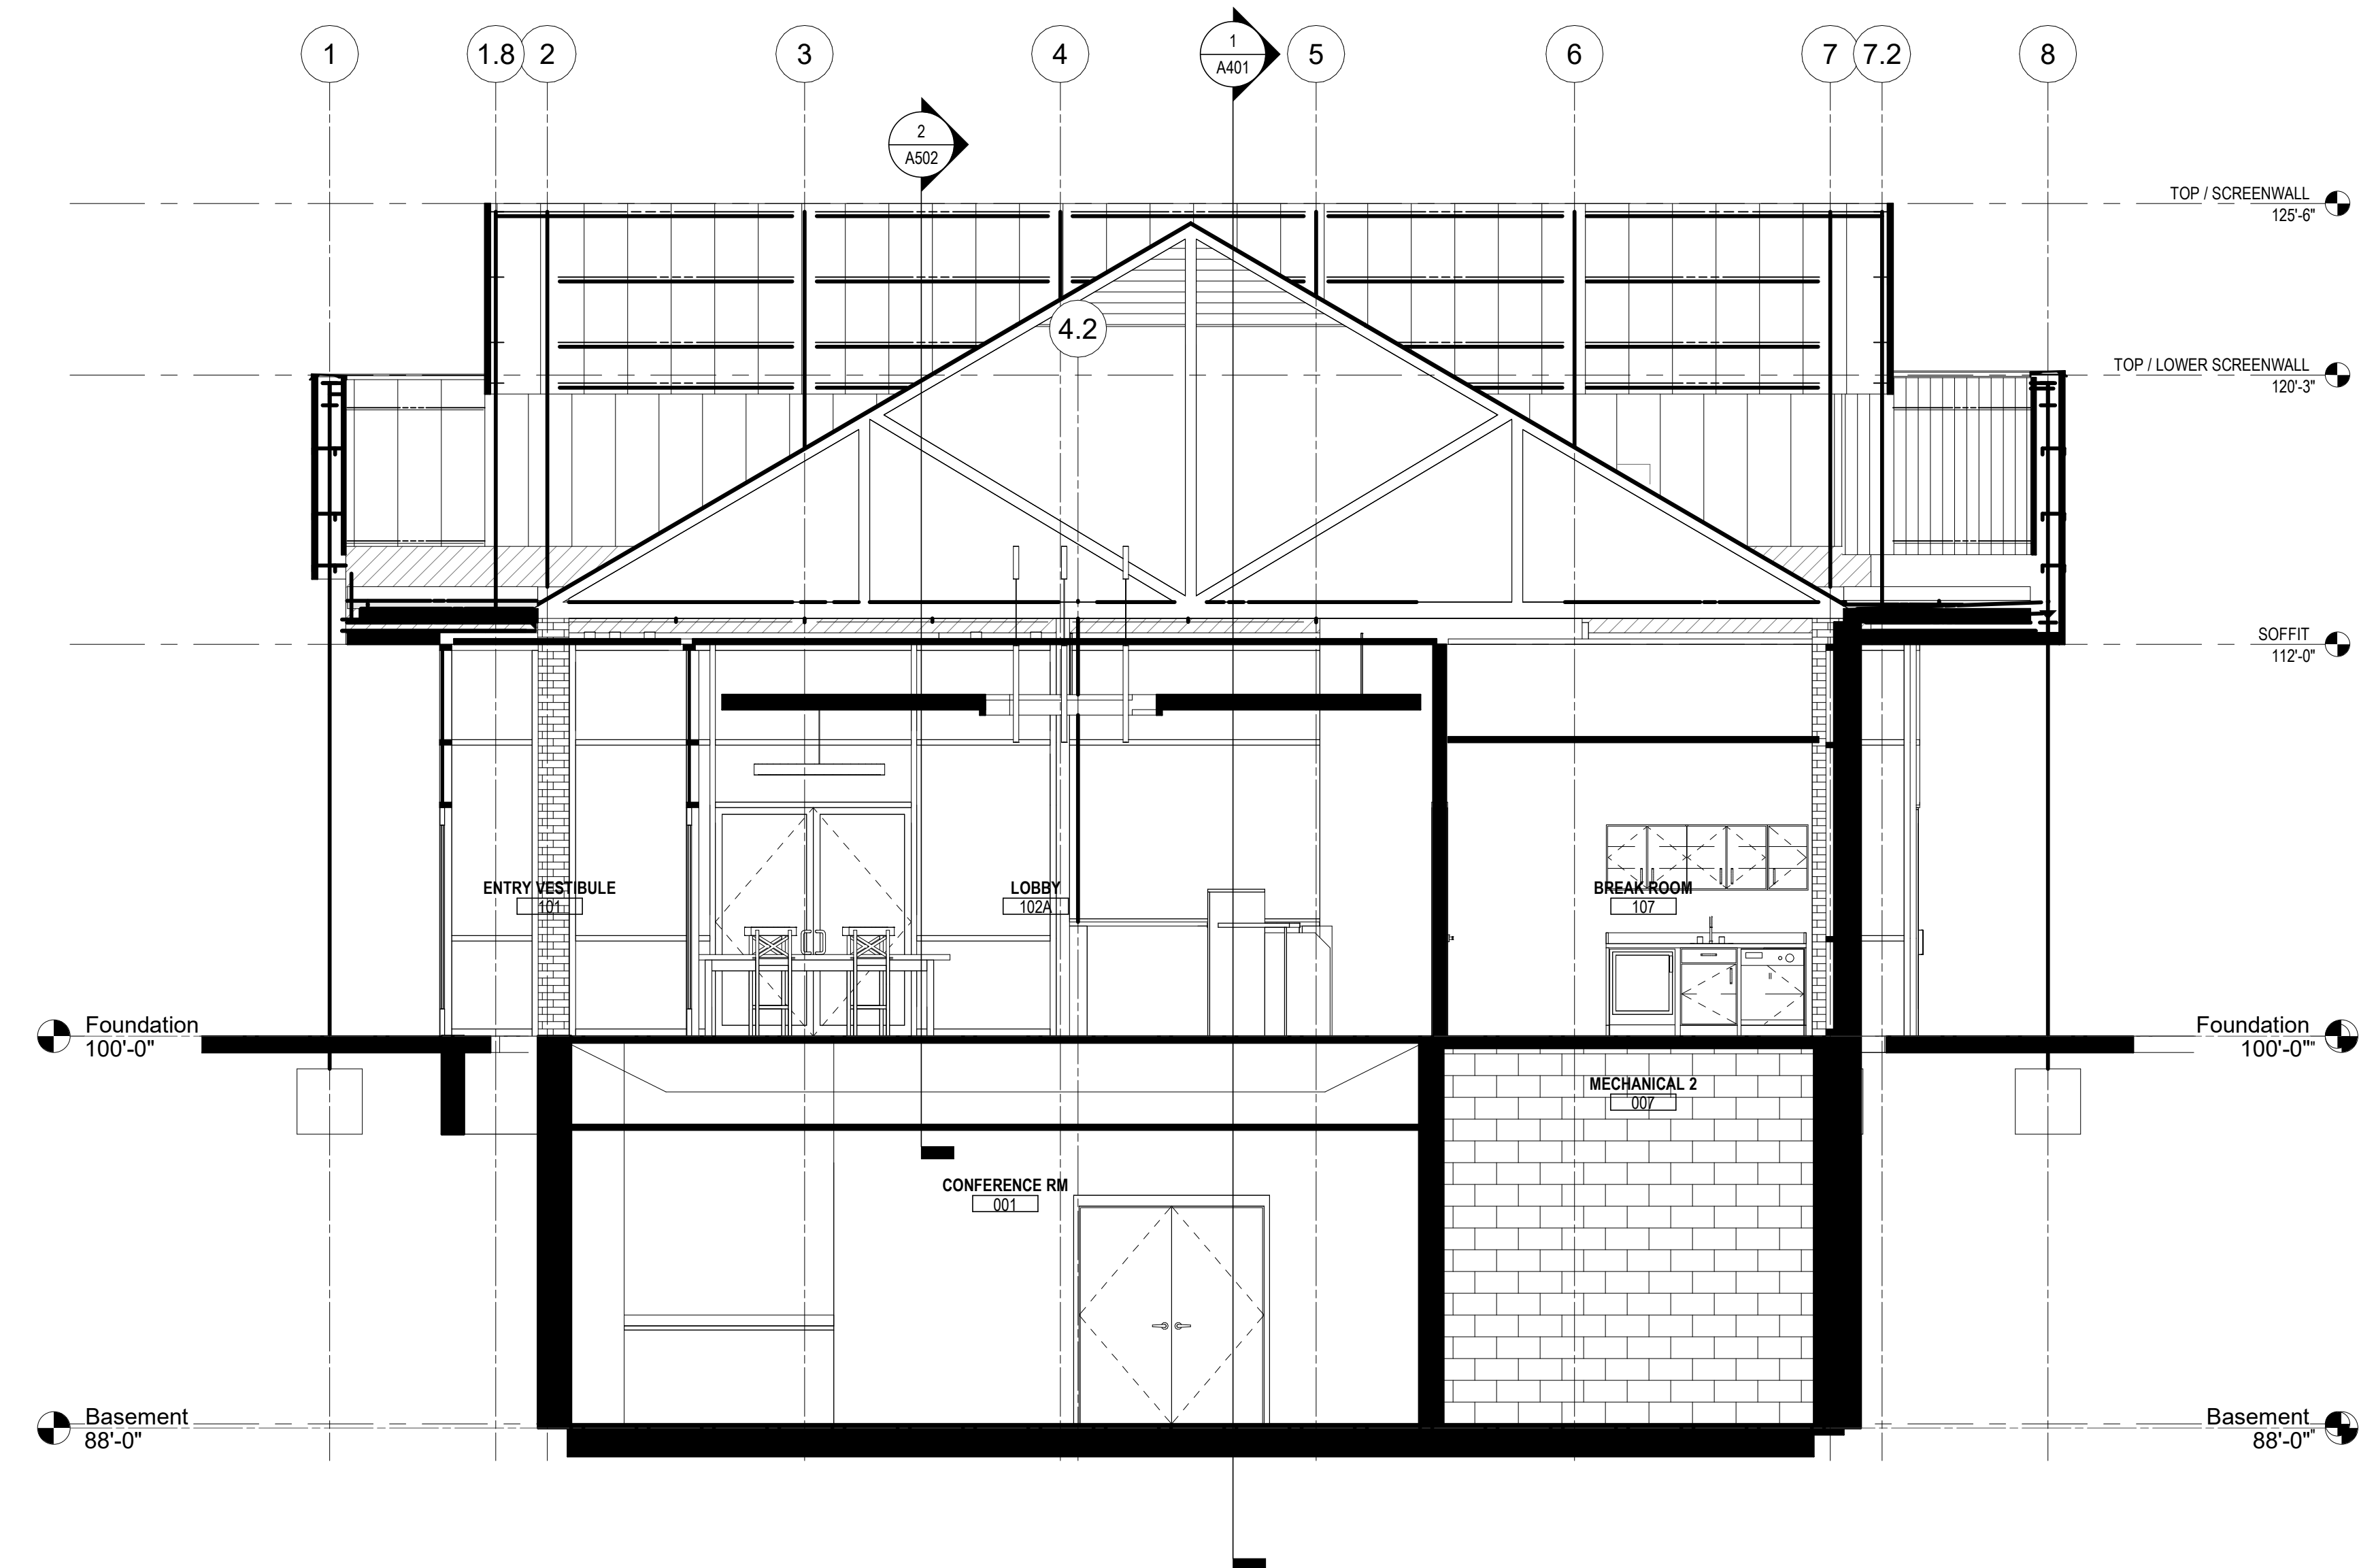

2 EAST-WEST BUILDING SECTION
1/4" = 1'-0"

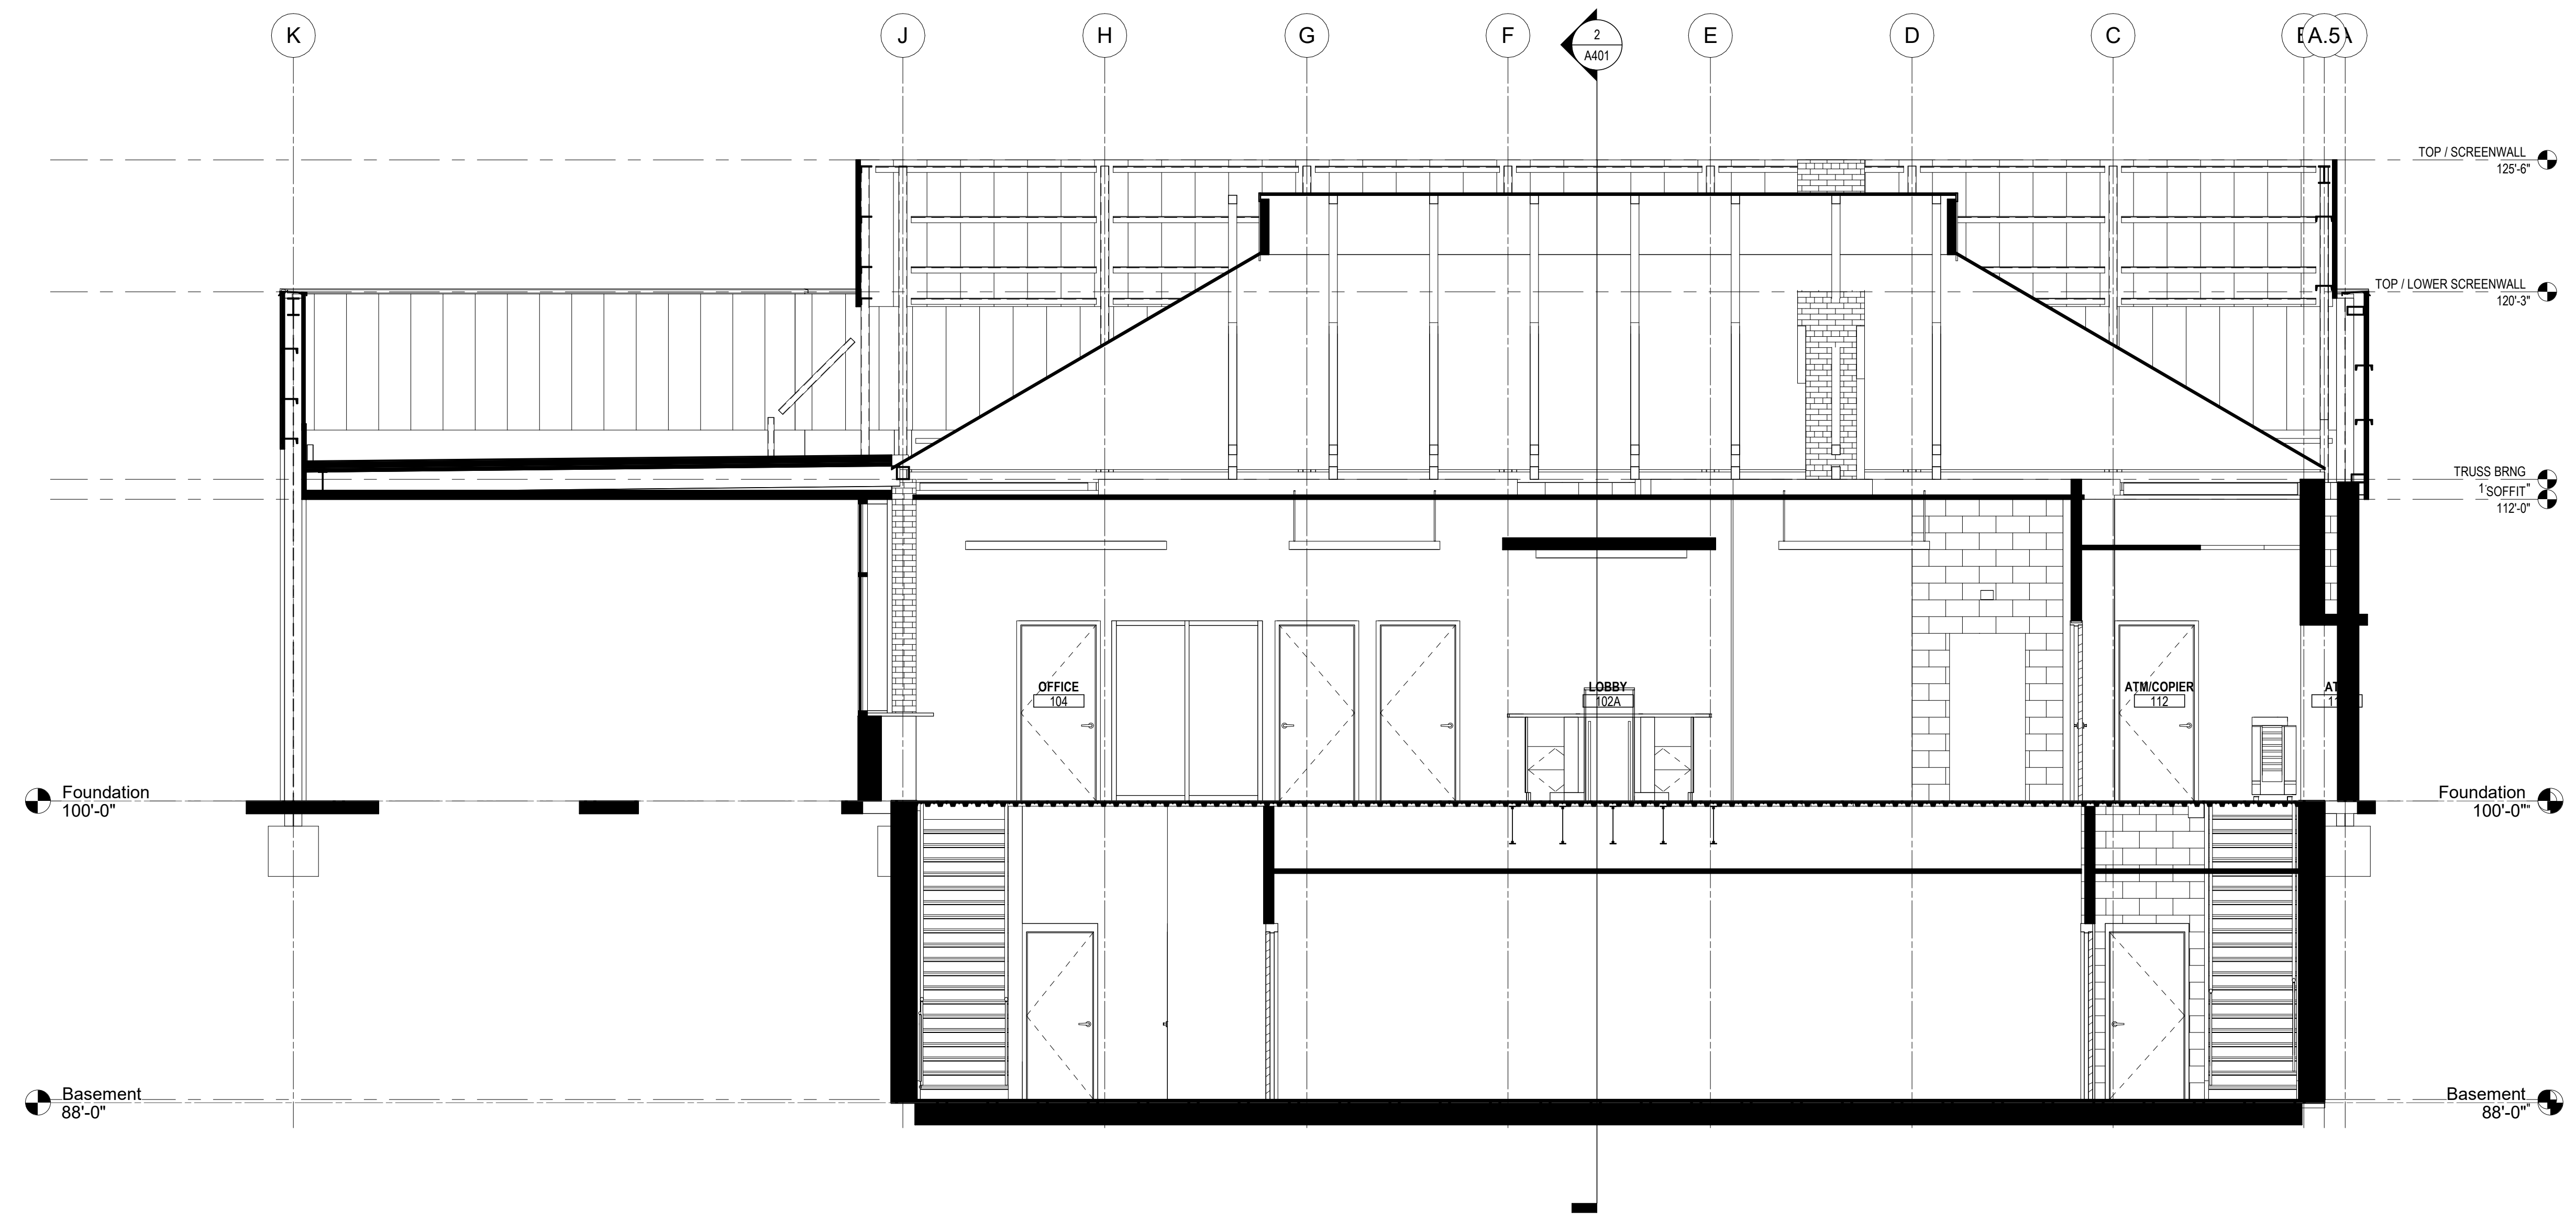

1 NORTH-SOUTH BUILDING SECTION
1/4" = 1'-0"

GENERAL NOTES - BUILDING SECTIONS

1. X

KEYNOTE LEGEND

KEY VALUE KEYNOTE TEXT


#	DATE	CHANGE DESCRIPTION

RENOVATION OF HEARTLAND BANK DUBLIN
5500 PRANTZ ROAD
DUBLIN, OH 43017
FOR
HEARTLAND BANK


MOODY-NOLAN
300 SPRUCE STREET
SUITE 300
COLUMBUS, OHIO 43215
PHONE: (614) 461-4664
FAX: (614) 280-8881

BUILDING SECTIONS

PROGRESS DRAWING NOT FOR CONSTRUCTION	11/30/2020
	DRAWN BY: XXXX CHECKED BY: XXXX
	20022
	A401
	FINAL DEVELOPMENT PLAN

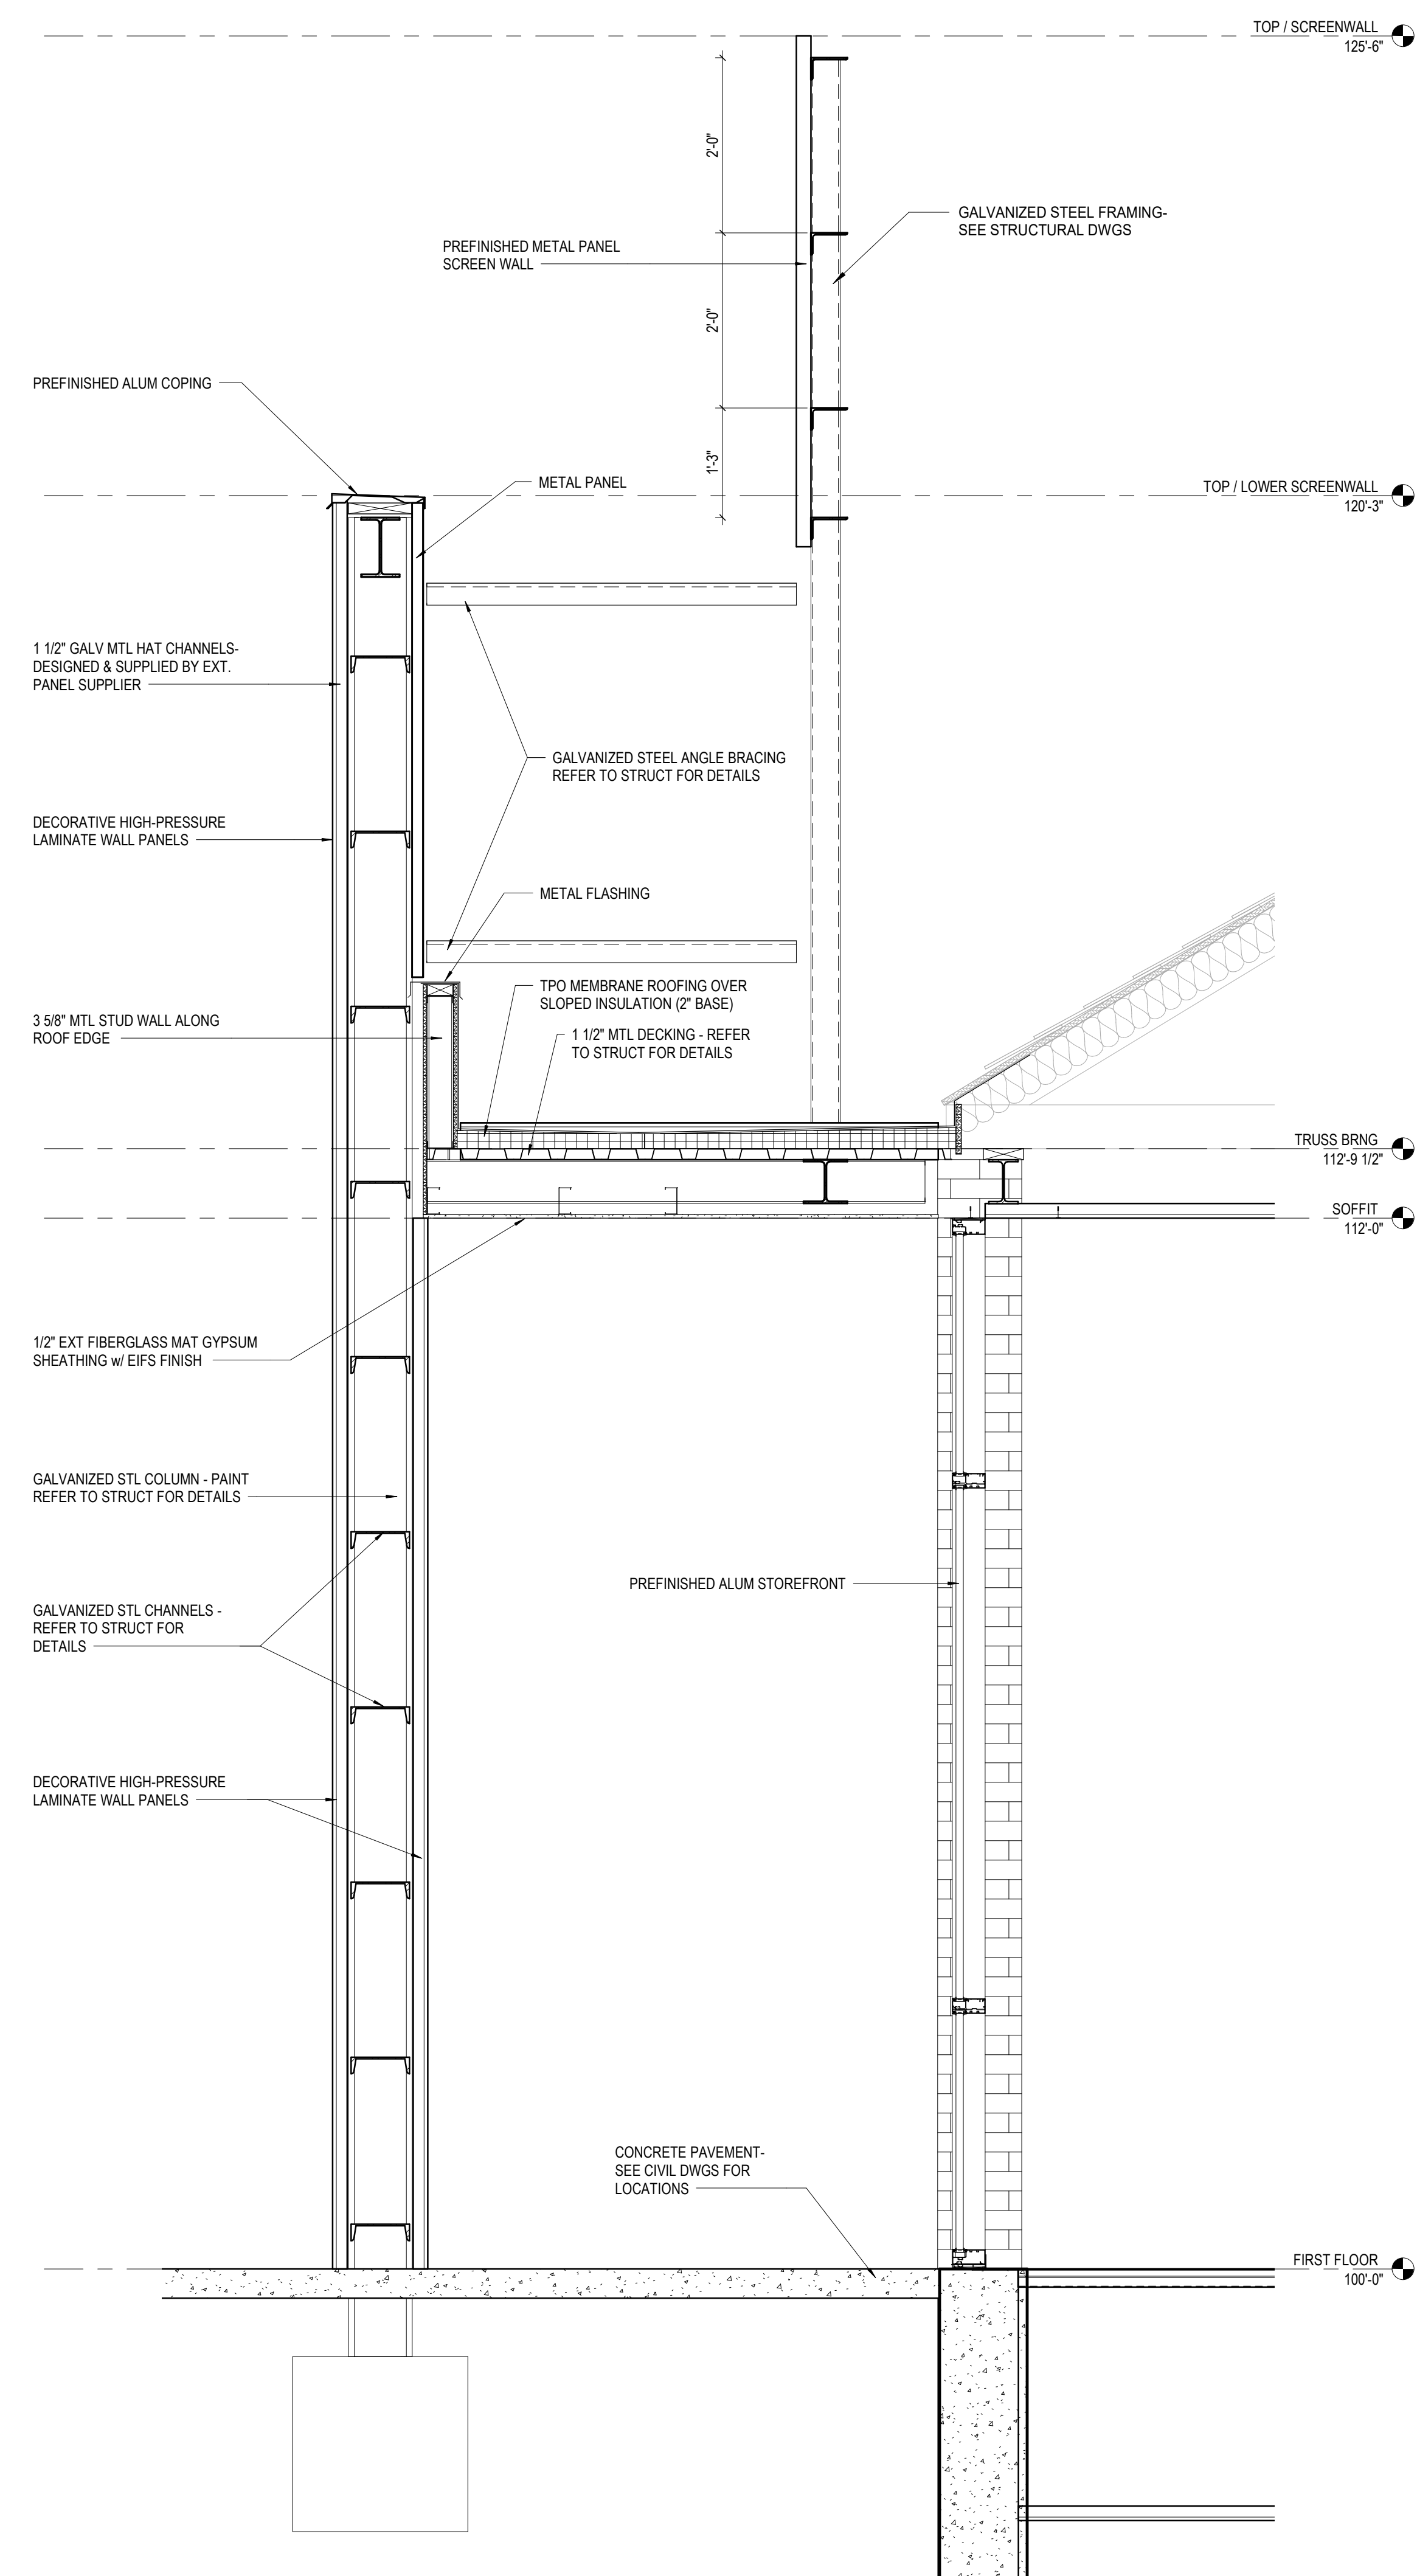

2 SECTION WEST DOUBLE WALL
 3/4" = 1'-0" REF: 1 / A10

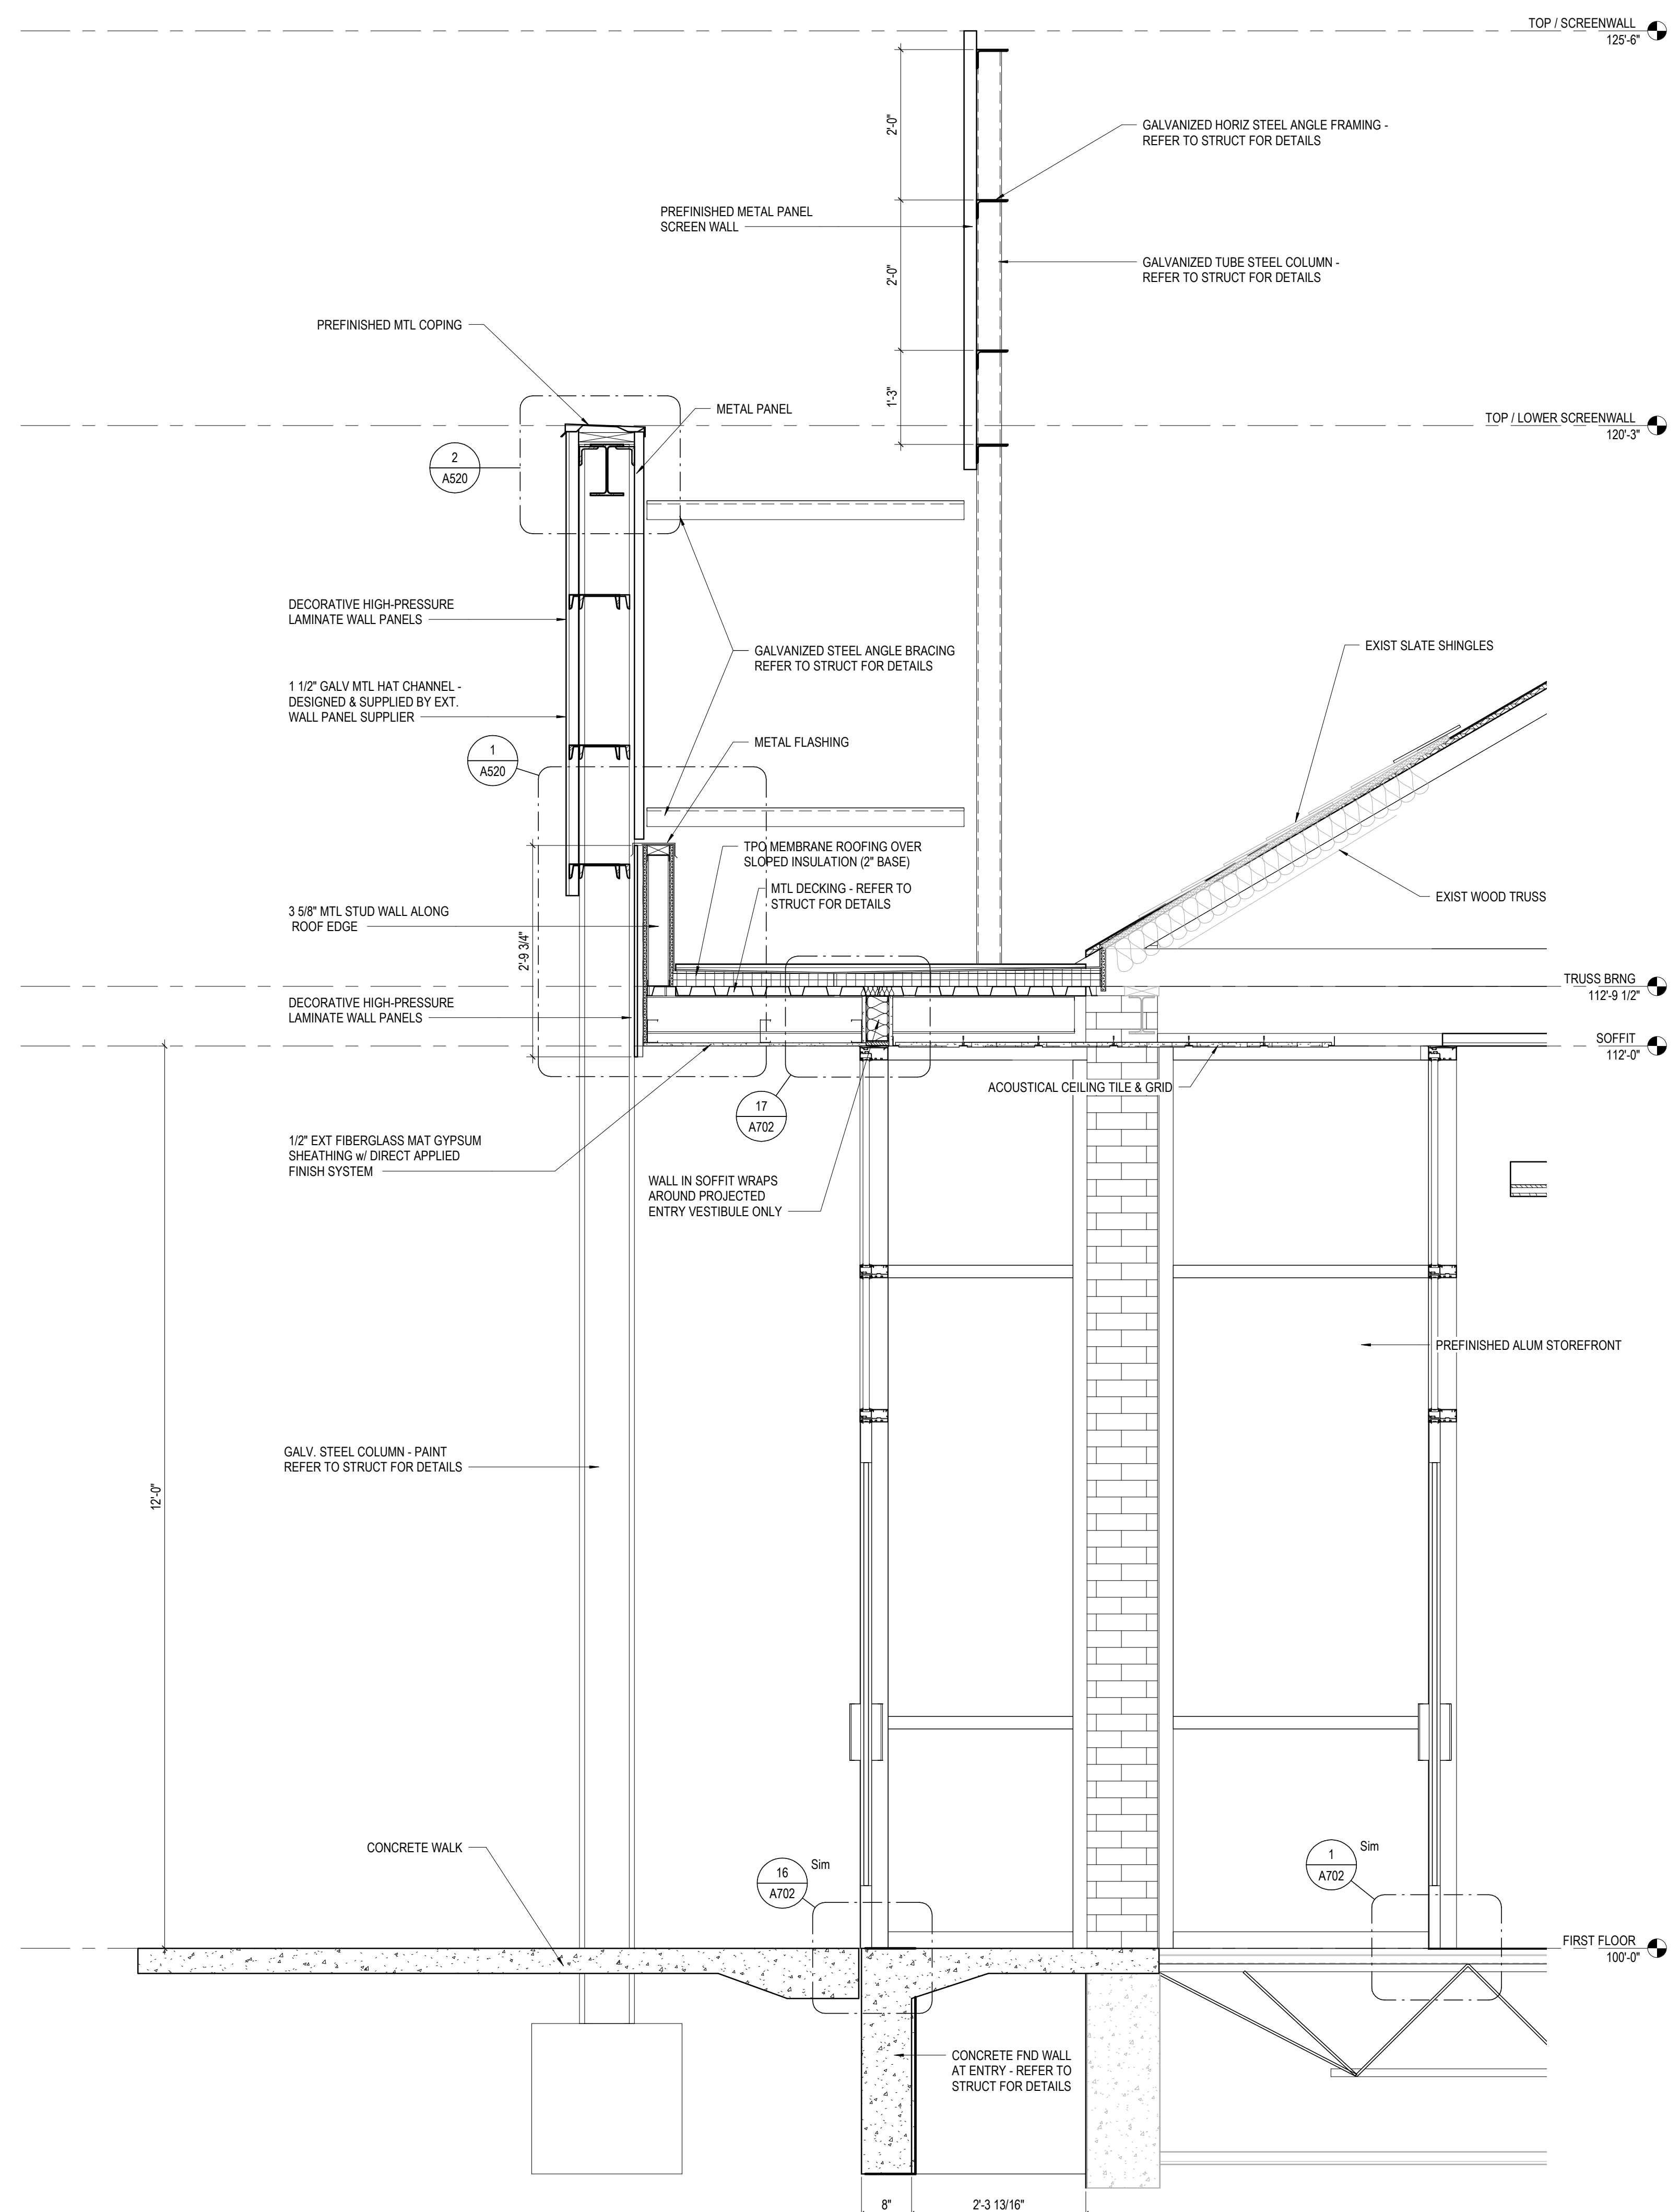

1 SECTION WEST MAIN ENTRY
 3/4" = 1'-0" REF: 1 / A102

GENERAL NOTES - WALL SECTIONS

1. X

KEYNOTE LEGEND

#	DATE	CHANGE DESCRIPTION


RENOVATION OF HEARTLAND BANK DUBLIN
 5300 PRANTZ ROAD
 DUBLIN, OH 43017
 FOR
HEARTLAND BANK

MOODY-NOLAN
 300 SPRUCE STREET
 SUITE 300
 COLUMBUS, OHIO 43215
 PHONE: (614) 461-4664
 FAX: (614) 280-8881


WALL SECTIONS

DRAWING TITLE:

PROGRESS DRAWING NOT FOR CONSTRUCTION	11/30/2020 DRAWN BY: XXXX CHECKED BY: XXXX
	20022
	A501
	FINAL DEVELOPMENT PLAN

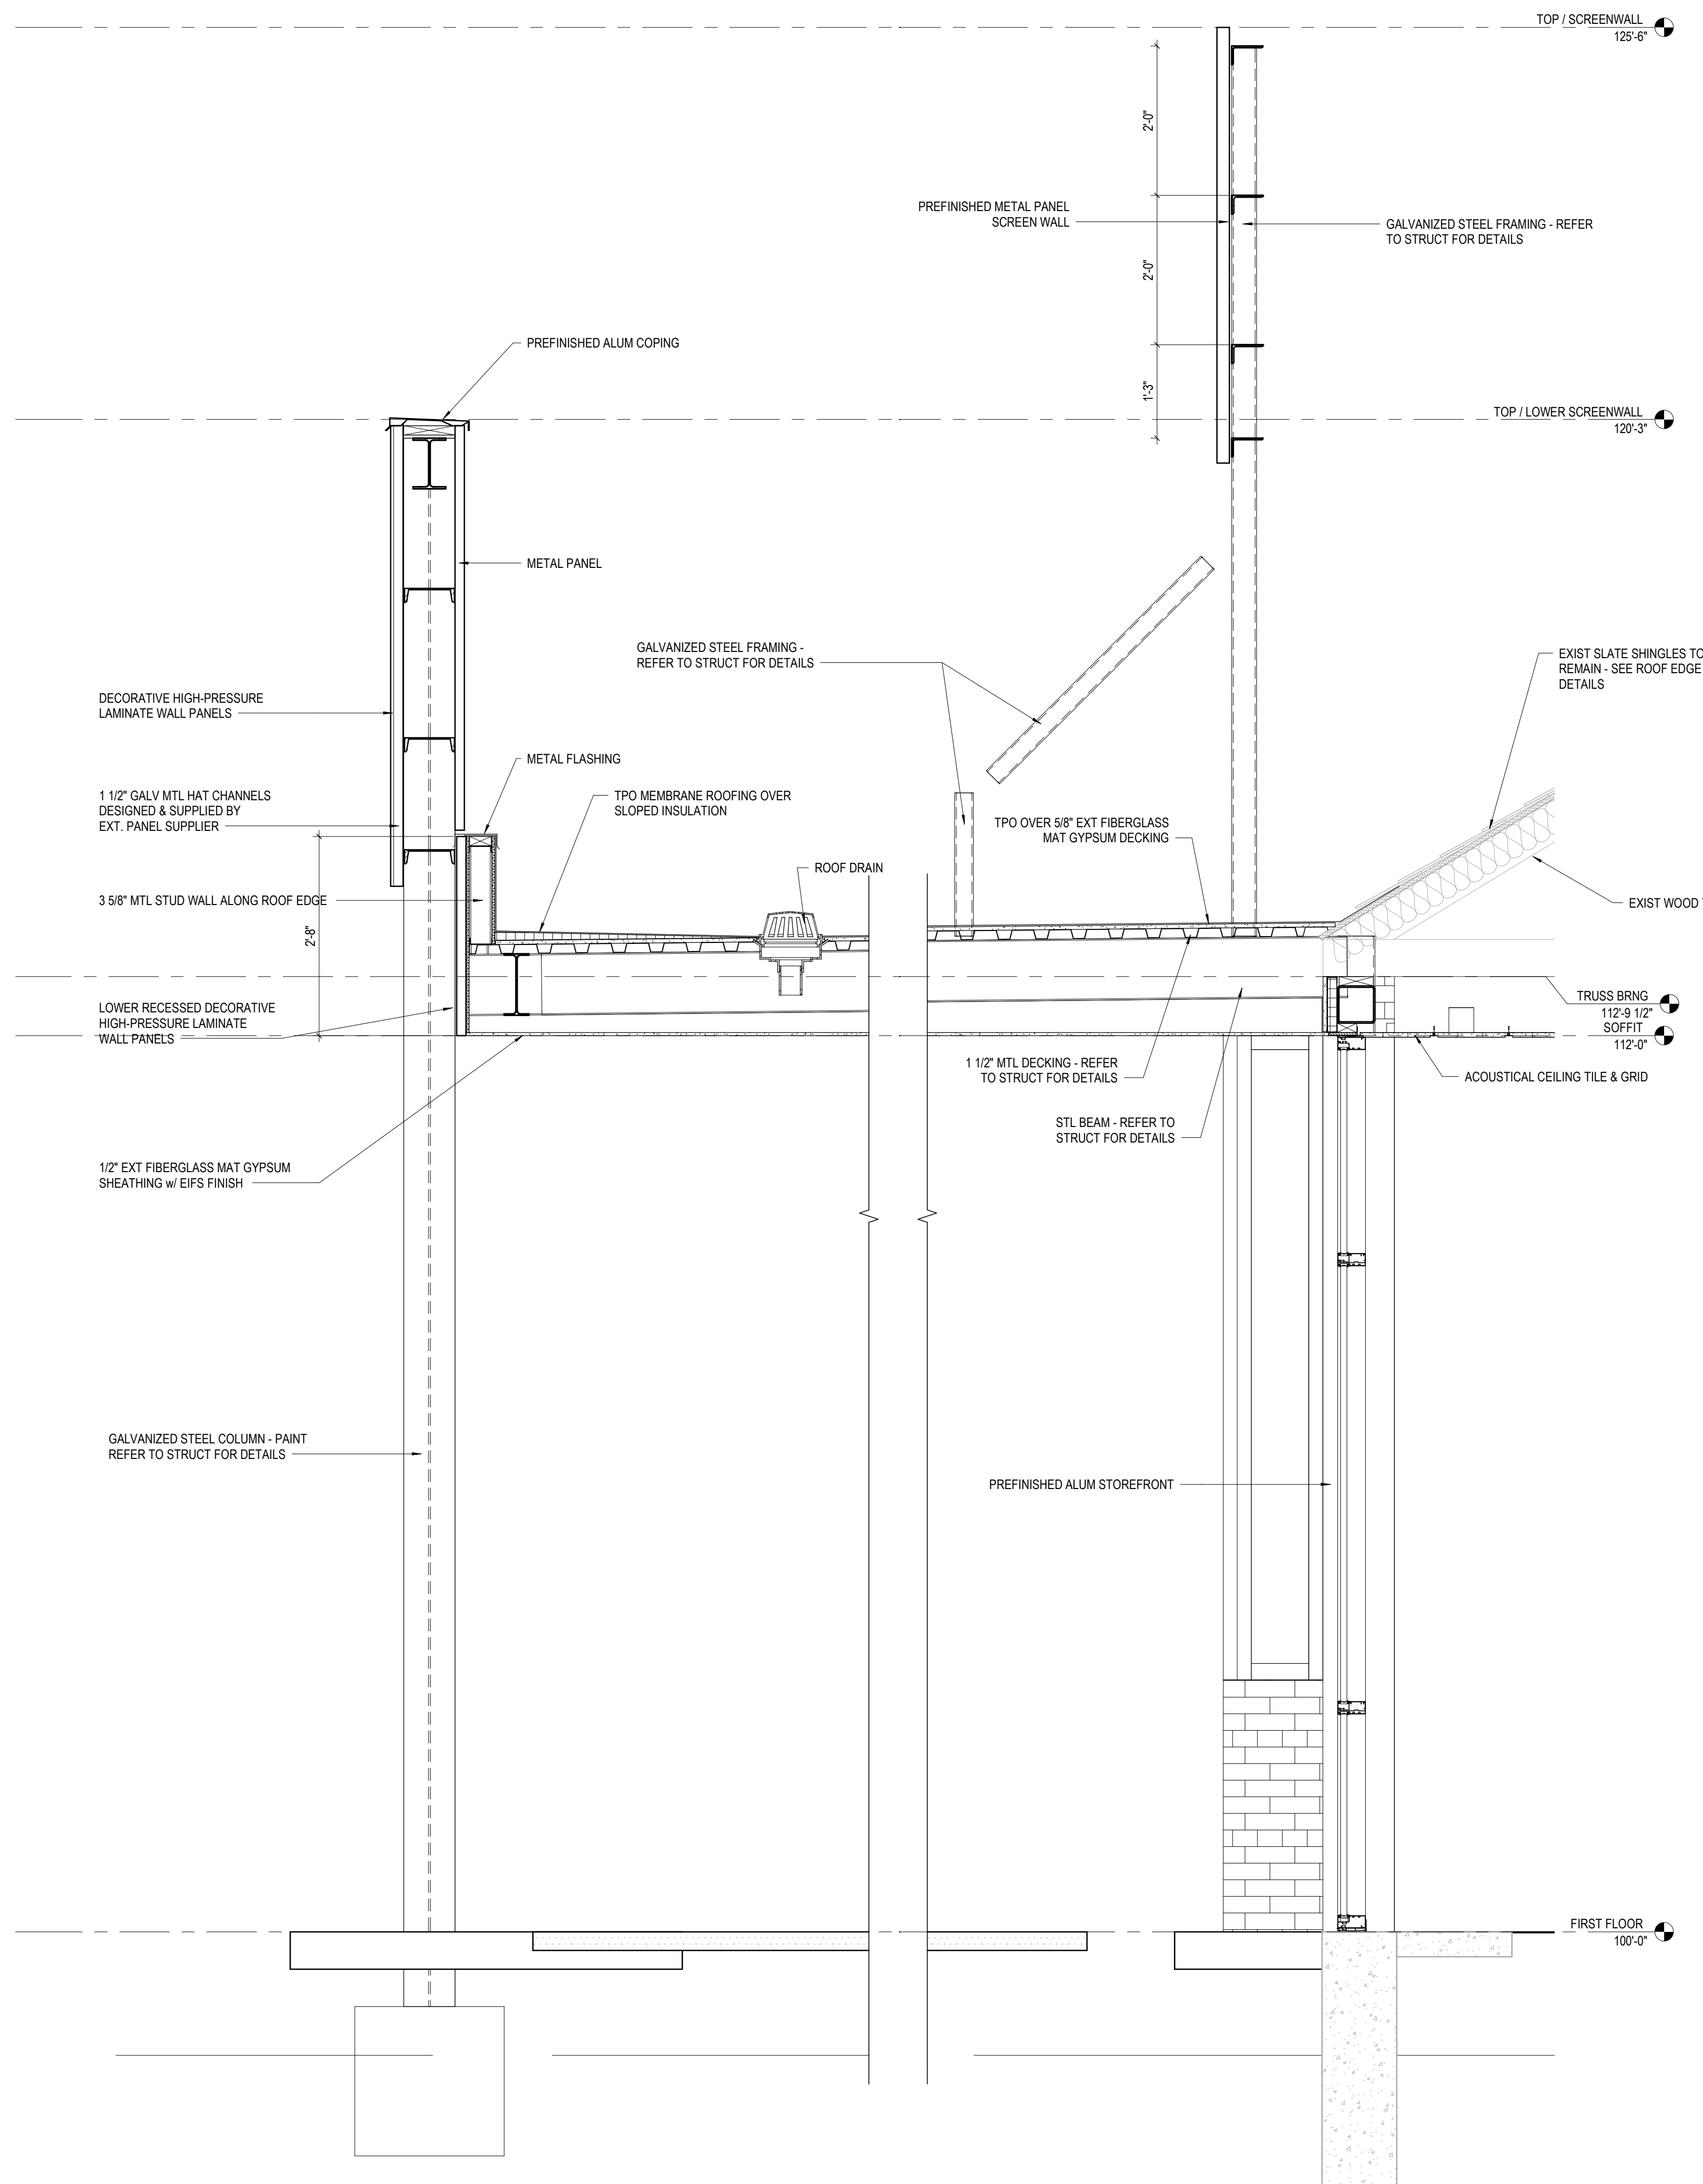

2 SECTION DRIVE-THRU
 3/4" = 1'-0" REF: 1 / A102

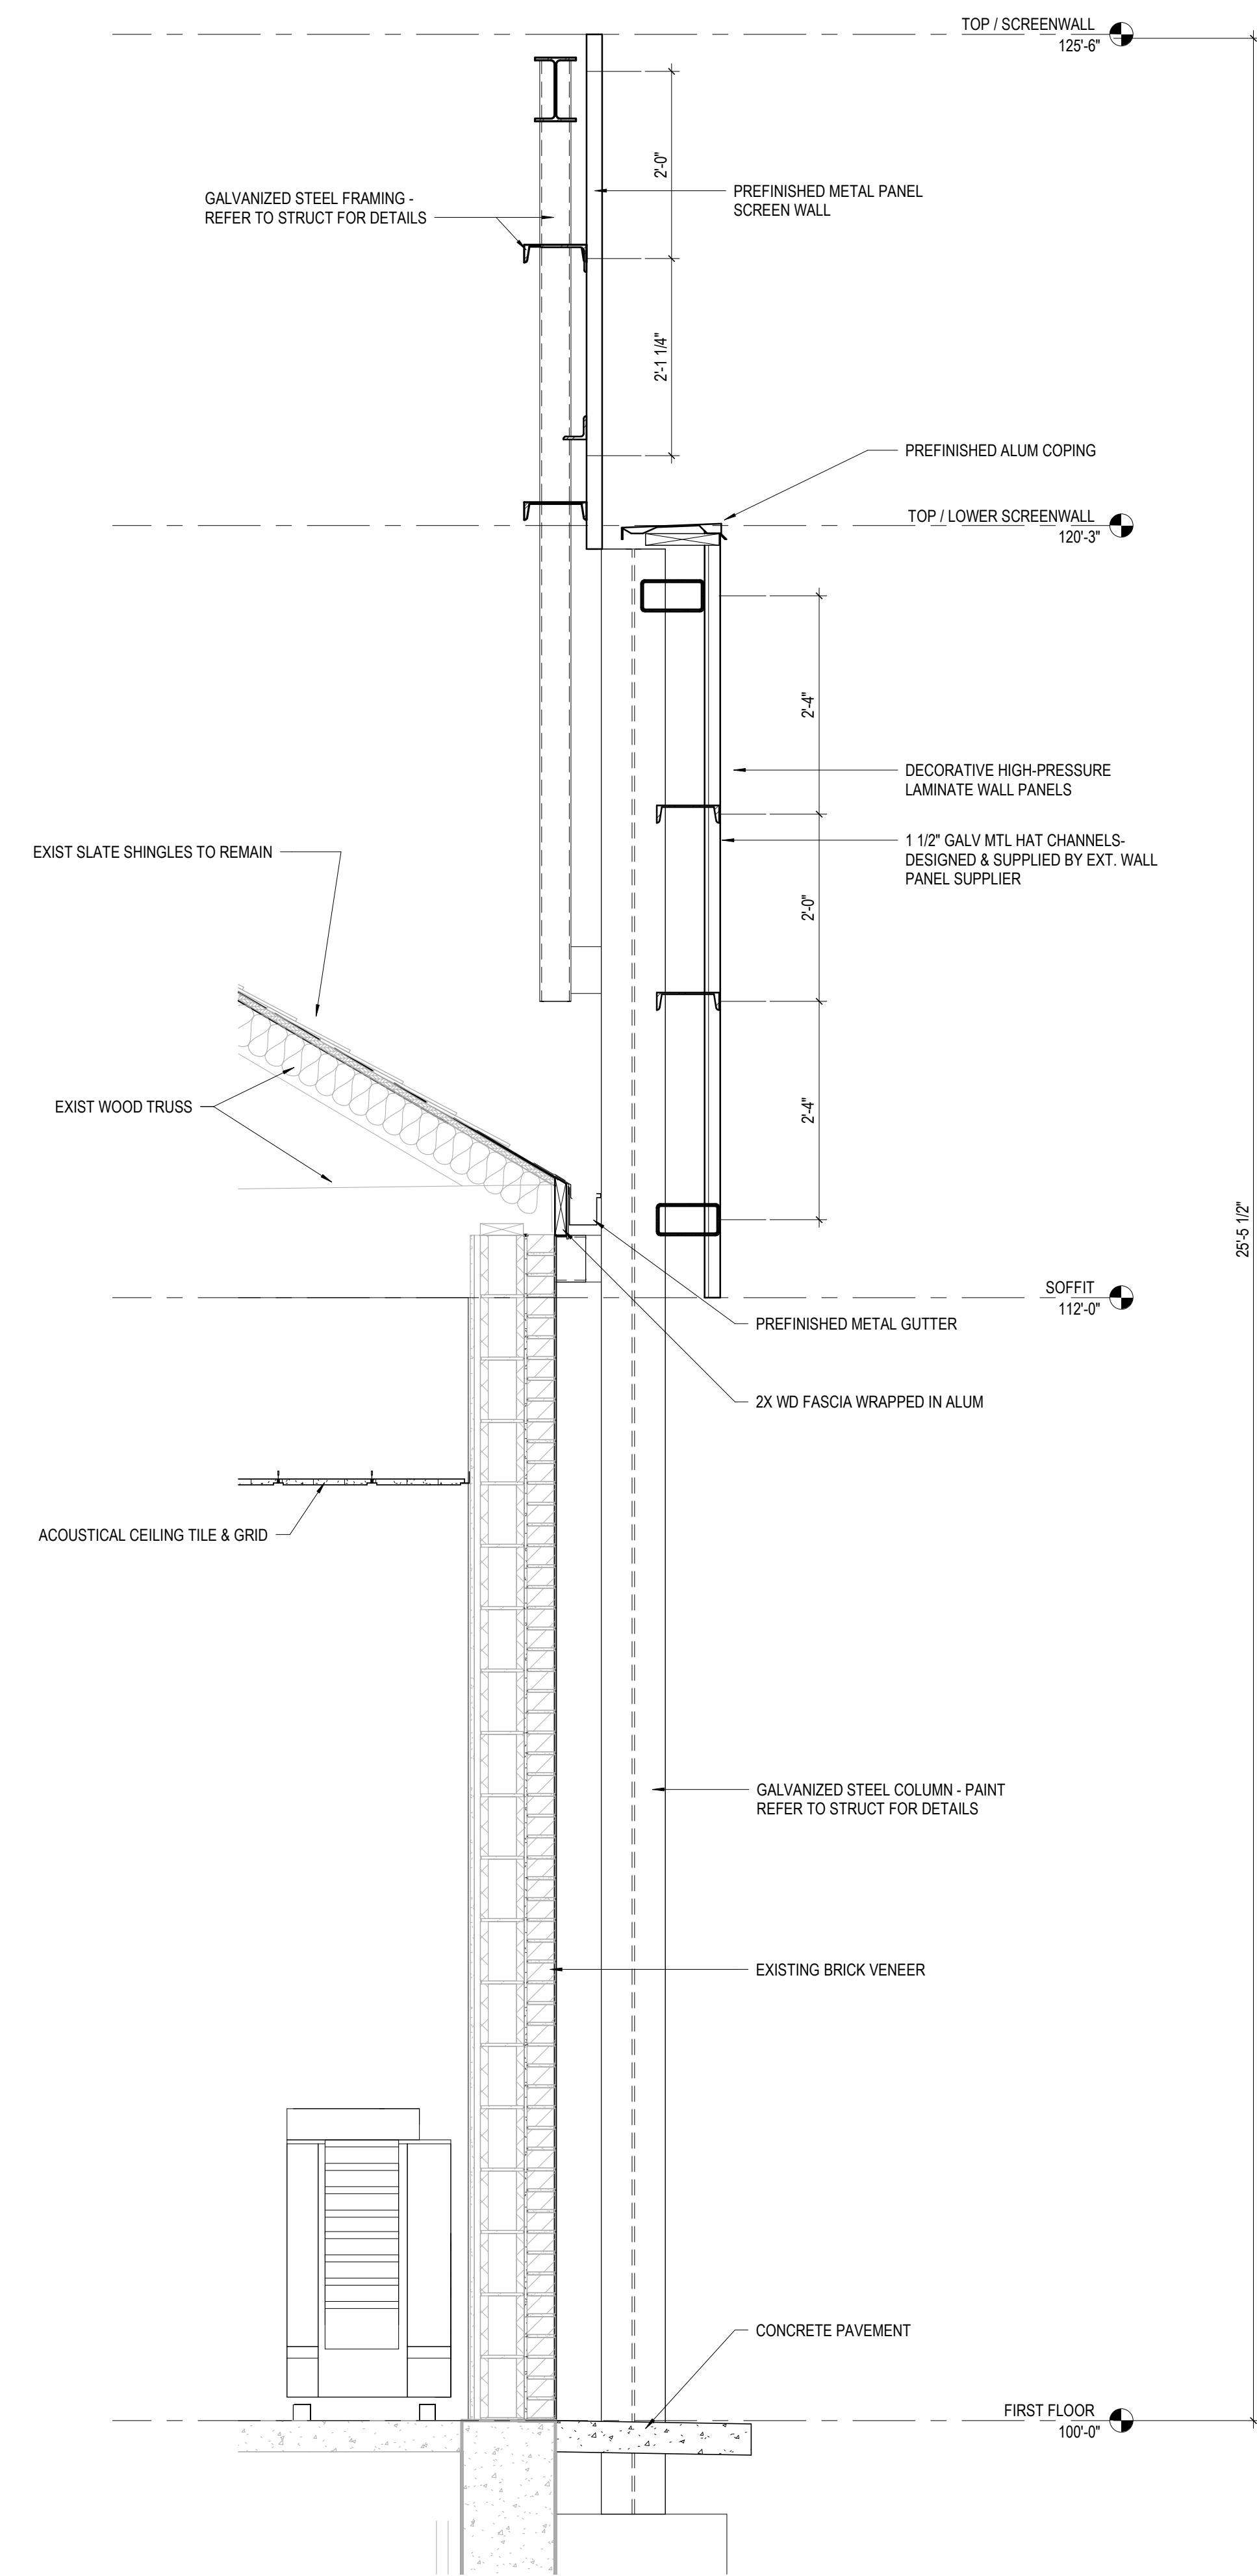

1 SECTION SOUTH WALL
 3/4" = 1'-0" REF: 1 / A102

GENERAL NOTES - WALL SECTIONS

1. X

KEYNOTE LEGEND

KEY VALUE	KEYNOTE TEXT
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#	DATE	CHANGE DESCRIPTION

RENOVATION OF HEARTLAND BANK DUBLIN
 6300 PRANTZ ROAD
 DUBLIN, OH 43017
 FOR
HEARTLAND BANK


MOODY-NOLAN
 300 SPRUCE STREET
 SUITE 300
 COLUMBUS, OHIO 43215
 PHONE: (614) 461-4664
 FAX: (614) 280-8881

DRAWING TITLE:


WALL SECTIONS

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	20022
	A502
FINAL DEVELOPMENT PLAN	
























DOOR PANEL TYPE LEGEND

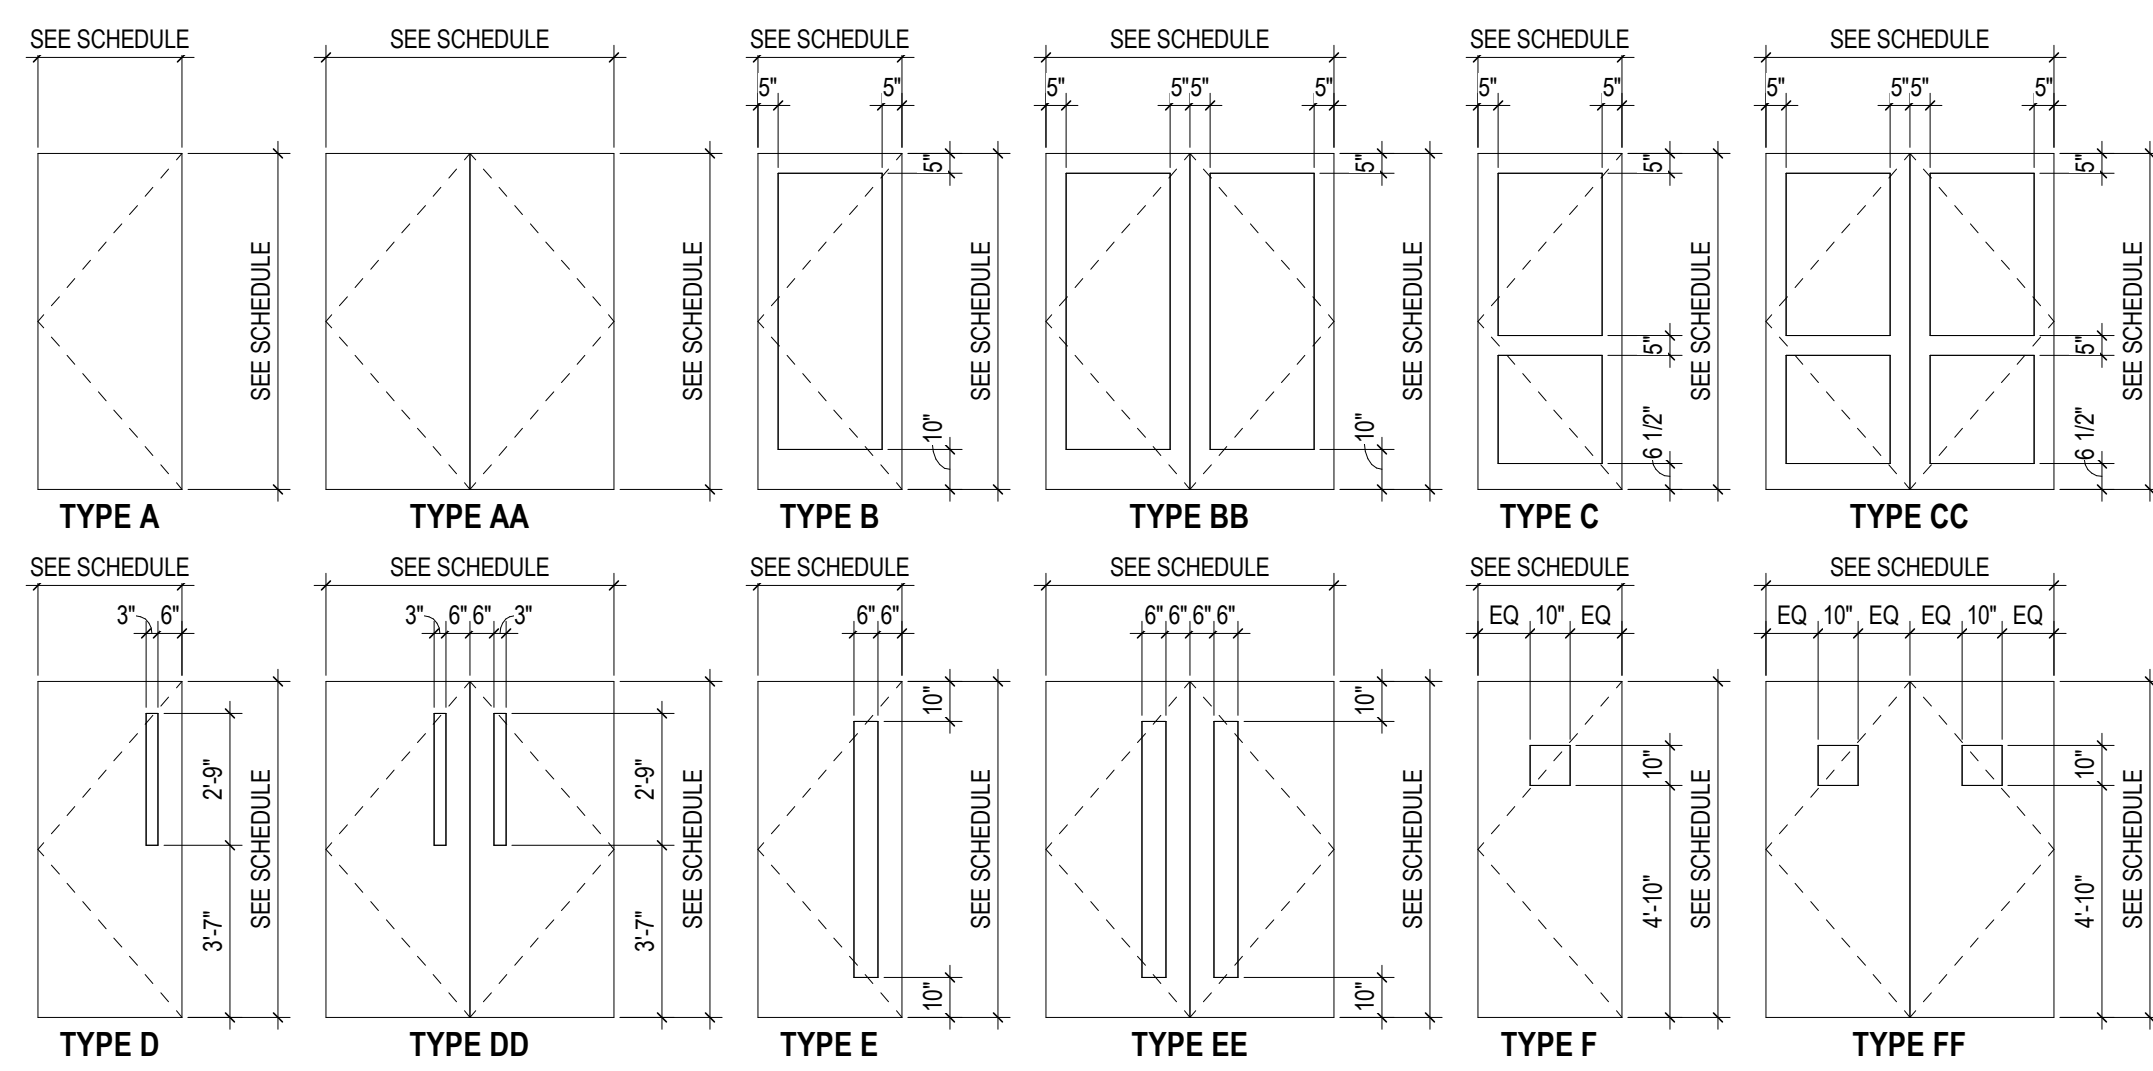


DOOR FRAME TYPE LEGEND

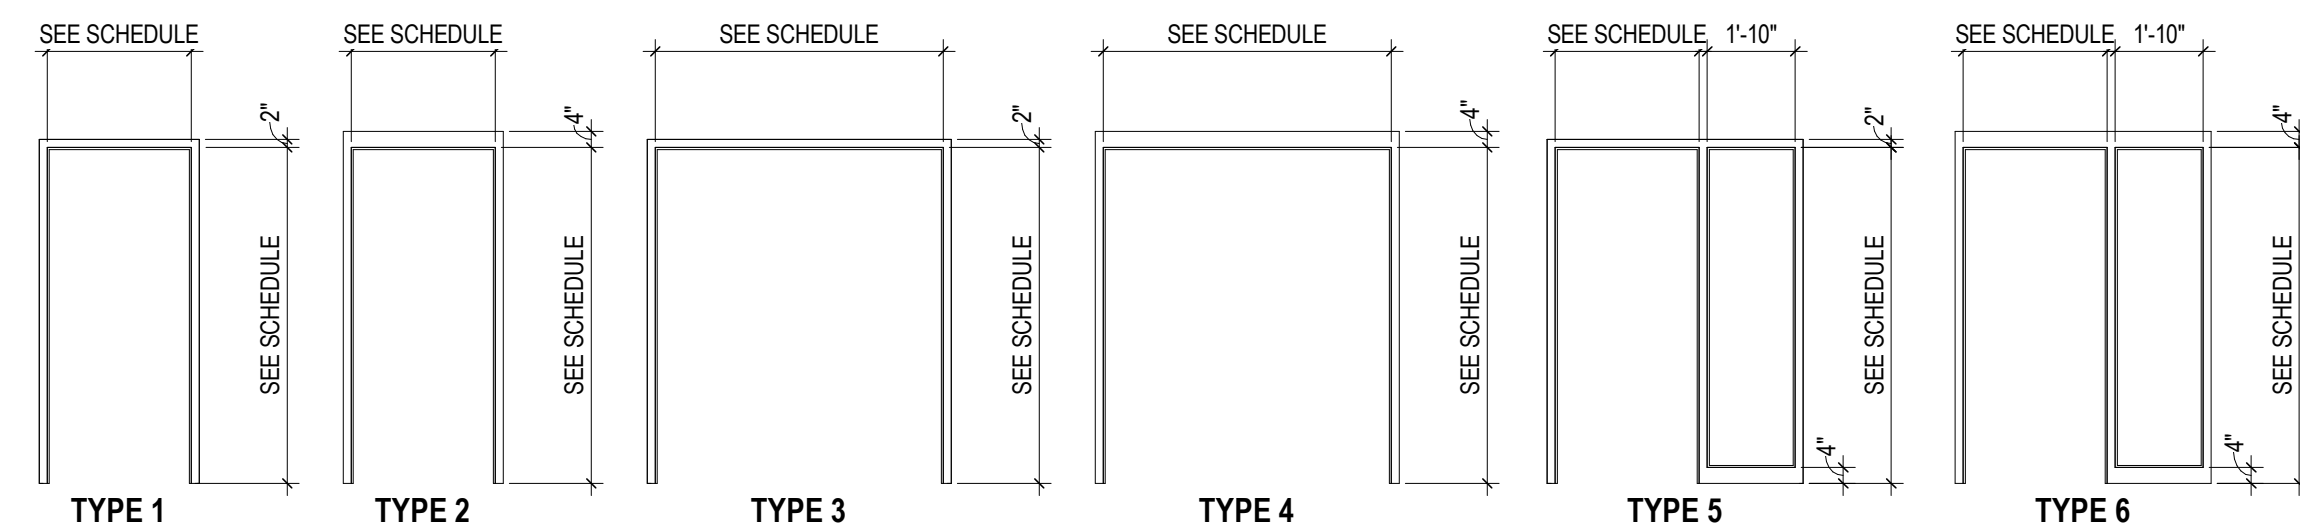

DOOR SCHEDULE												
NUMBER	ROOM NAME	DOOR	WIDTH	HEIGHT	MATERIAL	ELEV	FRAME		DETAILS - SHEET AX.XX			REMARKS
							MATERIAL	ELEV	FIRE RATING	HOW SET	HEAD	
31			3'-0"	7'-0"		A	HM	1				
32	STAIR 02		2'-6"	7'-0"		A	HM	1				
101	ENTRY VESTIBULE		6'-5 1/2"	7'-0"								
103			6'-0"	7'-0"	WD		ALUM					
105	OFFICE		3'-0"	7'-0"	WD	A	HM	1				
106	OFFICE		3'-0"	7'-0"	WD	A	HM	1				
107	BREAK ROOM		3'-0"	7'-0"	WD	A	HM	1				
108	STORAGE		2'-6"	7'-0"	WD	A	HM	1				
109	UNISEX RR		3'-0"	7'-0"	WD	A	HM	1				
110												
111	STAIRS		3'-0"	7'-0"		A	HM	1				
112			3'-0"	7'-0"	WD	A	HM	1				
113			12'-0"	5'-11 1/2"	WD	AA	HM	4				
114	OFFICE		2'-11 3/4"	7'-0"	WD		ALUM					
115	MANAGERS OFFICE		3'-3 1/4"	7'-0"	WD		ALUM					
EX105			6'-0"	7'-0"								
EX106	LOBBY		6'-5 1/2"	7'-0"								
EX108	STAIRS		3'-0"	7'-10"		A		1				
EX109	LOBBY		3'-0"	6'-8"		A		1				
EX110	MANAGERS OFFICE		3'-0"	6'-8"		A		1				
EX111			6'-0"	7'-0"								
EX112	OFFICE		2'-6"	7'-10"		A		1				
EX114	OFFICE		2'-6"	7'-10"		A		1				
EX115	STAIRS		3'-0"	7'-10"		A		1				
EX116	ENTRY VESTIBULE		5'-4"	9'-11"		AA	HM					
EX118			5'-11"	7'-0"								
EX120			5'-4"	9'-11"		AA	HM					

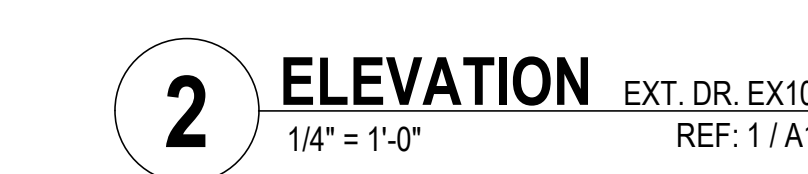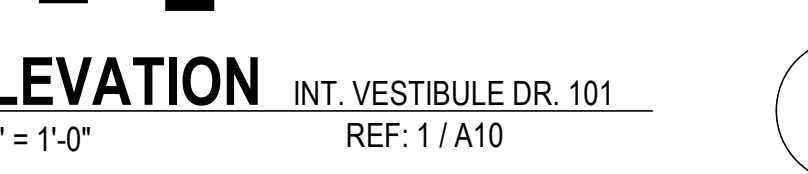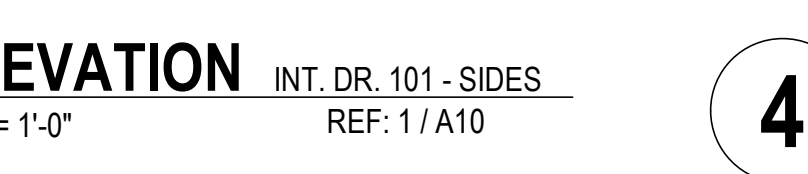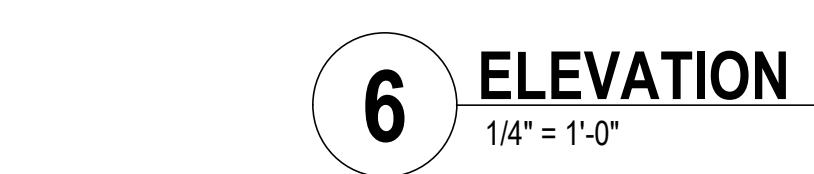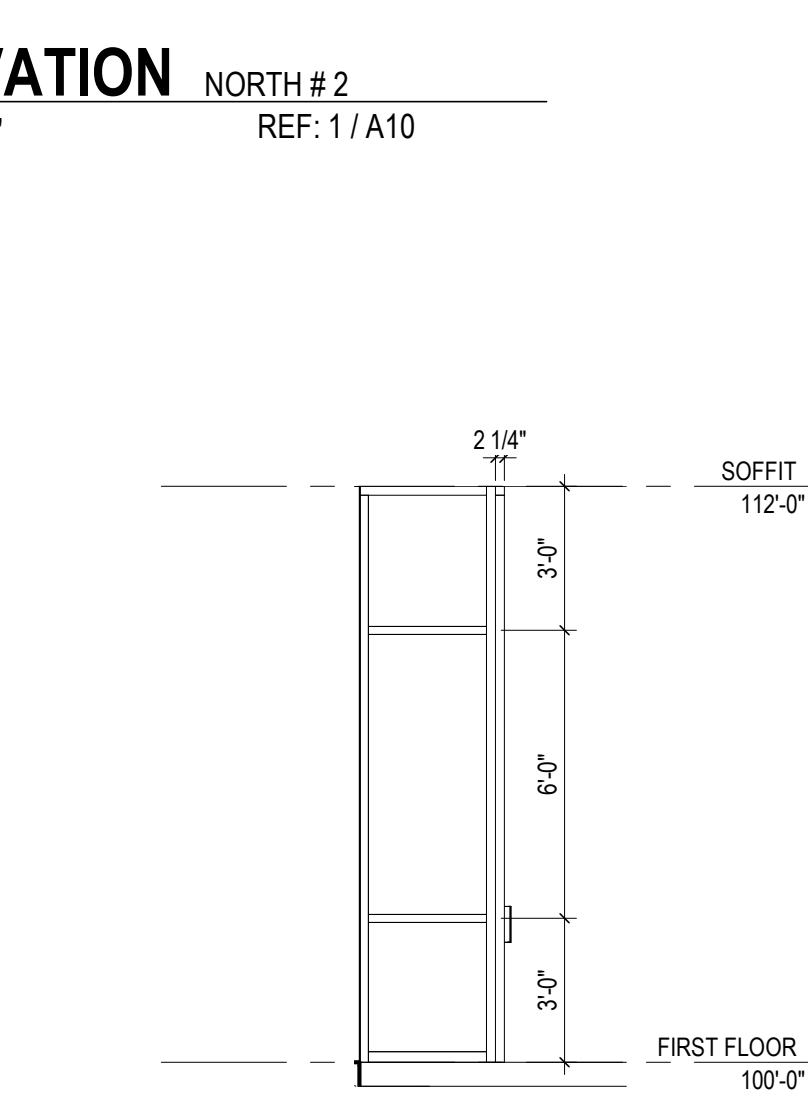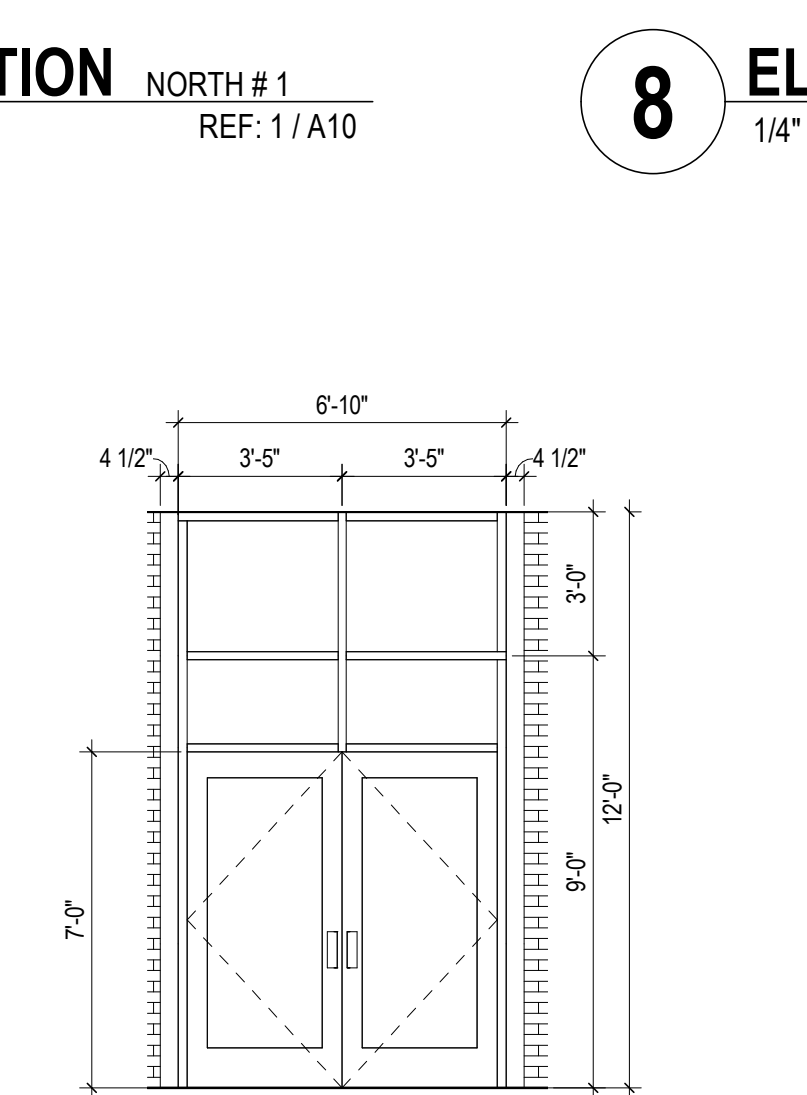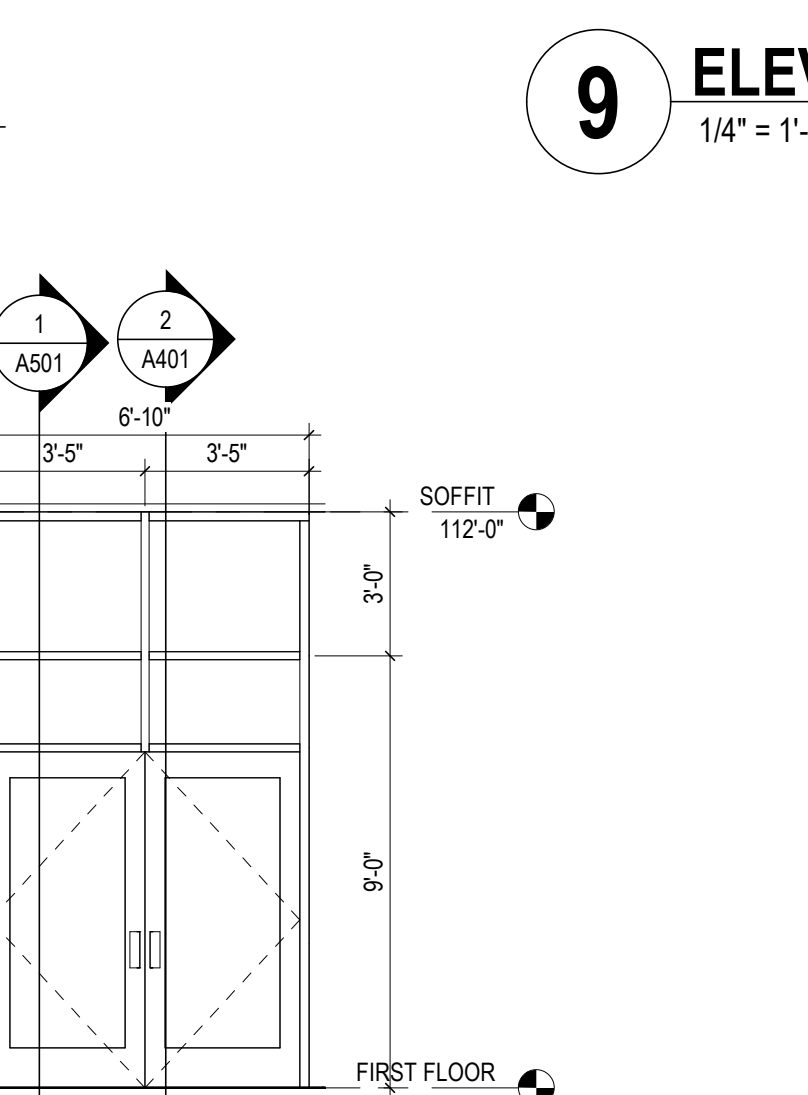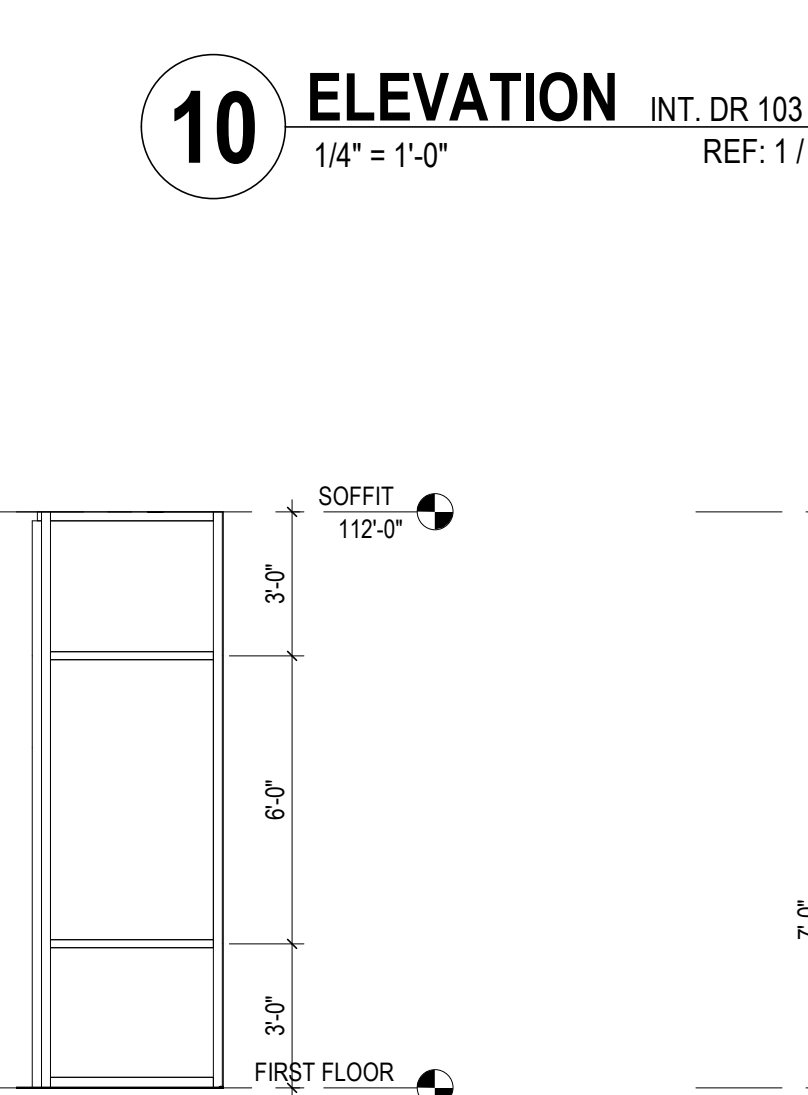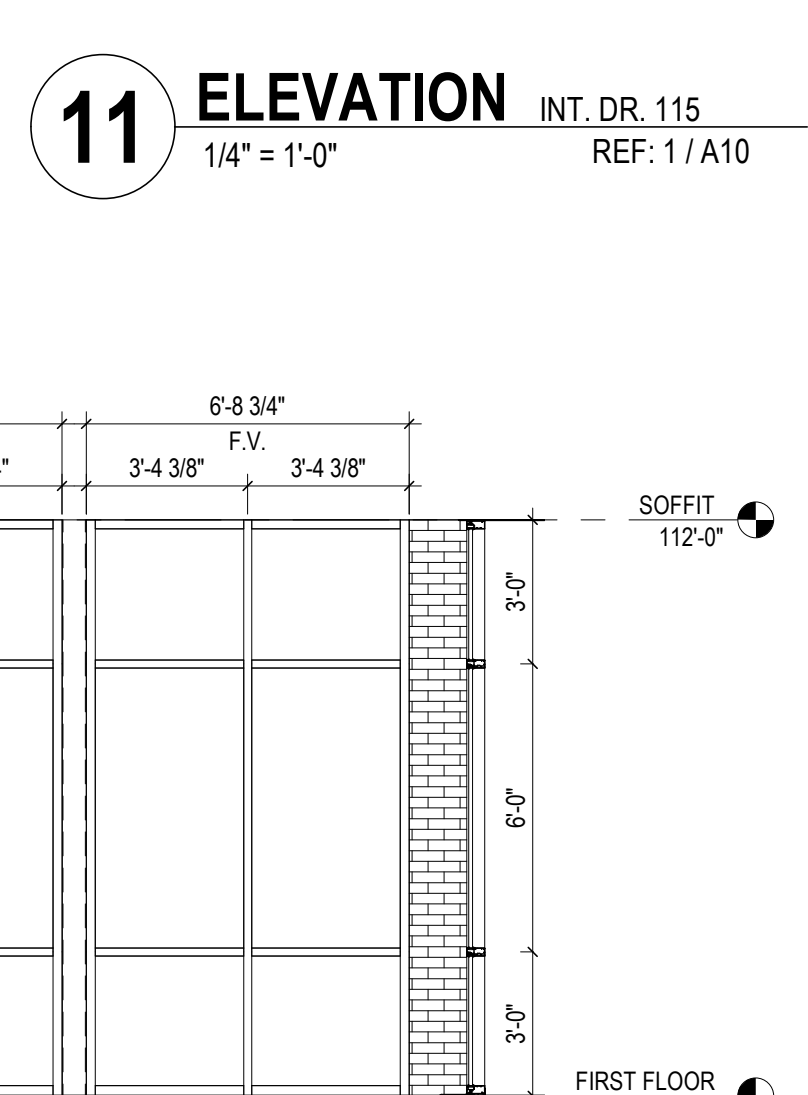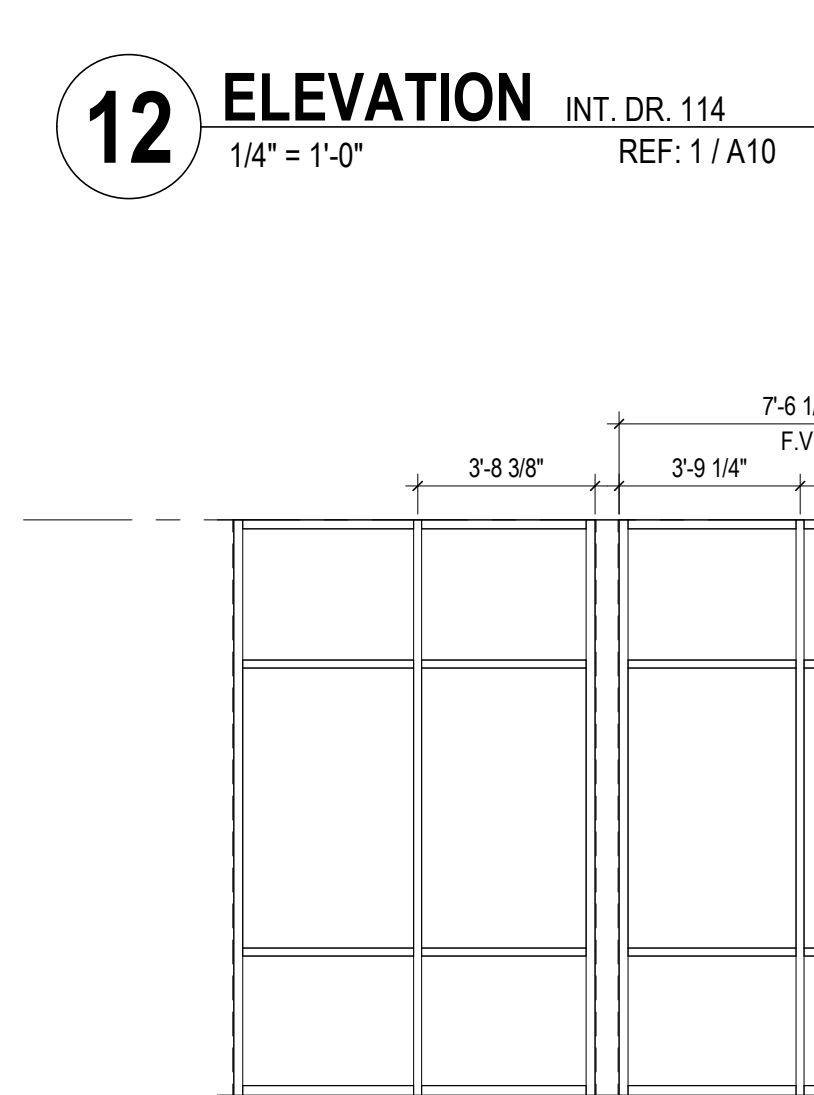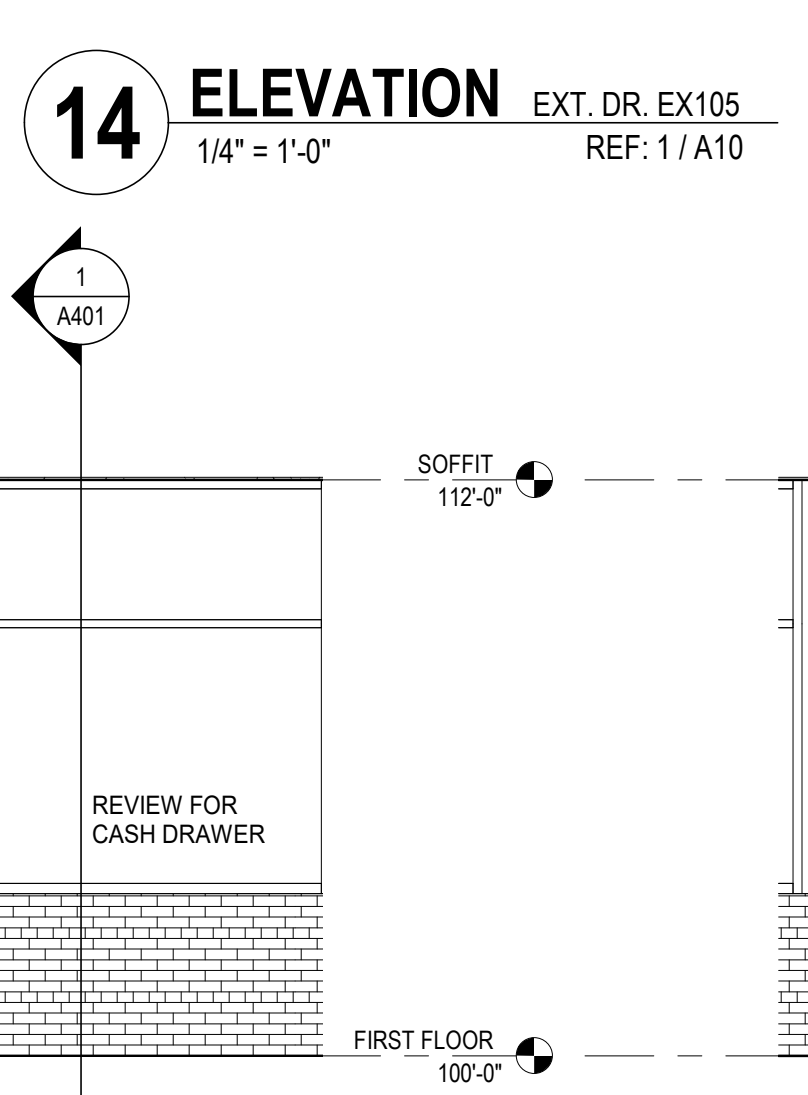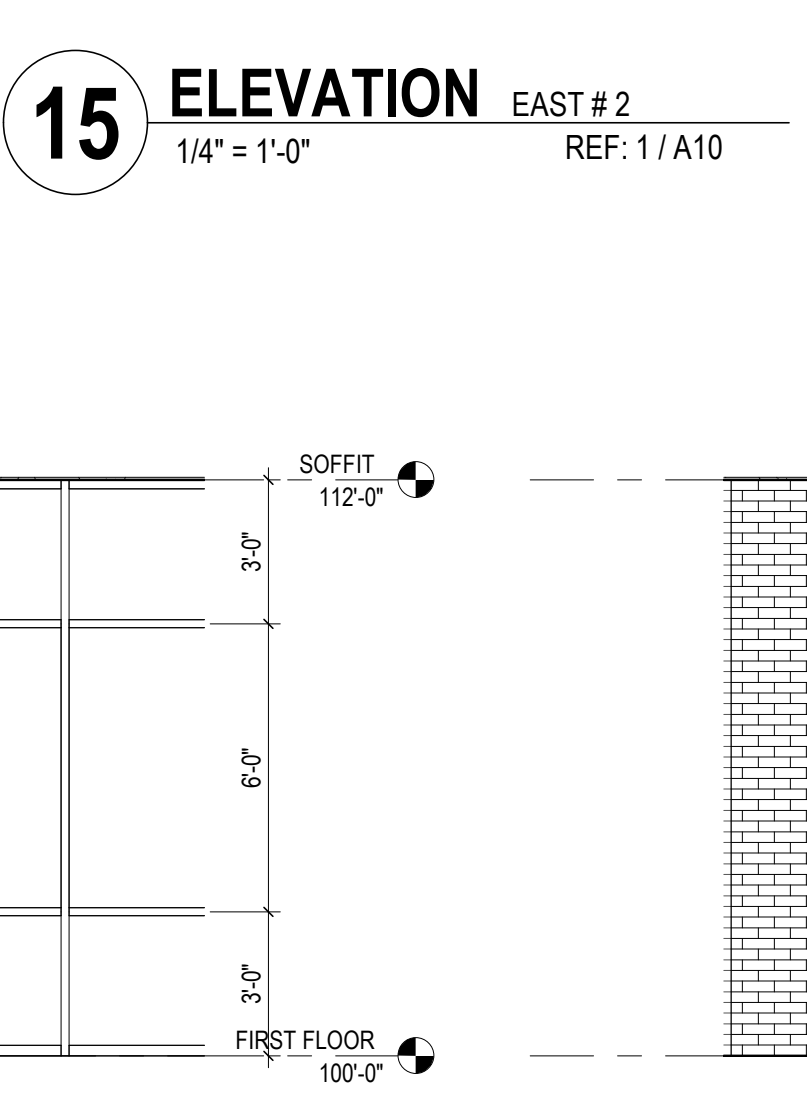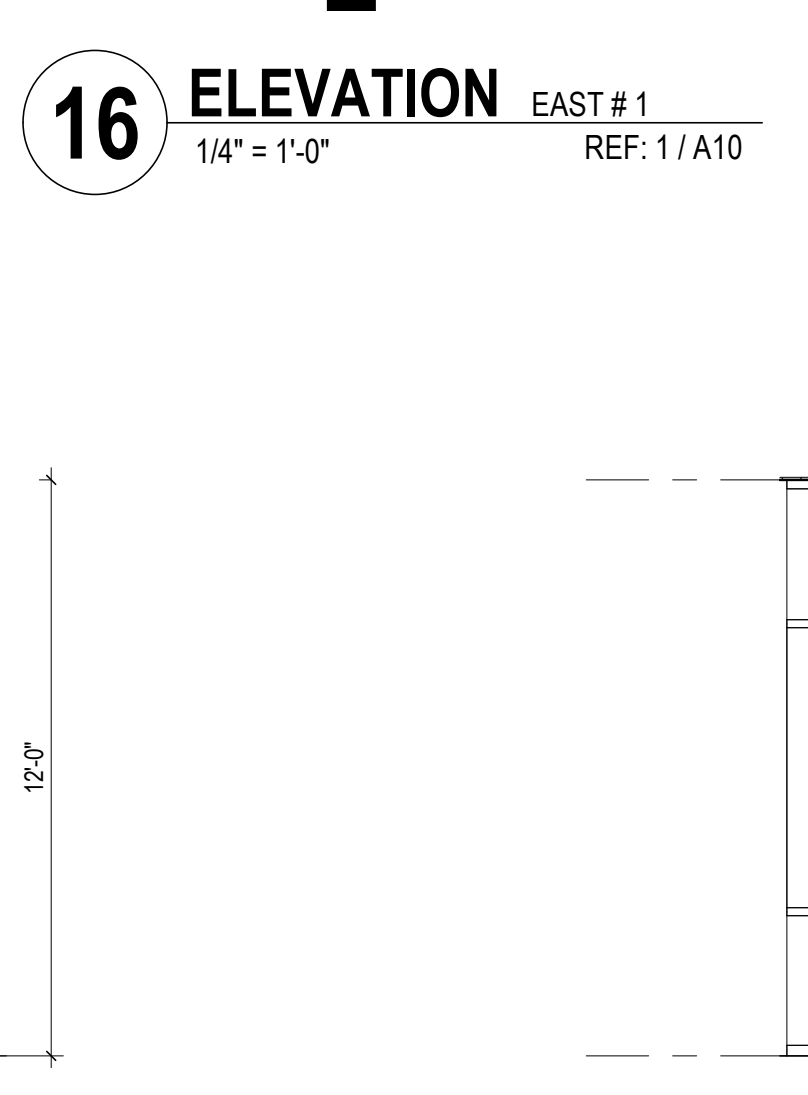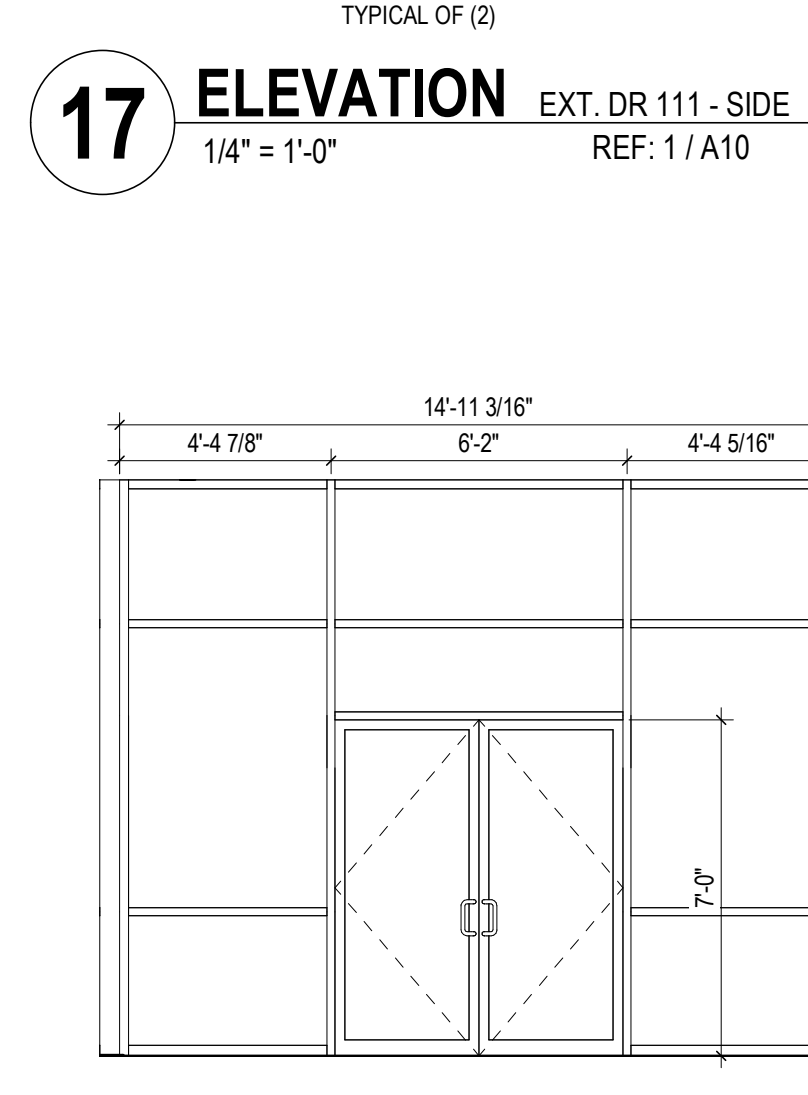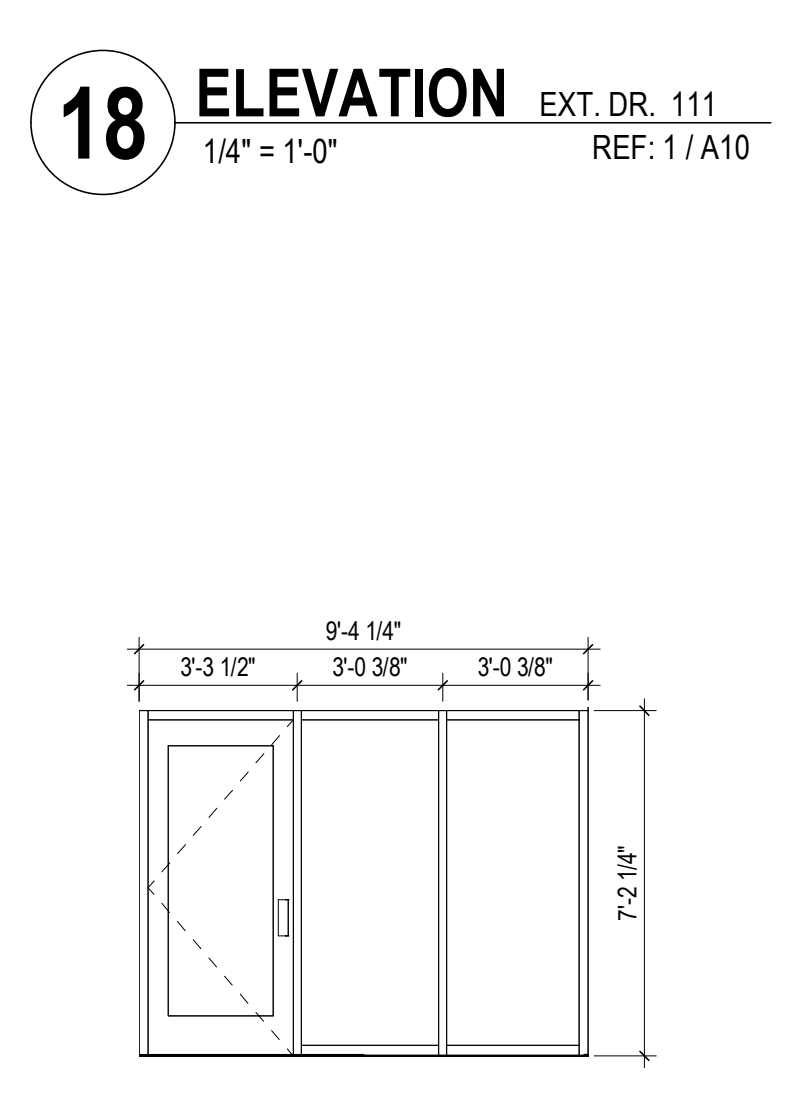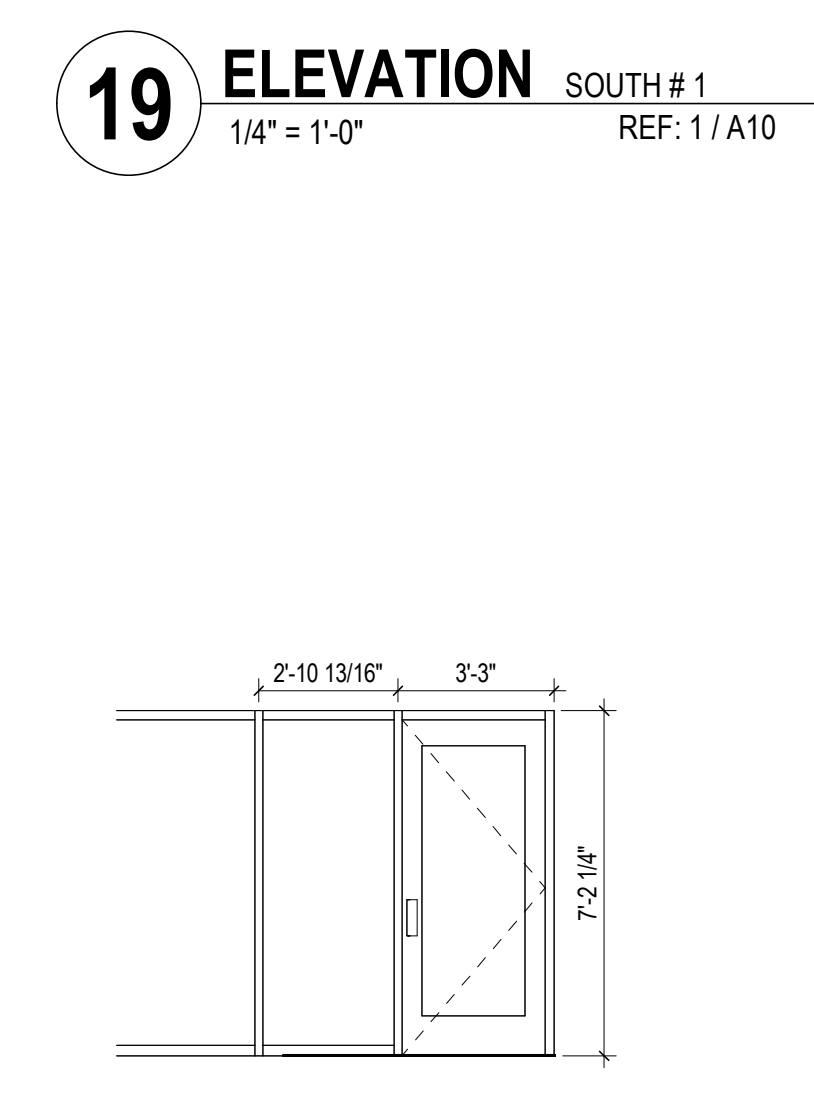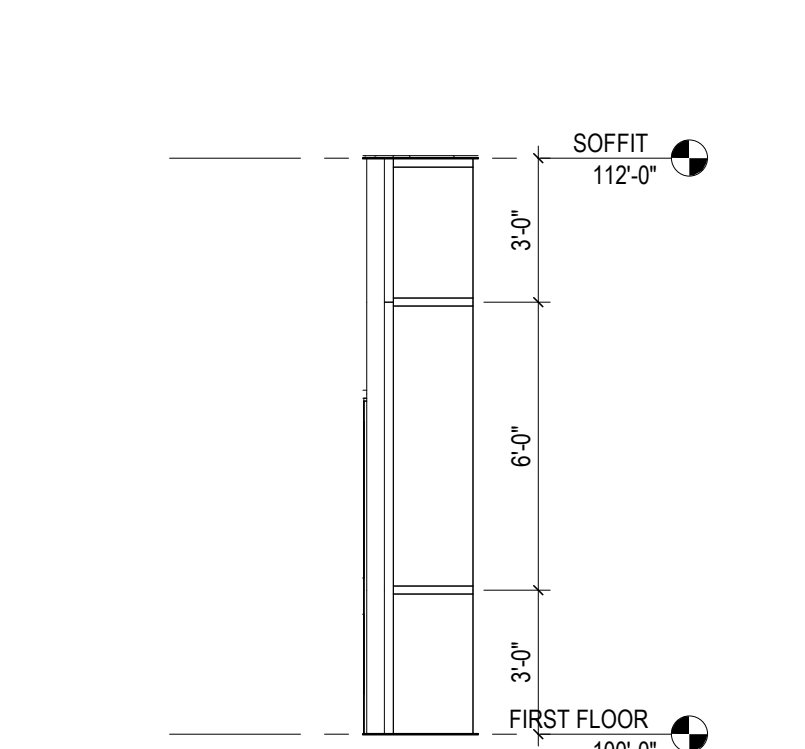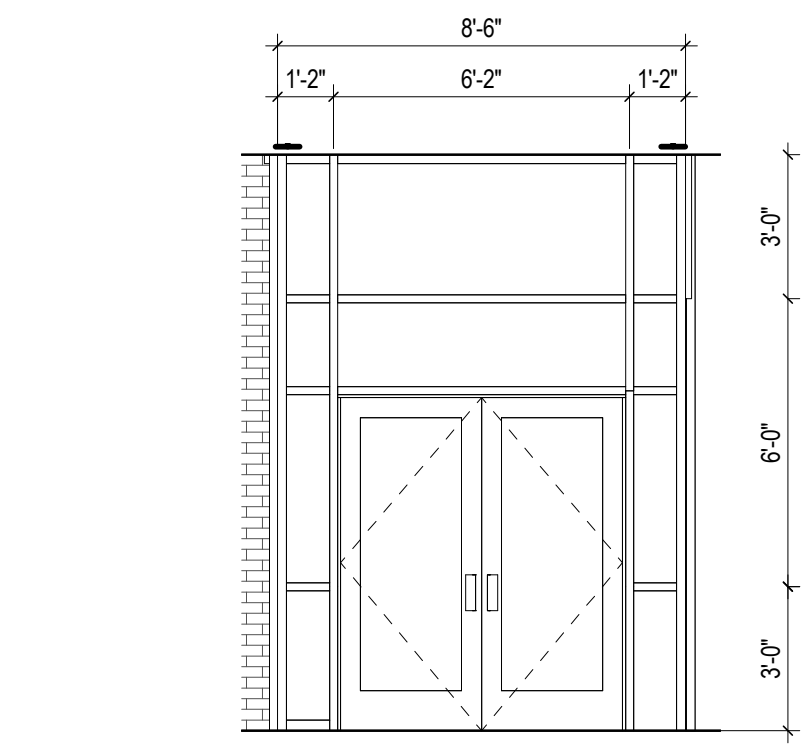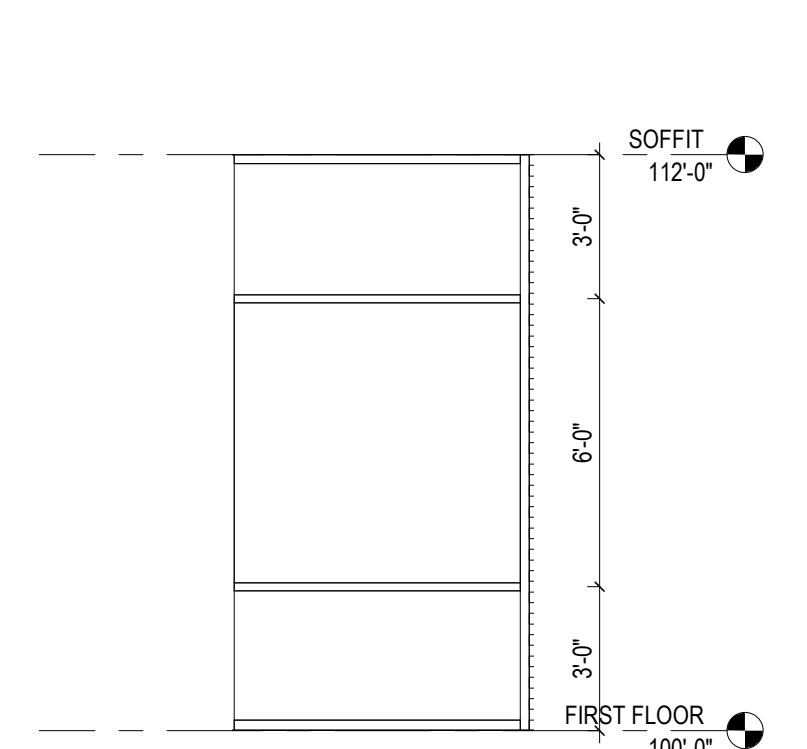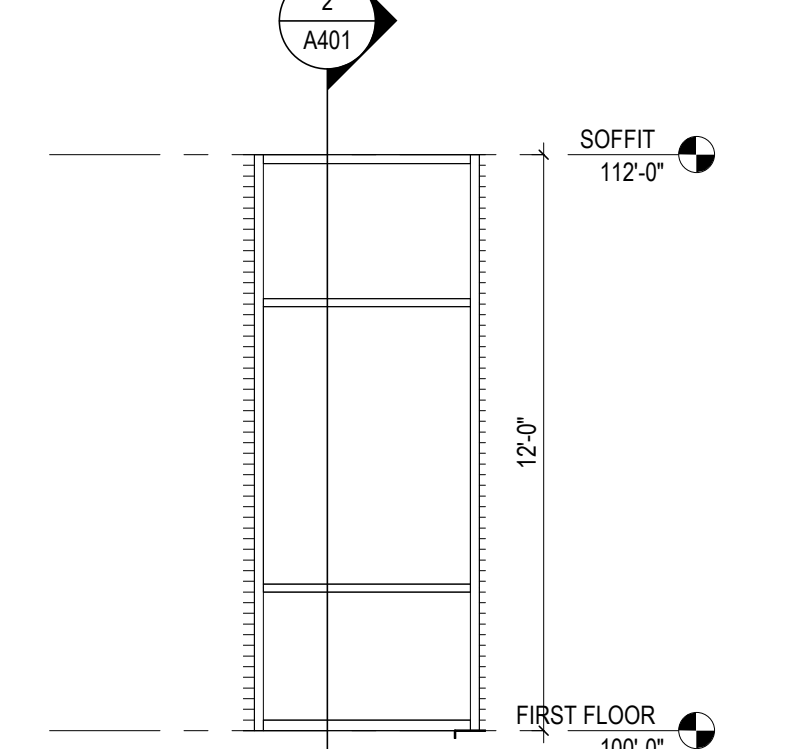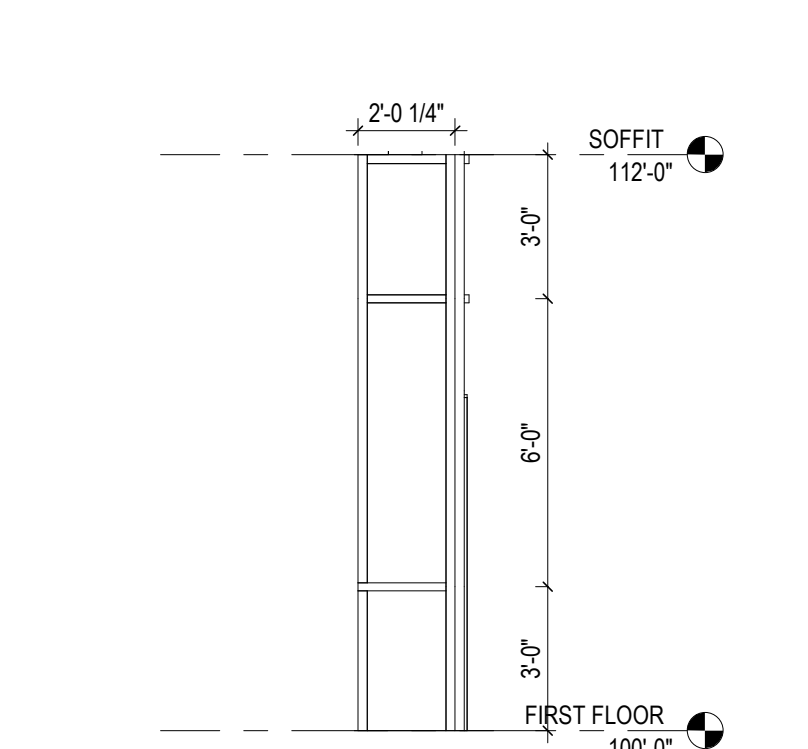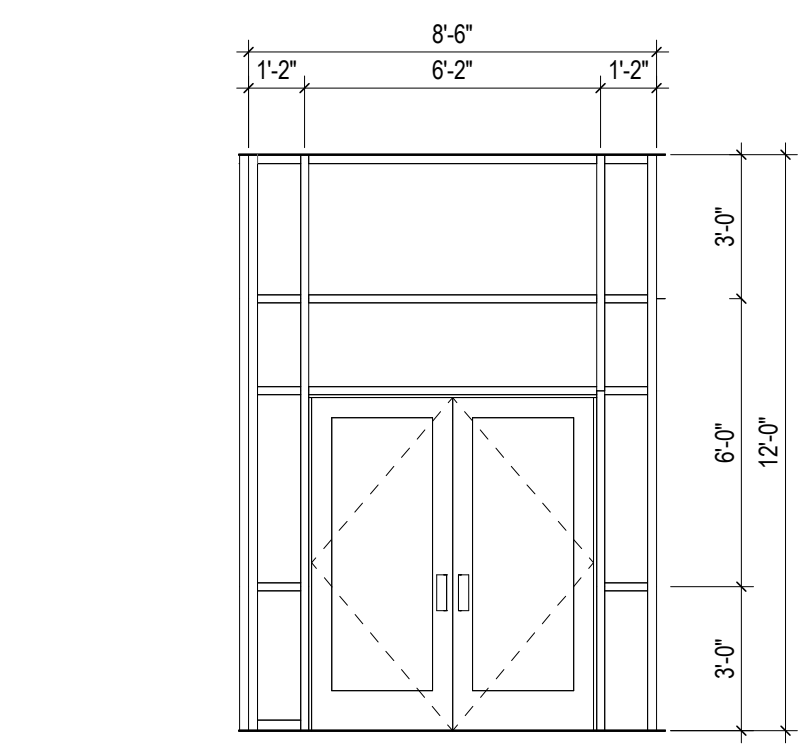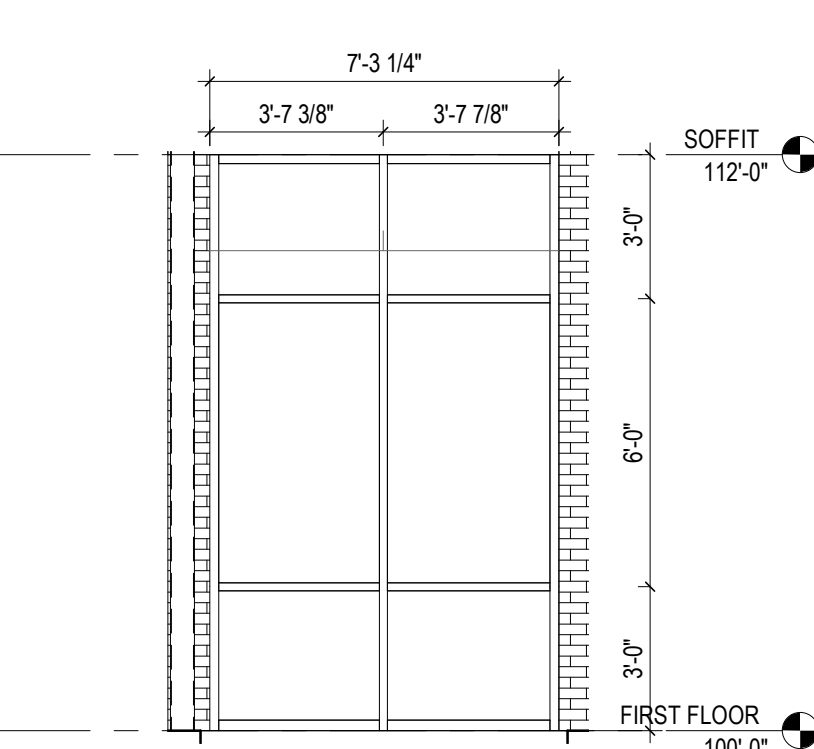

DOOR CLEARANCES

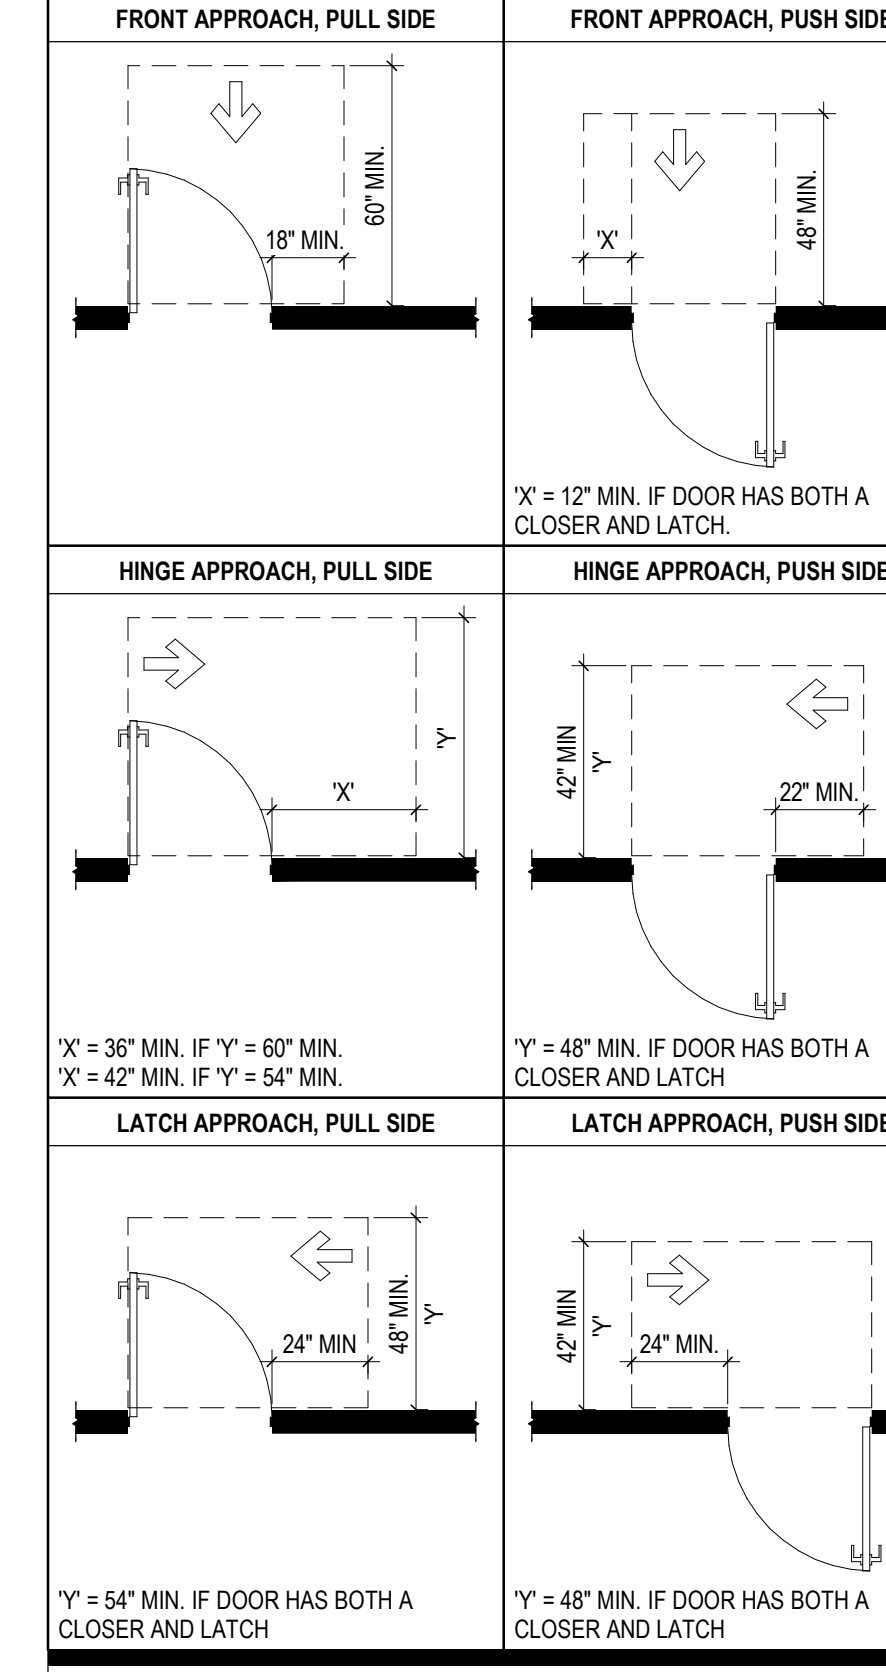

GLAZING TYPES

- GL-1 INTERIOR GLAZING (CLEAR TEMPERED)
- GL-2 INTERIOR GLAZING (CLEAR LAMINATED)
- GL-3 INTERIOR GLAZING (CERAMIC 45 MINUTE)
- GL-4 INTERIOR GLAZING (CERAMIC 60 MINUTE)
- GL-5 INTERIOR GLAZING (CERAMIC 90 MINUTE)
- GL-6 INTERIOR GLAZING (FROSTED)
- GL-7 INTERIOR GLAZING (GRIDDED)


#	DATE	CHANGE DESCRIPTION

RENOVATION OF HEARTLAND BANK DUBLIN
5303 FRANTZ ROAD
DUBLIN, OH 43017
FOR
HEARTLAND BANK


MOODY-NOLAN
300 SPRUCE STREET
SUITE 300
COLUMBUS, OHIO 43215
PHONE: (614) 461-4664
FAX: (614) 280-8881

DOOR & WINDOW SCHEDULES


11/30/2020
DRAWN BY: XXXX CHECKED BY: XXXX
20022
A701
FINAL DEVELOPMENT PLAN

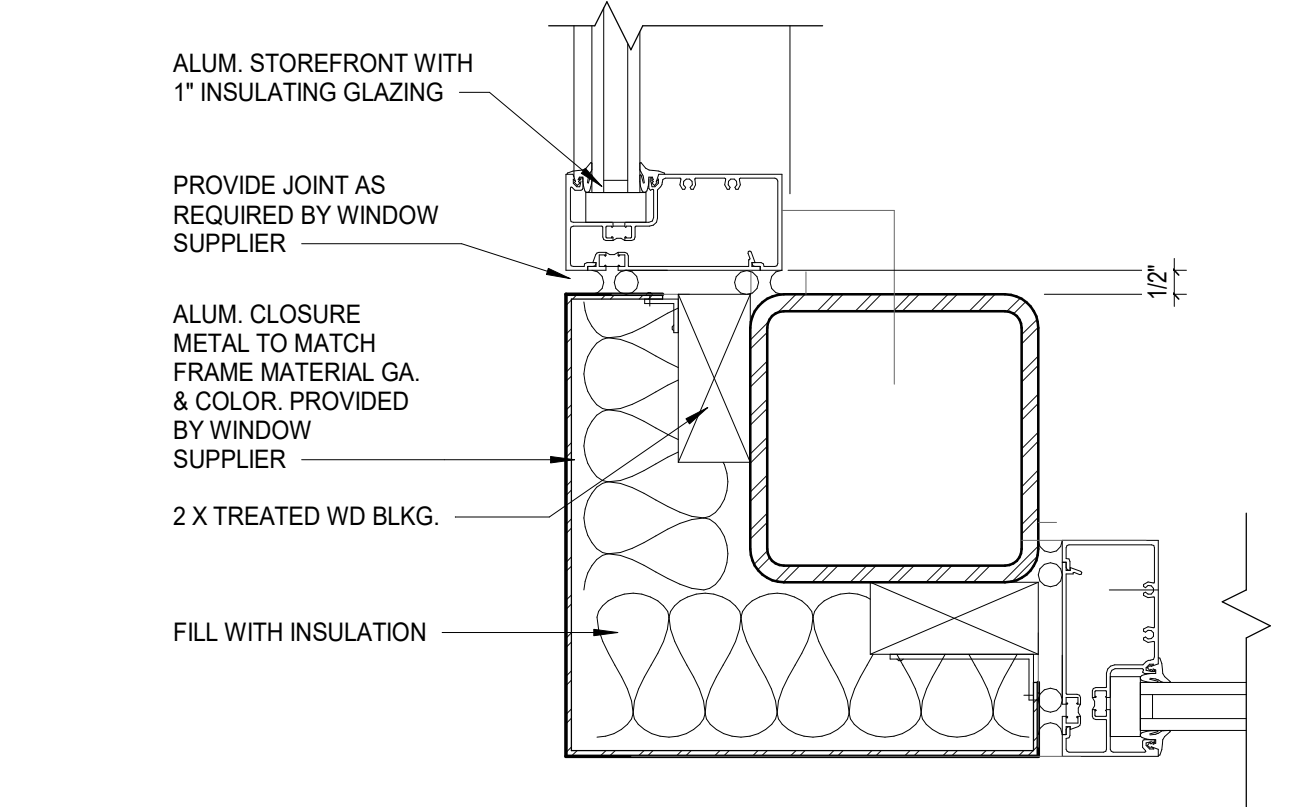


22 DETAIL S.F. @ CORNER COLUMN
3" = 1'-0"

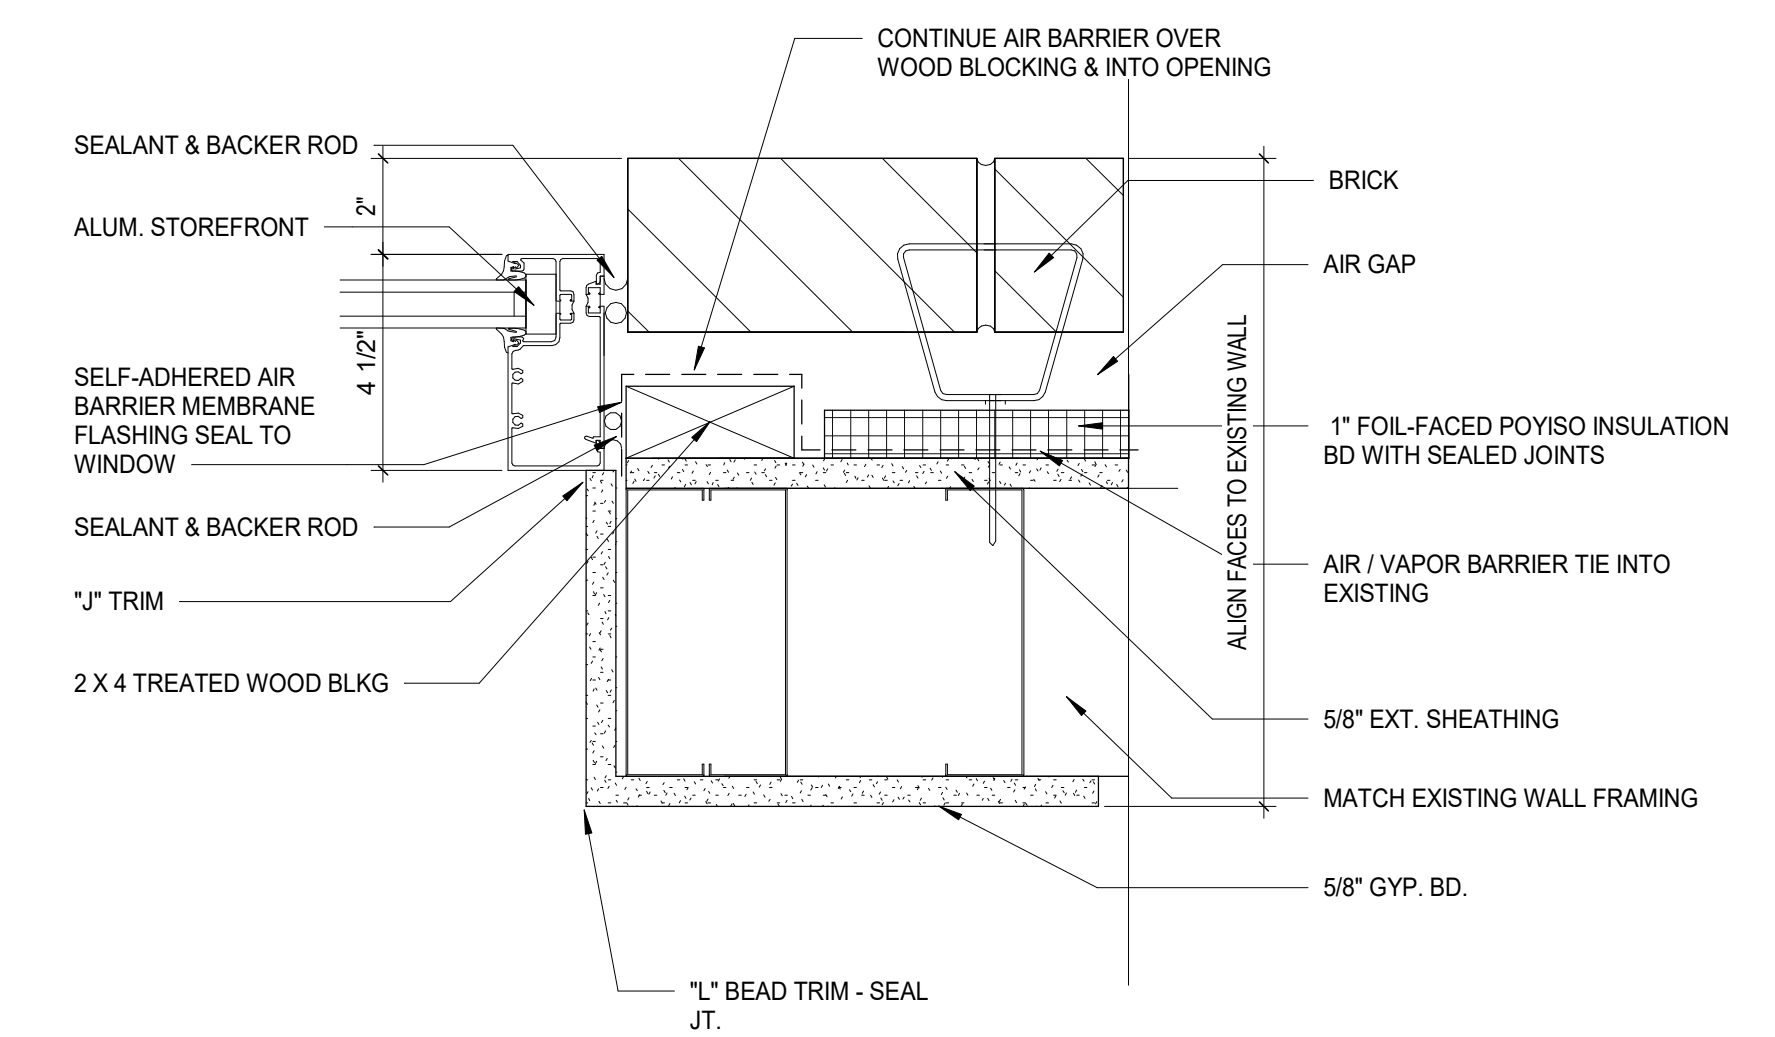


21 DETAIL S.F. JAMB @ MASONRY
3" = 1'-0"

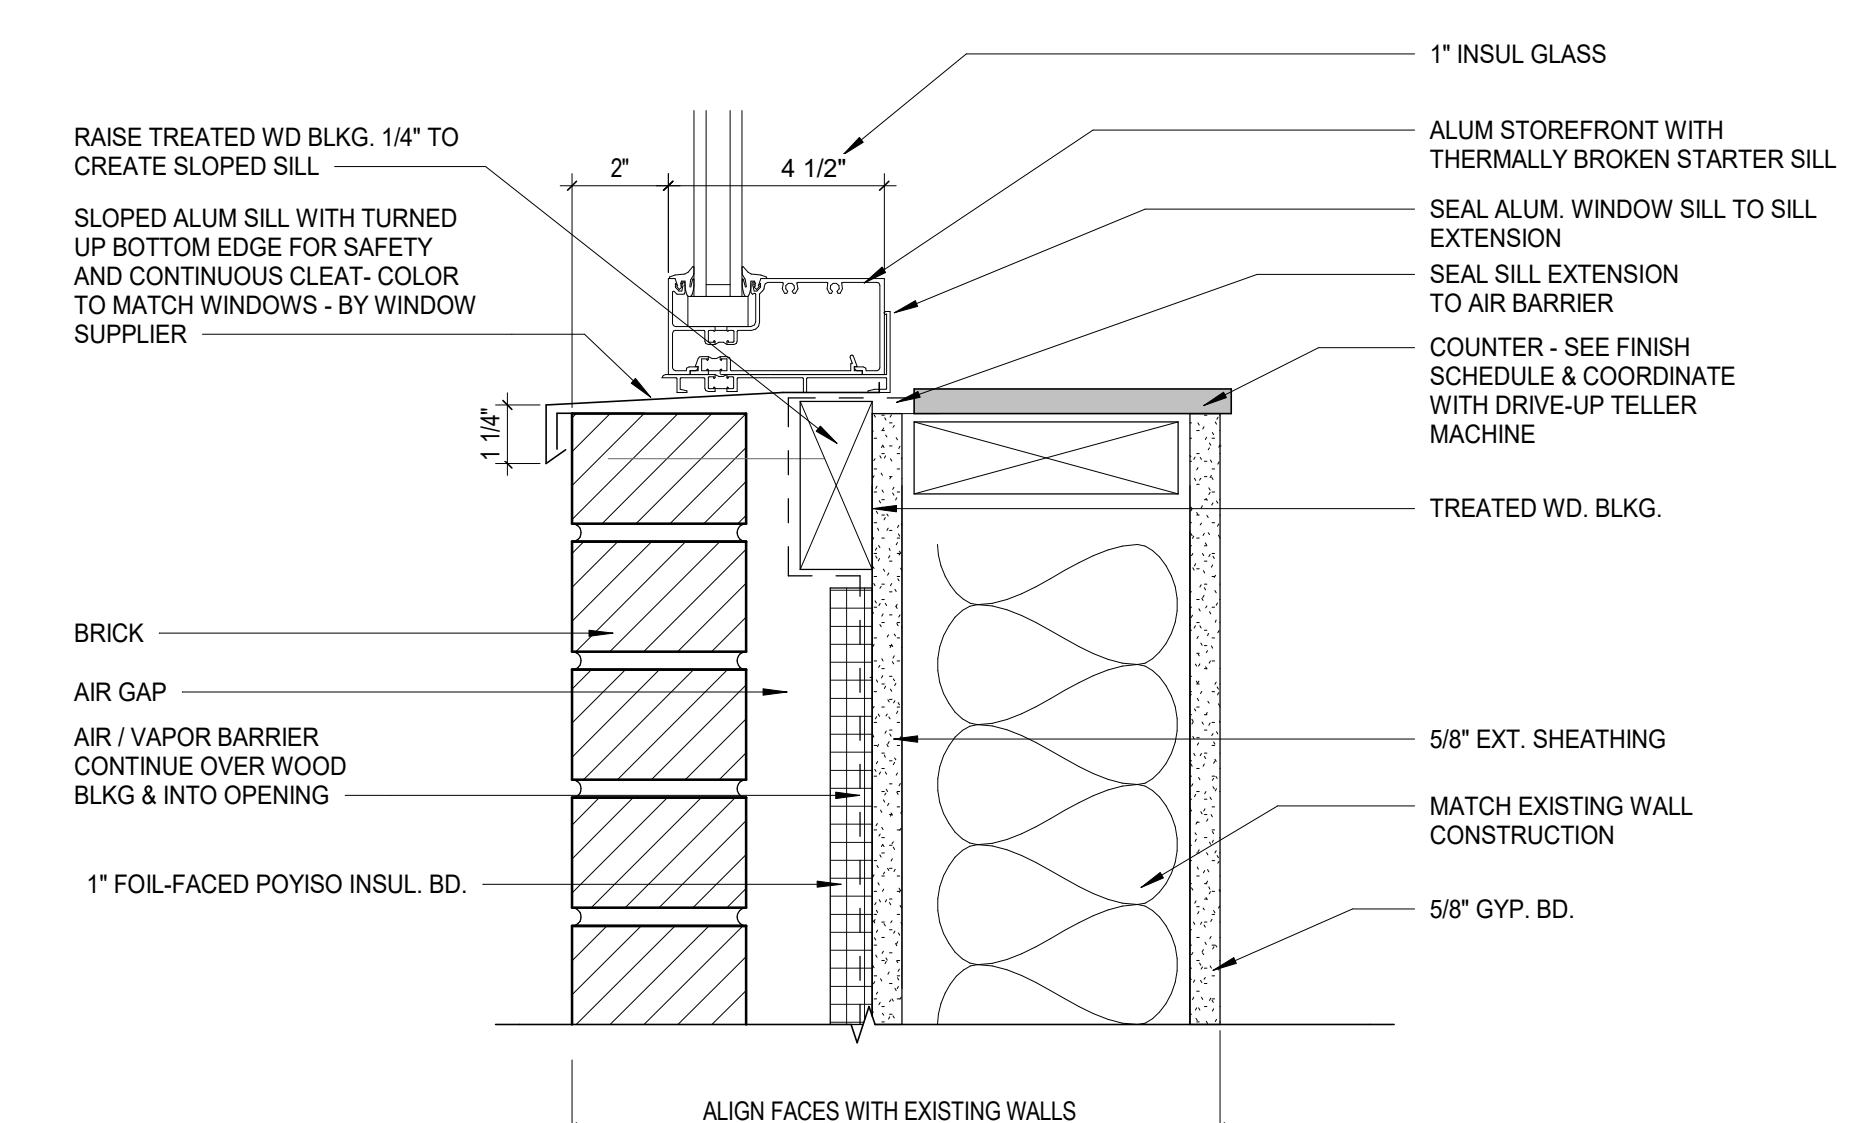


20 DETAIL S.F. SILL @ MASONRY
3" = 1'-0"

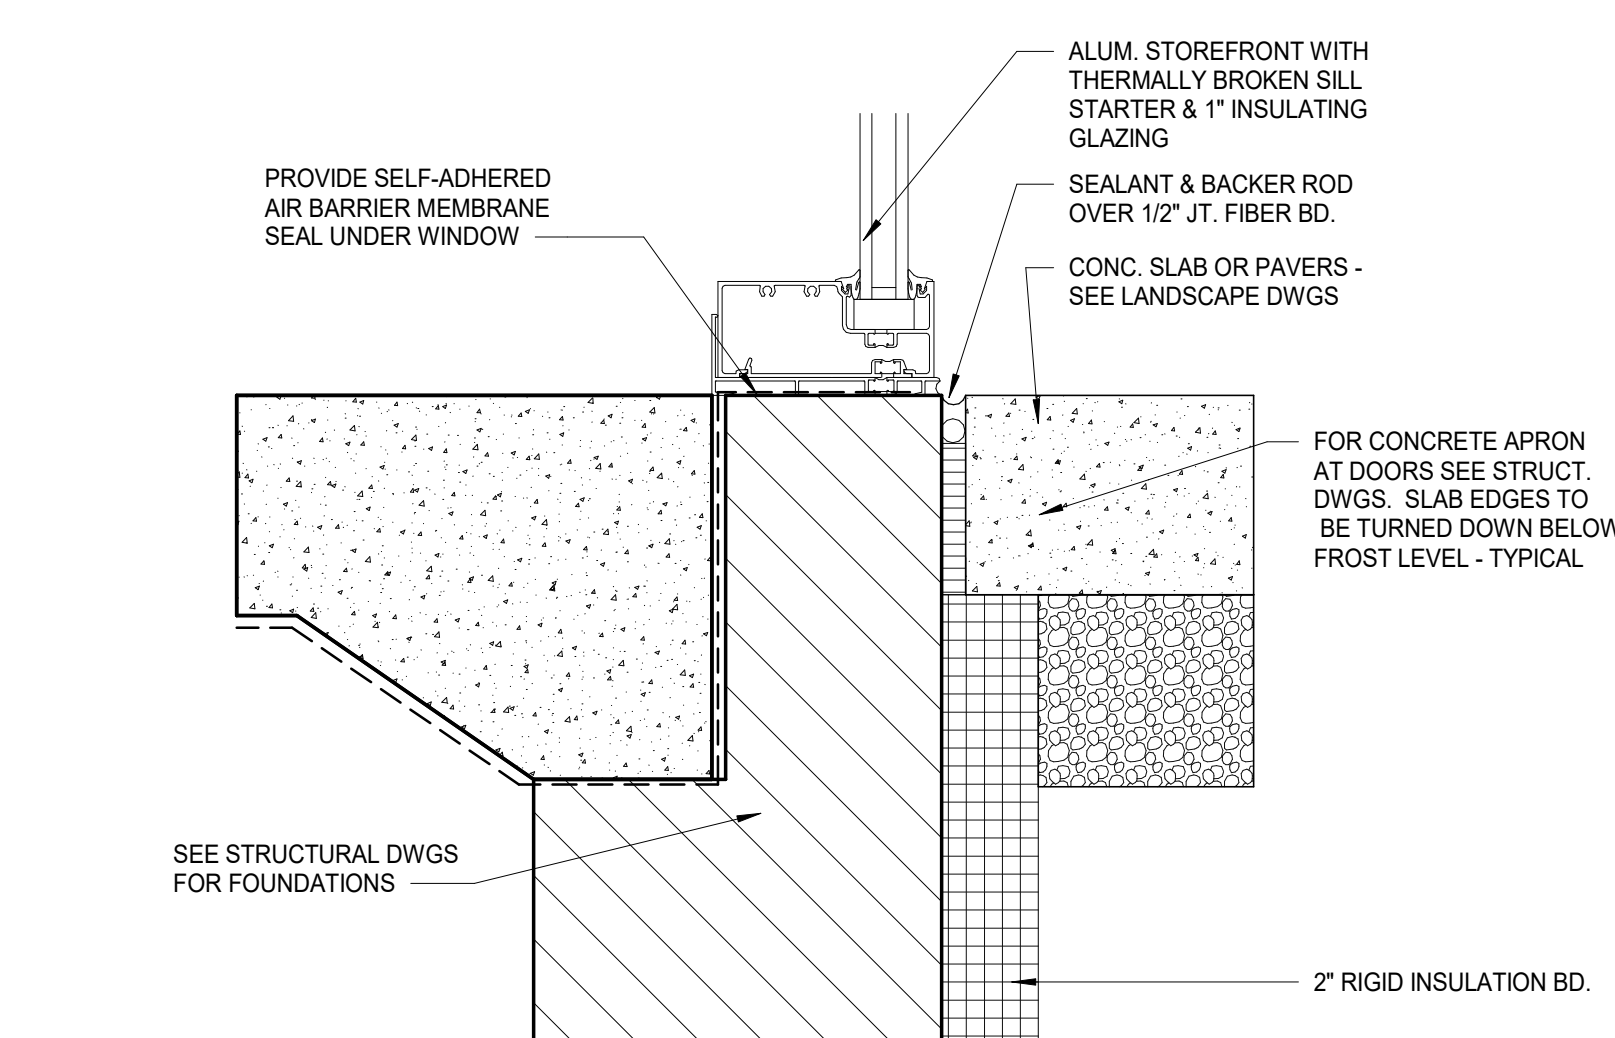


19 DETAIL S.F. @ CONCRETE FND
3" = 1'-0"

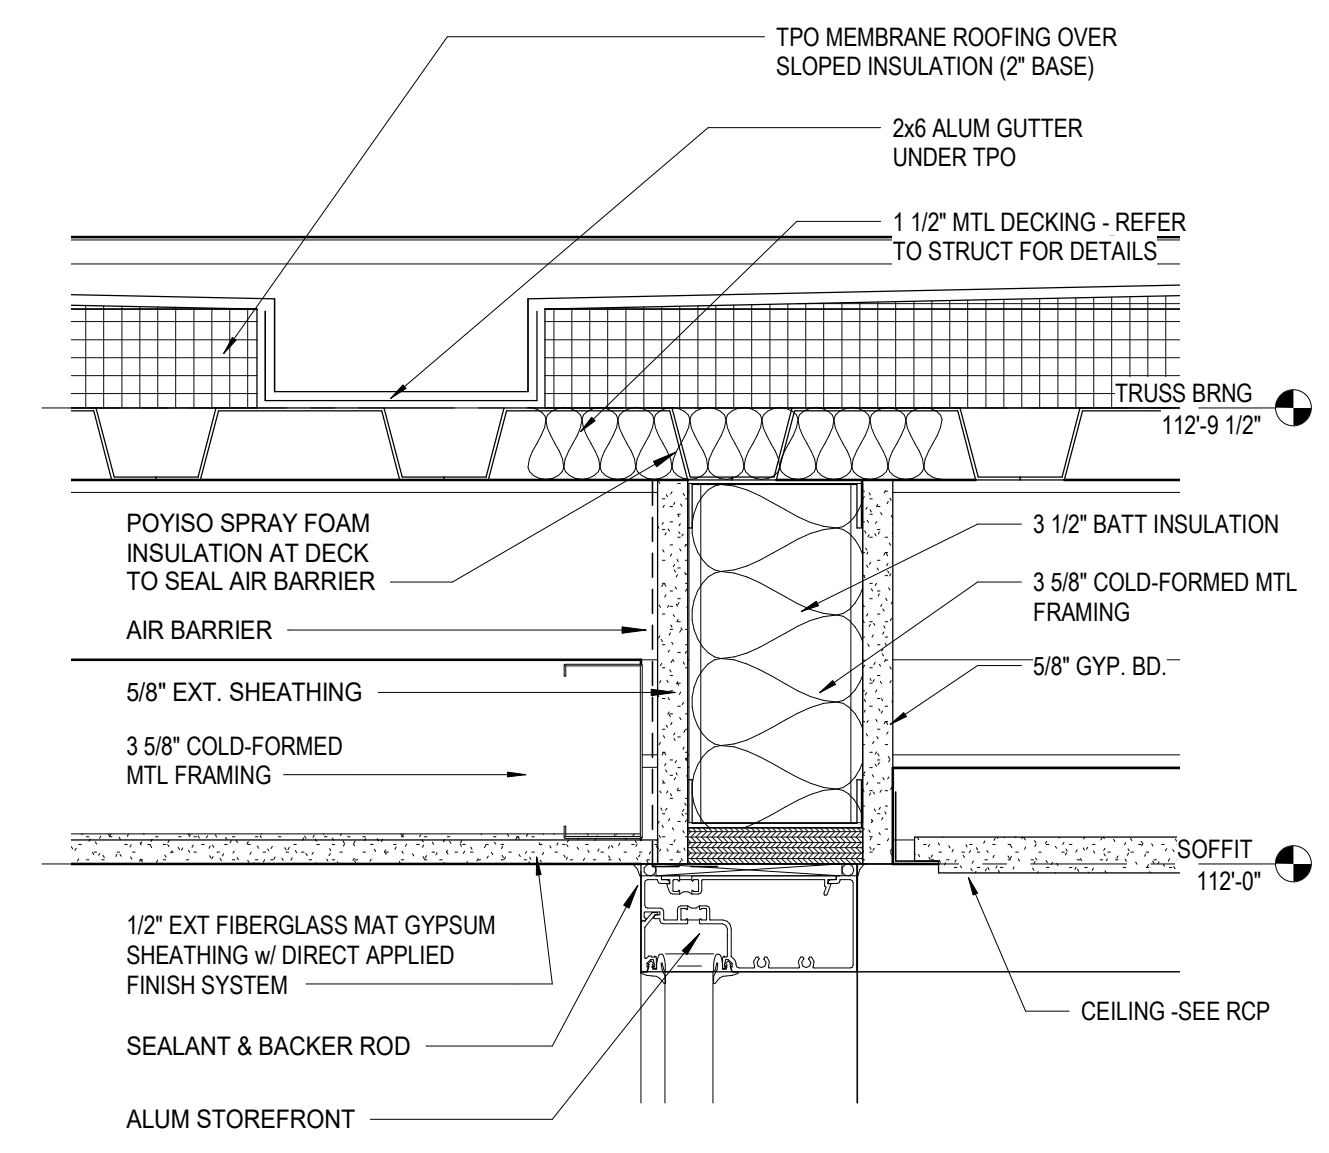


17 DETAIL WEST MAIN ENTRY - Callout 1
3" = 1'-0" REF: 1 / A501

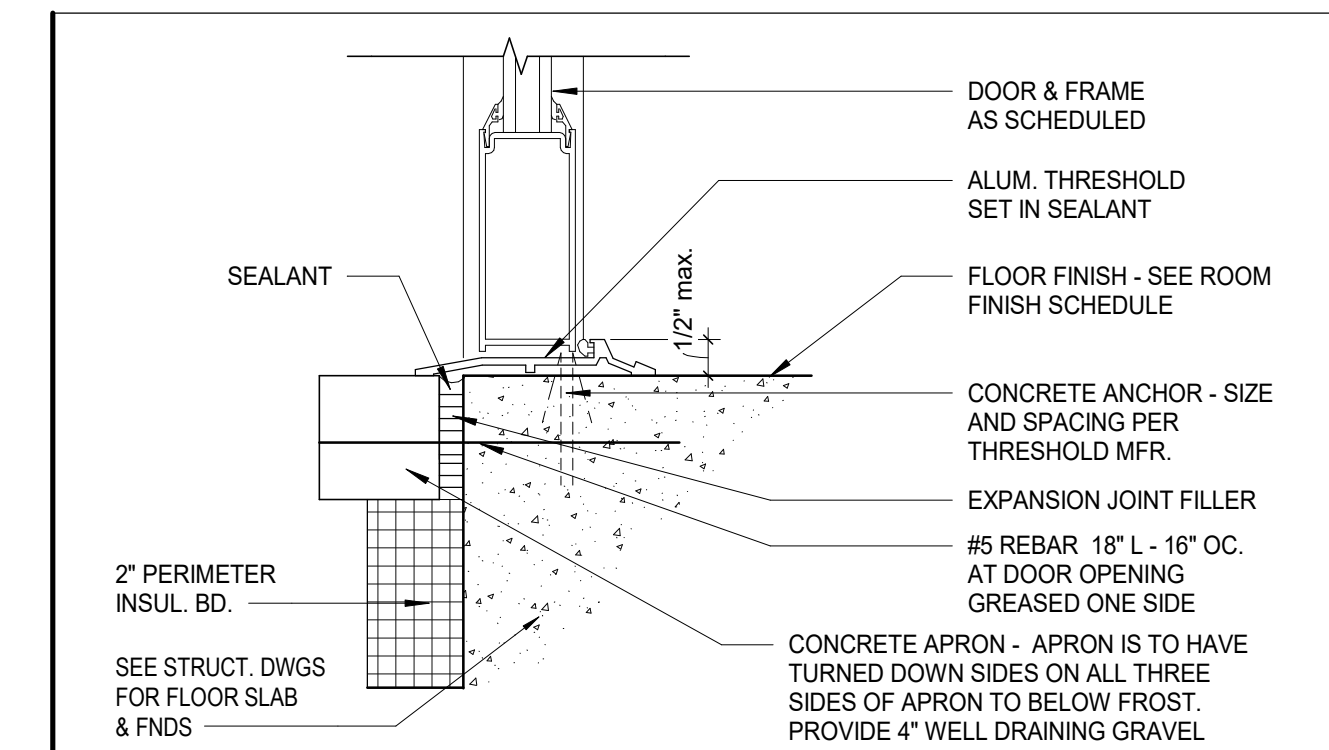


16 DETAIL EXT. DR. THRESHOLD
3" = 1'-0" REF: 1 / A501

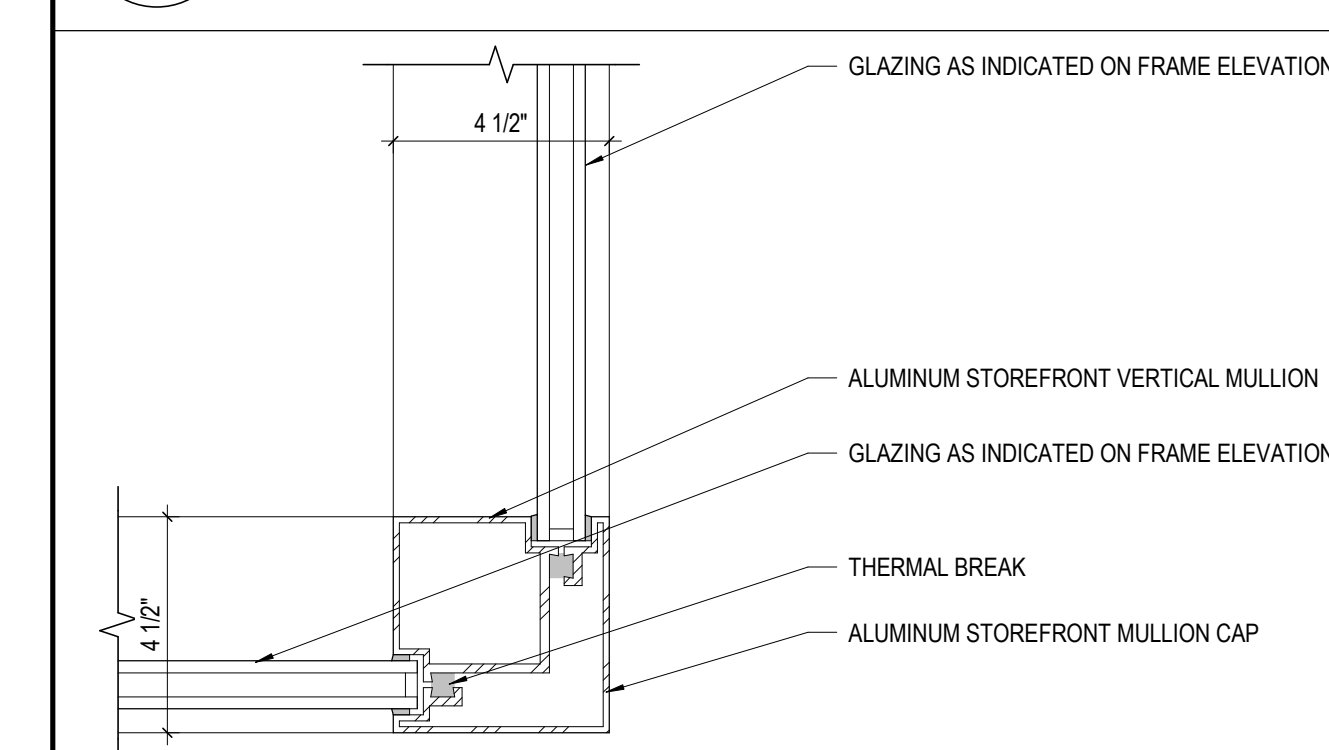


15 DETAIL STOREFRONT CORNER MULLION
3" = 1'-0" A70 DE-J - SE 8 OUT CORNER MULLION SQUARE

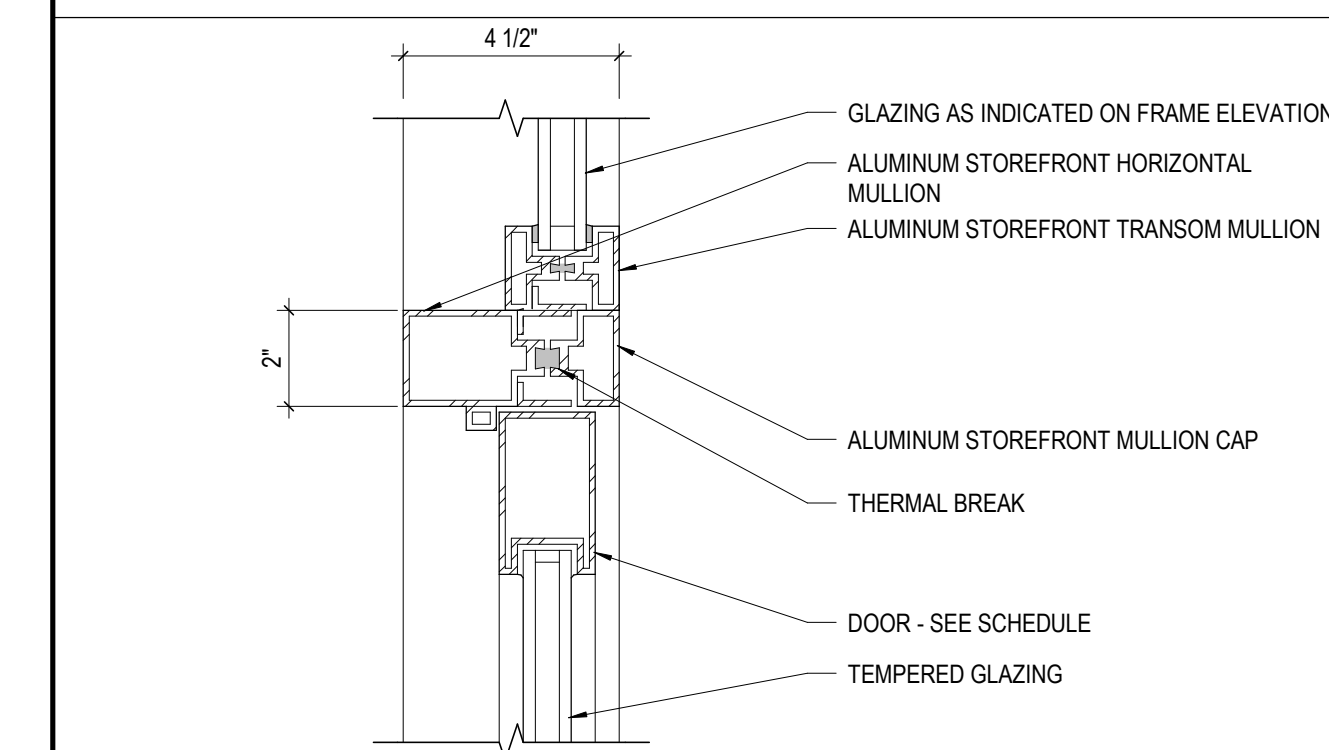


14 DETAIL STOREFRONT TRANSOM
3" = 1'-0" A70 DE-T - SE 8 DOOR HEAD

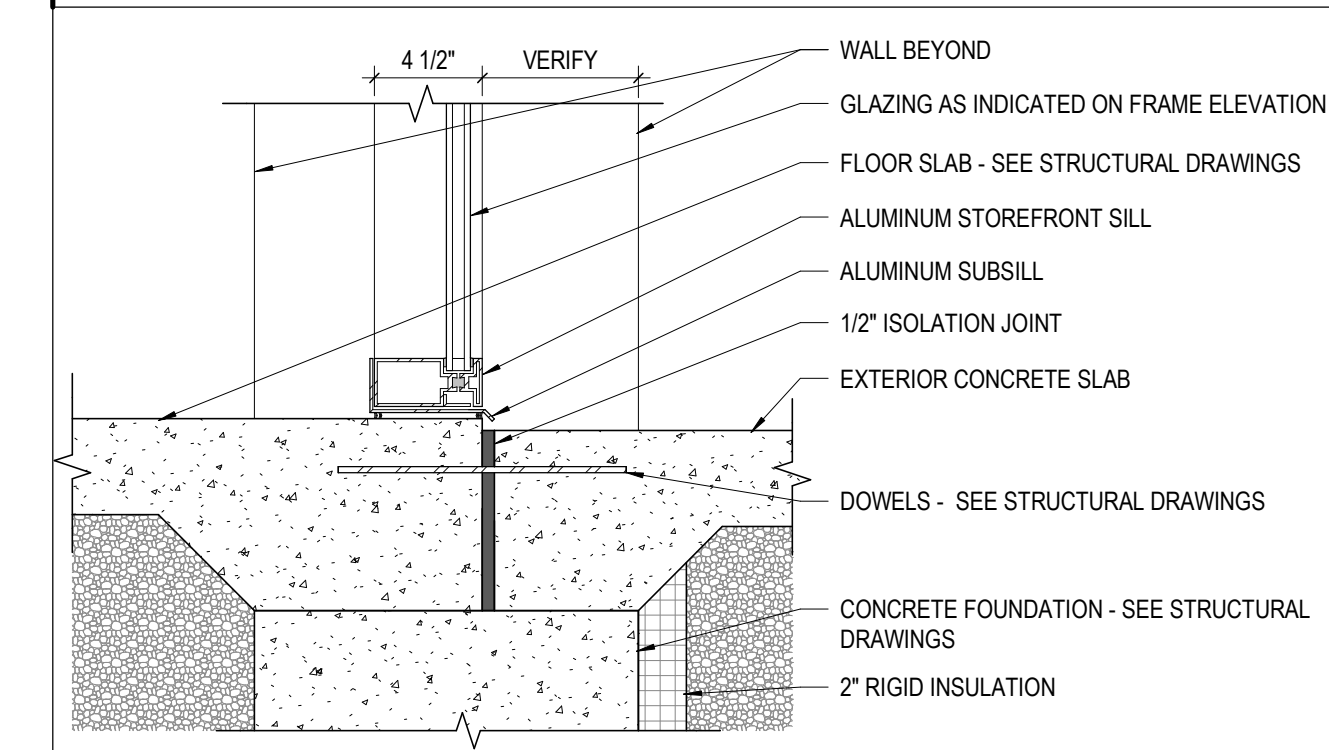


13 DETAIL STOREFRONT SILL - CONG. FOUND.
1 1/2" = 1'-0" A70 DE-S - SE 3 SIDELITE EXT INSUL

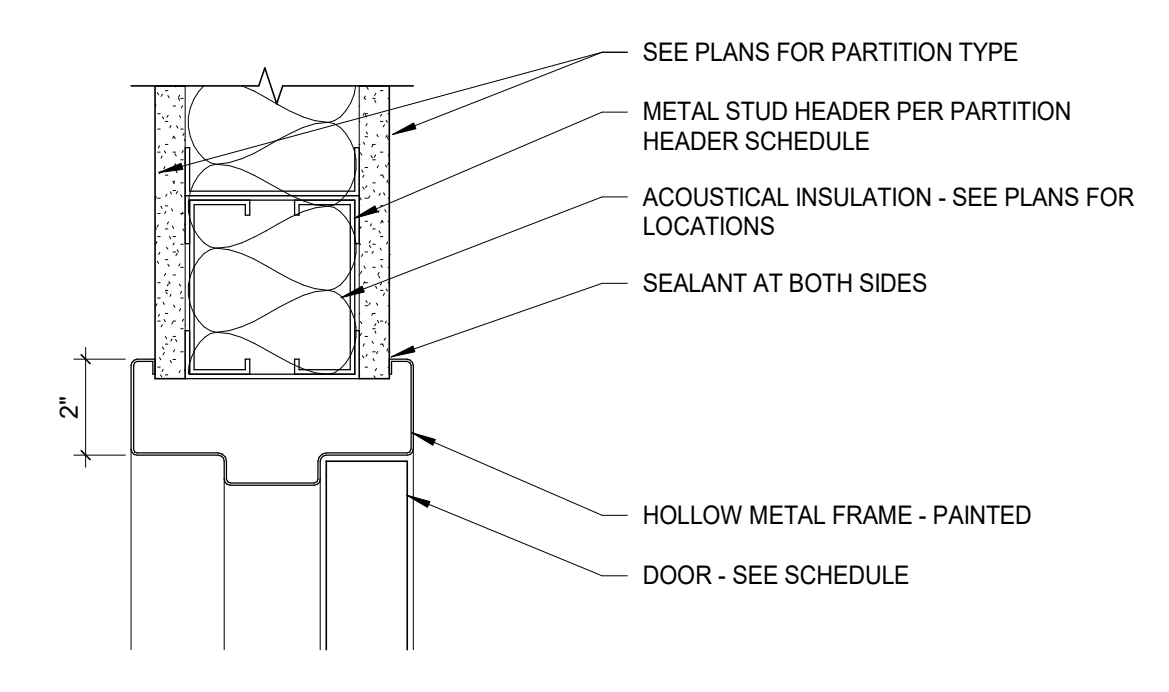


12 DETAIL H.M. DR. HEAD
3" = 1'-0"

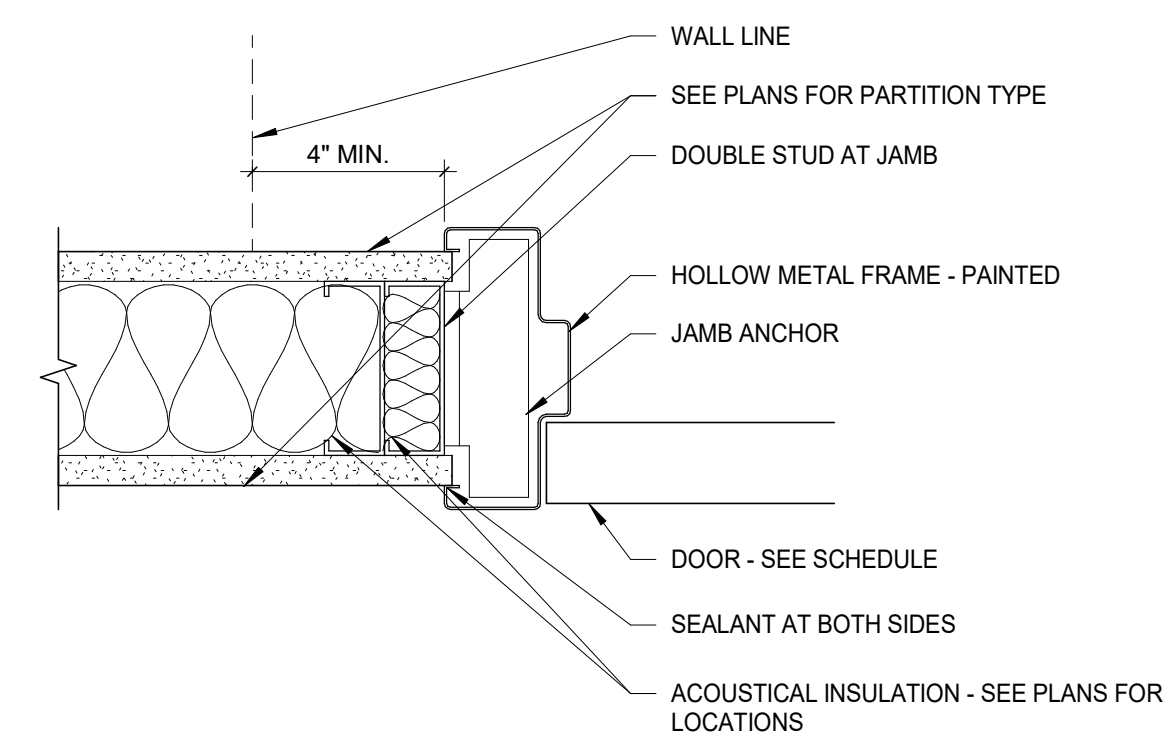


11 DETAIL H.M. DR. JAMB
3" = 1'-0"

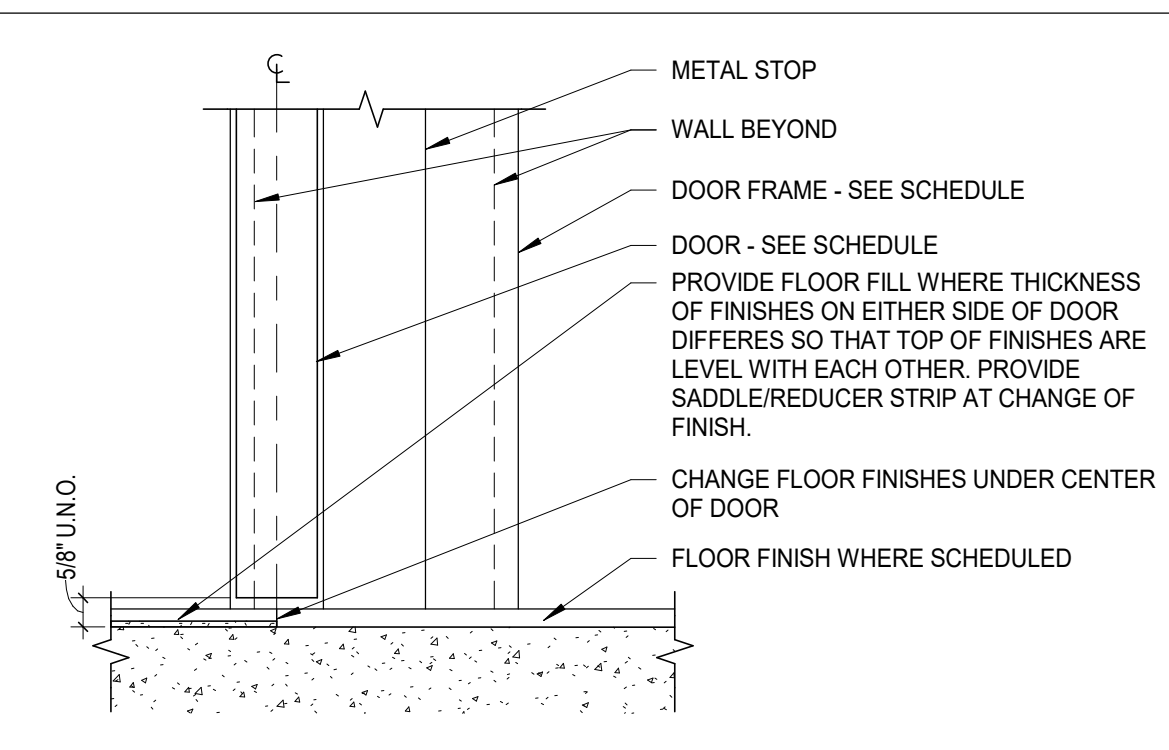


10 DETAIL H.M. DR. SILL
3" = 1'-0"

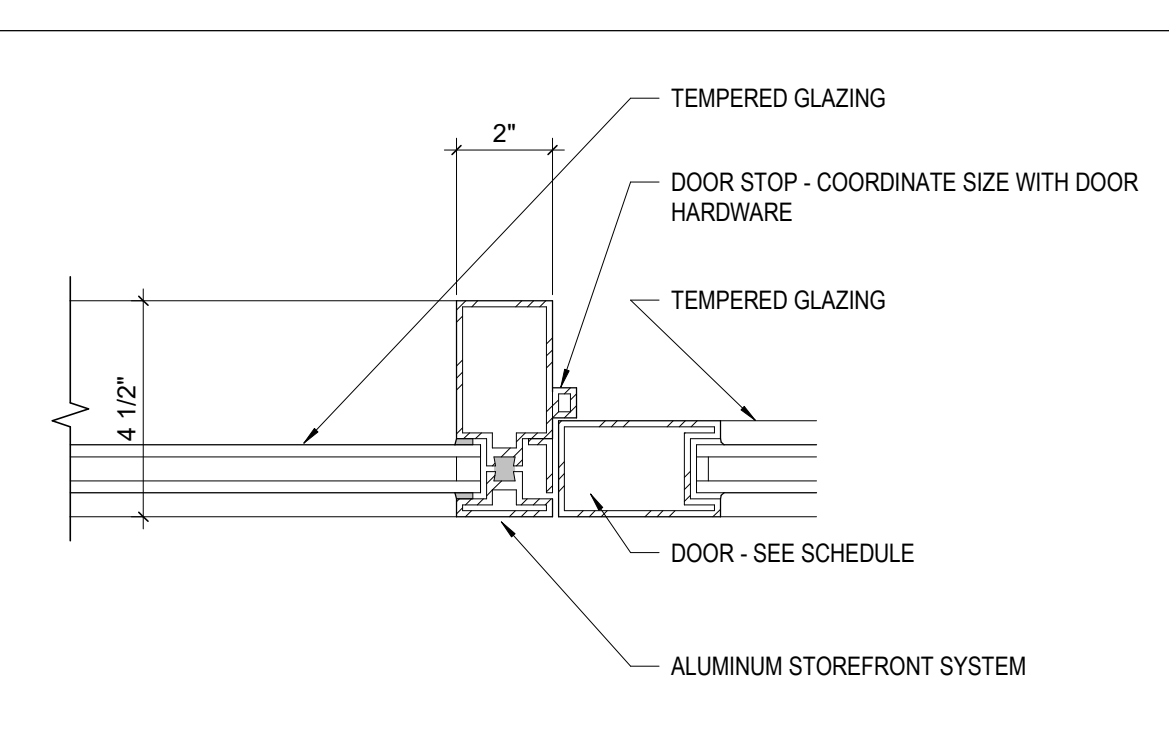


9 DETAIL STOREFRONT EXT. JAMB W/ SIDELITE
3" = 1'-0" A70 DI-SE - J 8 W/ SIDELITE

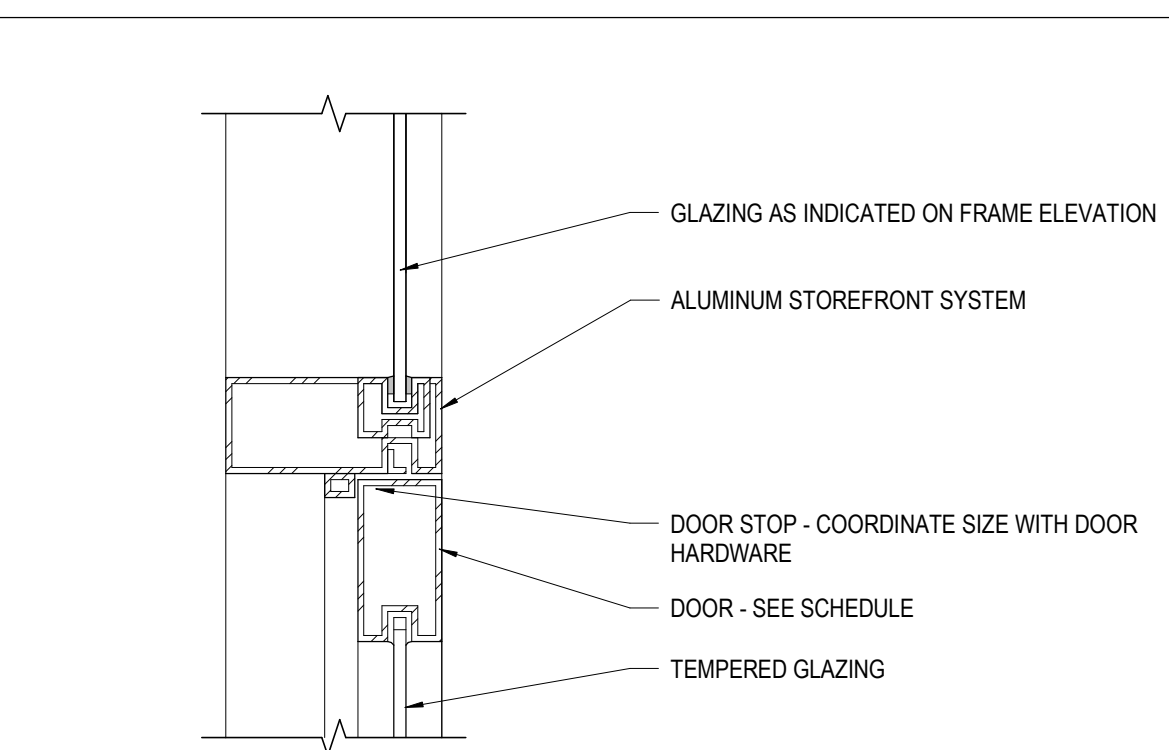


8 DETAIL @ STOREFRONT TRANSOM HEAD
3" = 1'-0" A70 DI-SI - T 8 TRANSOM

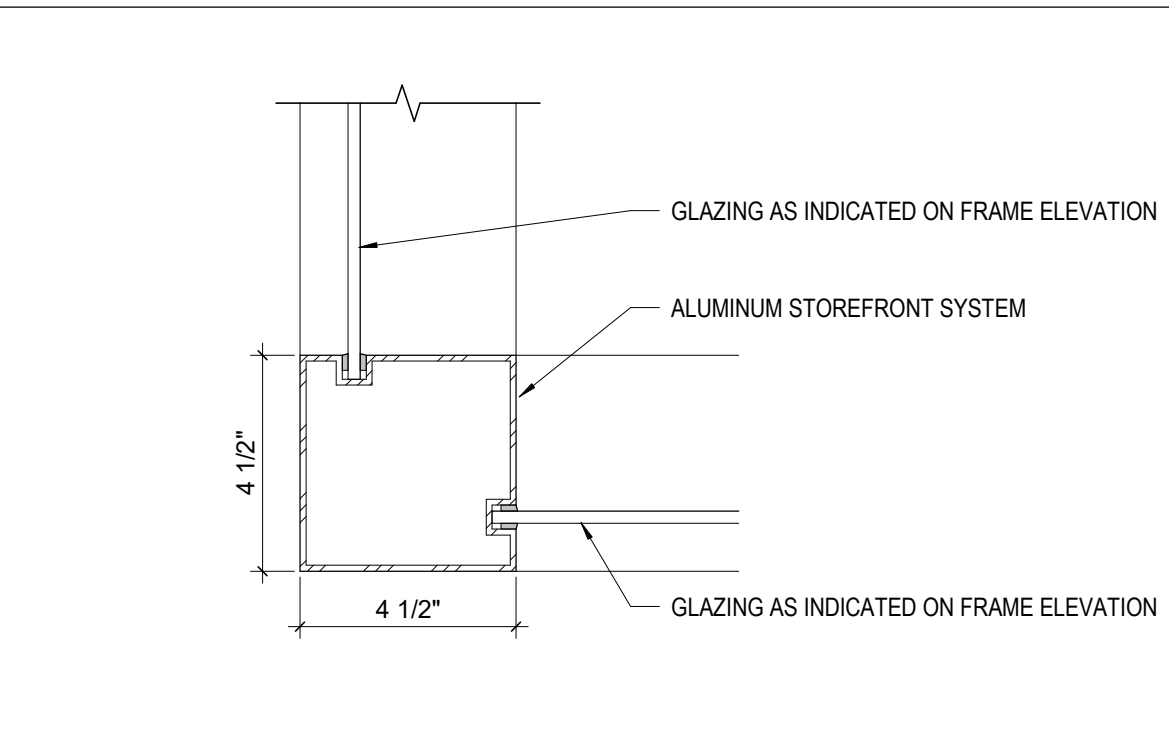


7 DETAIL STOREFRONT SIDELITE OUT CORNER
3" = 1'-0" A70 DI-SI - J 8 SQ CORNER

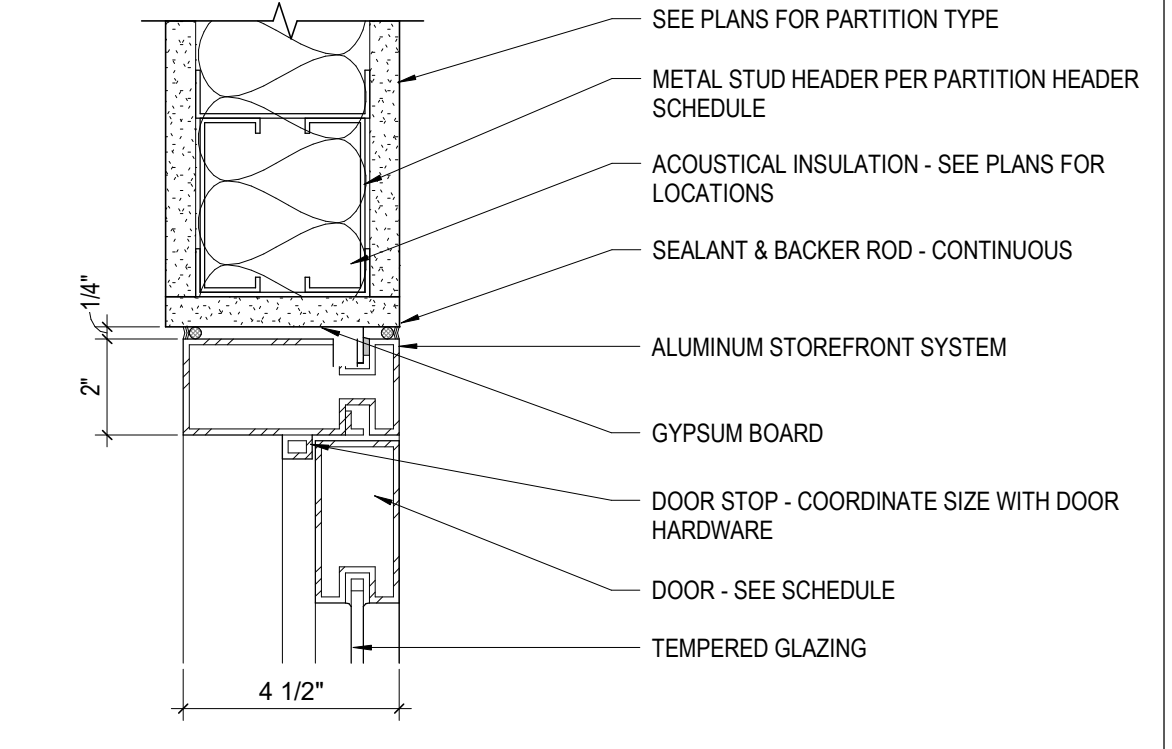


6 DETAIL INT. STOREFRONT DR. HEAD DETAIL
3" = 1'-0" A70 DI-SI - H 9 TYP

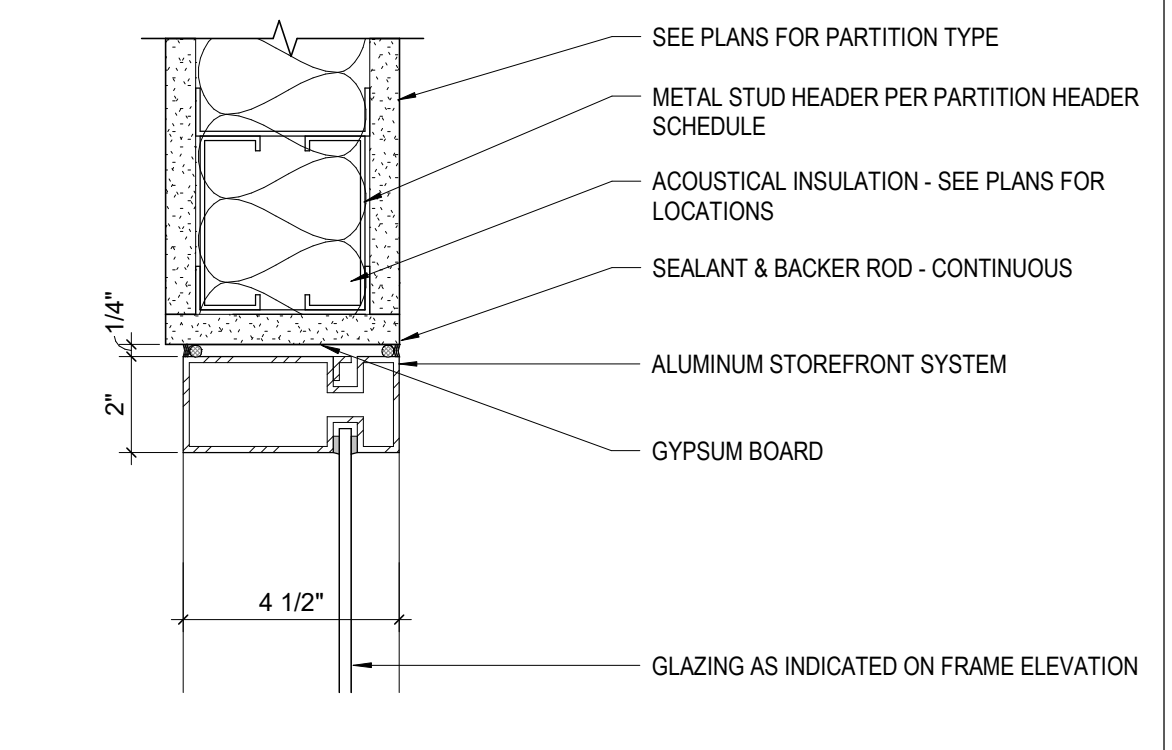


5 DETAIL INT. STOREFRONT SIDELITE HEAD
3" = 1'-0" A70 DI-SI - H 9 SIDELITE

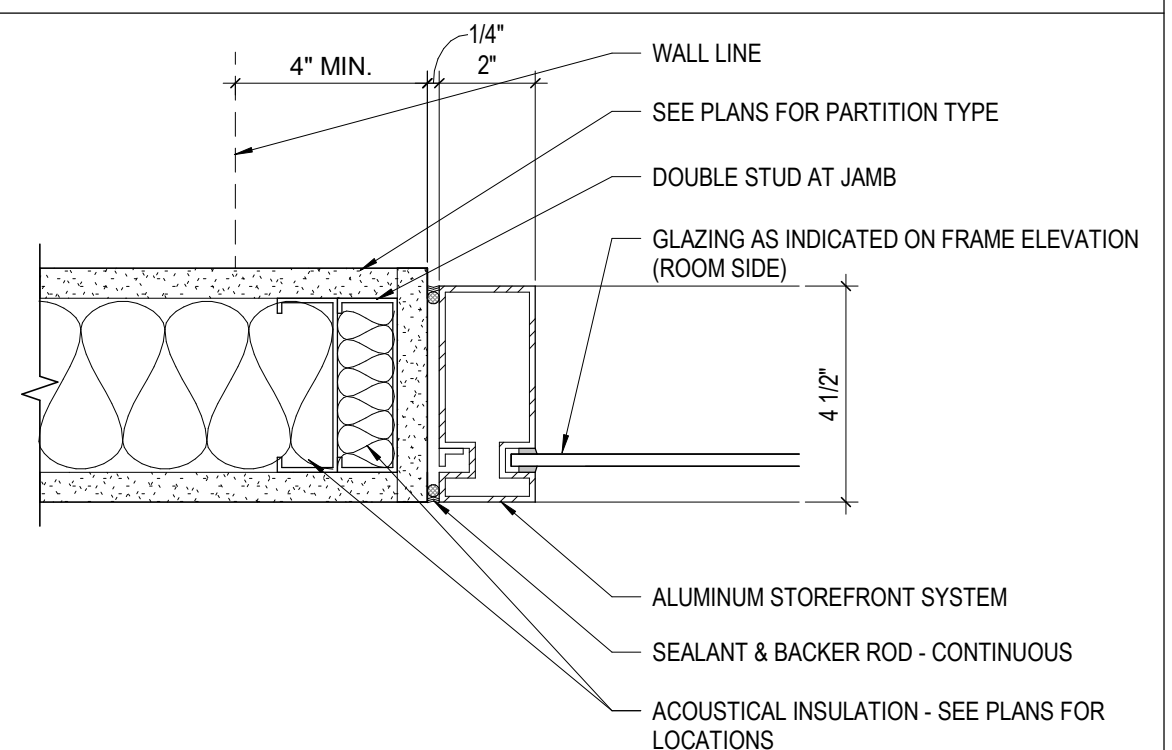


4 DETAIL INT. STOREFRONT SIDELITE JAMB
3" = 1'-0" A70 DI-SI - J 9 SIDELITE

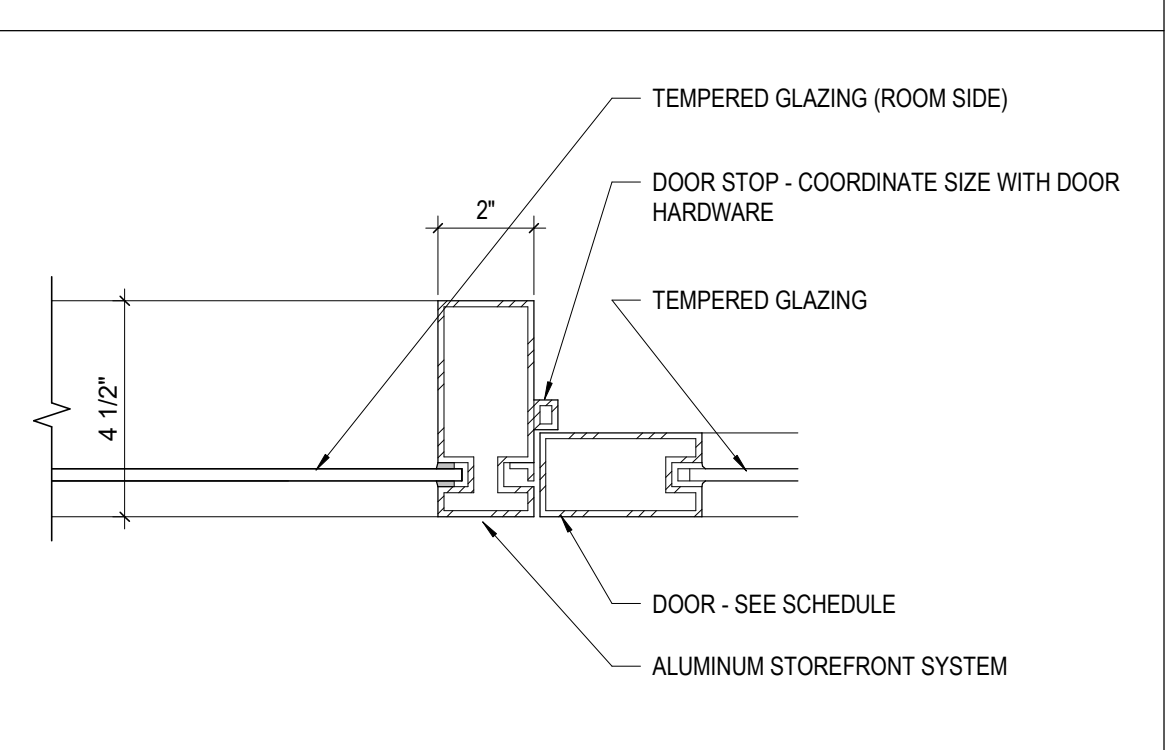

3 DETAIL INT. STOREFRONT DR. JAMB W/ SIDELITE
3" = 1'-0" A70 DI-SI - J 8 W/ SIDELITE

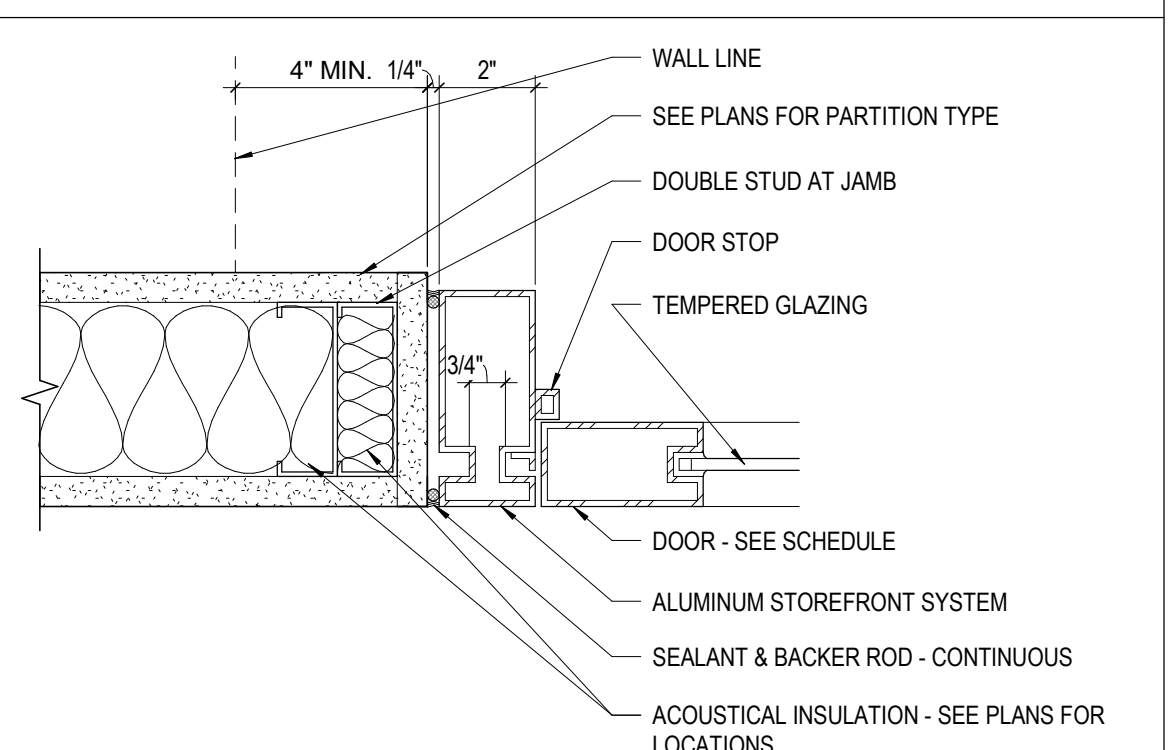

2 DETAIL TYP. INT. STOREFRONT DOOR JAMB
3" = 1'-0" A70 DI-SI - J 9 TYP

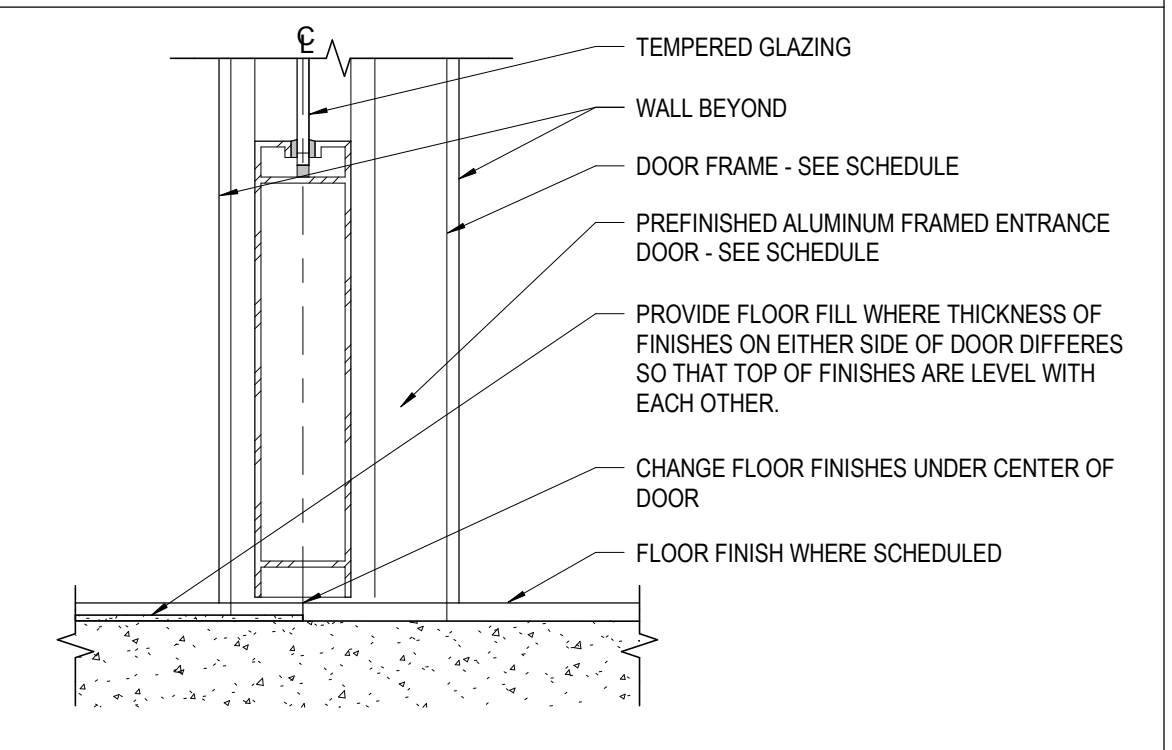

1 DETAIL TYPICAL INTERIOR STOREFRONT DOOR SILL
3" = 1'-0" REF: 1 / A501 A70 DS-E - S-SI INT TYP


#	DATE	CHANGE DESCRIPTION

RENOVATION OF HEARTLAND BANK DUBLIN
5303 FRANTZ ROAD
DUBLIN, OH 43017
FOR
HEARTLAND BANK


MOODY-NOLAN
300 SPRUCE STREET
SUITE 300
COLUMBUS, OHIO 43215
PHONE: (614) 461-4664
FAX: (614) 280-8881

DRAWING TITLE:
DOOR & WINDOW DETAILS


11/30/2020
DRAWN BY: DCB CHECKED BY: PFP
20022
A702
FINAL DEVELOPMENT PLAN

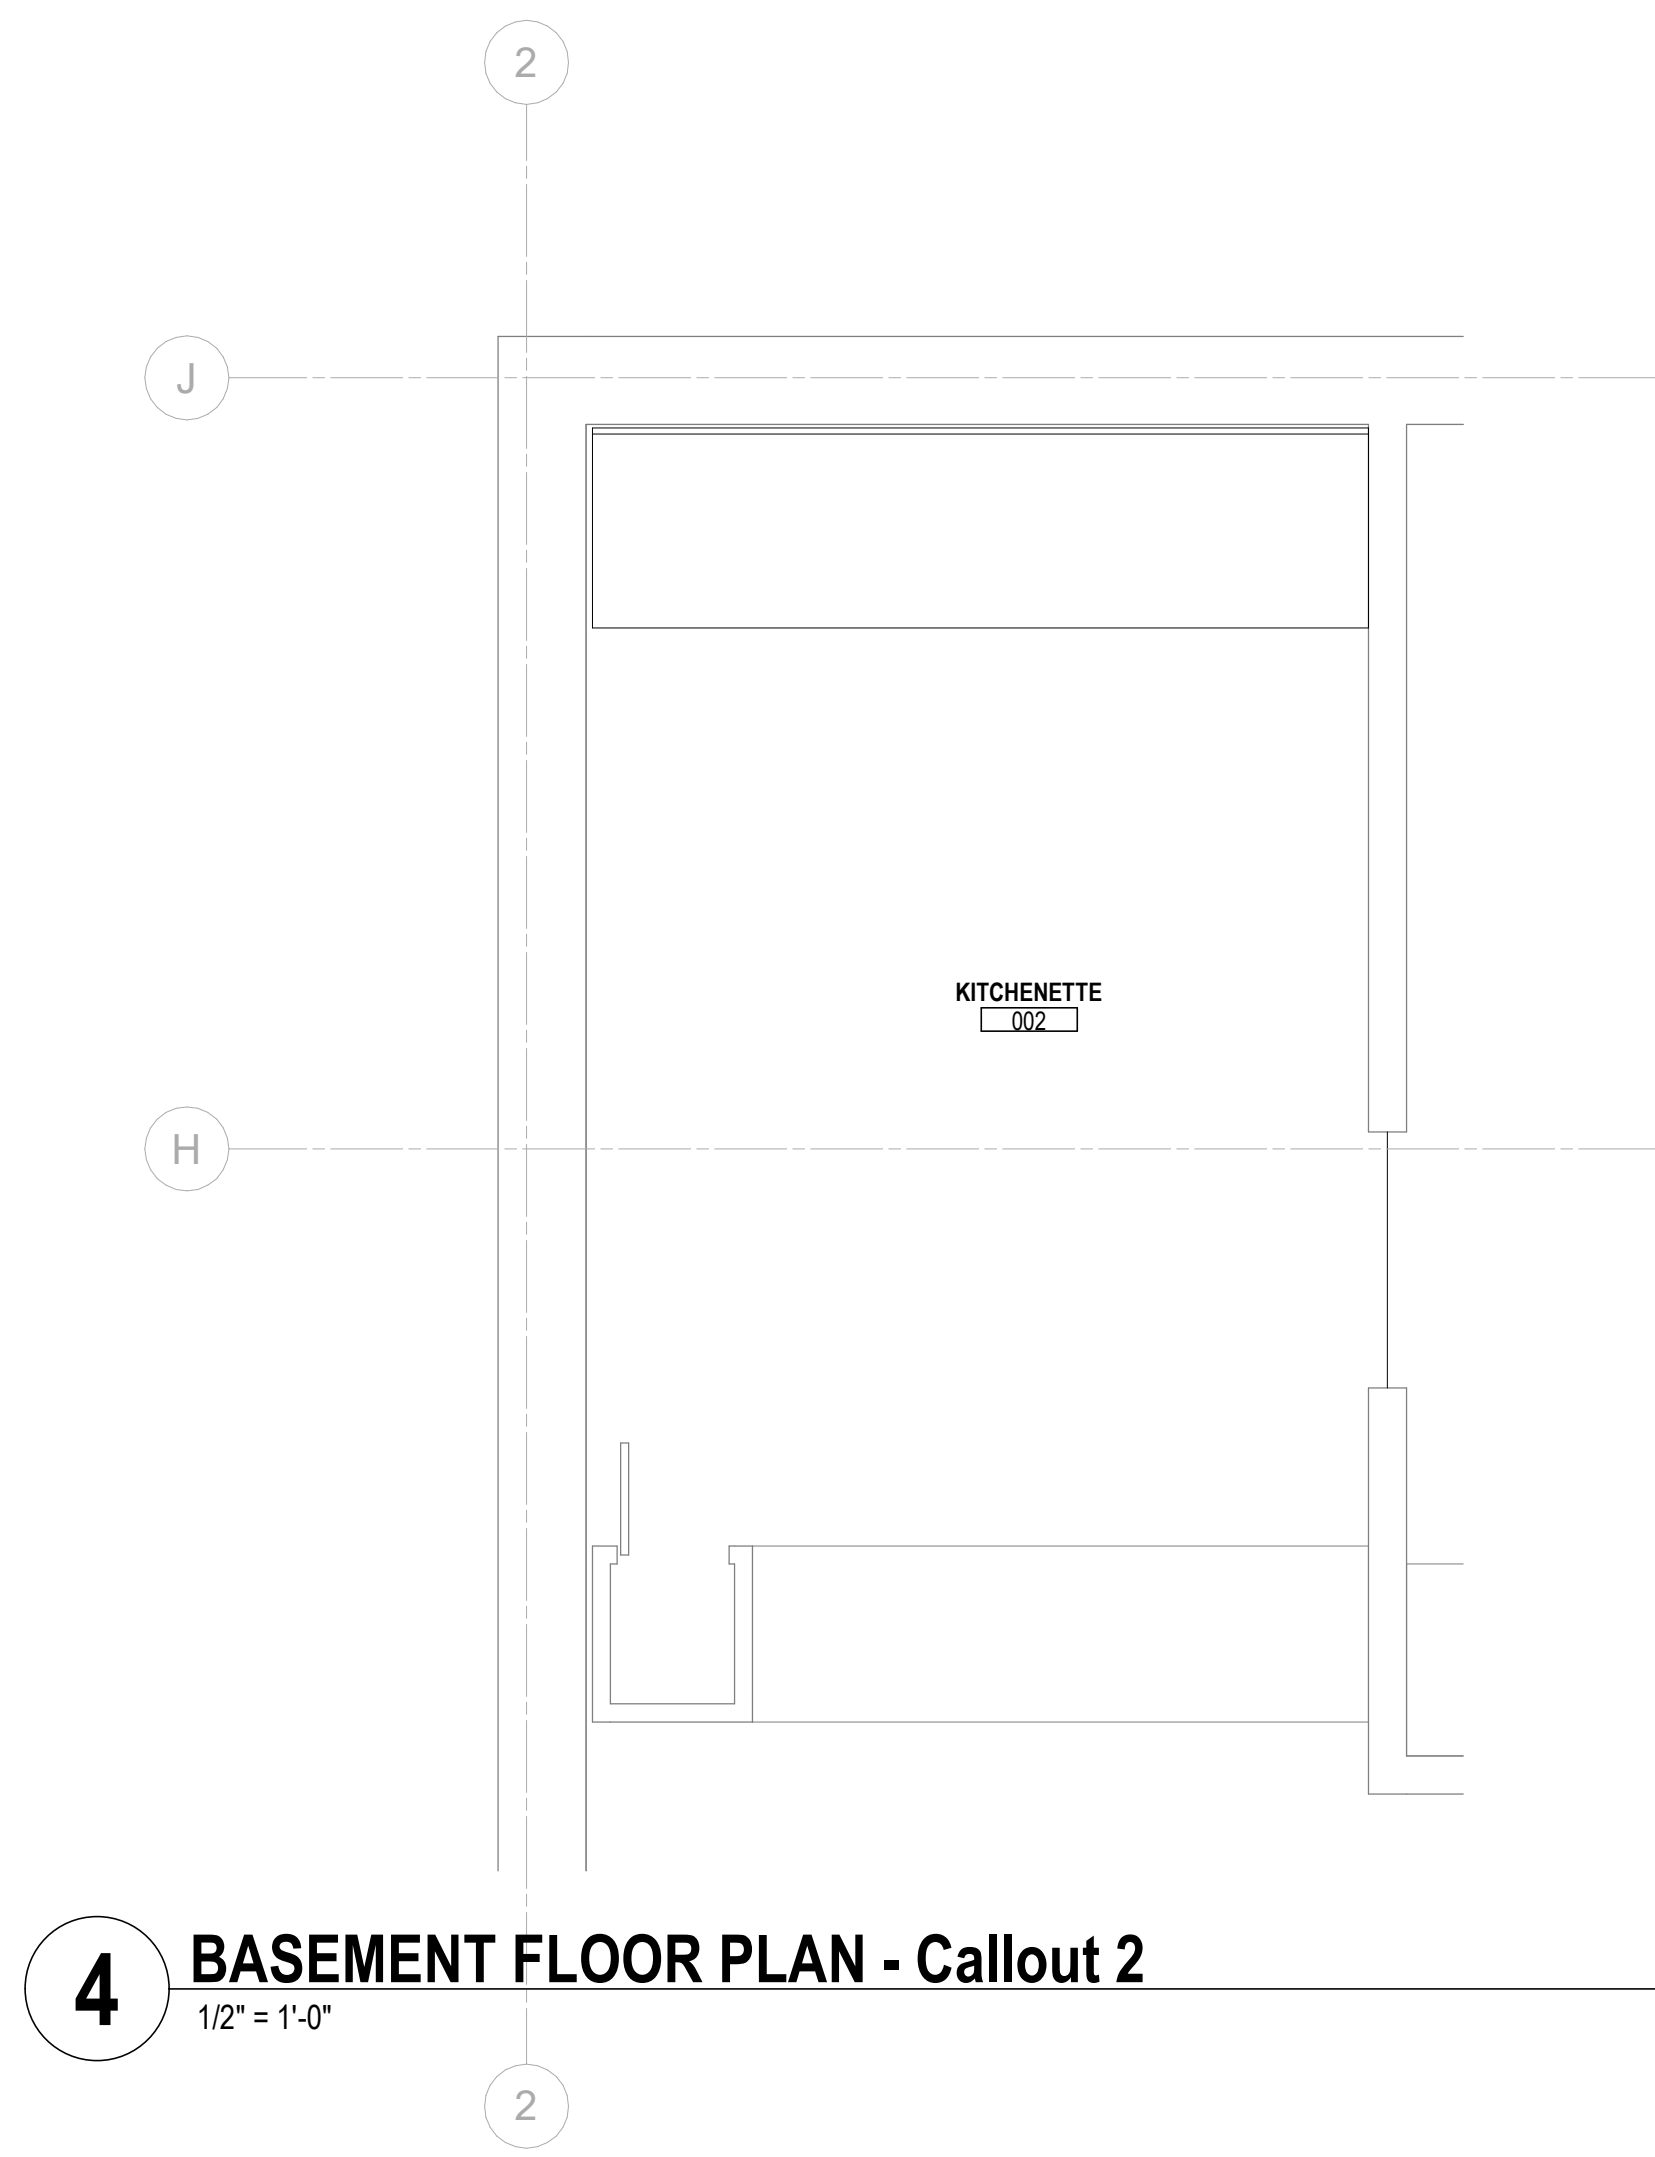


4 BASEMENT FLOOR PLAN - Callout 2
1/2" = 1'-0"

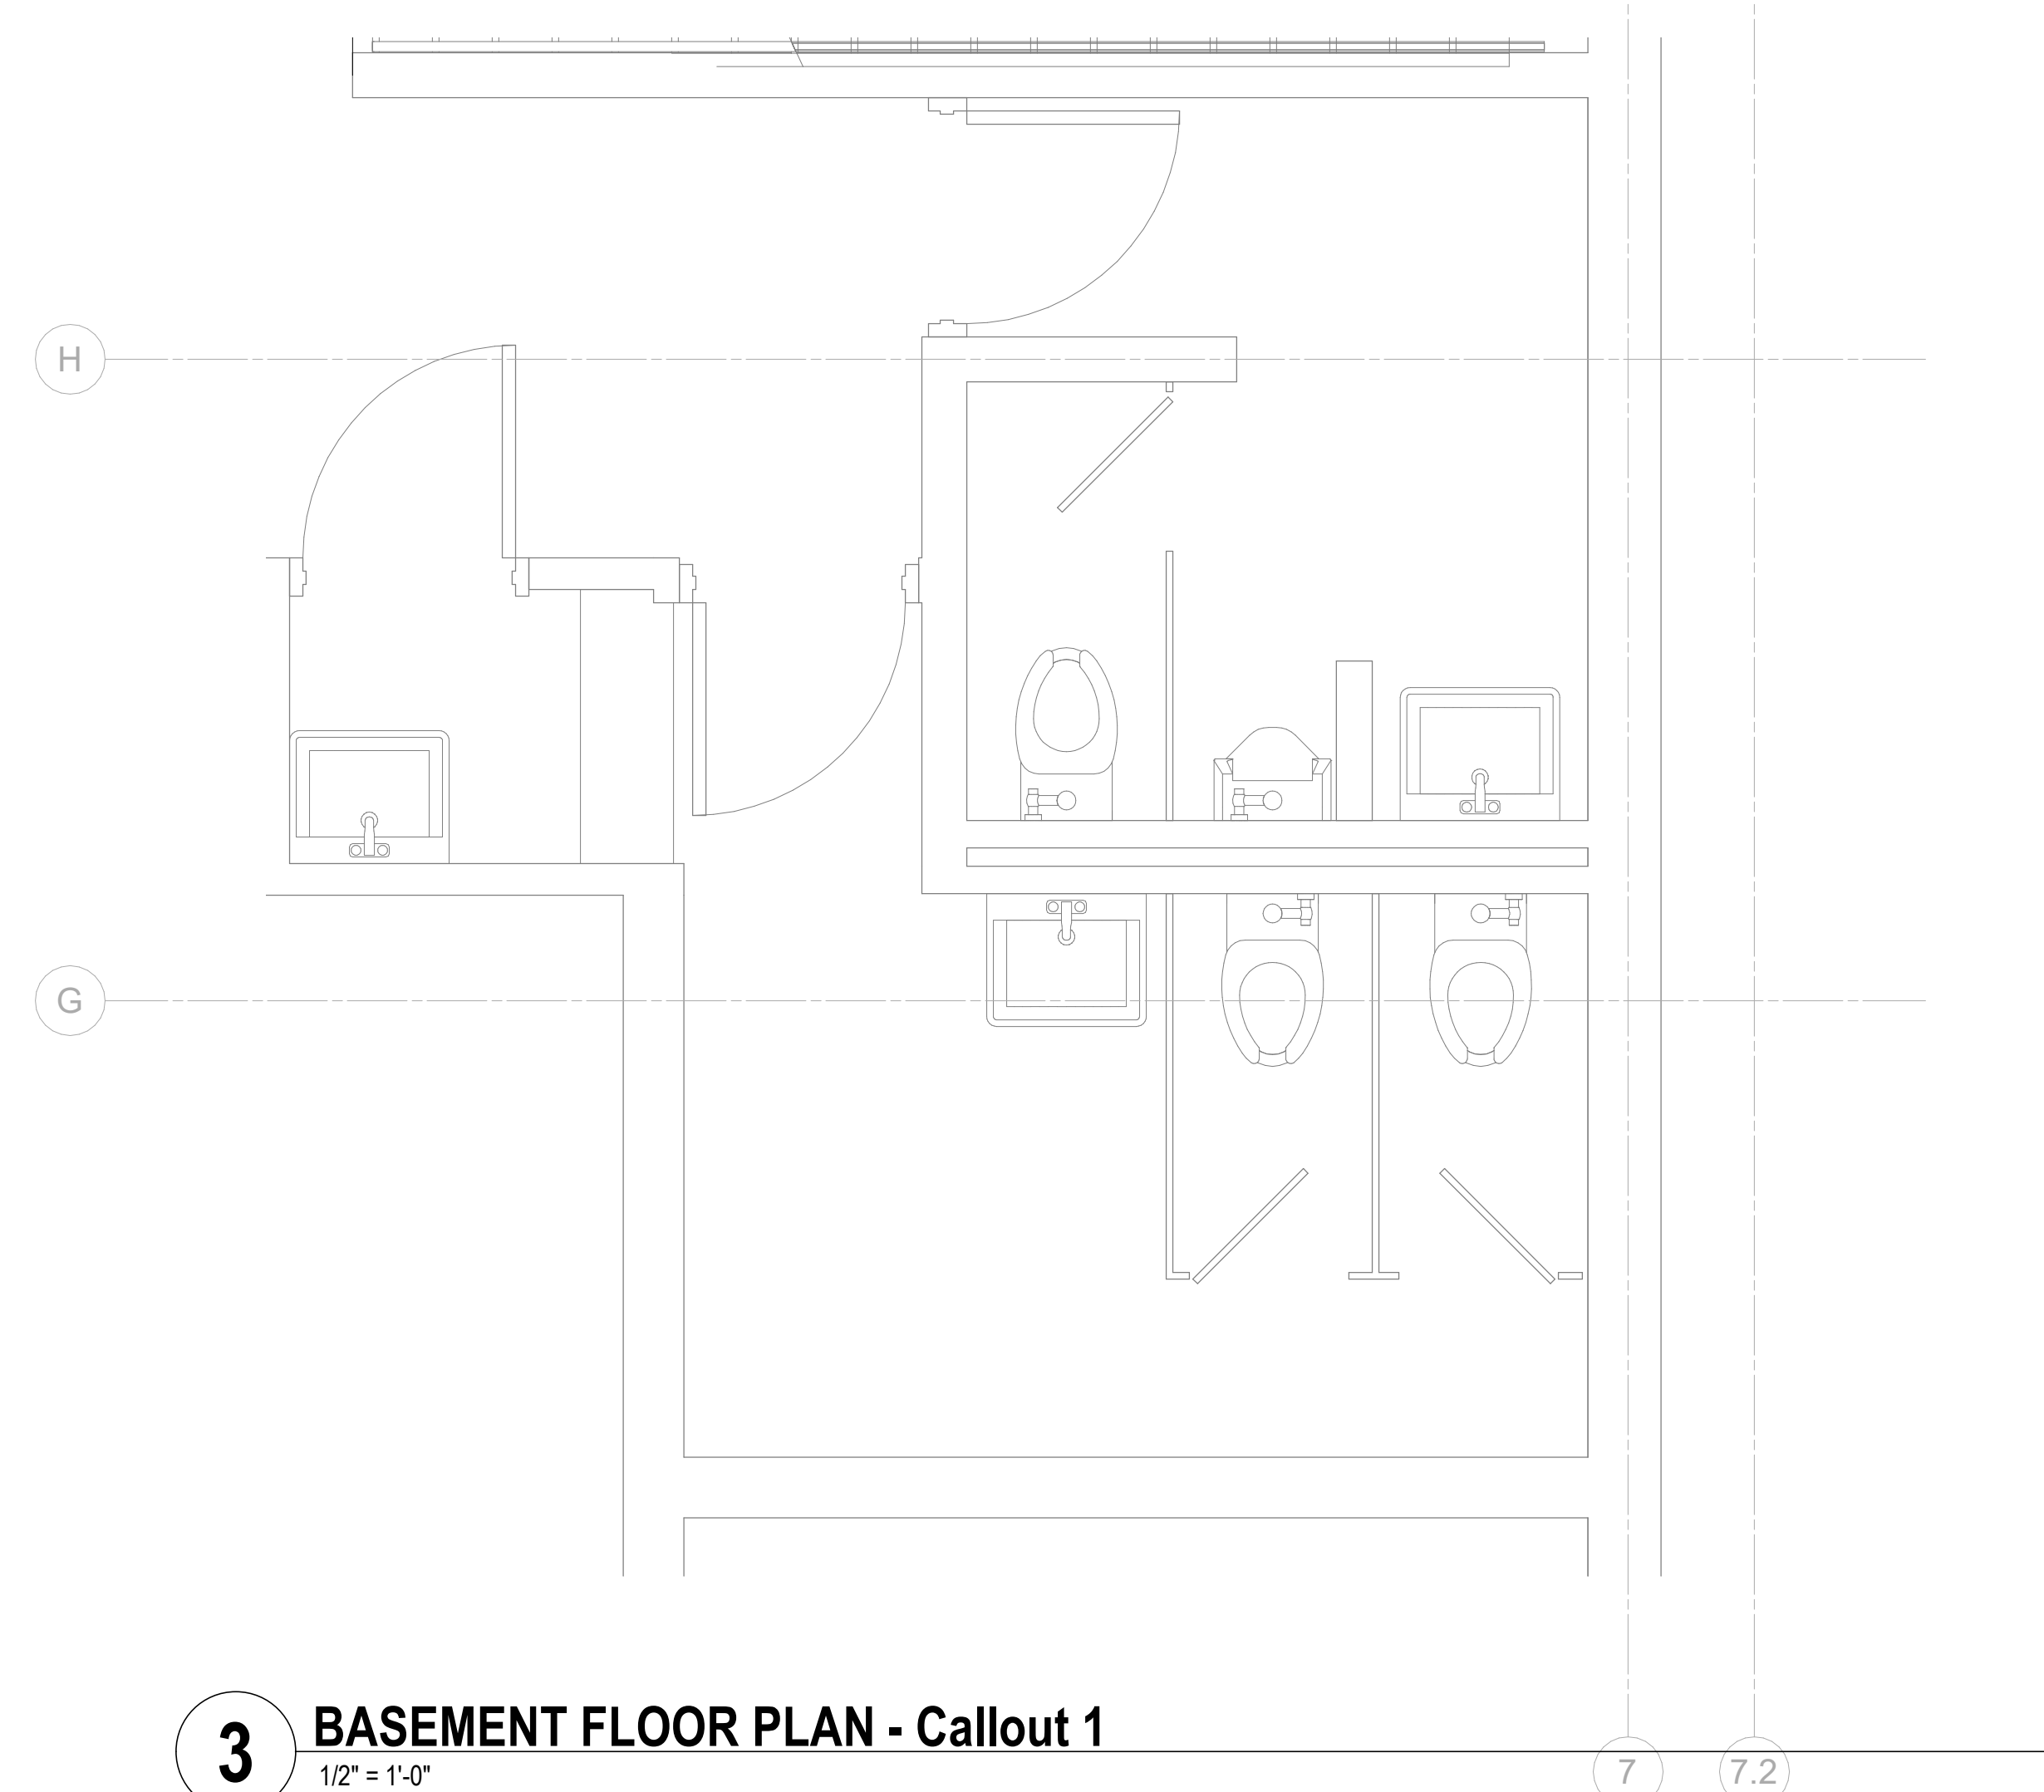

3 BASEMENT FLOOR PLAN - Callout 1
1/2" = 1'-0"

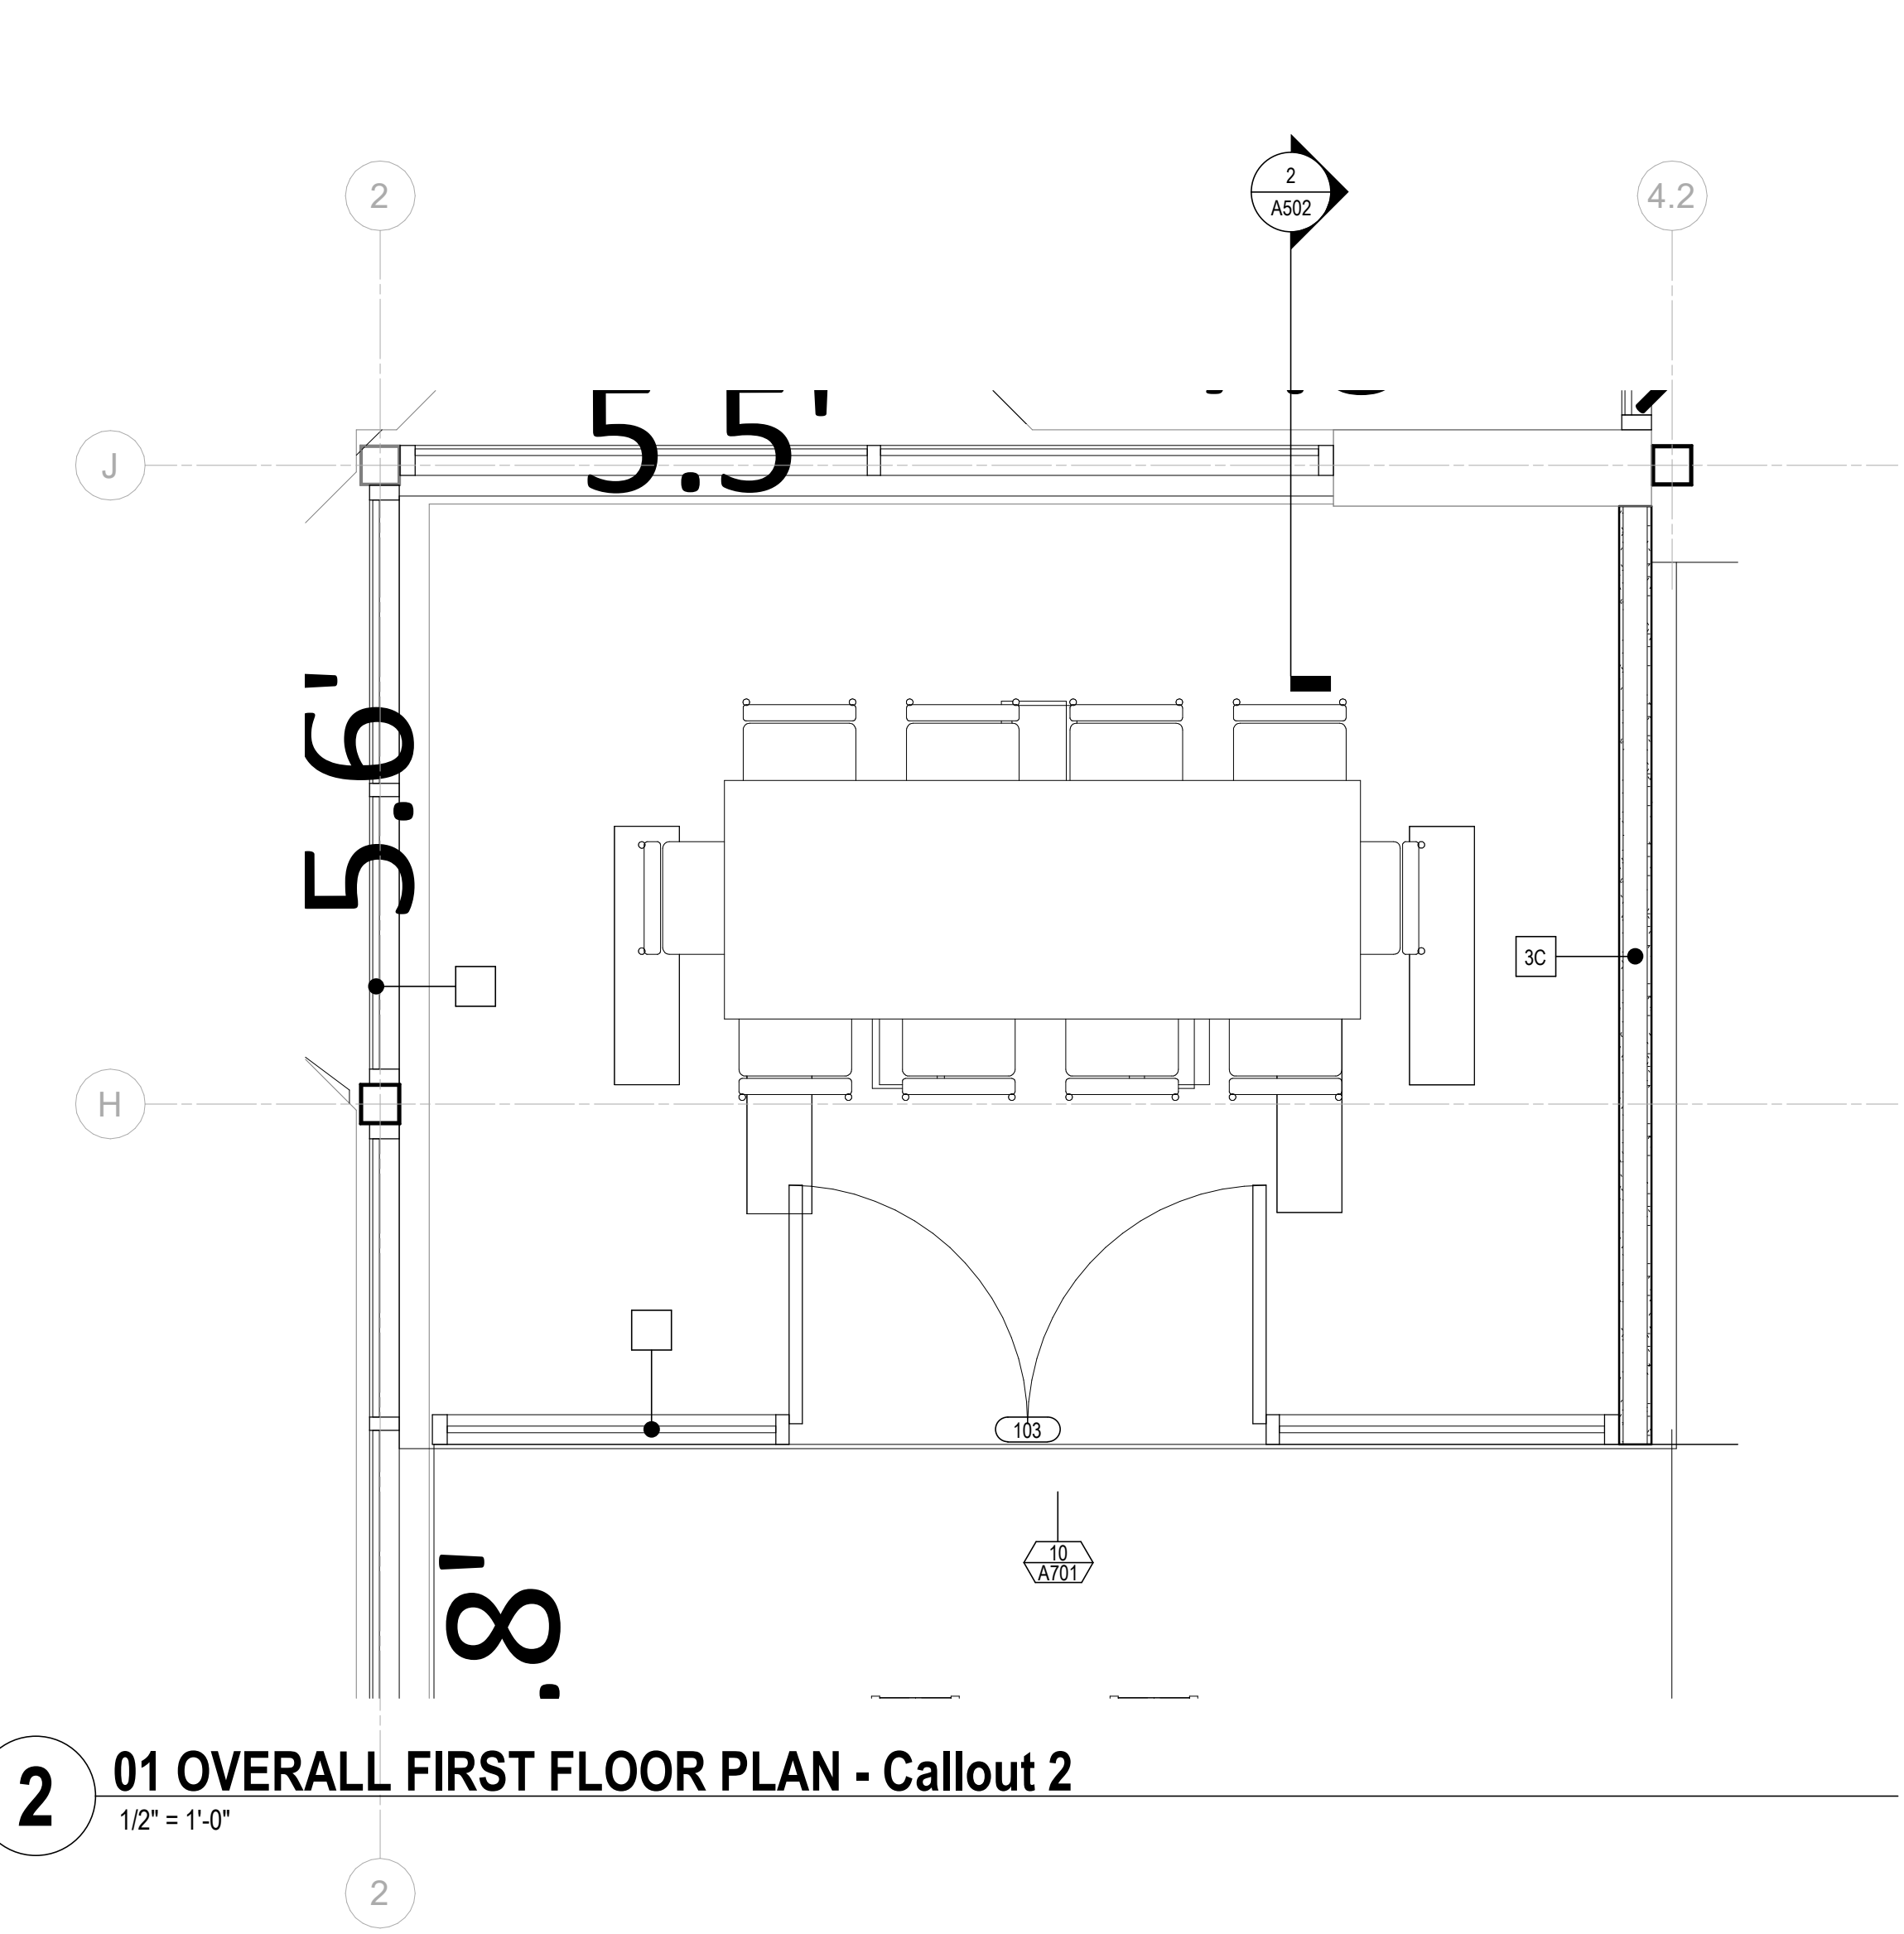

2 01 OVERALL FIRST FLOOR PLAN - Callout 2
1/2" = 1'-0"

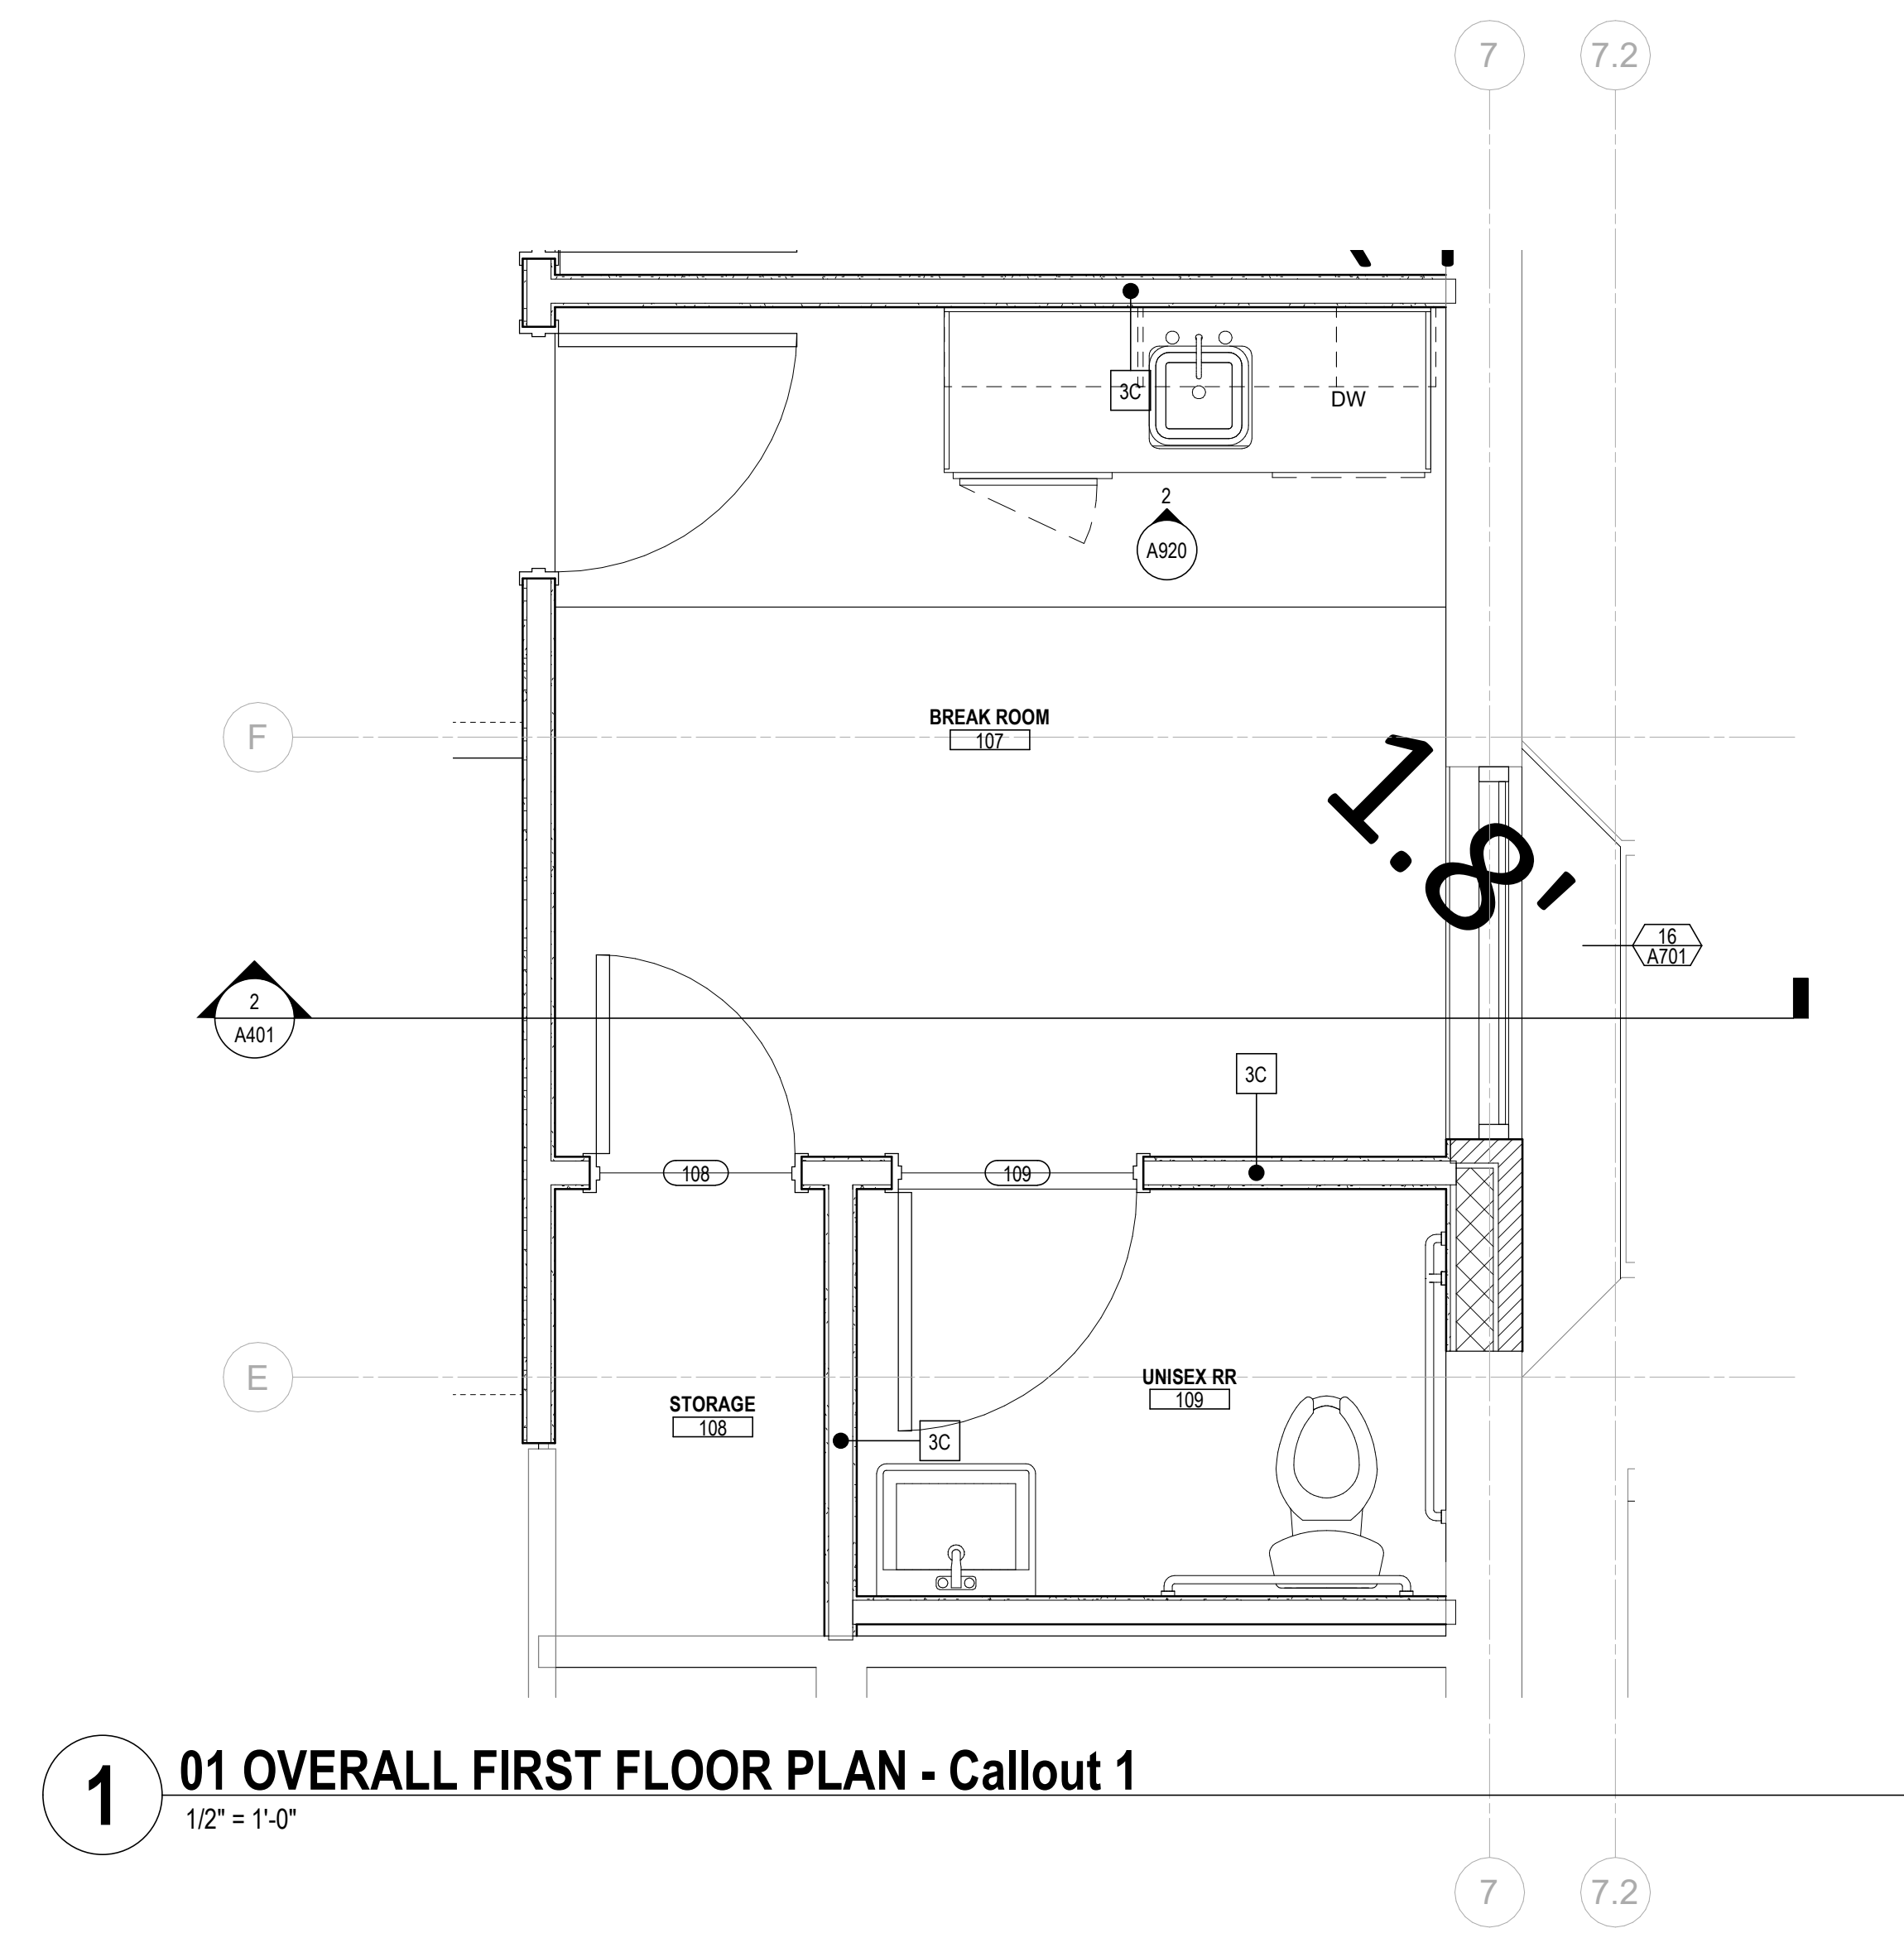

1 01 OVERALL FIRST FLOOR PLAN - Callout 1
1/2" = 1'-0"

GENERAL NOTES - ENLARGED PLANS

1. X

KEYNOTE LEGEND

KEY VALUE	KEYNOTE TEXT
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#	DATE	CHANGE DESCRIPTION

RENOVATION OF HEARTLAND BANK DUBLIN
5500 PRANTZ ROAD
DUBLIN, OH 43017
FOR
HEARTLAND BANK

MOODY-NOLAN
300 SPRUCE STREET
SUITE 300
COLUMBUS, OHIO 43215
PHONE: (614) 461-4664
FAX: (614) 280-8881

ENLARGED PLANS

PROGRESS DRAWING NOT FOR CONSTRUCTION	11/30/2020
	DRAWN BY: XXXX CHECKED BY: XXXX
	20022
	A810
FINAL DEVELOPMENT PLAN	

FINISH LEGEND

FLOORS

SC-1 SEALED CONCRETE 1 - SEE SPECS

Luxury Vinyl Tile
 LVT-1 MOHAWK - LINEATE GRAY

Porcelain Tile Floor (PTF)

PTF-1: CAESAR ONE CEMENT 30X30 MATTE RECTIFIED USE GT-
 PTF-2: CAESAR ONE CEMENT 12X24 MATTE RECTIFIED USE GT

Carpet (CR) *INSTALL 1/2 OFFSET ASHLAR

CR-1: INTERFACE - HUMAN NATURE COLLECTION - HN850 NICKEL
 CR-2: INTERFACE - HUMAN NATURE COLLECTION - HN 810 NICKEL
 CR-3: INTERFACE - HUMAN NATURE COLLECTION - CLEMENTINE
 CR-4: INTERFACE - HUMAN NATURE COLLECTION - COBALT
 CR-5: INTERFACE ABOVE BOARD COLOR: BIRCH

WALKOFF CARPET (WO)

WO-1: SHAW CONTRACT GROUP - STEPPIN OUT - BONJOUR II - COLOR: 31957

BASE

Rubber Base (RB) *RB-1 ON ALL ROOMS U.N.O.

RB-1: TARKETT - 3" MILLWORK OBLIQUE PROFILE BASE - STRAIGHT: COLOR: MOONROCK

Porcelain Tile Base (PTB)

PTB-1 TO MATCH PTF-1

WALLS

Reclaimed Wood Wall and Ceiling - (WD)

WD-1: OLDE WOOD - DISTRESSED COLLECTION - ANTIQUE BARN SIDING - CREME

Ceramic Wall Tile (CT)

CT-1: COLOR BY NUMBER - 3X0 WHITE - GT-2
 CT-2: DALTILE RETRO ROUNDS MOSAIC COBALT BLUE USE GT-3
 CT-3: DALTILE - SEASON WOOD - COLORBODY PORCELAIN 12X48 - COLOR: SNOW PINE (INSTALL 1/2 OFFSET RUNNING BOND) USE GT-1

*ALL TILE WALLS TO BE FULL HEIGHT FLOOR TO CEILING, U.N.O.

Paint (PT)

* PAINT ALL WALLS PT-1 U.N.O.

PT-1: BENJAMIN MORE: SUPER WHITE PM-1
 PT-2: SHERWIN WILLIAMS: LAZY GRAY SW6254
 PT-3: BENJAMIN MORE: CHELSEA GRAY

Vinyl Wallcovering (WC)

WC-1: DL DODCH- STACY GARCIA HIGHLIGHTS COLOR: COBALT
 WC-2: MINARMI - HITCH: COLOR: MIMOSA

MISCELLANEOUS

Plastic Laminate (PL) *INSTALL PATETRN VERTICAL U.N.O.

PL-1: WILSONART: ASIAN NIGHT
 PL-2: WILSONART: SHADOW ZEPHYR MATTE FINISH

Solid Surface (SS)

SS-1: CORIAN: GLACIER WHITE
 SS-2: SILESTONE COLOR: WHITE STORM

Grout (GT) *USE GT-1 U.N.O.

GT-1: BOSTIK - COLOR: BUFF H188
 GT-2: BOSTIK - COLOR: CHAR BLACK H139
 GT-3: BOSTIK BRIGHT WHITE H177

Floor Transition Strip

Schüco/SCHÜCO - METAL TRANSITION STRIP BETWEEN PORCELAIN TILE AND CARPET.

Corner Guards (CG)

USE STAINLESS STEEL CORNER GUARDS, 8" HIGH PLACED ABOVE WALL BASE.

USE FRY REGLET WALL COVERING CORNER GUARD TRIM @ WALLCOVERING EXTERNAL CORNERS, FULL HEIGHT OF WALL.

GENERAL NOTES - FINISH PLANS

- STANDARDS AND PROCEDURES FOR THE PREPARATION AND APPLICATION OF INTERIOR FINISHES ARE DEFINED IN THE PROJECT MANUAL. FINISH (SUB) CONTRACTORS ARE REQUIRED TO READ, UNDERSTAND AND FOLLOW ALL RELEVANT SECTIONS OF THE PROJECT MANUAL.
- FINISH MATERIALS ARE LISTED IN THE LEGEND COMPONENT OF THE FINISH SCHEDULE. SPECIFICATIONS ARE INCLUDED IN THE PROJECT MANUAL. ANY CONFLICTS OR DISCREPANCIES BETWEEN THESE TWO SHOULD BE BROUGHT TO THE ARCHITECT'S ATTENTION IMMEDIATELY.
- NO FINISH MATERIAL SUBSTITUTIONS WILL BE ACCEPTED EXCEPT IN THE SPECIFIC CIRCUMSTANCES ENUMERATED IN THE PROJECT MANUAL.
- PAINTED HOLLOW METAL DOORS AND FRAMES TO BE PAINTED TO MATCH ADJACENT WALL COLOR UNLESS NOTED OTHERWISE. MATERIAL, FINISH AND COLOR INFORMATION FOR ALL OTHER DOORS AND FRAMES IS CONTAINED IN THE DOOR SCHEDULE AND ITS ASSOCIATED LEGENDS. IF WALLS ON OPPOSITE SIDES OF DOOR FRAME ARE DIFFERENT COLORS THE PAINT COLORS SHOULD BE SPLIT AT THE JAMB OF THE FRAME.
- ALL VERTICAL TRANSITIONS BETWEEN DIFFERING WALL FINISHES ARE TO BE MADE AT INSIDE CORNERS (UNLESS NOTED OTHERWISE).
- FLOORING MATERIAL DESIGNATED FOR STAIRS IS TO INCLUDE STAIR AND ALL ASSOCIATED TREADS, RISERS, LANDINGS, ETC. (UNLESS NOTED OTHERWISE).
- PAINT DESIGNATED FOR METAL STAIR COMPONENTS IS TO INCLUDE ALL EXPOSED METAL COMPONENTS ASSOCIATED WITH THE STAIR SYSTEM ITSELF. ALL EXPOSED STRUCTURAL STEEL COMPONENTS SUPPORTING THE STAIR SYSTEM (UNLESS NOTED OTHERWISE), AND ALL EXPOSED METAL COMPONENTS OF THE HANDRAIL AND GUARDRAIL SYSTEMS (UNLESS NOTED OTHERWISE). UNDERSIDES OF STAIR RUNS AND LANDINGS ARE CONSIDERED "EXPOSED" IN ALL SITUATIONS.
- FOR CLARITY, SOME FINISH INFORMATION HAS BEEN PRESENTED GRAPHICALLY IN THE FORM OF FINISH AND FLOORING PLANS. SHOULD THERE BE A DISCREPANCY BETWEEN THE FINISH SCHEDULE AND THESE PLANS, THE ARCHITECT SHOULD BE NOTIFIED IMMEDIATELY. FOR THE PURPOSE OF BIDDING, INFORMATION DETAILED ON THE FINISH FLOOR PLANS AND FLOORING PLANS IS TO TAKE PRECEDENCE OVER THE FINISH SCHEDULE UNTIL FURTHER CLARIFICATION CAN BE GIVEN. FOR AREAS NOT SPECIFICALLY DETAILED ON THESE PLANS, THE FINISH SCHEDULE PERTAINS.
- PAINT DESIGNATED FOR EXPOSED OVERHEAD STRUCTURE IS TO INCLUDE ALL EXPOSED COMPONENTS INCLUDING (BUT NOT EXCLUSIVE TO) DECKING, STRUCTURAL MEMBERS, MECHANICAL AND ELECTRICAL DELIVERY SYSTEMS, FIRE PROTECTION SYSTEMS (EXCLUDING SPRINKLER HEADS), AND ALL OTHER MISCELLANEOUS BUILDING SYSTEMS LOCATED OVERHEAD. EACH OF THE AFOREMENTIONED CATEGORIES IS TO INCLUDE ANY AND ALL ASSOCIATED SUPPORTS, FASTENERS, HANGERS, STRUTS, BRACES, BRACKETS, ETC.
- WHERE RESILIENT BASE IS SPECIFIED (VINYL OR RUBBER) PROVIDE COVE PROFILE BASE AT ALL RESILIENT FLOORS AND STRAIGHT BASE FOR ALL CARPET AREAS (UNLESS OTHERWISE NOTED), HEIGHT AND COLOR TO BE AS INDICATED ON FINISH LEGEND.
- REFER TO REFLECTED CEILING PLANS AND SPECIFICATION MANUAL FOR ALL CEILING MATERIAL AND FINISH INFORMATION.
- ALL DRYWALL SOFFITS TO BE PAINTED FLAT CEILING WHITE UNLESS NOTED OTHERWISE ON CEILING PLANS.
- CERAMIC WALL TILE TO EXTEND FULL WIDTH AND FULL HEIGHT FOR ANY AND ALL SCHEDULED TILED WALLS (UNLESS NOTED OTHERWISE).
- FOR EPOXY OR INTUMESCENT PAINT COLOR REFER TO PAINT SCHEDULE NUMBERS.
- WITHIN FINISH SCHEDULE CELLS, SLASH MARKS INDICATE DIFFERENCES IN FINISH MATERIAL WHILE COMMAS INDICATE DIFFERENCES IN PATTERN OR COLOR WITHIN A SPECIFIC MATERIAL.
- APPROPRIATE METAL OR VINYL TRANSITION STRIPS MUST BE PROVIDED AT ALL FINISH MATERIAL FLOORING CHANGES. GENERAL CONTRACTOR TO SUBMIT SHOP DRAWINGS FOR ALL FLOORING TRANSITIONS AND AREAS IN WHICH FLOORING PATTERNS ARE SHOWN. SEE FLOOR FINISH PLANS, DETAILS AND NOTES FOR SPECIFIC INFORMATION.
- WALL PAINT INDICATED FOR CURTAIN WALL LOCATIONS APPLIES TO ALL ASSOCIATED DRYWALL COMPONENTS (CURBS, HEADERS, BULKHEADS, ETC.) AND SHOULD NOT BE INTERPRETED AS APPLYING TO CURTAIN WALL COMPONENTS OR GLASS.
- FLOORING CONTRACTOR(S) IS RESPONSIBLE FOR COORDINATING FINISHED FLOOR ELEVATIONS WITH ALL ANY FLOOR MOUNTED COMPONENTS (RECEPTACLES, ACCESS PANELS, ETC.) SO THAT COMPONENTS ARE INTEGRATED AND FLUSH.

KEYNOTE LEGEND

#	DATE	CHANGE DESCRIPTION


RENOVATION OF HEARTLAND BANK DUBLIN
 800 FRANTZ ROAD
 DUBLIN, OH 43017
 FOR
HEARTLAND BANK

MOODY•NOLAN
 300 SPRUCE STREET
 SUITE 300
 COLUMBUS, OHIO 43215
 PHONE: (614) 461-4664
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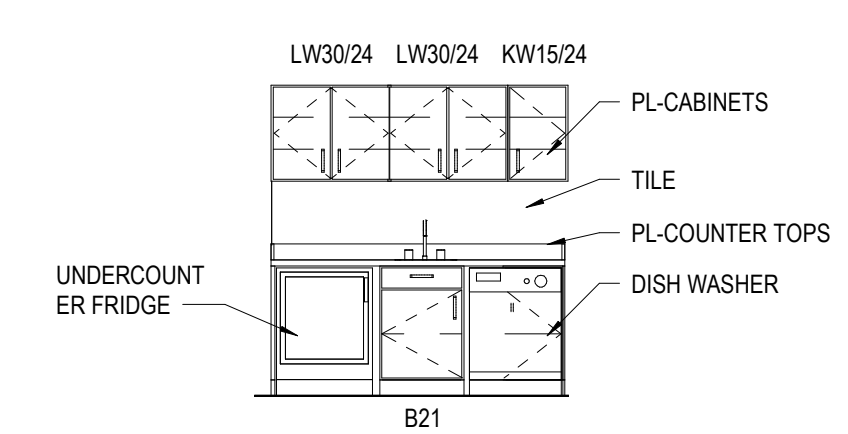
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FINISH LEGEND


PROGRESS DRAWING NOT FOR CONSTRUCTION	11/30/2020	
	DRAWN BY: xxx	CHECKED BY: xxx
	2022	
	A900	
FINAL DEVELOPMENT PLAN		



3 ELEVATION OFFICE
 1/4" = 1'-0" REF: 1 / A10

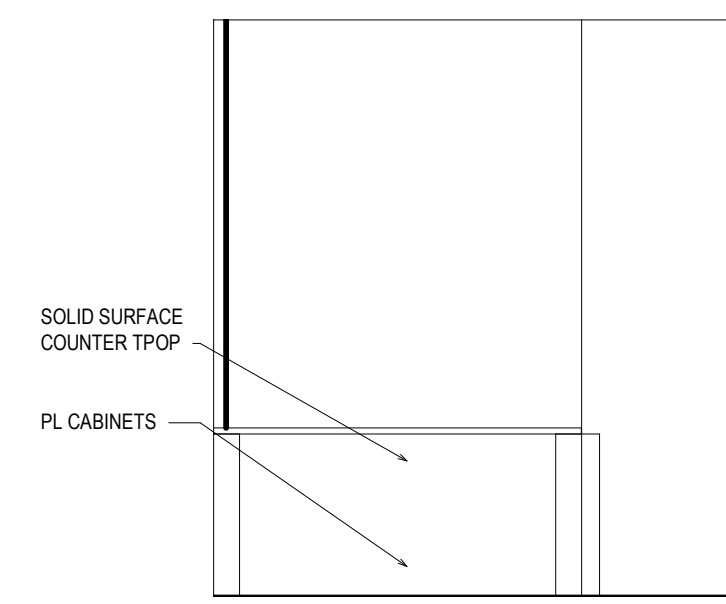

2 ELEVATION BREAKROOM
 1/4" = 1'-0" REF: 1 / A10

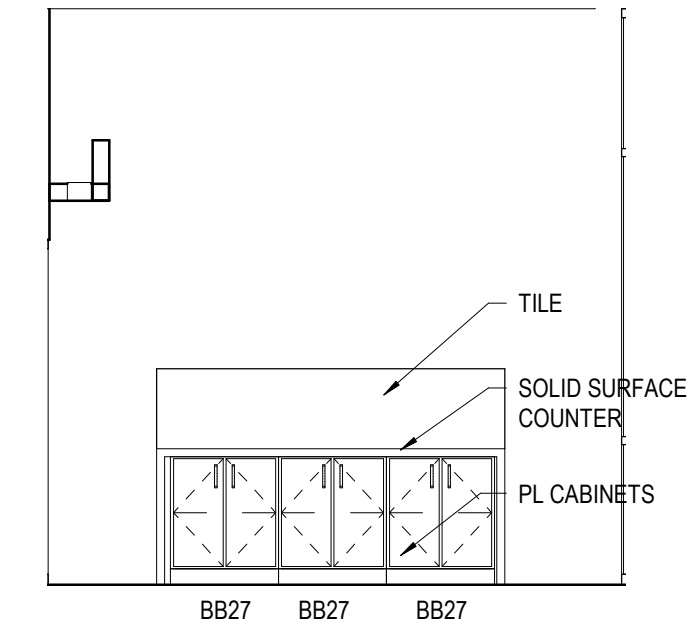

1 ELEVATION COFFEE BAR
 1/4" = 1'-0" REF: 1 / A10

#	DATE	CHANGE DESCRIPTION

RENOVATION OF HEARTLAND BANK DUBLIN
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 FOR
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DRAWING TITLE:
INTERIOR ELEVATIONS

PROGRESS DRAWING NOT FOR CONSTRUCTION	11/30/2020
	DRAWN BY: XXXX CHECKED BY: XXXX
	20022
A920	
FINAL DEVELOPMENT PLAN	


ABBREVIATIONS	
NOTE: NOT ALL ABBREVIATIONS MAY BE USED.	
(A)	EXISTING TO BE ABANDONED
(D)	EXISTING TO BE DEMOLISHED
(E)	EXISTING TO REMAIN
(F)	FUTURE
(R)	EXISTING TO BE RELOCATED
A	COMPRESSED AIR (SHOP AIR)
ABV	ABOVE
AE	ANESTHESIA EVACUATION
AFF	ABOVE FINISHED FLOOR
AMP	AMPERE
APPROX	APPROXIMATE
AR	ARGON
ARCH	ARCHITECT
AUTO	AUTOMATIC
AV	ACID VENT
AVG	AVERAGE
AW	ACID WASTE
BF	BELOW FLOOR
BFV	BUTTERFLY VALVE
BLDG	BUILDING
BOP	BOTTOM OF PIPE
BT	BATHTUB
CAP	CAPACITY
CFH	CUBIC FEET PER HOUR
CFM	CUBIC FEET PER MINUTE
CONN	CONNECTION OR CONNECT
CONT	CONTINUATION
CS	CLINIC SINK
CU IN	CUBIC INCH
D	DRAIN
DEPT	DEPARTMENT
DIA	DIAMETER
DI	DEIONIZED WATER
DN	DOWN
DW	DISTILLED WATER
DWG	DRAWING
E	EMERGENCY FIXTURE
EL	ELEVATION
EQUIP	EQUIPMENT
EWC	ELECTRIC WATER COOLER
EXH	EXHAUST
EXP	EXPANSION
EXIST	EXISTING
F	DEGREES FAHRENHEIT
FD	FLOOR DRAIN
FIN FL EL	FINISHED FLOOR ELEVATION
FOO	FUEL OIL DISCHARGE
FOF	FUEL OIL FILL
FOG	FUEL OIL GAUGE LINE
FOO	FUEL OIL OVER FLOW LINE
FOR	FUEL OIL RETURN
FOS	FUEL OIL SUPPLY
FOV	FUEL OIL TANK VENT
FT	FOOT OR FEET
GA	GAUGE
GAL	GALLONS
GPD	GALLONS PER DAY
GPH	GALLONS PER HOUR
GPM	GALLONS PER MINUTE
H	HYDROGEN
HD	HEAD
HE	HELIUM
HGT	HEIGHT
HP	HORSEPOWER
HVAC	HEATING, VENTILATING, AND AIR CONDITIONING
HZ	HERTZ

ABBREVIATIONS	
NOTE: NOT ALL ABBREVIATIONS MAY BE USED.	
IN	INCHES
INV EL	INVERT ELEVATION
IW	INDIRECT WASTE
KW	KILOWATT
L	LAVATORY
LB	POUNDS
LF	LINEAR FEET
LG	LENGTH
LN	LIQUID NITROGEN
LOX	LIQUID OXYGEN
MA	COMPRESSED AIR (MEDICAL GAS)
MAX	MAXIMUM
MECH	MECHANICAL
MFG	MANUFACTURER
MIN	MINIMUM
MS	MOP SINK
MV	VACUUM (MEDICAL GAS)
N2O	NITROUS OXIDE
N	NITROGEN
N/A	NOT APPLICABLE
NC	NORMALLY CLOSED
NIC	NOT IN CONTRACT
NO	NORMALLY OPEN
NO.	NUMBER
NPW	NON-POTABLE WATER
NTS	NOT TO SCALE
O	OXYGEN
OFCI	OWNER FURNISHED CONTRACTOR INSTALLED
OS&Y	OUTSIDE STEM AND YOKE VALVE
PD	PUMPED DISCHARGE
PLBG	PLUMBING
PPM	PARTS PER MILLION
PR	FUEL POLISH RETURN
PRESS	PRESSURE
PRV	PRESSURE REDUCING VALVE
PS	FUEL POLISH SUPPLY
PSI	POUNDS PER SQUARE INCH
PSIG	PSI GAUGE
RCP	RECIRCULATING PUMP
RD	ROOF DRAIN
RPBP	REDUCED PRESSURE BACKFLOW PREVENTER
RPM	REVOLUTIONS PER MINUTE
RO	REVERSE OSMOSIS WATER
S	SINK
SEC	SECOND
SH	SHOWER
SHT	SHEET
SPEC	SPECIFICATION
SRD	SECONDARY ROOF DRAIN
STSTL	STAINLESS STEEL
STD	STANDARD
STR	STRAINER
SW	SOFT POTABLE WATER
TE	TOP ELEVATION
TEMP	TEMPERATURE
TMV	THERMOSTATIC MIXING VALVE
TOP	TOP OF PIPE
TWS	TEMPERED WATER SUPPLY
TYP	TYPICAL
UNO	UNLESS NOTED OTHERWISE
UR	URINAL
V	VOLTVENT
VB	VACUUM BREAKER
VTR	VENT THRU ROOF
W	WATER
WC	WATER CLOSET
WF	WASH FOUNTAIN


SYMBOLS LIST	
PIPING	
EXISTING TO REMAIN	(E)
EXISTING TO BE DEMOLISHED	(D)
DOMESTIC HOT WATER	HW
DOMESTIC COLD WATER	CW
SANITARY	SAN
VENT	V
NATURAL GAS	G

DESCRIPTION	2D SYMBOL	3D SYMBOL	
		PLAN VIEW	SECTION VIEW
DROP	—○		
RISE	—○		
TEE	—○		
CAP	—J		
GLOBE VALVE	⊗	⊗	⊗
PLUG VALVE	⊗	⊗	⊗
SOLENOID VALVE	⊗	⊗	⊗
GAS PRESSURE REGULATOR	⊗	⊗	⊗
PRESSURE REDUCING VALVE	⊗	⊗	⊗
OUTSIDE STEM & YOKE VALVE	⊗	⊗	⊗
BUTTERFLY VALVE	⊗	⊗	⊗
BALL VALVE	⊗	⊗	⊗
CHECK VALVE	⊗	⊗	⊗
BALANCE VALVE	⊗	⊗	⊗
STRAINER	⊗	⊗	⊗
UNION	⊗	⊗	⊗
TEMPERATURE & PRESSURE RELIEF VALVE	⊗	⊗	⊗
METER	⊗	⊗	⊗
AQUASTAT	⊗	⊗	⊗
THERMOMETER	⊗	⊗	⊗
PRESSURE GAUGE WITH STOPCOCK	⊗	⊗	⊗
REDUCED PRESSURE BACKFLOW PREVENTER	⊗	⊗	⊗
PUMP	⊗	⊗	⊗
WALL HYDRANT	⊗	⊗	⊗
HOSE BIBB	⊗	⊗	⊗
CLEANOUT	⊗	⊗	⊗
CLEANOUT AT FLOOR OR AT GRADE	⊗	⊗	⊗
FLOOR OR AREA DRAIN	⊗	⊗	⊗
ROOF DRAIN	⊗	⊗	⊗
DOWNSPOUT NOZZLE	⊗	⊗	⊗

- GENERAL NOTES:
- PROVIDE NEW DOMESTIC WATER, SANITARY WASTE, STORM DRAINAGE, NATURAL GAS FOR THIS BUILDING. PROVIDE ALL NECESSARY COMPONENTS FOR FULLY OPERATIONAL SYSTEM. INSTALL SYSTEMS IN ACCORDANCE WITH STATE REQUIREMENTS AND LOCAL AUTHORITY HAVING JURISDICTION COORDINATE THE LOCATION OF ALL UTILITY CONNECTION POINTS, FLOOR DRAINS AND HUB DRAINS FOR EQUIPMENT WITH OTHER TRADES.
 - ALL FLOOR PENETRATIONS TO BE SEALED WATER TIGHT AND COMPLETELY PACKED WITH FIRE STOP MATERIAL BY TRADE CONTRACTORS.
 - THESE DRAWINGS ARE DIAGRAMMATIC IN NATURE AND ARE NOT INTENDED TO SHOW THE EXACT LOCATIONS OF COMPONENTS. NOR SHOW ALL SYSTEM COMPONENTS. CONTRACTOR SHALL PROVIDE ADDITIONAL OFFSETS OR FITTINGS REQUIRED FOR PROPER INSTALLATION, COORDINATION WITH OTHER TRADES, AND/OR TO MAINTAIN PROPER CLEARANCES.
 - DRAWINGS ARE NOT TO BE SCALED. DIMENSIONS SHALL GOVERN. CONTRACTOR SHALL VERIFY ALL DIMENSIONS AND CONDITIONS AT THE JOB SITE CONCERNING EXISTING AND NEW WORK BEFORE PROCEEDING WITH EITHER FABRICATION OR INSTALLATION IN MECHANICAL AREAS WITH NUMEROUS OBSTRUCTIONS INCLUDING DUCTWORK, EQUIPMENT AND PIPING. THIS WILL REQUIRE ON SITE CUTTING AND VERIFICATION.
 - ANY INFORMATION CONFLICTS BETWEEN THE SPECIFICATIONS AND DRAWINGS SHALL BE BROUGHT TO THE ENGINEER'S ATTENTION. THE CONTRACTOR(S) SHALL NOT PROCEED WITH ANY WORK, EXCEPT AT THEIR OWN RISK, UNTIL CLARIFICATIONS OF THE CONFLICTS ARE ISSUED TO THE CONTRACTOR(S) BY THE ENGINEER.
 - ALL MATERIAL AND LABOR SHALL BE UNDER WARRANTY FOR ONE YEAR FROM THE DATE OF FINAL ACCEPTANCE BY THE OWNER. ANY NEW DEVICES OR EQUIPMENT FOUND FAULTY SHALL BE REPLACED AS PART OF THE WARRANTY. A SET OF APPROVED DRAWINGS SHALL BE MAINTAINED ON SITE AND ALL FIELD CHANGES SHALL BE RED LINED ON THE DRAWINGS. CONTRACTOR SHALL PREPARE "AS-BUILT" DRAWINGS IN ELECTRONIC (AUTOCAD) FORMAT, REFLECTING ACCURATE FIELD CONDITIONS.
 - ALL PENETRATIONS THROUGH FIRE RESISTANCE RATED CONSTRUCTION SHALL BE PROVIDED A UL LISTED THROUGH PENETRATION FIRESTOP ASSEMBLY. THE RATINGS OF ALL FIRESTOP ASSEMBLIES SHALL BE GREATER THAN OR EQUAL TO THE RATING OF THE PENETRATED BARRIER.
 - CORE DRILL PENETRATIONS IN CONCRETE FLOORS OR WALLS 1-2 INCHES LARGER THAN THE PIPE DIAMETER OF THE PENETRATING PIPE.
 - DUCTWORK, PIPING, MECHANICAL EQUIPMENT AND CEILINGS SHALL NOT BE USED AS LADDERS, SCAFFOLDING OR WORK PLATFORMS.
 - NO STRUCTURAL MEMBERS SHALL BE CUT, DRILLED, OR BURNED WITHOUT THE KNOWLEDGE AND WRITTEN APPROVAL OF THE OWNER.
 - EQUIPMENT, MATERIALS, INSTALLATION WORKMANSHIP, EXAMINATION AND TESTING SHALL BE IN ACCORDANCE WITH CURRENT PLUMBING CODE. INSTALL PIPING STRAIGHT AND TRUE TO BEARS EVENLY ON HANGARS AND SUPPORTS. PIPE SHALL NOT INTERFERE WITH OTHER EQUIPMENT AND CONSTRUCTION.
 - CONTRACTOR SHALL BE RESPONSIBLE FOR AVOIDING ALL CONFLICTS WITH LIGHTING FIXTURES, DIFFUSERS, GRILLES, DUCTS, STRUCTURAL MEMBERS, MECHANICAL EQUIPMENT AND PIPES.
 - NO FABRICATION OR INSTALLATION IS ALLOWED WITHOUT APPROVED SHOP DRAWING SUBMITTALS.
 - CONTRACTOR SHALL SUBMIT SYSTEM CATALOG PRODUCT DATA SHEETS OF ALL COMPONENTS PROPOSED FOR USE PRIOR TO INSTALLATION FOR APPROVAL. SHOP DRAWINGS SHALL BE SUBMITTED FOR APPROVAL.
 - ALL MATERIALS AND EQUIPMENT SHALL BE NEW.
 - PIPING SHALL NOT SHARE SUPPORTS WITH OTHER BUILDING SYSTEMS. IN MECHANICAL AREAS, PIPING SHALL NOT BE ATTACHED TO THE DUCT WORK. STANCHIONS SHALL BE USED WHERE PIPING IS UNABLE TO BE HUNG FROM ABOVE.
 - PIPING IN AREAS WITH FINISHED CEILINGS SHALL BE INSTALLED ABOVE FINISHED CEILINGS.
 - CONTRACTOR SHALL PROVIDE LABELS (WITH FLOW ARROWS) FOR ALL PIPING.
 - PIPING SHALL NOT BE INSTALLED PASSING THROUGH ELECTRICAL ROOMS OR OVER ELECTRICAL PANELS/EQUIPMENT WHICH SERVES OTHER AREAS. COORDINATE THE LOCATION OF ALL PIPING WITH ELECTRICAL EQUIPMENT AND OTHER TRADES AND ADJUST AS NECESSARY.
 - MAKE REASONABLE AND NECESSARY MODIFICATIONS IN LAYOUTS AND COMPONENTS NEEDED TO PREVENT CONFLICTS WITH WORK OF OTHER TRADES AND TO COORDINATE IN ACCORDANCE WITH SPECIFICATIONS.
 - MAINTAIN MAXIMUM HEADROOM AT ALL LOCATIONS. ALL PIPING TO BE AS TIGHT TO THE UNDERSIDE OF DECK AS POSSIBLE. ALL EXPOSED PIPING SHALL BE APPROVED BY ARCHITECT AND SHALL MAINTAIN REQUIRED CLEARANCES.

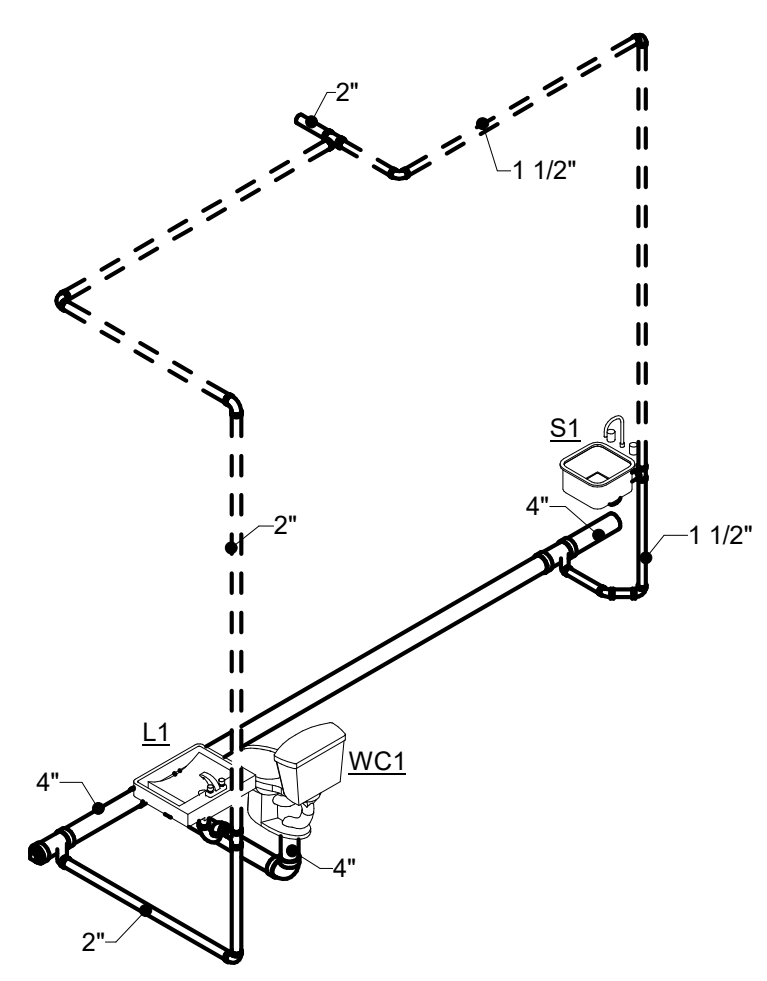

1 DETAIL DIAGRAM - STACK A

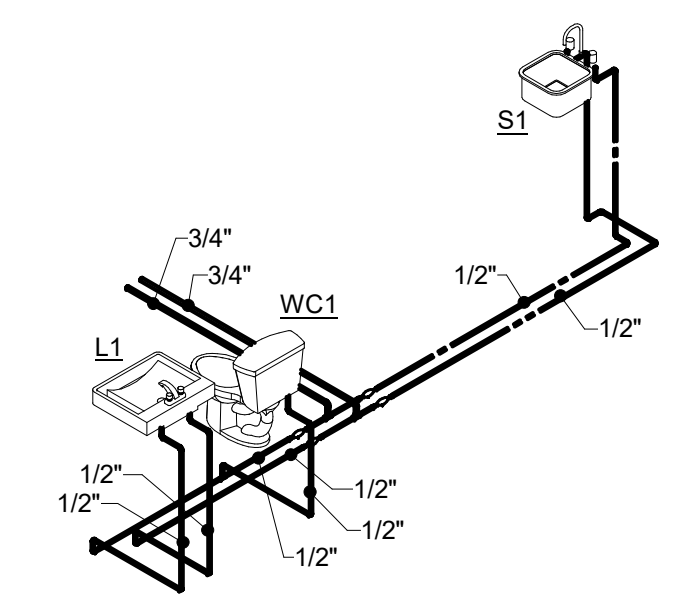

2 DETAIL DIAGRAM - RISER 1

PLUMBING FIXTURE SCHEDULE			
TAG	FIXTURE DESCRIPTION	MANUFACTURER	MODEL #
WC1	WATER CLOSET - VITREOUS CHINA, CLOSE-COUPLED TANK, PRESSURE ASSISTED, ELONGATED BOWL, LOW-CONSUMPTION 1.6 GPF, .JET FLUSH ACTION, FULLY-GLAZED 2-1/8" TRAPWAY, 10"x12" WATER, SURFACE AREA, MEETS ASME FLUSH REQUIREMENTS AT 1.6 GPF.	AMERICAN STANDARD	2462.016
L1	SEAT: HEAVY WEIGHT AND INJECTION-MOLDED OF SOLID PLASTIC, OPEN FRONT LESS COVER FOR ELONGATED BOWL AND FEATURE EXCLUSIVE, FOUR LARGE MOLDED-IN BUMPERS, CONCEALED CHECK HINGES WITH STAINLESS STEEL POSTS. LAVATORY: 20-1/2" X 18-1/4", VITREOUS CHINA, WALL HUNG, FRONT OVERFLOW, SELF-DRAINING DECK AREA WITH CONTOURED BACK AND SIDE SPLASH SHIELDS, FAUCET LEDGE, FAUCET HOLES ON 4" CENTERS, CONCEALED ARMS SUPPORT. FAUCET: DECK MOUNTED FAUCET WITH 8" INTEGRAL SPOUT, POLISHED CHROME PLATED FINISH, SOLID BRASS BODY CONSTRUCTION, 0.5 GPM PRESSURE COMPENSATING AERATOR OUTLET, LEVER HANDLES, SECURED COLOR CODED INDEX BUTTONS, 4" CENTERS. TRIM: SUPPLY PIPE WITH LOOSE KEY STOPS, CAST BRASS P-TRAP WITH CLEAN-OUT, DRAIN WITH CHROME PLATED CAST BRASS SOLID TOP, OPEN GRID, P.O. PLUG, CHROME PLATED BRASS 17 GAUGE TAILPIECE. THERMOSTATIC MIXING VALVE: LEAD-FREE DESIGN, WAX-FILLED THERMOSTAT, ADJUSTABLE SET POINT WITHIN TEMPERATURE RANGE, UNIVERSAL MOUNTING CAPABILITY, INTEGRAL CHECK VALVES AND STRAINER, ASSE 1070 COMPLIANT, SET TO 110°F. CARRIER: LAVATORY SUPPORT WITH CONCEALED ARMS, RECTANGULAR STEEL UPRIGHTS WITH WELDED FEET, CAST IRON ADJUSTABLE HEADERS, CONCEALED ARMS, STEEL SLEEVE, ALIGNMENT TRUSS AND MOUNTING FASTENERS.	CHURCH AMERICAN STANDARD	295CT 0355.012
S1	SINK: SINGLE BOWL, #18 GAUGE, TYPE 304 NICKEL BEARING STAINLESS STEEL, UNDERCOUNTER MOUNTED, 1.34" VERTICAL AND HORIZONTAL RADIUS, BOWL FULLY UNDERCOATED TO DAMPEN SOUND AND PREVENT CONDENSATION, 3-1/2" DRAIN OPENING. FAUCET: DECK MOUNTED 4" WIDESPREAD FAUCET, POLISHED CHROME PLATED FINISH, SOLID BRASS BODY CONSTRUCTION, 8" SWING SPOUT, 0.5 GPM PRESSURE COMPENSATING AERATOR OUTLET, LEVER HANDLES AND SECURED COLOR CODED INDEX BUTTONS. DRAIN WITH NICKEL PLATED BRASS BODY WITH GRID STRAINER, POLISHED FINISH. TRIM: SUPPLY PIPE WITH LOOSE KEY STOPS, CAST BRASS P-TRAP WITH CLEAN-OUT, P.O. PLUG, CHROME PLATED BRASS 17 GAUGE TAILPIECE.	CHICAGO ELKAY MCGUIRE	802-KXBCP 165LK_8902_149 559-4000 SERIES Z1200 ELUH1316 895-LBABC LK18 165LK_8912

PUMP SCHEDULE								
TAG	ELECTRIC			GPM	FEET OF HEAD	MANUFACTURER	MODEL #	NOTES
	VOLT	PHASE	HP					
SE1	120	1	1	20	40	ZOELLER	N270	DUPLX SYSTEM
SP1	120	1	1	20	40	ZOELLER	N270	DUPLX SYSTEM

WATER HAMMER ARRESTOR SCHEDULE			
TAG	INLET PIPE SIZE	FIXTURE UNIT RATING	REMARKS
A	3/4"	1 - 11	PDI CERTIFIED
B	1"	12 - 32	PDI CERTIFIED
C	1"	33 - 60	PDI CERTIFIED
D	1"	61 - 113	PDI CERTIFIED
E	1"	114 - 154	PDI CERTIFIED
F	1"	155 - 330	PDI CERTIFIED

NOTES:
1. INSTALL ARRESTOR IN UPRIGHT POSITION BEFORE LAST FLUSH VALVED FIXTURE AND ON MAIN COLD WATER PIPE HEADER.
2. INSTALL SHUT-OFF VALVE BEFORE ARRESTOR.

PLUMBING FIXTURE ROUGH-IN SCHEDULE						
FIXTURE	WASTE	TRAP	VENT	COLD	HOT	
WC1	4"	INTEGRAL	2"	1"	NA	
L1	1-1/2"	1-1/4"x1-1/2"	1-1/2"	1/2"	1/2"	
S1	1-1/2"	1-1/2"x1-1/2"	1-1/2"	1/2"	1/2"	

#	DATE	CHANGE DESCRIPTION

RENOVATION OF HEARTLAND BANK DUBLIN
6500 FRANTZ ROAD
DUBLIN, OH 43017
FOR
HEARTLAND BANK

300 SPRUCE STREET
SUITE 300
COLUMBUS, OHIO 43215
PHONE: (614) 461-4664
FAX: (614) 280-8881

MOODY-NOLAN

DRAWING TITLE:
GENERAL INFORMATION - PLUMBING


11/30/2020
DRAWN BY: Author CHECKED BY: Checker
20022

PROGRESS DRAWING NOT FOR CONSTRUCTION

P-001

FINAL DEVELOPMENT PLAN

- CODED NOTES:**
- EXISTING SINK, FAUCET, TRIM AND ASSOCIATED PIPING TO BE REMOVED. EXISTING HOT & COLD WATER AND SANITARY TO BE CAPPED IN WALL.
 - EXISTING LAVATORY, FAUCET, TRIM AND ASSOCIATED PIPING TO BE REMOVED. EXISTING HOT & COLD WATER, SANITARY AND VENT PIPING BE REMOVED BACK INTO CHASE.
 - EXISTING SINK, FAUCET, TRIM AND ASSOCIATED PIPING TO BE REMOVED. EXISTING HOT & COLD WATER, SANITARY AND VENT PIPING BE REMOVED BACK INTO CHASE.
 - EXISTING WATER CLOSET, TRIM AND ASSOCIATED PIPING TO BE REMOVED. EXISTING HOT & COLD WATER AND VENT PIPING BE REMOVED BACK INTO CHASE. EXISTING SANITARY PIPING TO BE REMOVED TO FLOOR BELOW.
 - EXISTING HOT & COLD WATER AND SANITARY PIPING TO BE REMOVED TO FLOOR BELOW. EXISTING VENT PIPING TO BE REMOVED TO VENT THROUGH ROOF. EXISTING VENT THROUGH ROOF TO REMAIN.
 - EXISTING 40 GALLON GAS-FIRED WATER HEATER TO REMAIN.
 - EXISTING SEWAGE EJECTOR PUMPS, CONTROLS AND LID TO BE REMOVED. EXISTING BASIN TO REMAIN. EXISTING PIPING TO REMAIN.
 - EXISTING SUMP PUMPS, CONTROLS AND LID TO BE REMOVED. EXISTING BASIN TO REMAIN. EXISTING PIPING TO REMAIN.
 - EXISTING ACCUMULATOR TANK AND ASSOCIATED PIPING TO BE REMOVED.
 - EXISTING BOILER BEING REMOVED. DISCONNECT EXISTING GAS LINE AND PROVIDE TEMPORARY CAP.

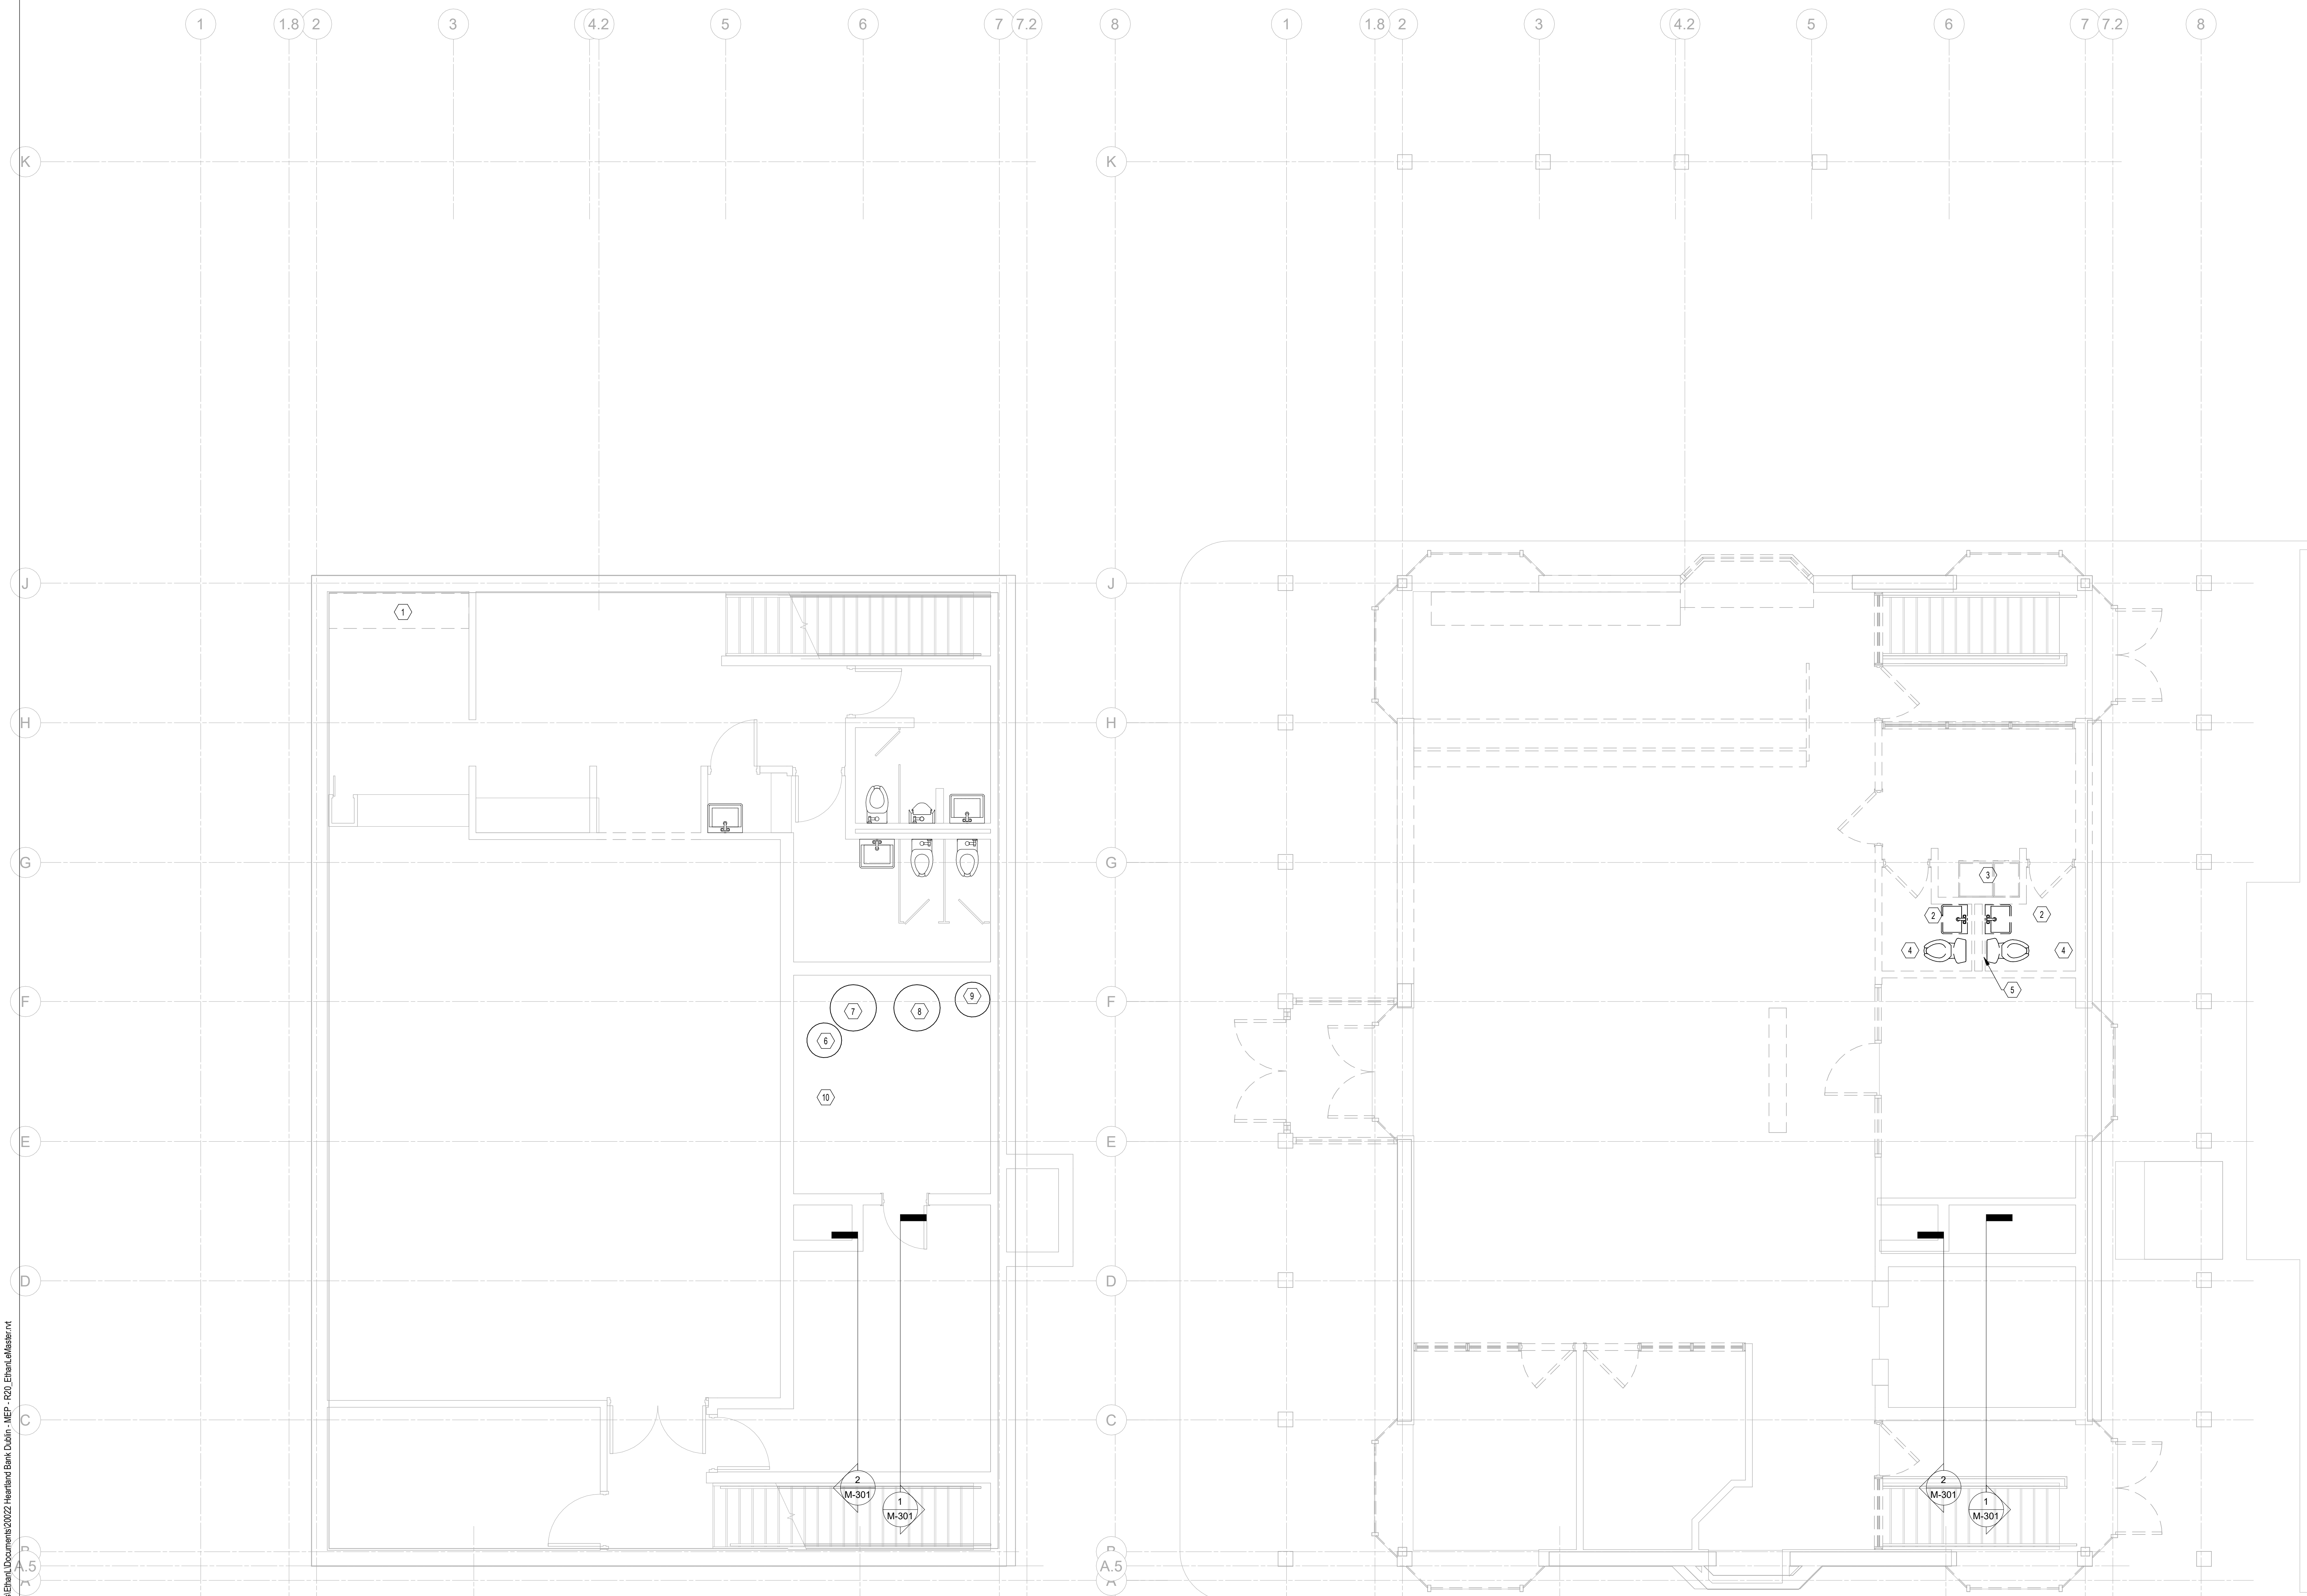

1 PLAN BASEMENT FLOOR PLAN - PLUMBING - DEMOLITION
 1/4" = 1'-0"

2 PLAN FIRST FLOOR PLAN - PLUMBING - DEMOLITION
 1/4" = 1'-0"

#	DATE	CHANGE DESCRIPTION


RENOVATION OF HEARTLAND BANK DUBLIN
 6500 FRANTZ ROAD
 DUBLIN, OH 43017
 FOR
HEARTLAND BANK

MOODY-NOLAN
 300 SPRUCE STREET
 SUITE 300
 COLUMBUS, OHIO 43215
 PHONE: (614) 461-4664
 FAX: (614) 280-8881

DRAWING TITLE:
FLOOR PLANS - PLUMBING - DEMOLITION

PROGRESS DRAWING NOT FOR CONSTRUCTION	11/30/2020
	DRAWN BY: Author CHECKED BY: Checker
	20022
PD101	
FINAL DEVELOPMENT PLAN	

- CODED NOTES:**
- EXISTING 40 GALLON GAS-FIRED WATER HEATER TO REMAIN.
 - CONNECT 3/4" HW, 3/4" CW AND 1" G TO EXISTING TO EXISTING 3/4" HW, 3/4" CW AND GAS IN THIS AREA.
 - CONNECT 3" PUMP DISCHARGE TO EXISTING SANITARY PIPING.
 - CONNECT 3" PUMP DISCHARGE TO EXISTING STORM PIPING.
 - CONNECT 4" SAN TO EXISTING 4" SAN IN THIS AREA.
 - CONNECT 3/4" G TO HVAC EQUIPMENT. PROVIDE SHUT-OFF AND DIRT LEG. MAKE FINAL CONNECTION.
 - CONNECT 2" V TO EXISTING VENT IN THIS AREA.
 - EXTEND 1/2" HW FROM SINK SUPPLY TO DISHWASHER. EXTEND DRAIN FROM DISHWASHER TO CONNECTION ABOVE SINK TRAP. MAKE FINAL CONNECTION.

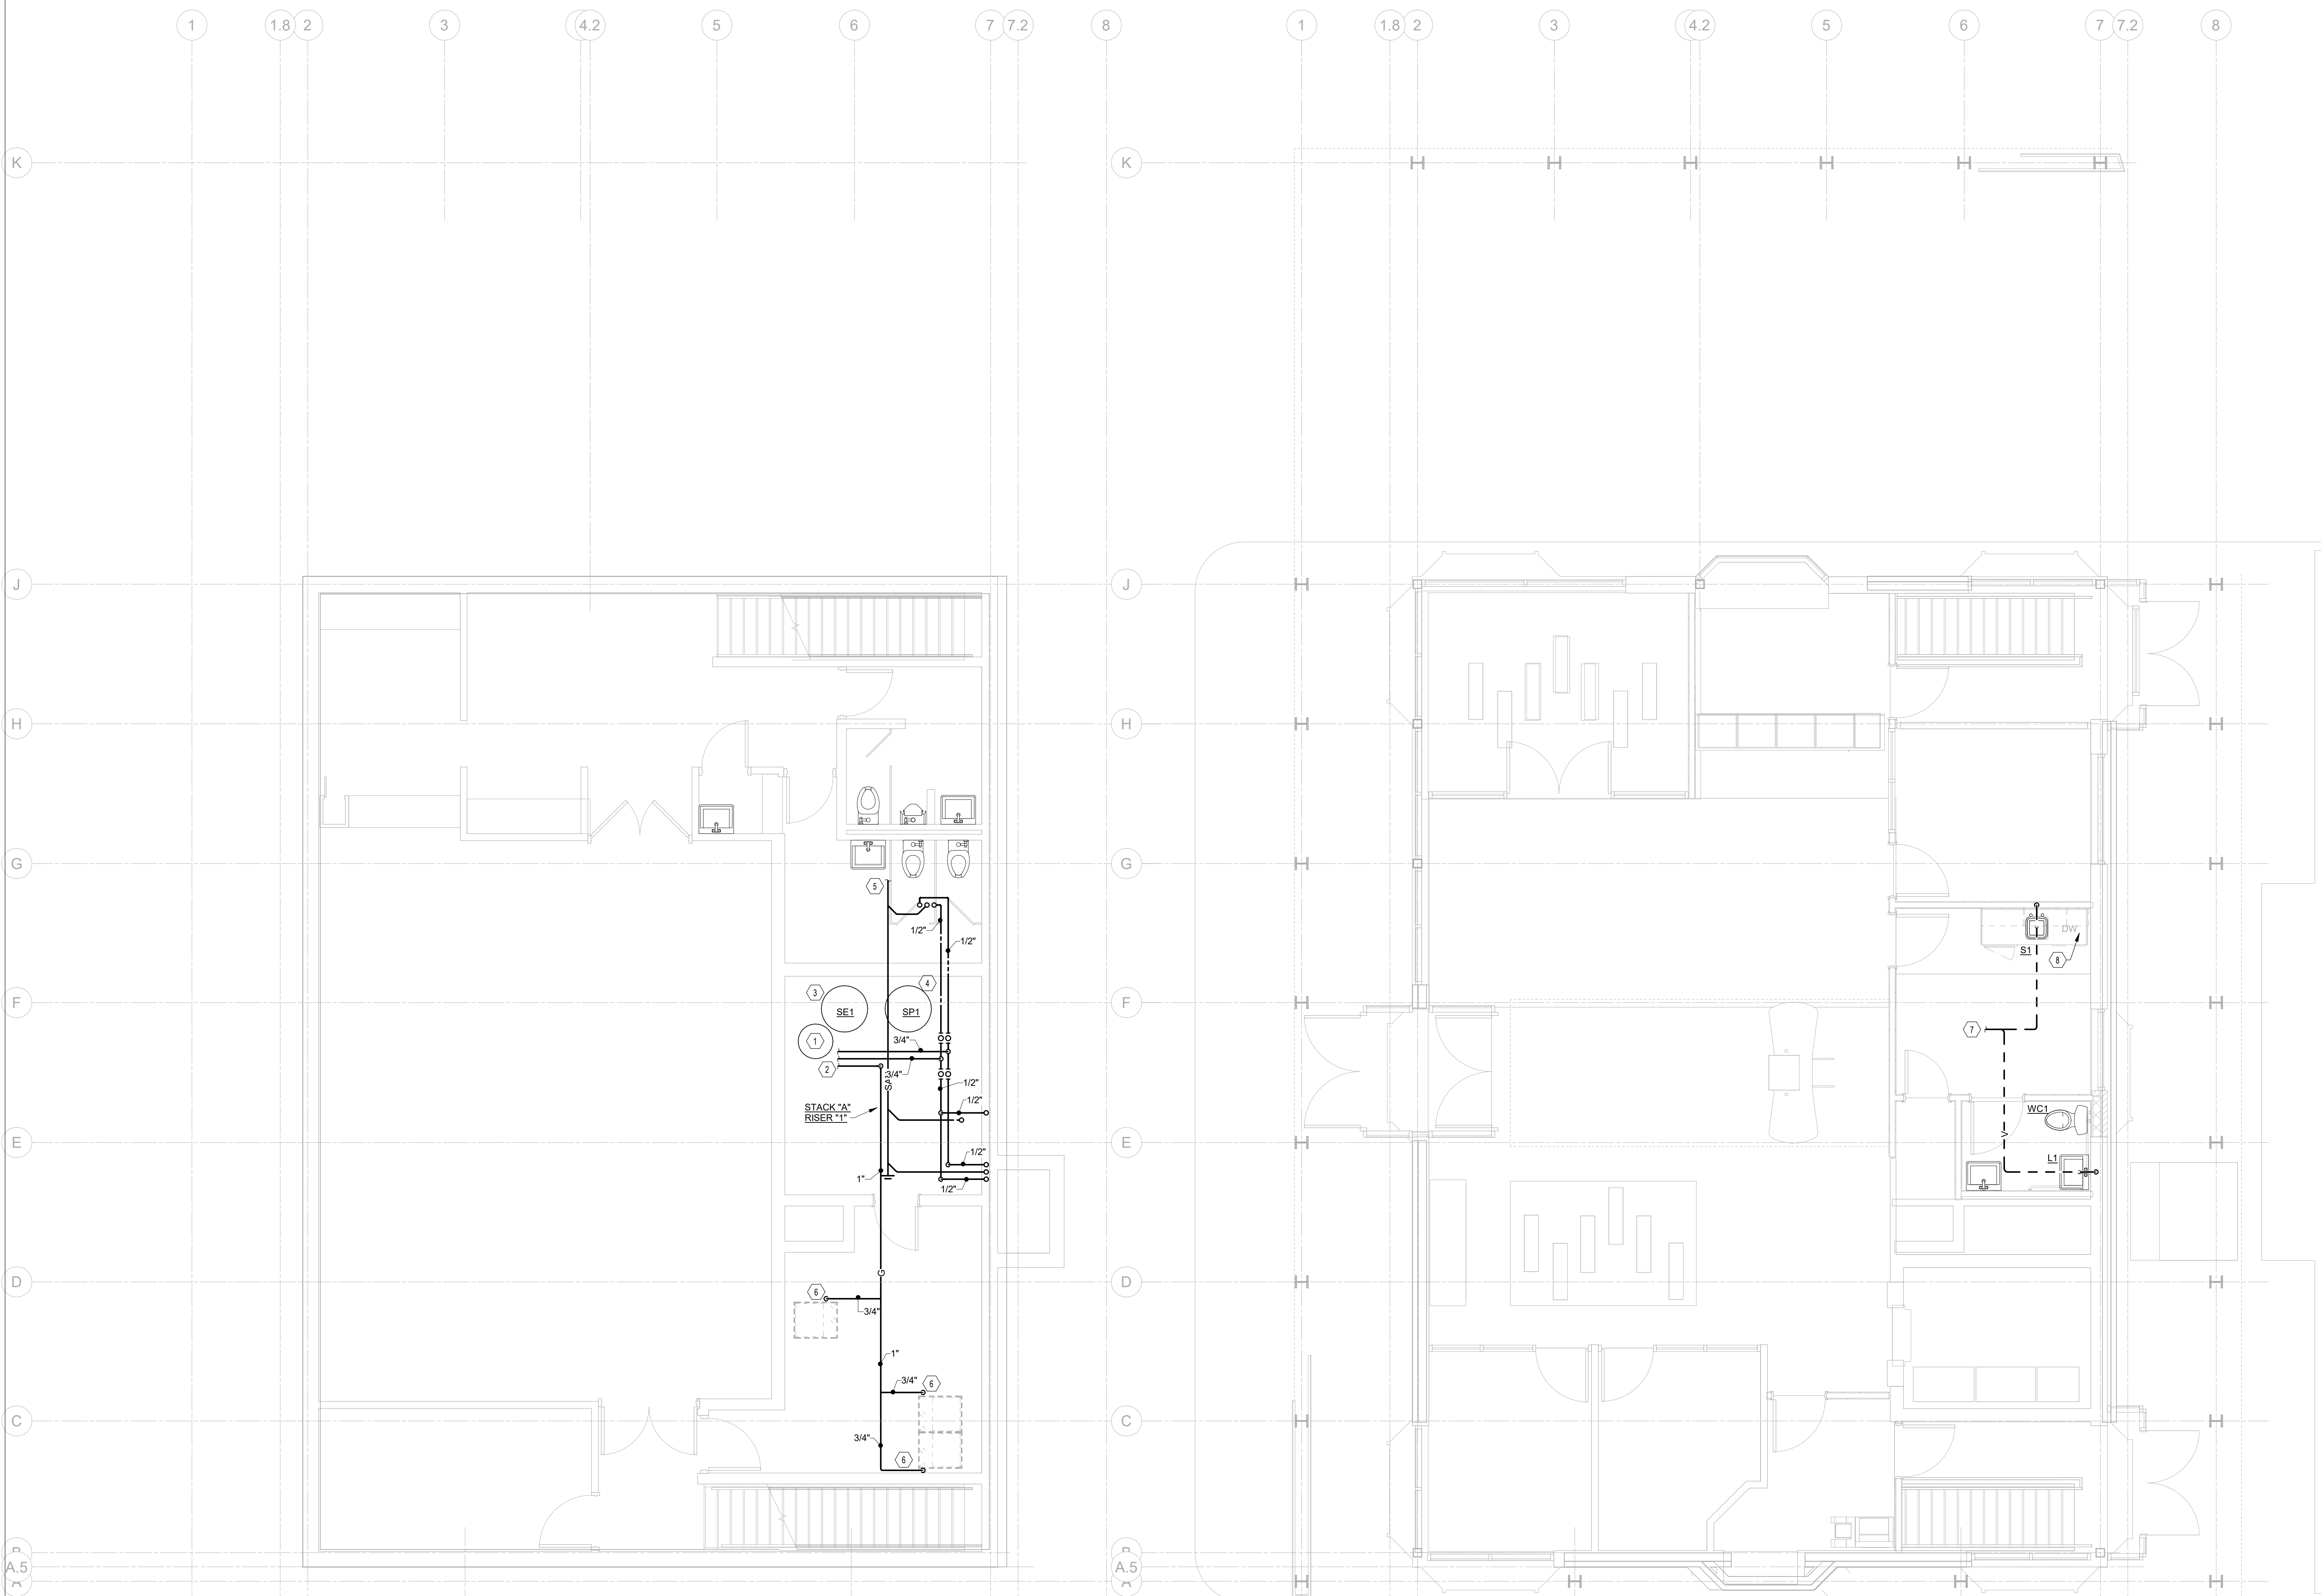

1 PLAN BASEMENT FLOOR PLAN - PLUMBING
1/4" = 1'-0"

2 PLAN FIRST FLOOR PLAN - PLUMBING
1/4" = 1'-0"


#	DATE	CHANGE DESCRIPTION

RENOVATION OF HEARTLAND BANK DUBLIN
6500 FRANTZ ROAD
DUBLIN, OH 43017
FOR
HEARTLAND BANK


MOODY-NOLAN
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FLOOR PLANS - PLUMBING

PROGRESS DRAWING NOT FOR CONSTRUCTION	11/30/2020
	DRAWN BY: Author CHECKED BY: Checker
	20022
P-101	
FINAL DEVELOPMENT PLAN	

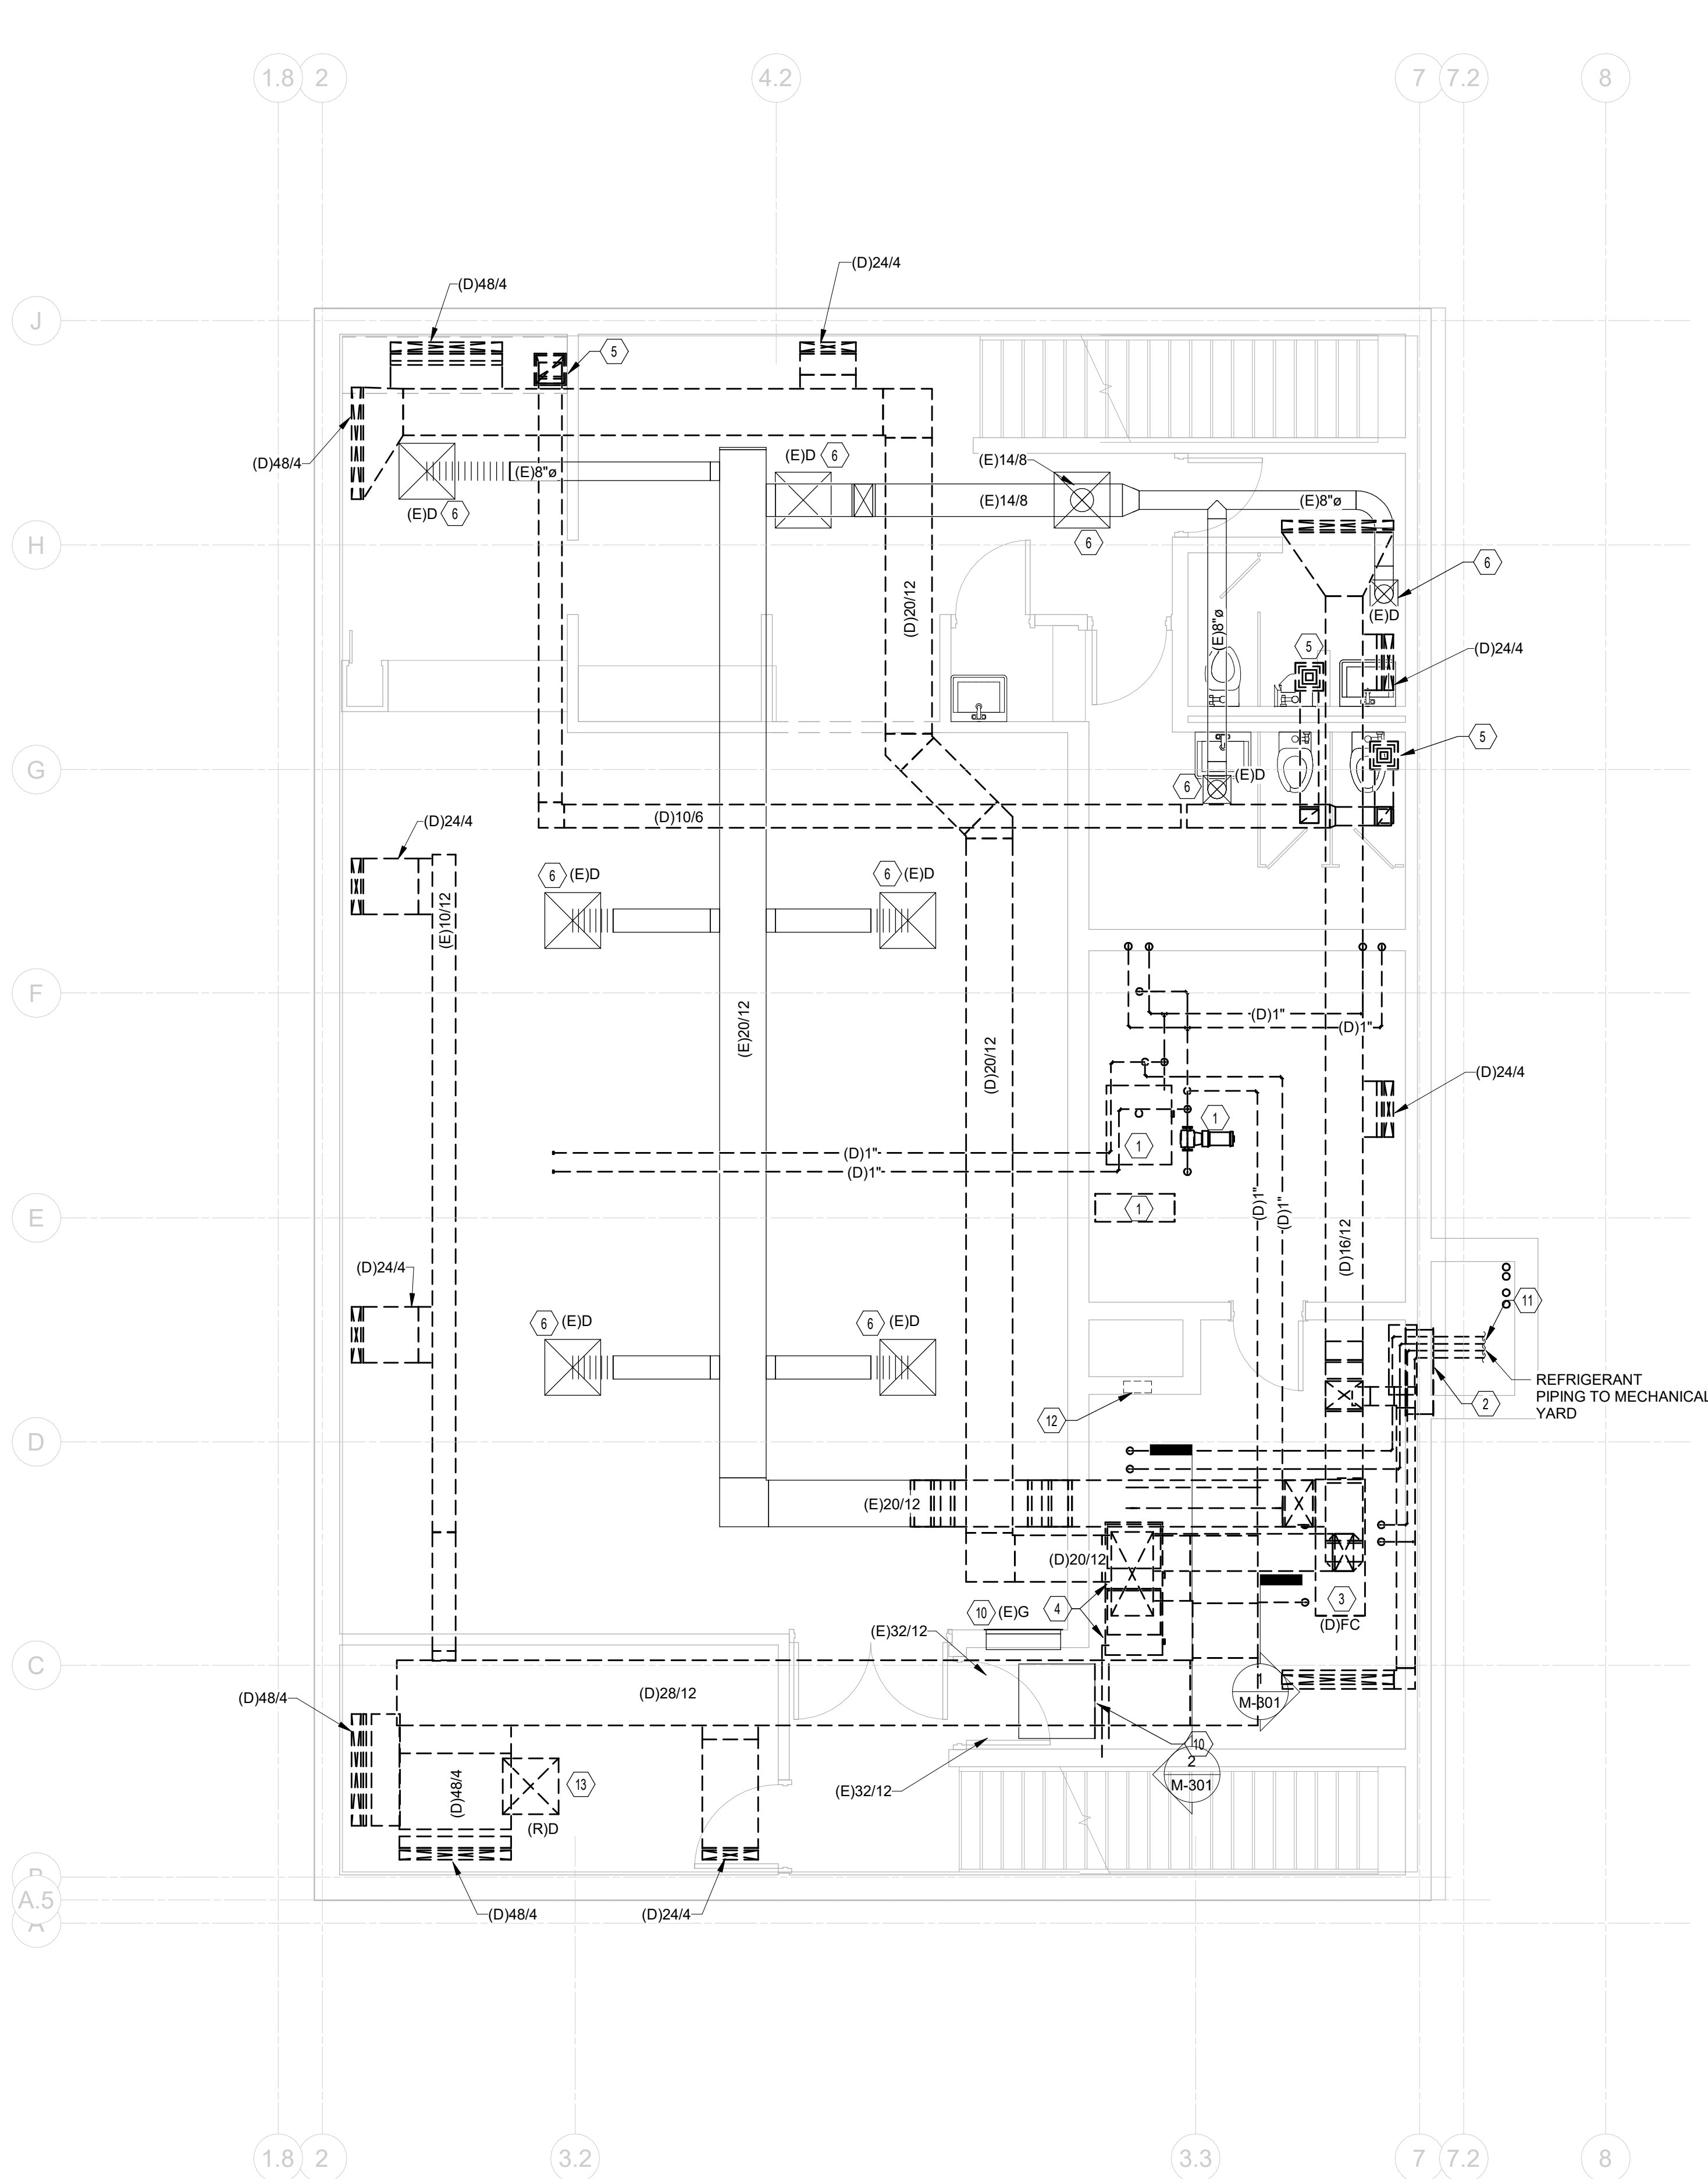

1 PLAN BASEMENT FLOOR PLAN - MECHANICAL - DEMOLITION
1/4" = 1'-0"

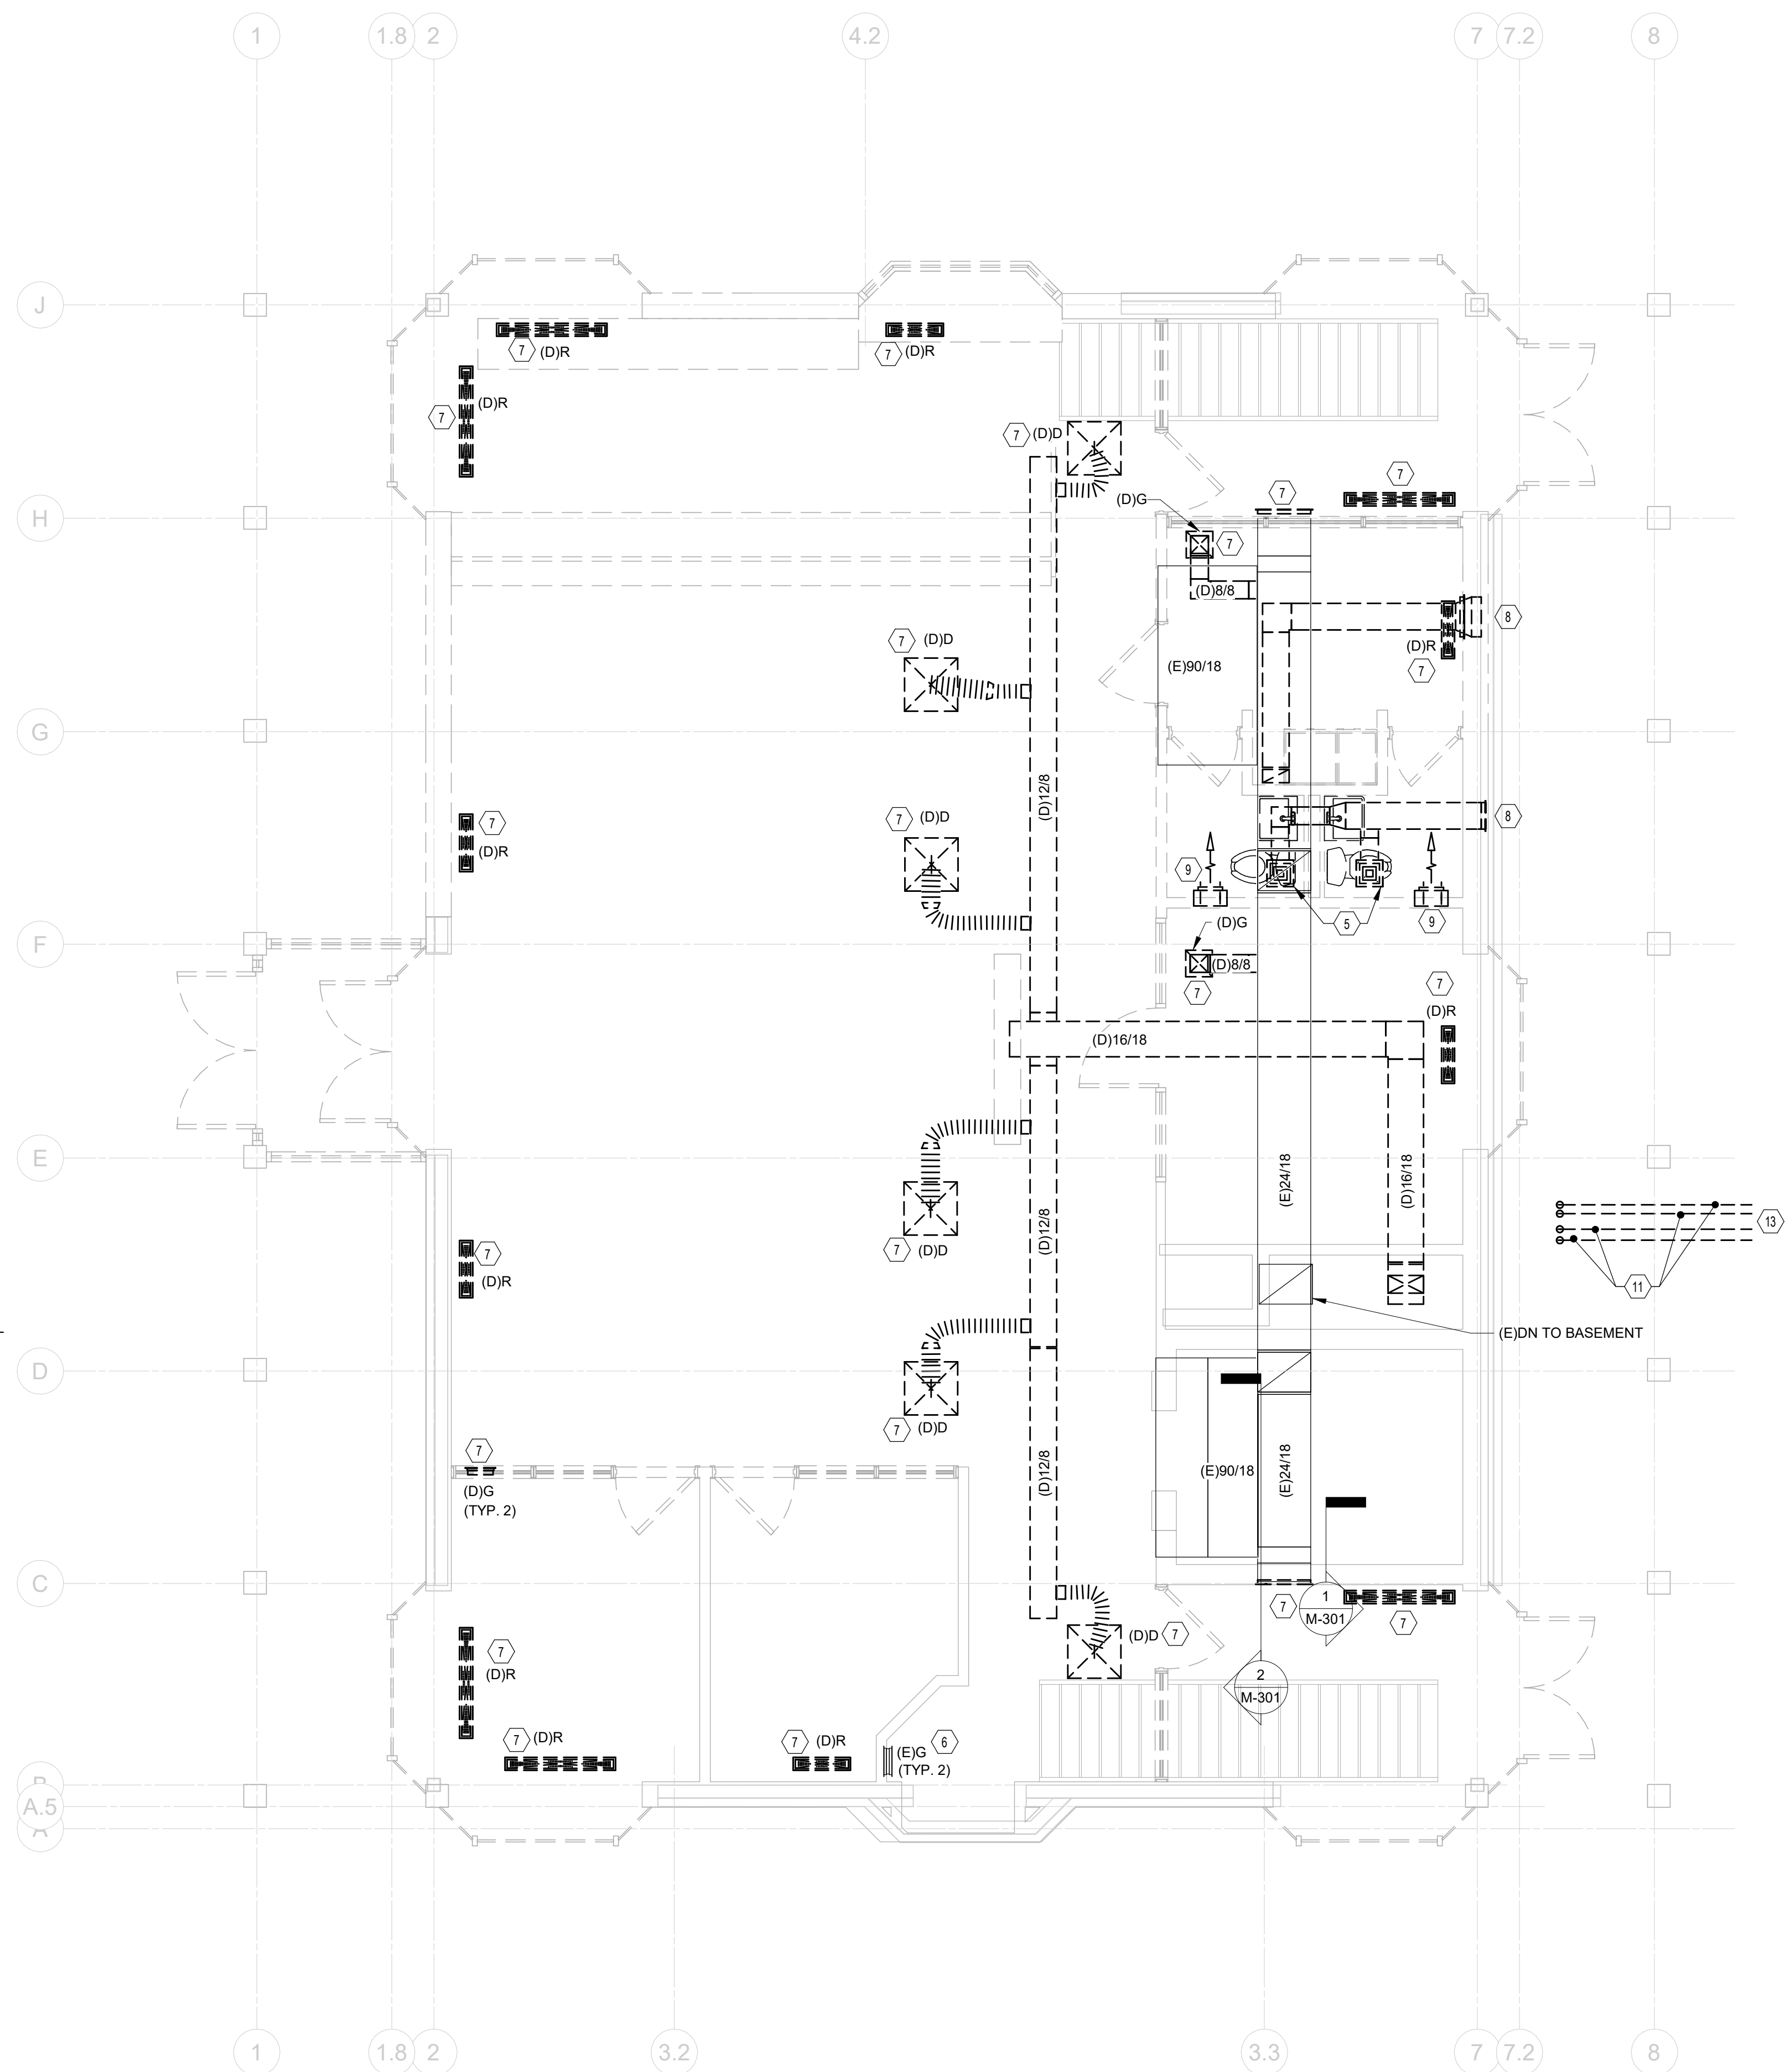

2 PLAN FIRST FLOOR PLAN - MECHANICAL - DEMOLITION
1/4" = 1'-0"

CODED NOTES:

1. DEMOLISH EXISTING BOILER, ASSOCIATED PIPING, IN-LINE PUMP, EXPANSION TANK AND ALL APPURTENANCES COMPLETE.
2. DEMOLISH 6' H X 3' W OUTSIDE AIR LOUVER, DAMPER, AND ASSOCIATED DUCTWORK.
3. DEMOLISH EXISTING FAN COIL UNITS, SUPPORTS, AND ALL APPURTENANCES COMPLETE.
4. EXISTING TWINNED-FURNACES AND ASSOCIATED EVAPORATOR COILS TO BE REMOVED AND SALVAGED. RETURN TO OWNER.
5. DEMOLISH EXISTING RESTROOM CABINET EXHAUST FAN.
6. EXISTING AIR DEVICE TO REMAIN.
7. DEMOLISH EXISTING AIR DEVICE.
8. DEMOLISH EXISTING EXTERIOR SOFFIT EXHAUST VENTS, ASSOCIATED EXHAUST DUCTWORK, AND ALL APPURTENANCES COMPLETE.
9. DEMOLISH EXISTING FINNED-TUBE HEATER AND ALL APPURTENANCES COMPLETE.
10. EXISTING RETURN GRILLE AND ASSOCIATED DUCTWORK TO REMAIN. DEMOLISH ASSOCIATED PNEUMATIC DAMPER.
11. DEMOLISH EXISTING REFRIGERANT PIPING, SUPPORTS, AND ALL APPURTENANCES COMPLETE.
12. DEMOLISH EXISTING HVAC CONTROLS COMPLETE.
13. REFER TO MD401 FOR CONTINUATION.

#	DATE	CHANGE DESCRIPTION


RENOVATION OF HEARTLAND BANK DUBLIN
6500 FRANTZ ROAD
DUBLIN, OH 43017
FOR
HEARTLAND BANK

MOODY-NOLAN
300 SPRUCE STREET
SUITE 300
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FLOOR PLANS - MECHANICAL - DEMOLITION

PROGRESS DRAWING NOT FOR CONSTRUCTION	11/30/2020
	DRAWN BY: Author CHECKED BY: Checker
	20022
	MD101
FINAL DEVELOPMENT PLAN	

- CODED NOTES:**
1. DEMOLISH ABOVE AND BELOW GRADE REFRIGERANT PIPING, SUPPORTS, AND ALL APPURTENANCES COMPLETE.
 2. REMOVE EXISTING CONDENSING UNIT AND SALVAGE. RETURN TO OWNER. DEMOLISH EXISTING ASSOCIATED CONCRETE PAD.
 3. DEMOLISH EXISTING CONCRETE PAD COMPLETE.
 4. REFER TO SHEET MD101 FOR CONTINUATION.

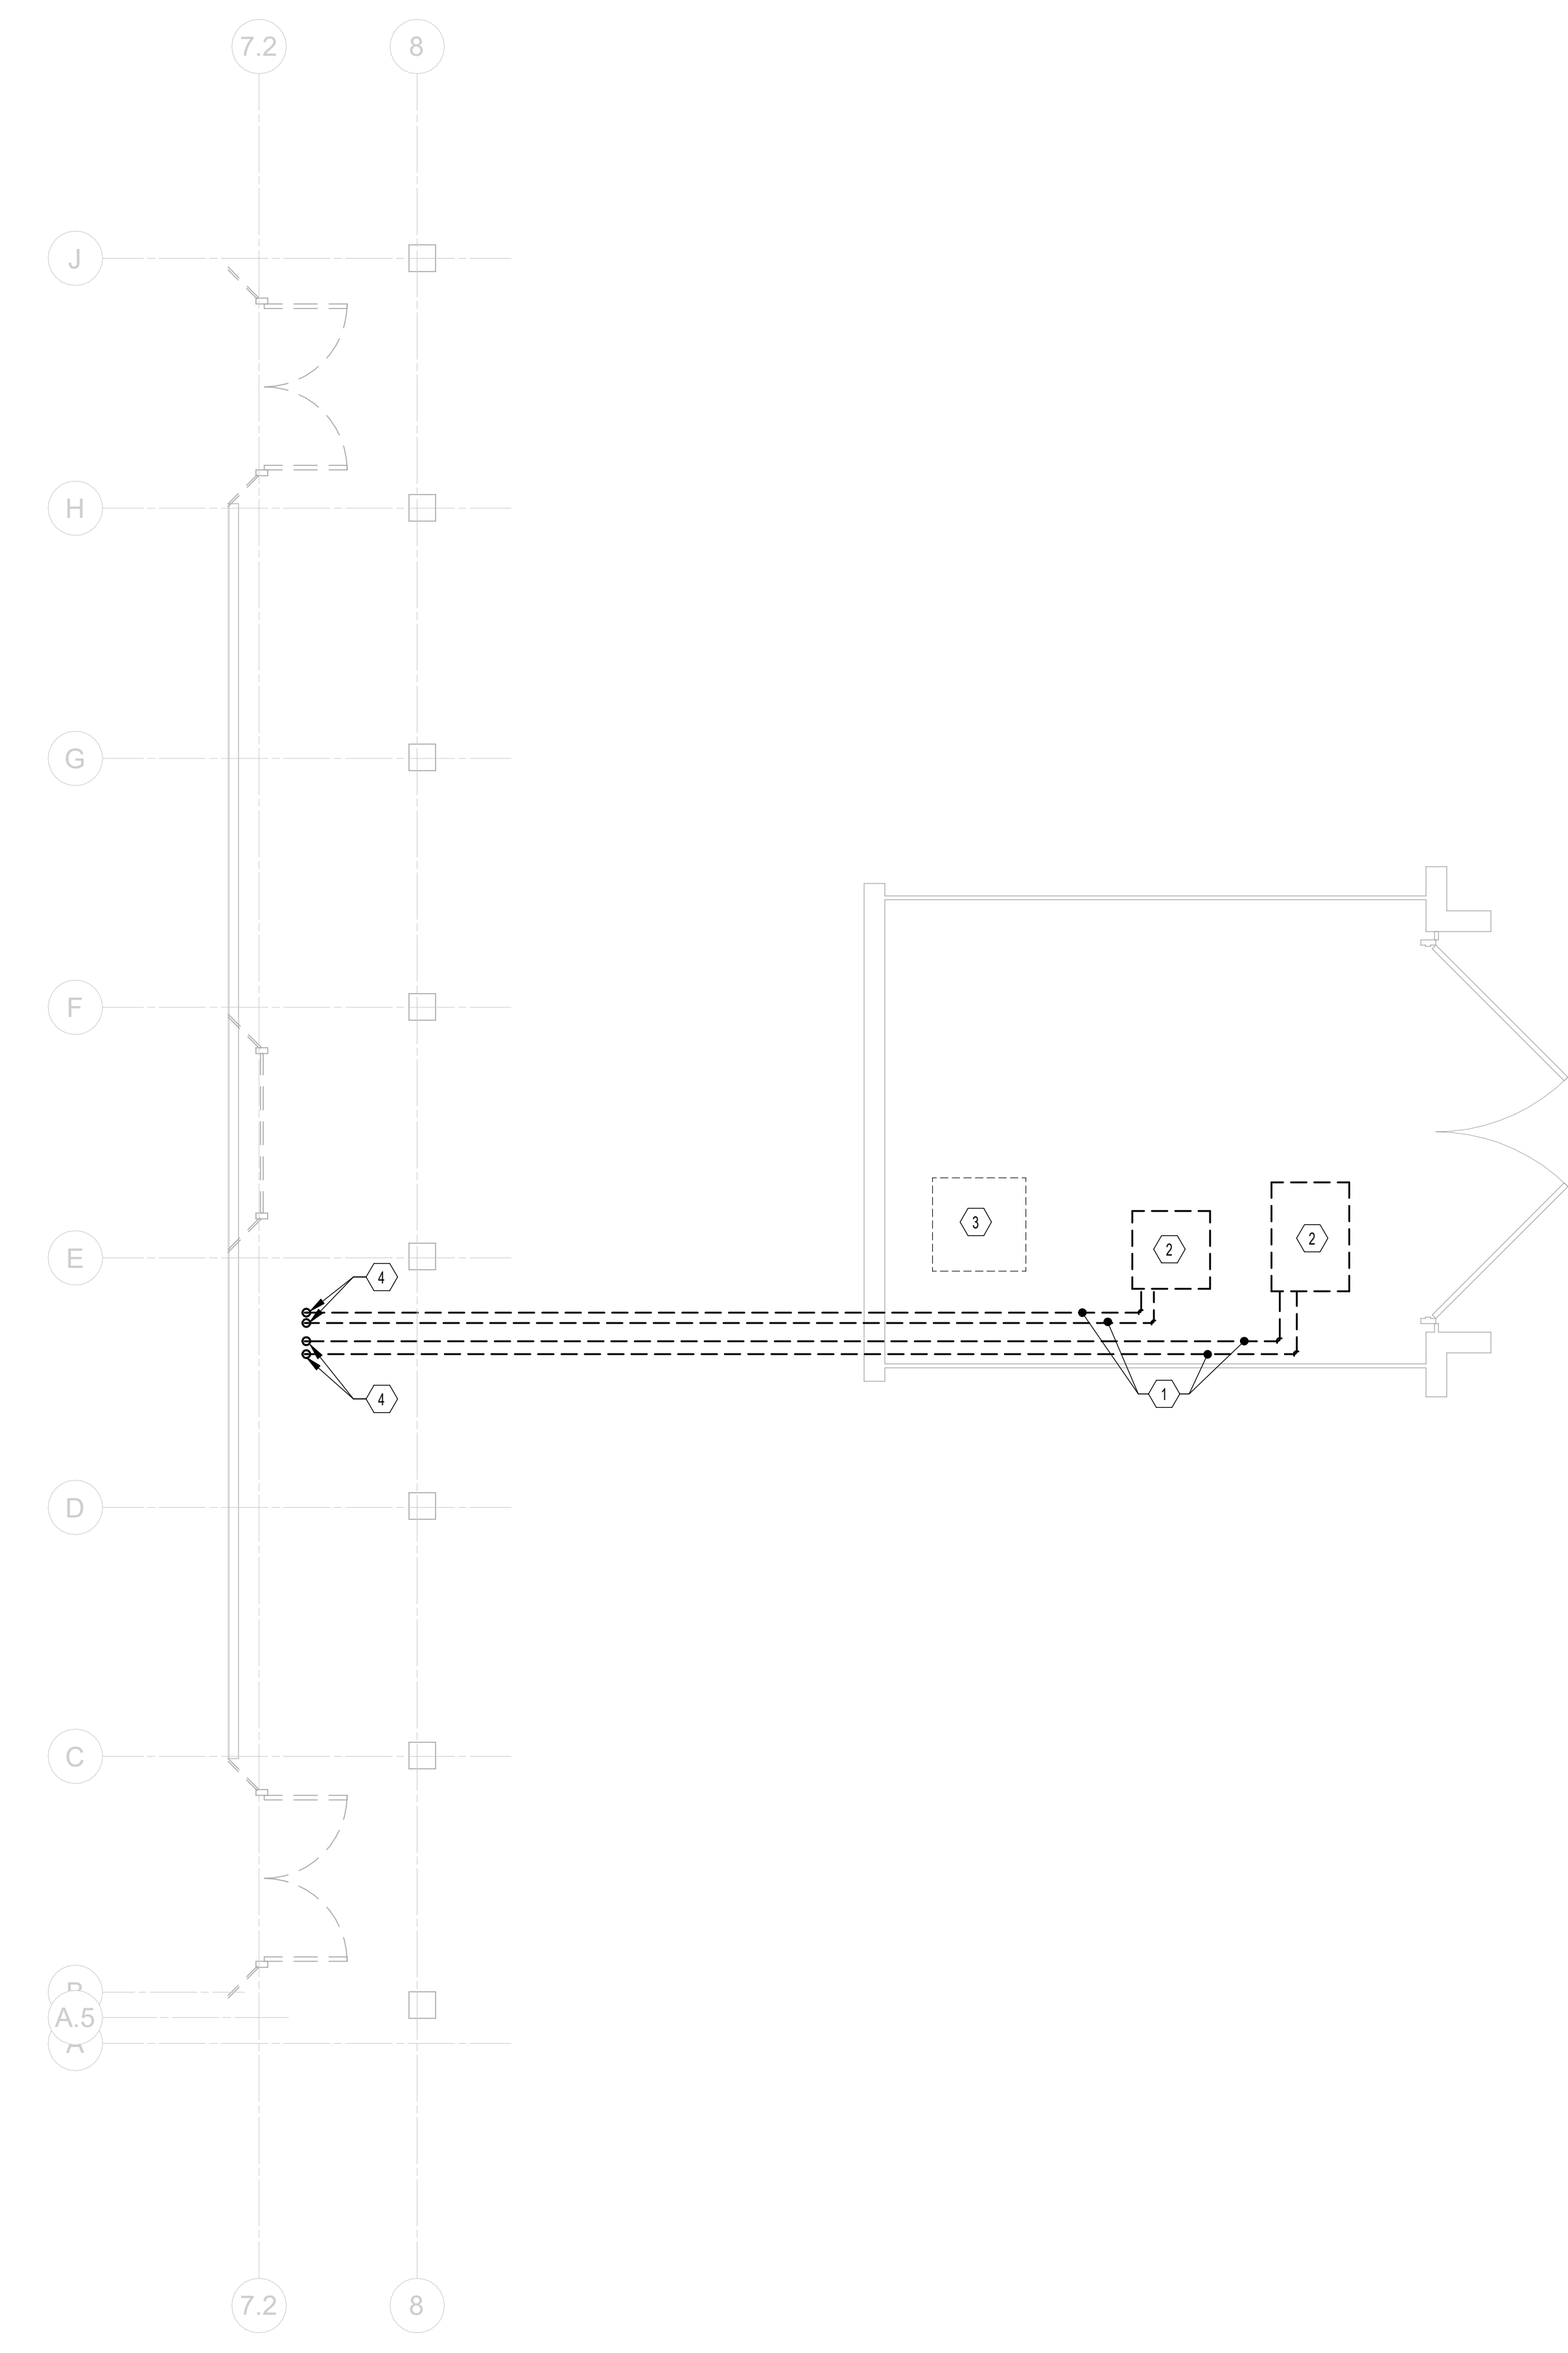

1 PLAN EQUIPMENT YARD PLAN - MECHANICAL - DEMOLITION
1/4" = 1'-0"


#	DATE	CHANGE DESCRIPTION

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6500 FRANTZ ROAD
DUBLIN, OH 43017
FOR
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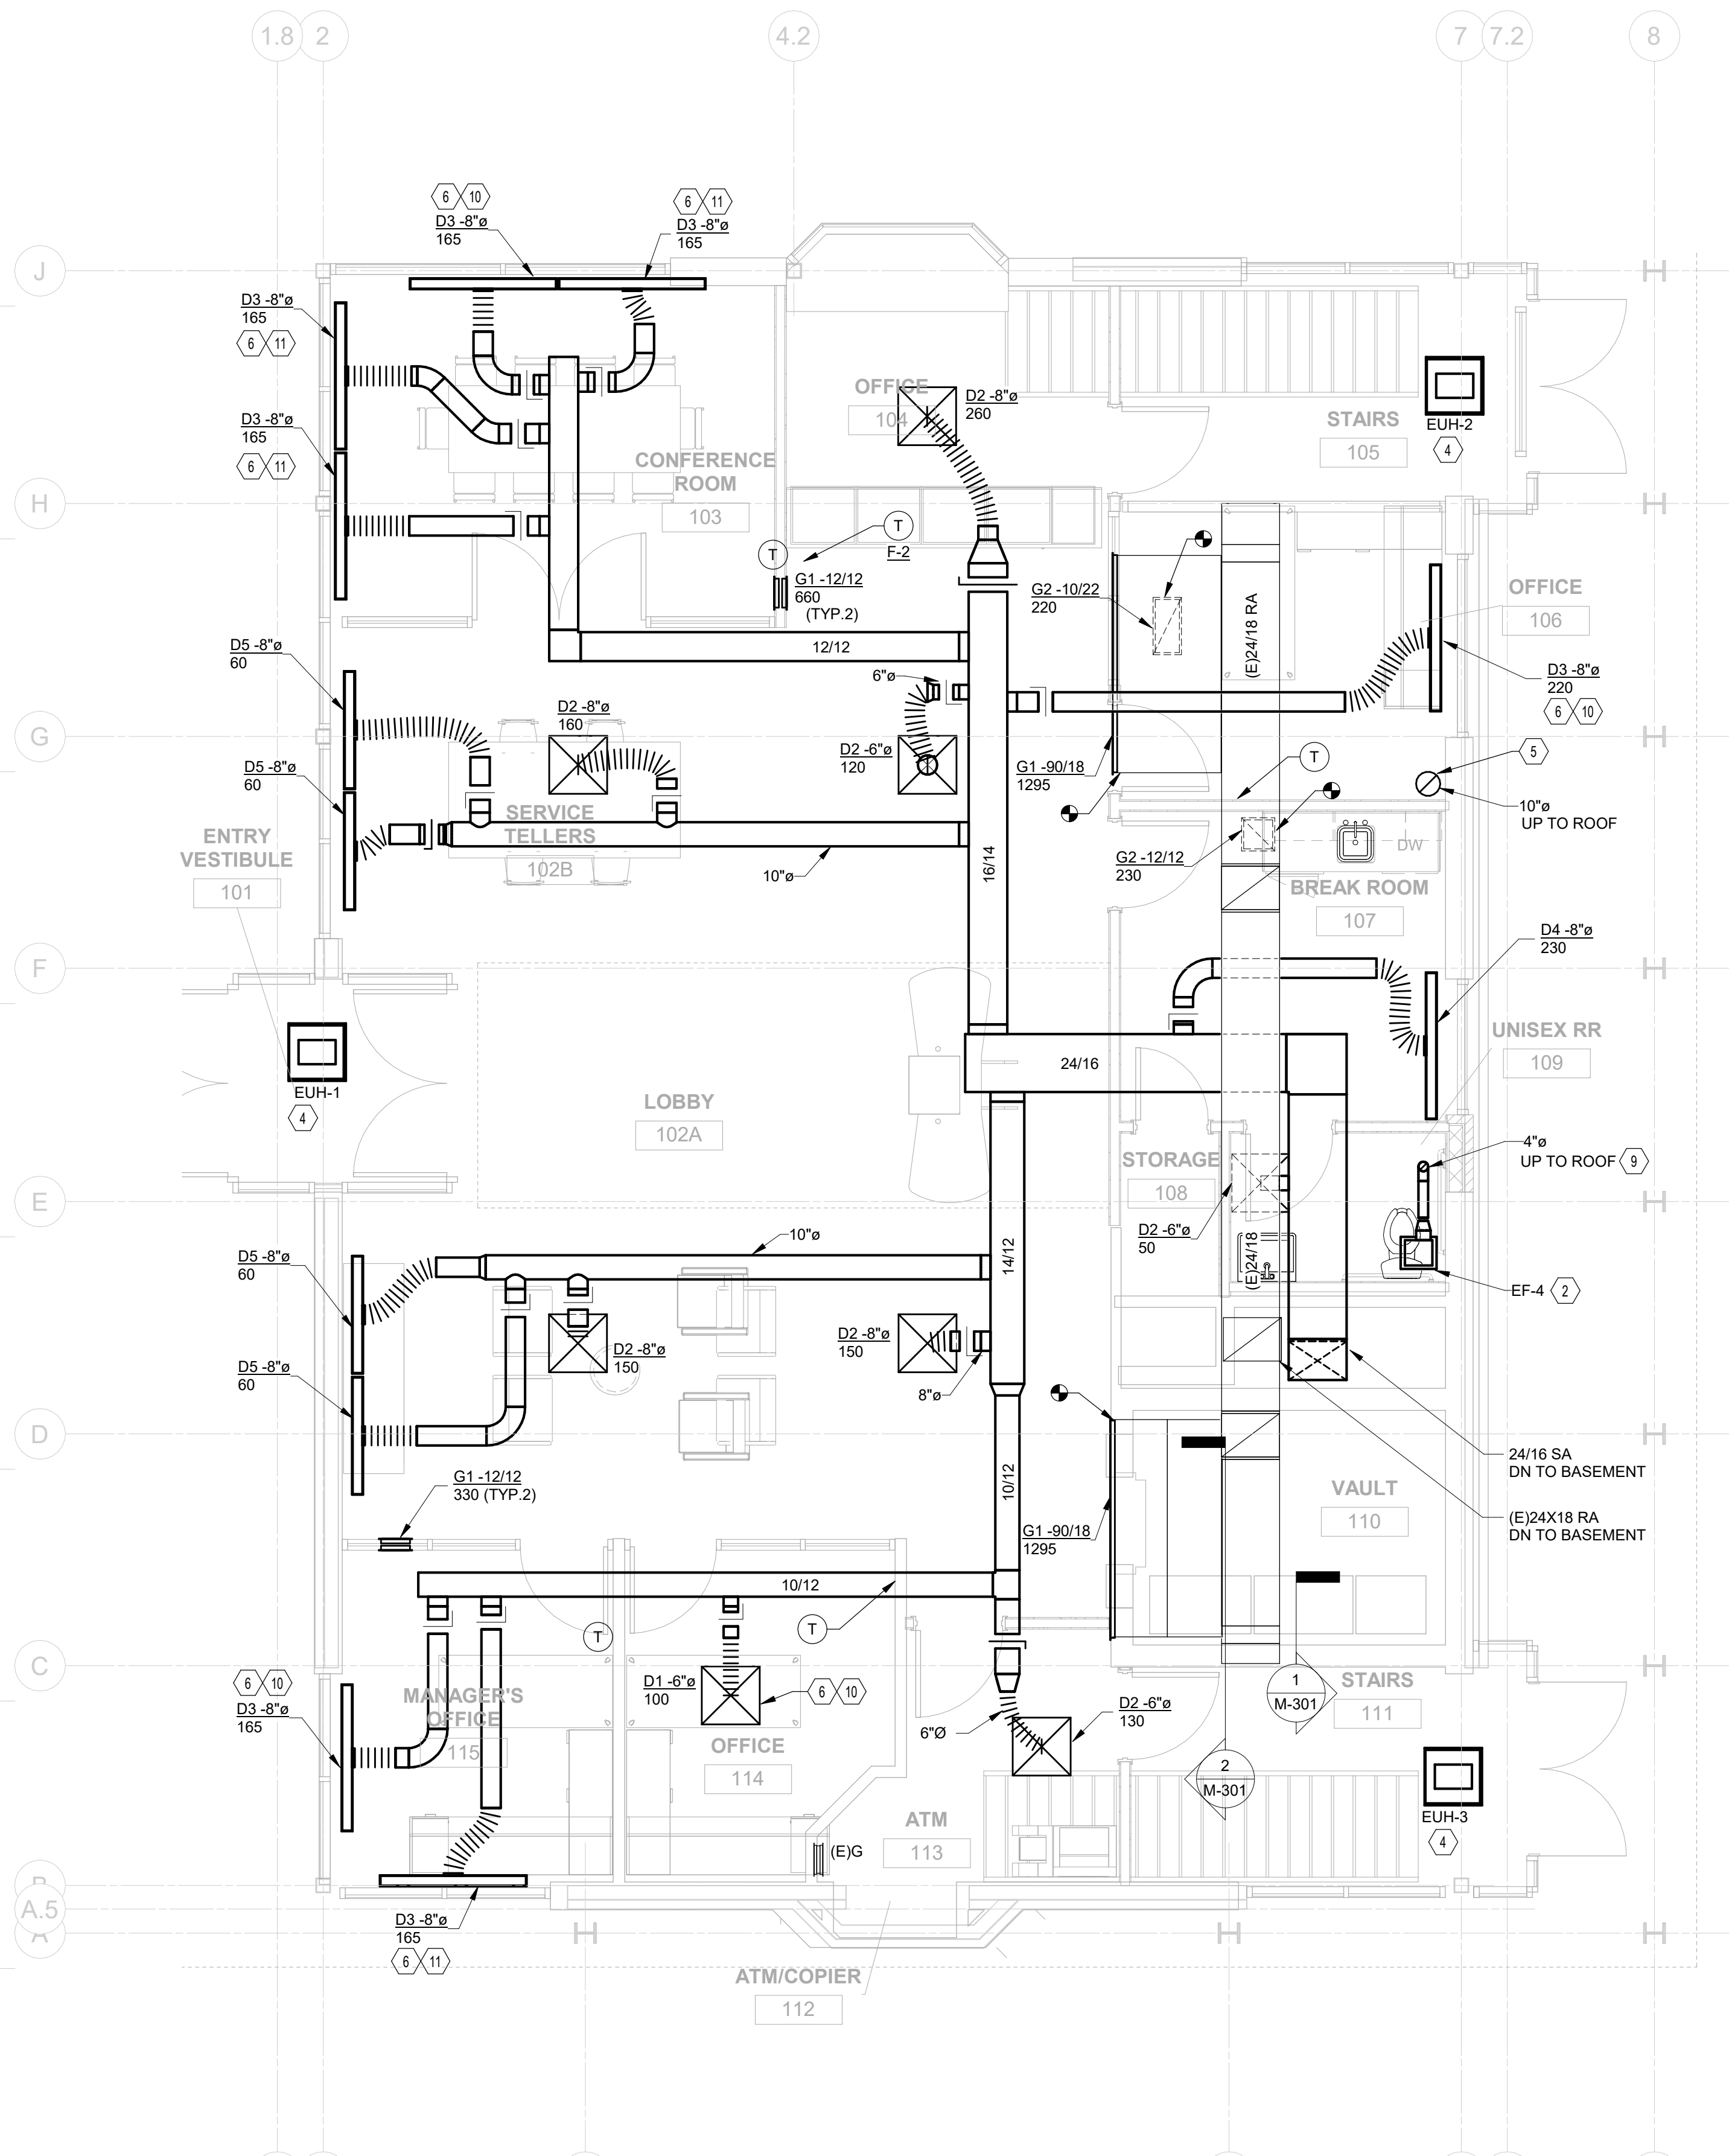
MOODY-NOLAN
300 SPRUCE STREET
SUITE 300
COLUMBUS, OHIO 43215
PHONE: (614) 461-4664
FAX: (614) 280-8881

DRAWING TITLE:
ENLARGED PLANS - MECHANICAL - DEMOLITION

PROGRESS DRAWING NOT FOR CONSTRUCTION	11/30/2020
	DRAWN BY: Author CHECKED BY: Checker
	20022
	MD401
	FINAL DEVELOPMENT PLAN

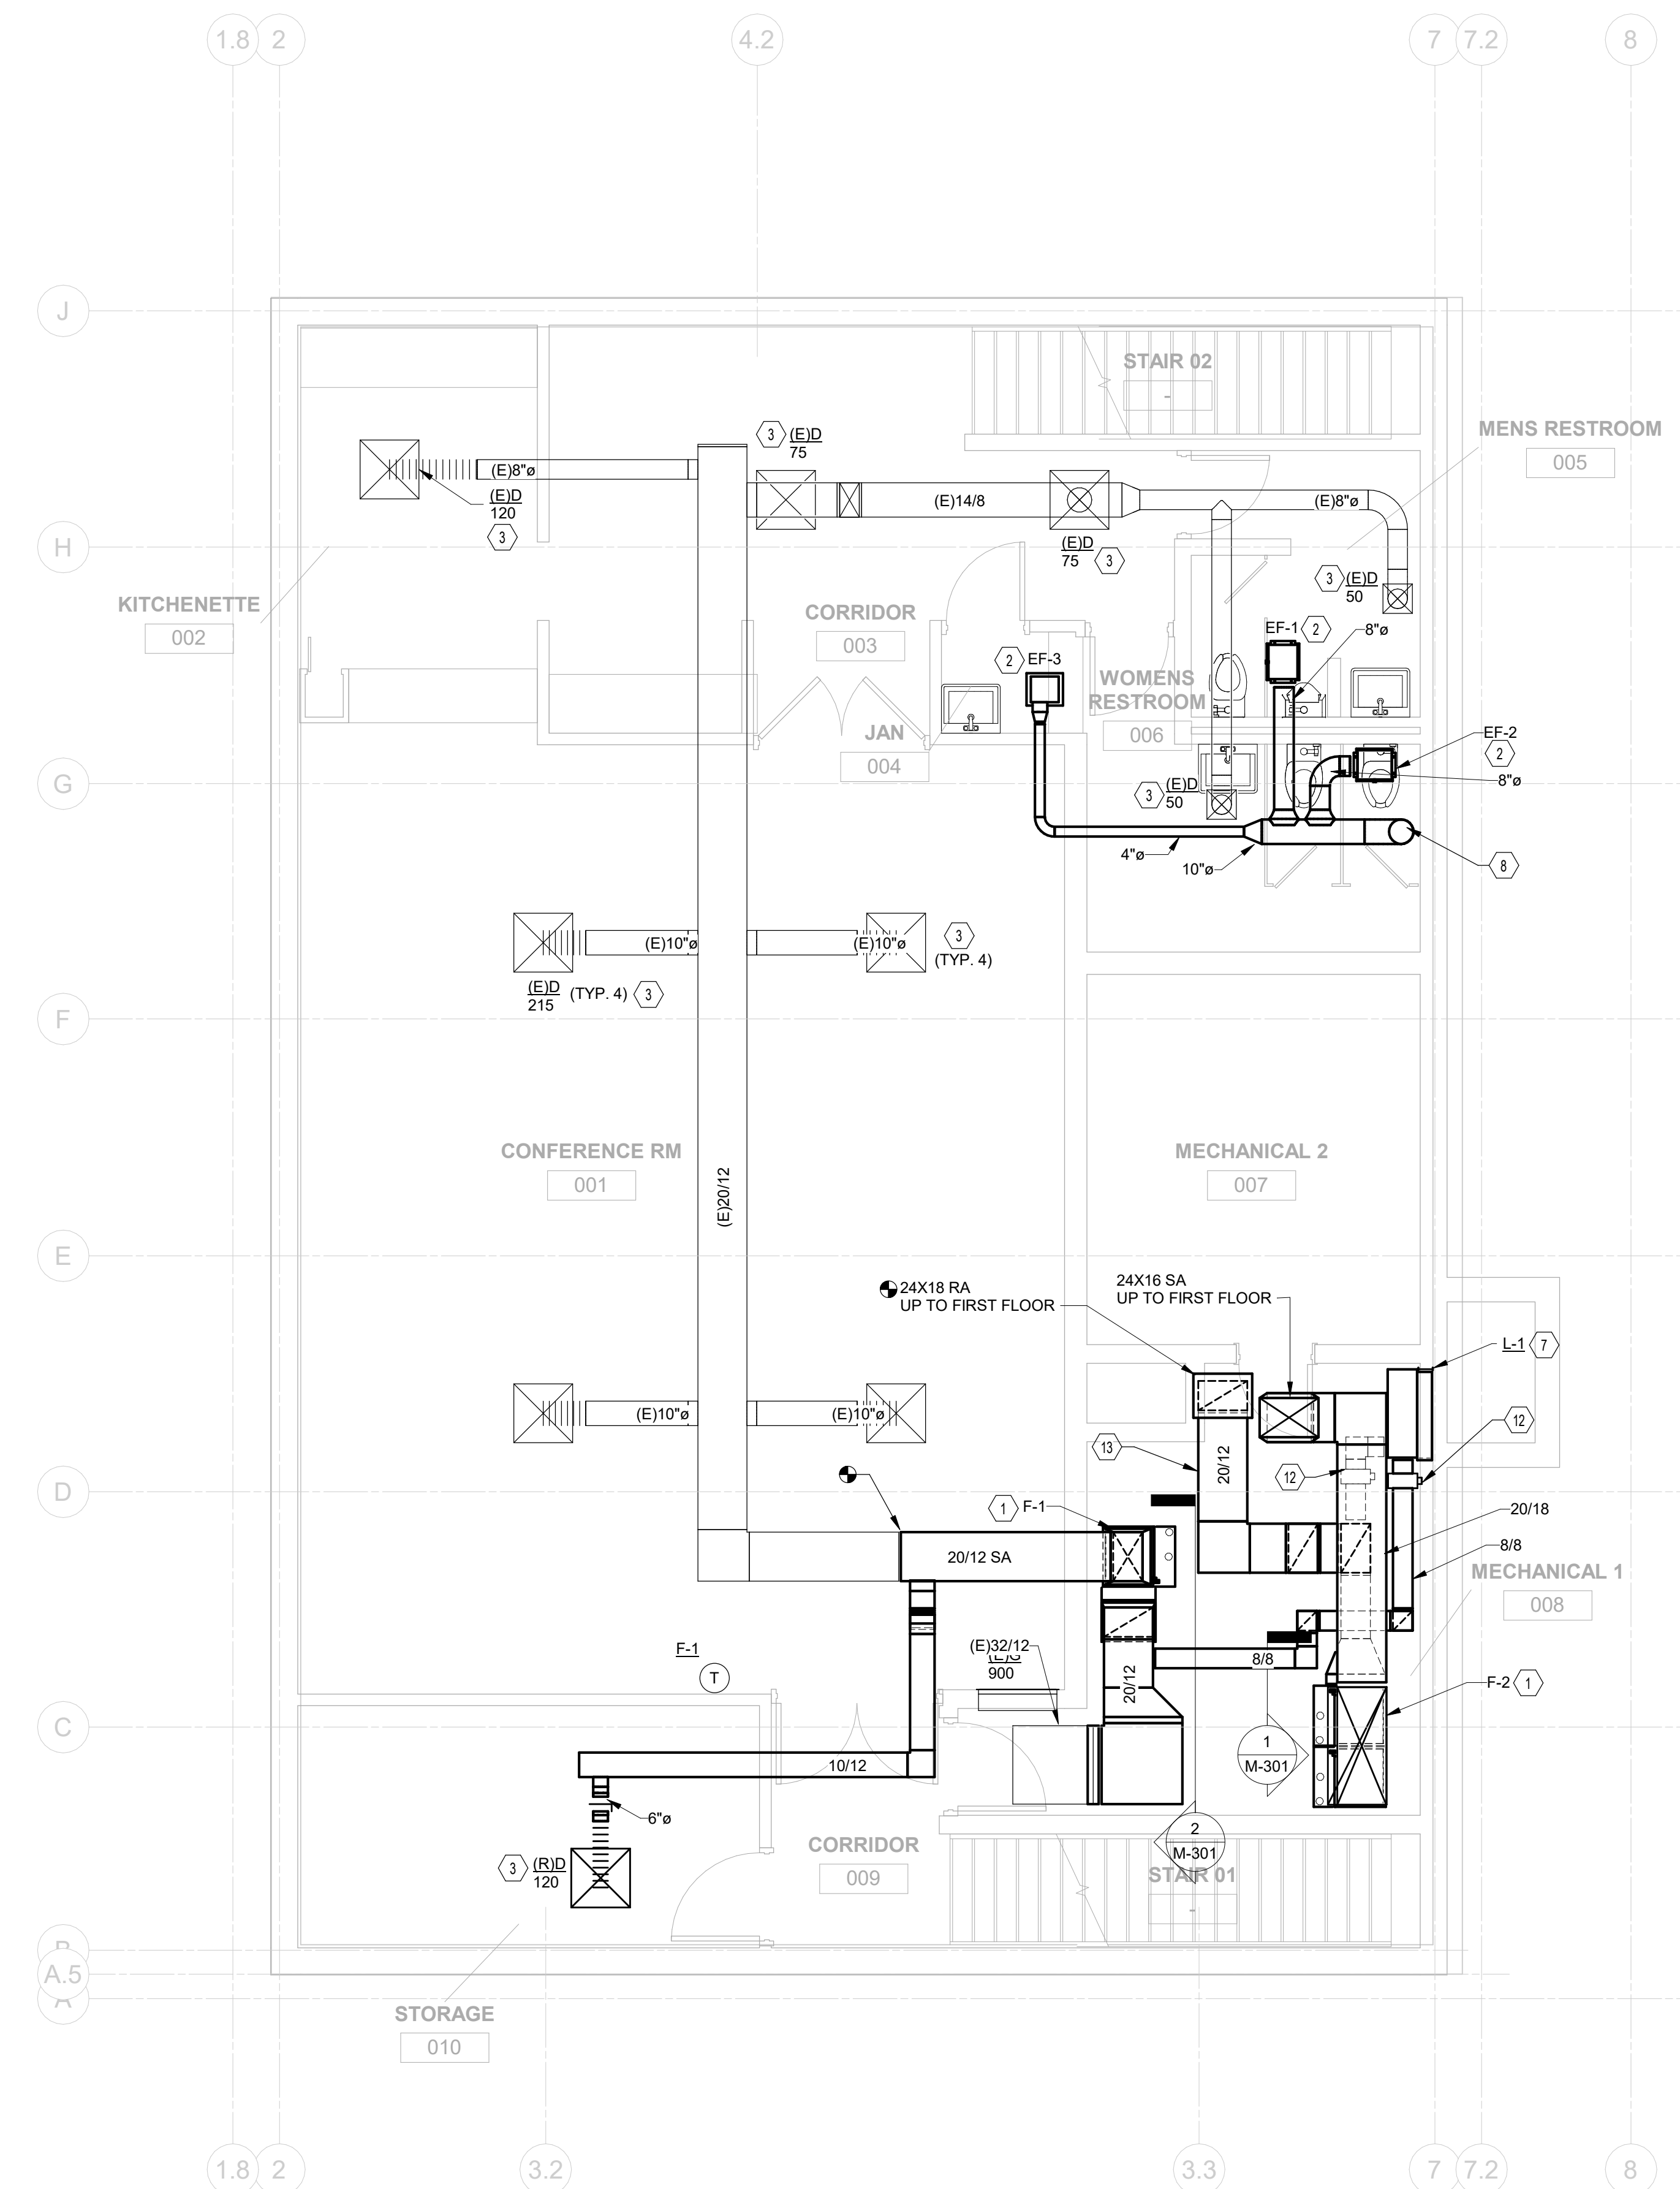

1 PLAN BASEMENT FLOOR PLAN - MECHANICAL
1/4" = 1'-0"



2 PLAN FIRST FLOOR PLAN - MECHANICAL
1/4" = 1'-0"

- CODED NOTES:**
1. PROVIDE GAS-FIRED FURNACE AND EVAPORATOR COIL. PROVIDE EQUIPMENT PAD. REFER TO SCHEDULE SHEET FOR MORE INFORMATION. REFER TO DETAILS 4M-501 AND 5M-501.
 2. PROVIDE RESTROOM CABINET EXHAUST FAN. REFER TO SCHEDULE SHEET FOR MORE INFORMATION.
 3. REBALANCE RELOCATED/EXISTING AIR DEVICE TO INDICATED CFM.
 4. PROVIDE CEILING RECESSED ELECTRIC UNIT HEATER. REFER TO SCHEDULE SHEET FOR MORE INFORMATION.
 5. TERMINATE EXHAUST WITH PITCHED ROOF WALL CAP WITH 10"Ø EXTENSION EQUAL TO FAMCO BK10X.
 6. PROVIDED VAV DIFFUSER. REFER TO SCHEDULE SHEET FOR MORE INFORMATION. REFER TO SHEET M-701 FOR CONTROL INFORMATION.
 7. PROVIDE INTAKE AIR LOUVER L-1. PROVIDE SHEET METAL BLANK-OFF PANEL FOR REMAINING WALL OPENING. REFER TO SCHEDULE SHEET FOR MORE INFORMATION.
 8. 10"Ø EXHAUST DUCT UP TO FIRST FLOOR.
 9. TERMINATE EXHAUST DUCT THROUGH ROOF WITH PITCHED ROOF CAP. REFER TO SCHEDULE SHEET FOR MORE INFORMATION.
 10. MASTER VAV DIFFUSER FOR SPACE.
 11. DRONE VAV DIFFUSER FOR SPACE.
 12. PROVIDE 120V MOTORIZED OUTSIDE AIR DAMPER.
 13. DUCT SMOKE DETECTOR.

#	DATE	CHANGE DESCRIPTION

RENOVATION OF HEARTLAND BANK DUBLIN
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DUBLIN, OH 43017
FOR
HEARTLAND BANK

MOODY-NOLAN 300 SPRUCE STREET
SUITE 300
COLUMBUS, OHIO 43215
PHONE: (614) 461-4664
FAX: (614) 280-8881


FLOOR PLANS - HVAC

11/30/2020
DRAWN BY: Author CHECKED BY: Checker
20022
M-101
FINAL DEVELOPMENT PLAN


PROGRESS DRAWING NOT FOR CONSTRUCTION

CODED NOTES:

1. ROUTE REFRIGERANT PIPING FROM INDOOR EVAPORATOR COILS TO AIR-COOLED CONDENSING UNIT. REFRIGERANT PIPING SHALL ROUTE THROUGH INSULATED BLANK OFF PANEL AND INTO EXISTING AREAWELL. SEAL PENETRATIONS THROUGH BLANK OFF PANEL WATERTIGHT. INSTALL PER MANUFACTURERS RECOMMENDATIONS. REFER TO SHEET M-401 FOR CONTINUATION.
2. ROUTE COMBUSTION AIR INTAKE/VENT PIPING UP THROUGH EXISTING CHASE.
3. TERMINATE COMBUSTION AIR INTAKE/VENT PIPING THROUGH ROOF WITH 4" CONCENTRIC VENT KIT. INSTALL PER MANUFACTURERS RECOMMENDATIONS. REFER TO DETAILS 2/M-502 AND 7/M-502.
4. ROUTE 1" CONDENSATE PIPE TO NEAREST FLOOR DRAIN.

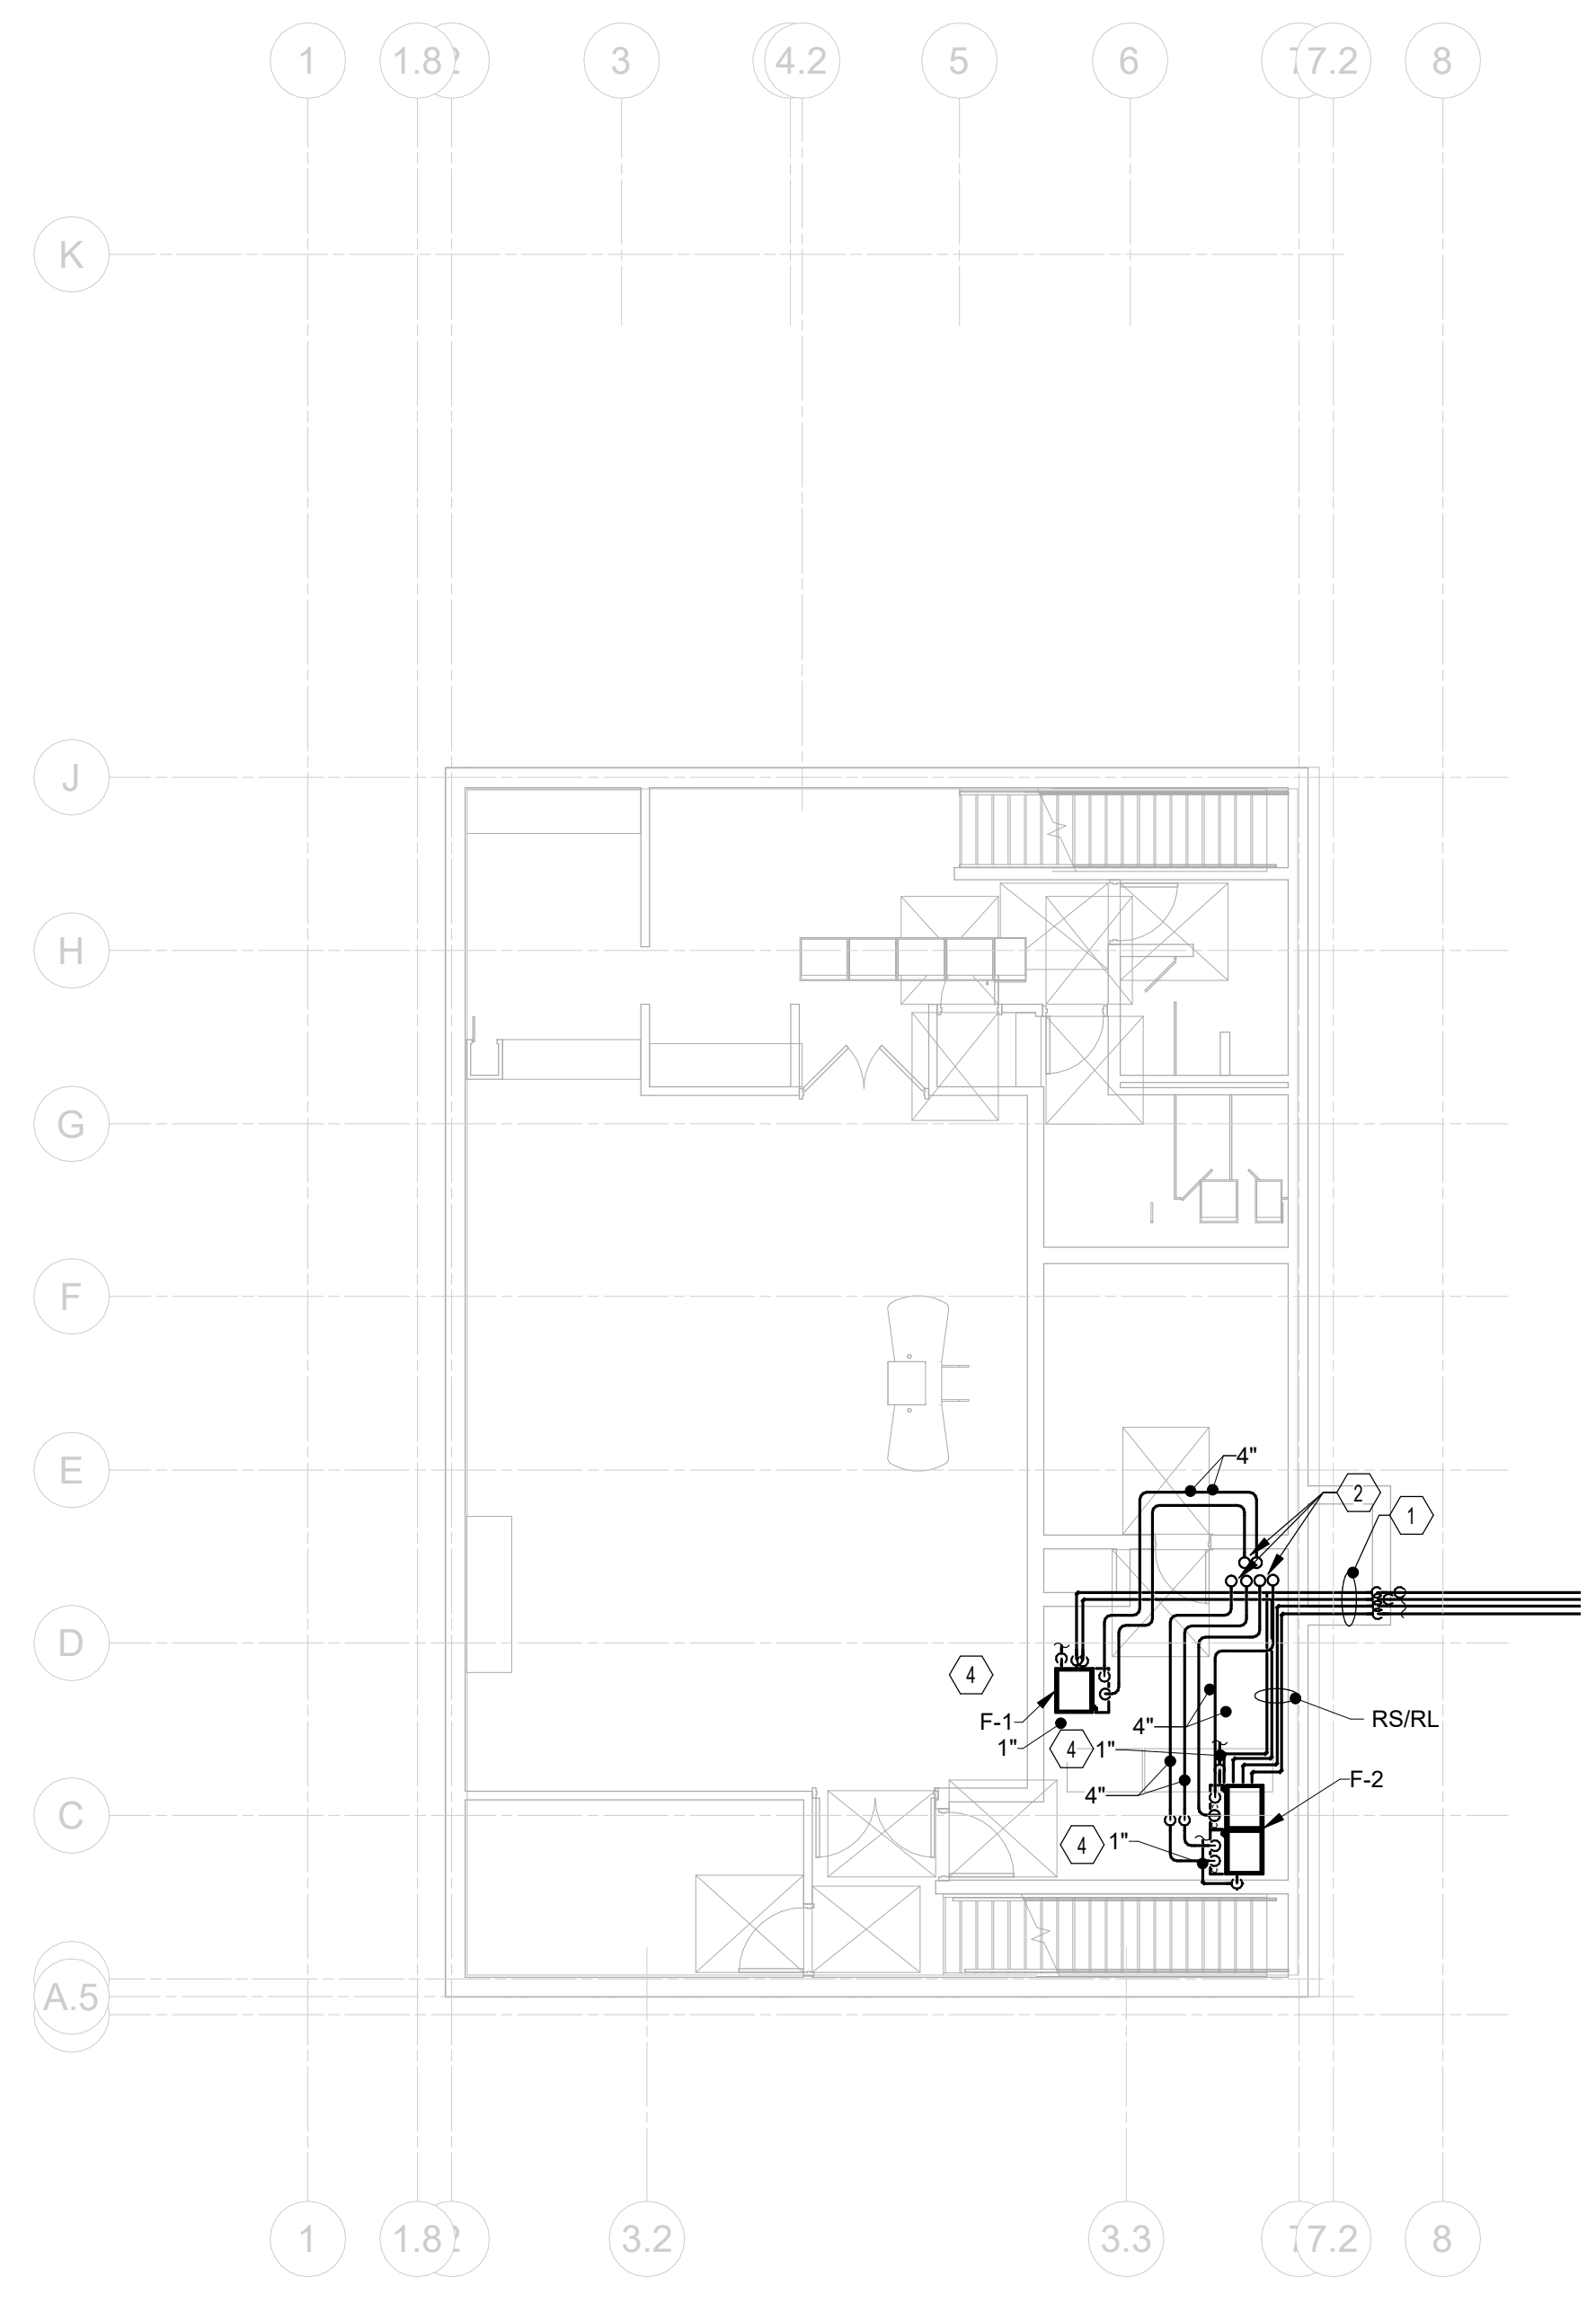

1 PLAN BASEMENT FLOOR PLAN - HVAC PIPING
1/8" = 1'-0"

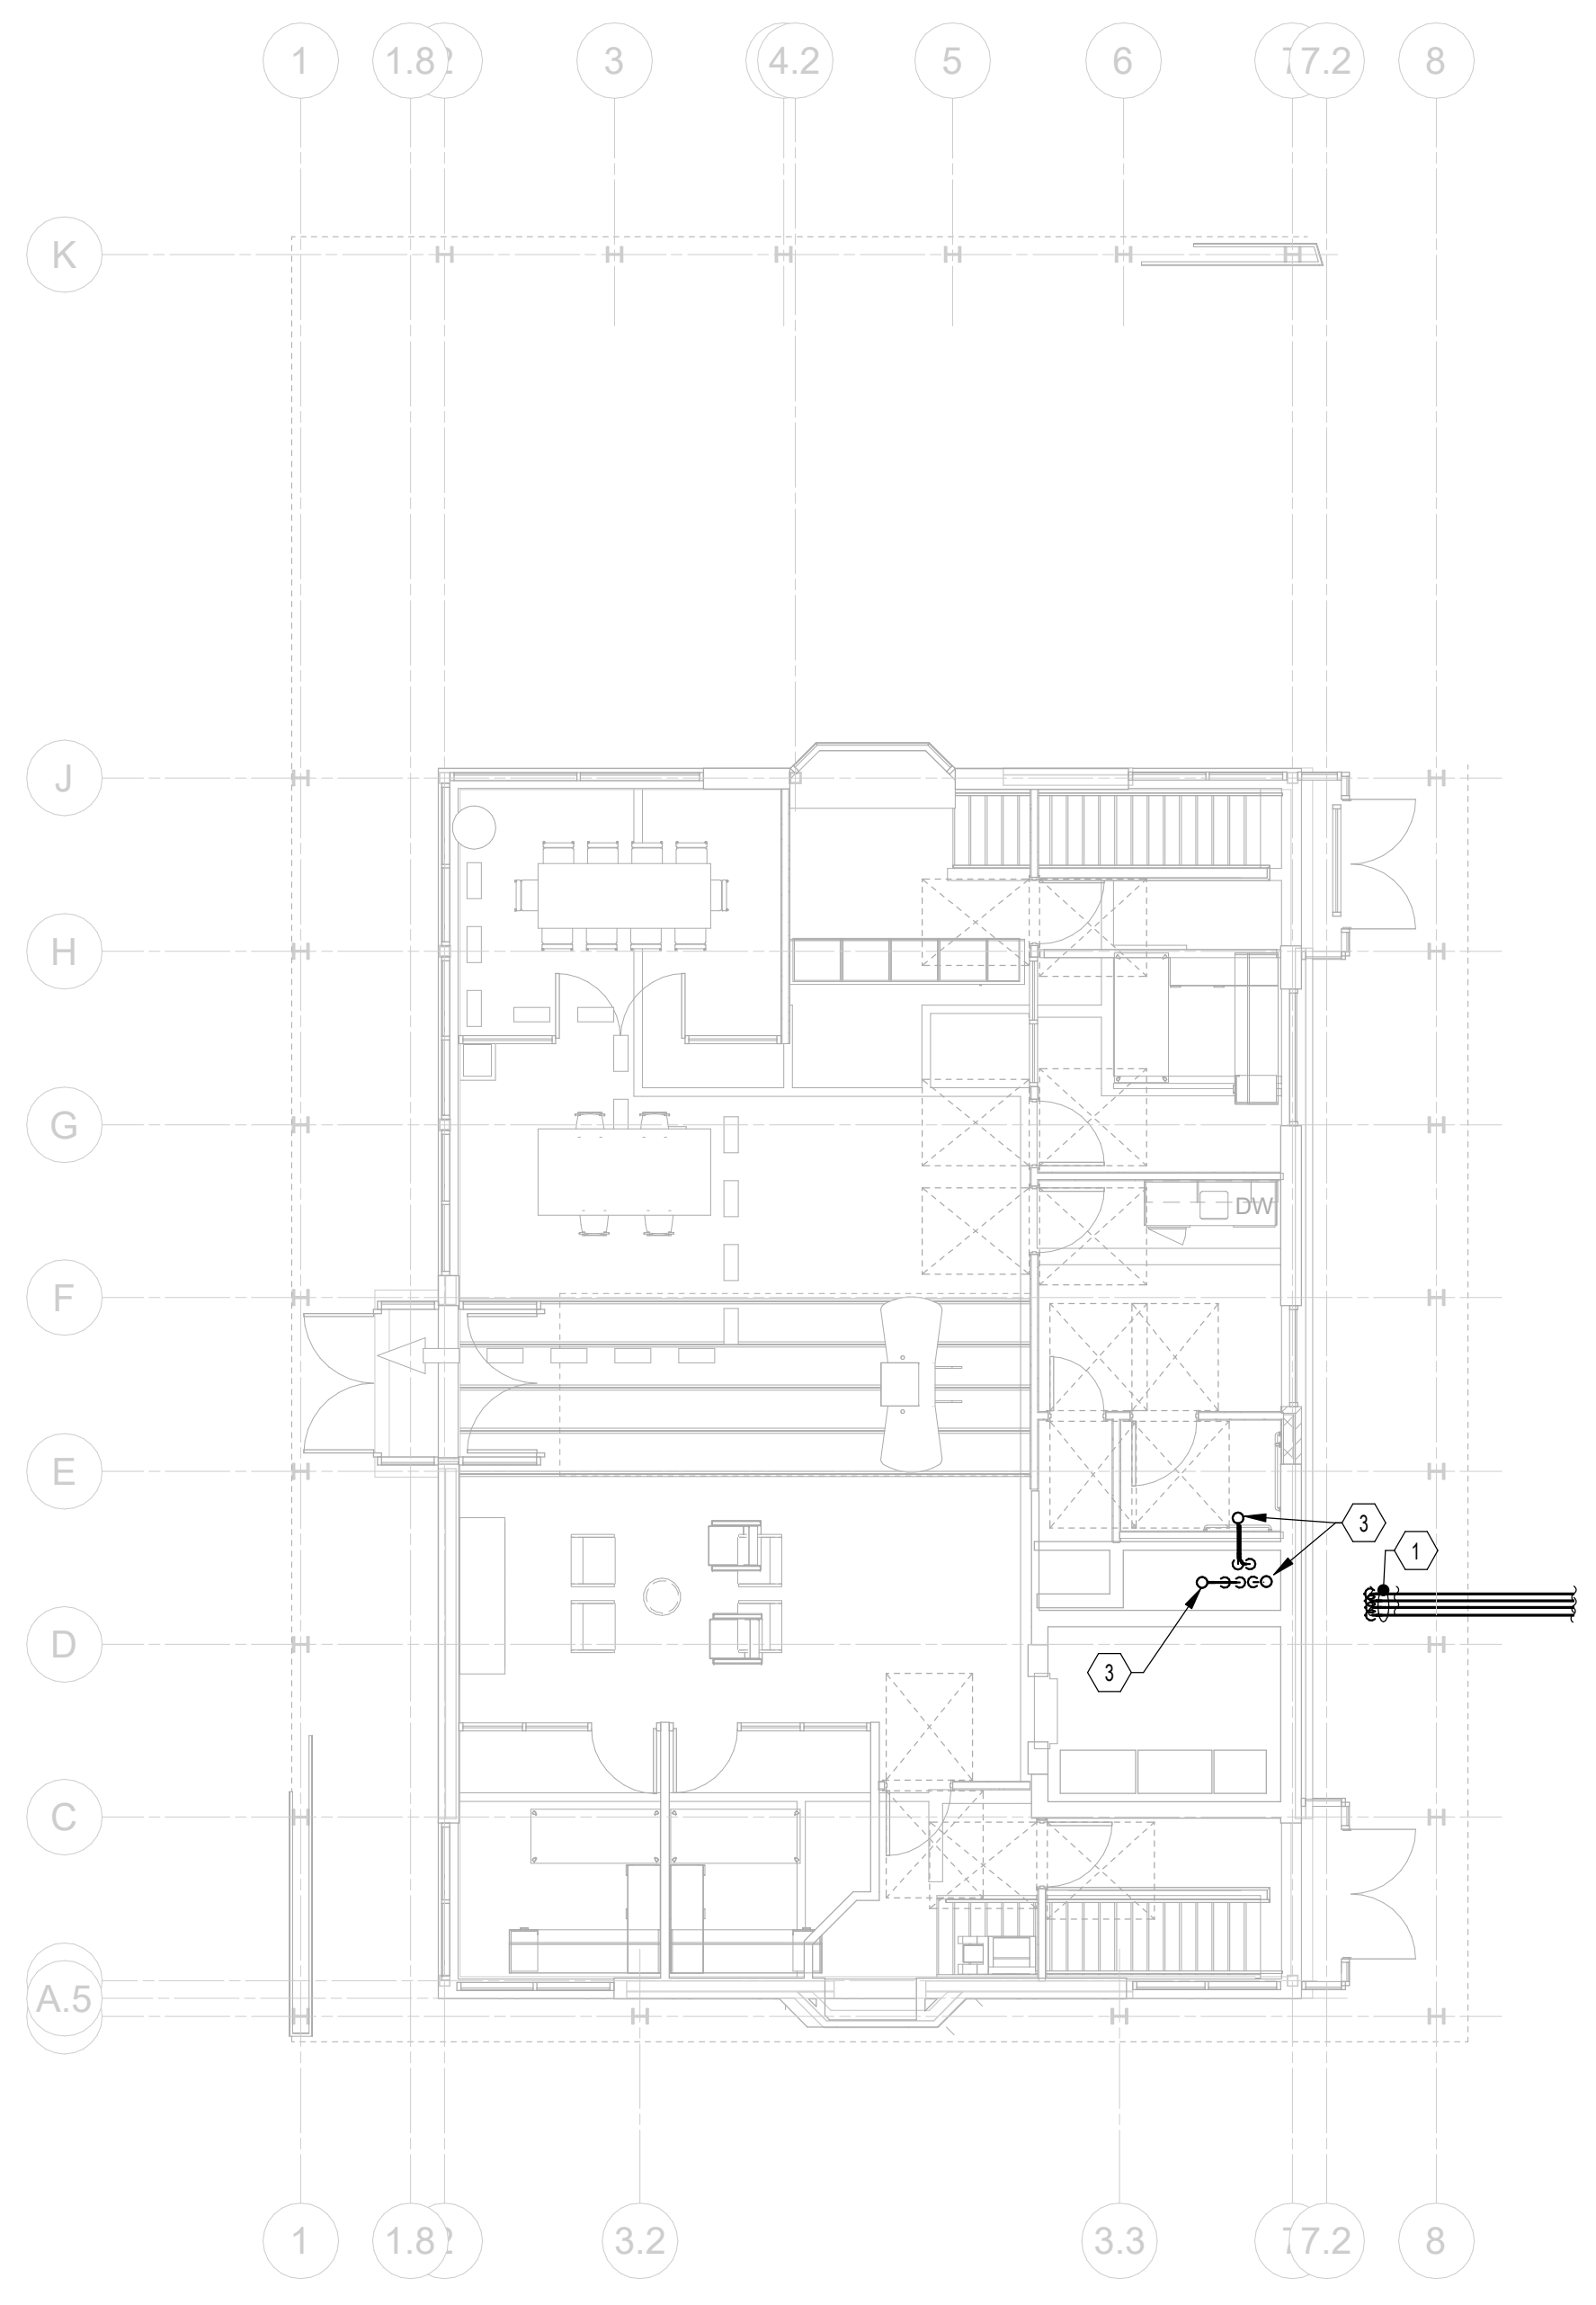

2 PLAN FIRST FLOOR PLAN - HVAC PIPING
1/8" = 1'-0"


#	DATE	CHANGE DESCRIPTION

RENOVATION OF HEARTLAND BANK DUBLIN
6500 FRANTZ ROAD
DUBLIN, OH 43017
FOR
HEARTLAND BANK


MOODY-NOLAN
300 SPRUCE STREET
SUITE 300
COLUMBUS, OHIO 43215
PHONE: (614) 461-4664
FAX: (614) 280-8881

DRAWING TITLE:
FLOOR PLANS - HVAC PIPING

PROGRESS DRAWING NOT FOR CONSTRUCTION	11/30/2020
	DRAWN BY: Author CHECKED BY: Checker
	20022
	M-201
FINAL DEVELOPMENT PLAN	

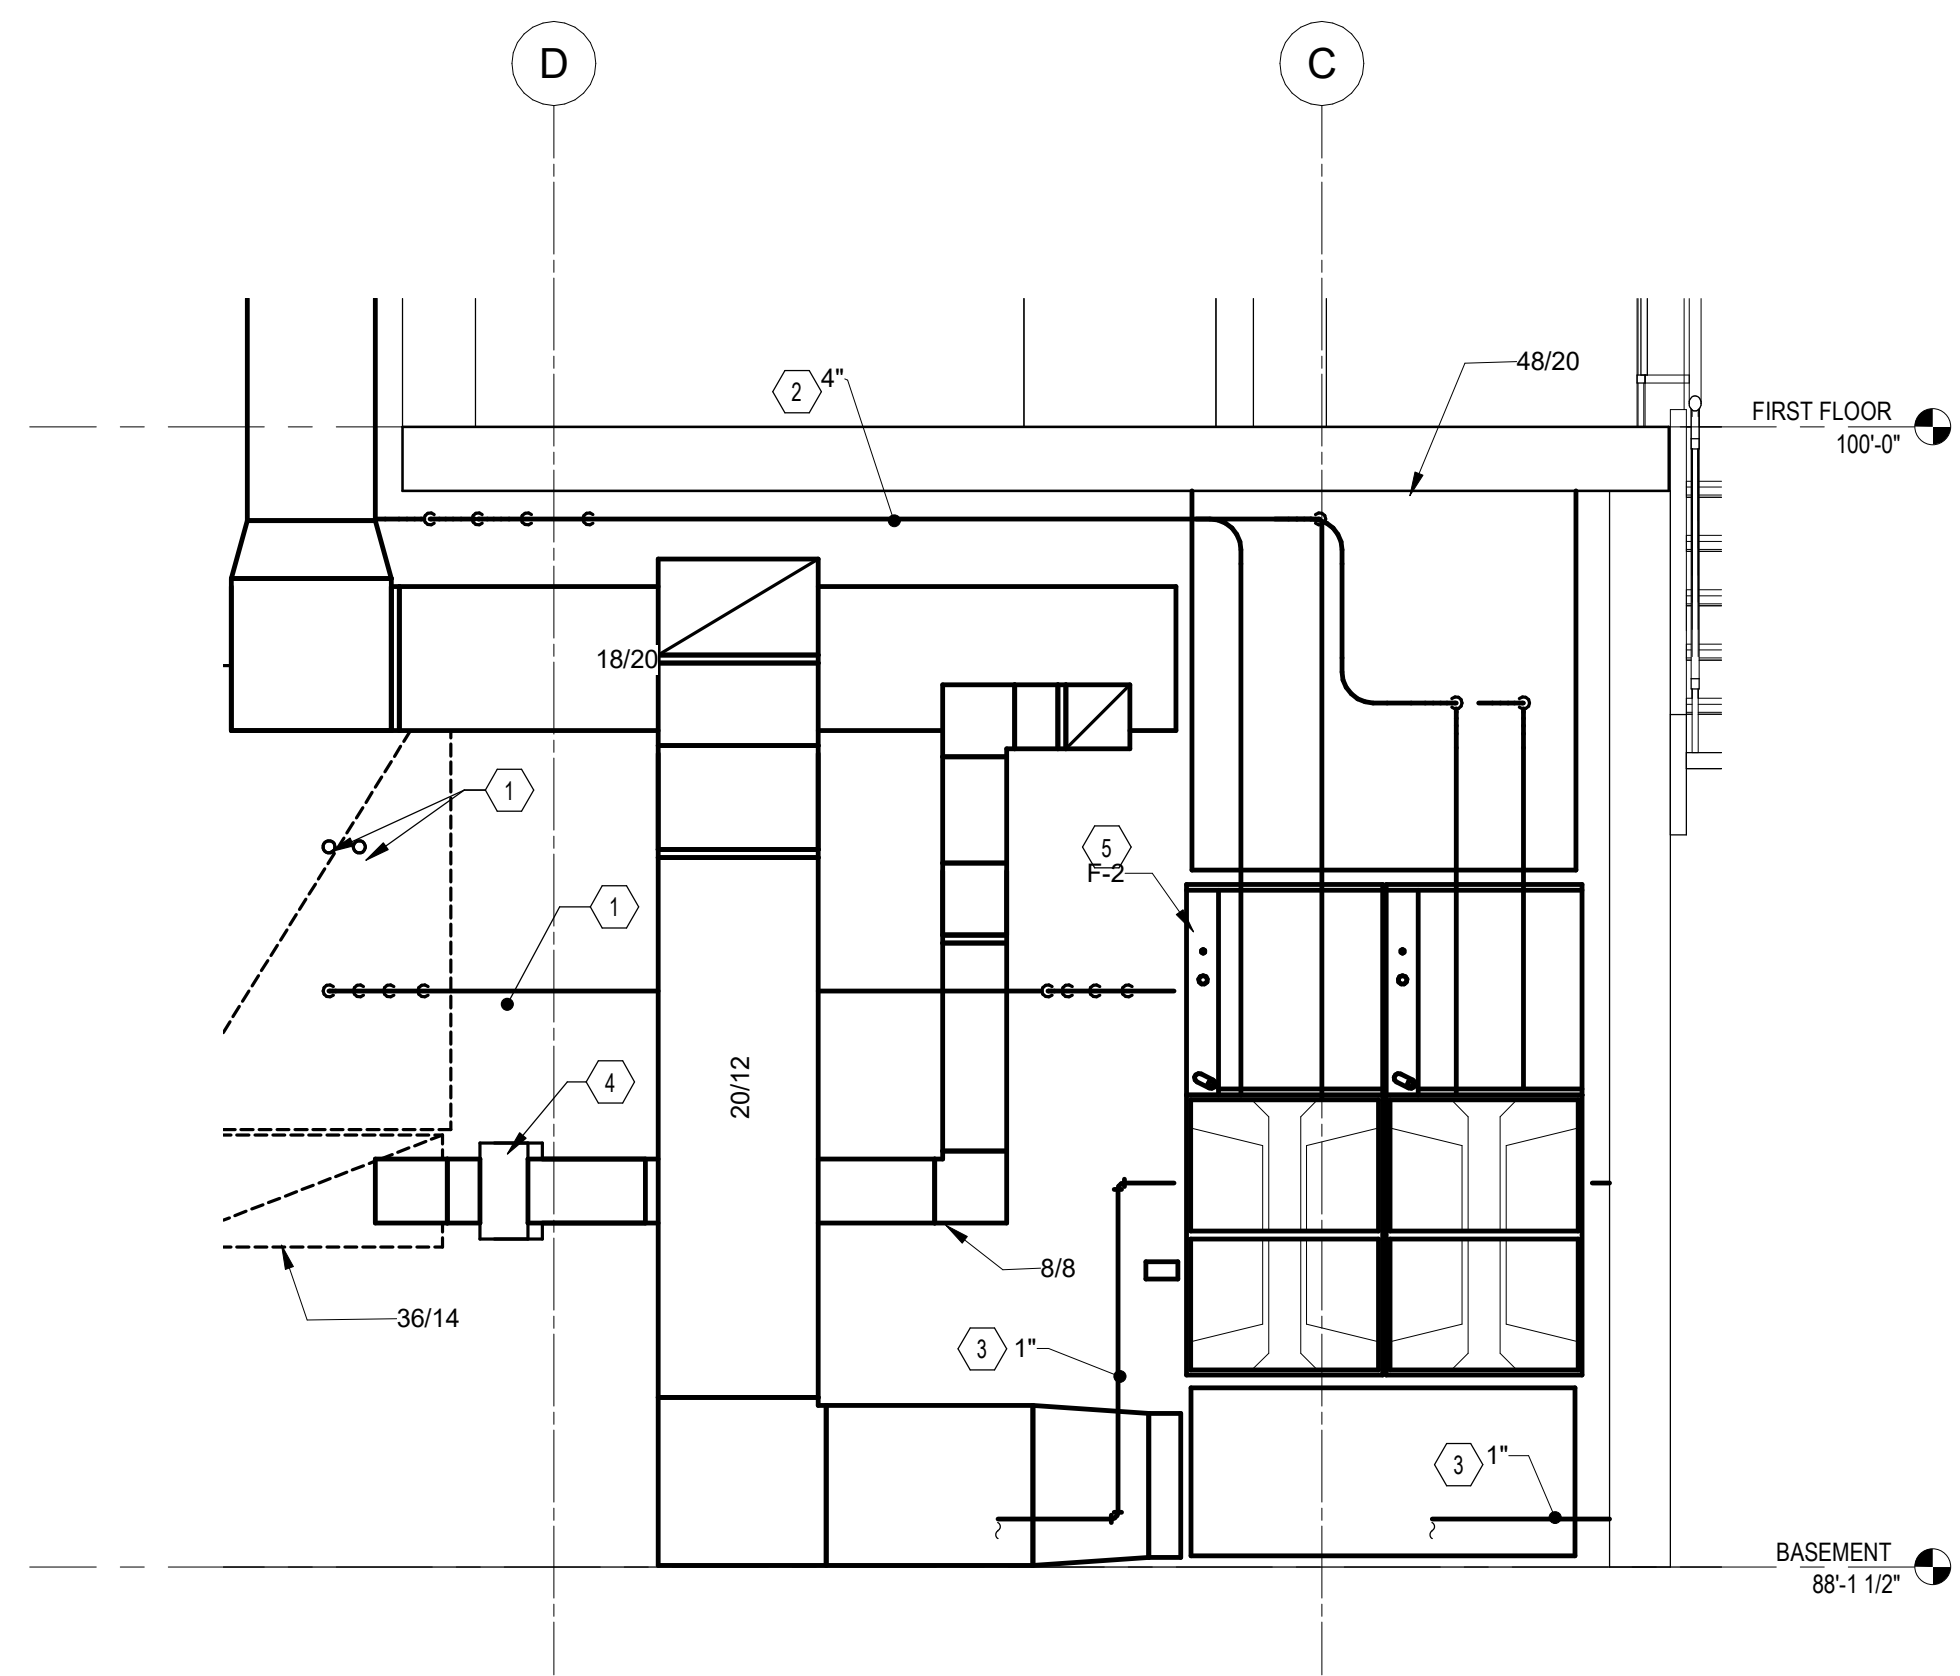

1 PLAN SECTION F-2
1/2" = 1'-0"

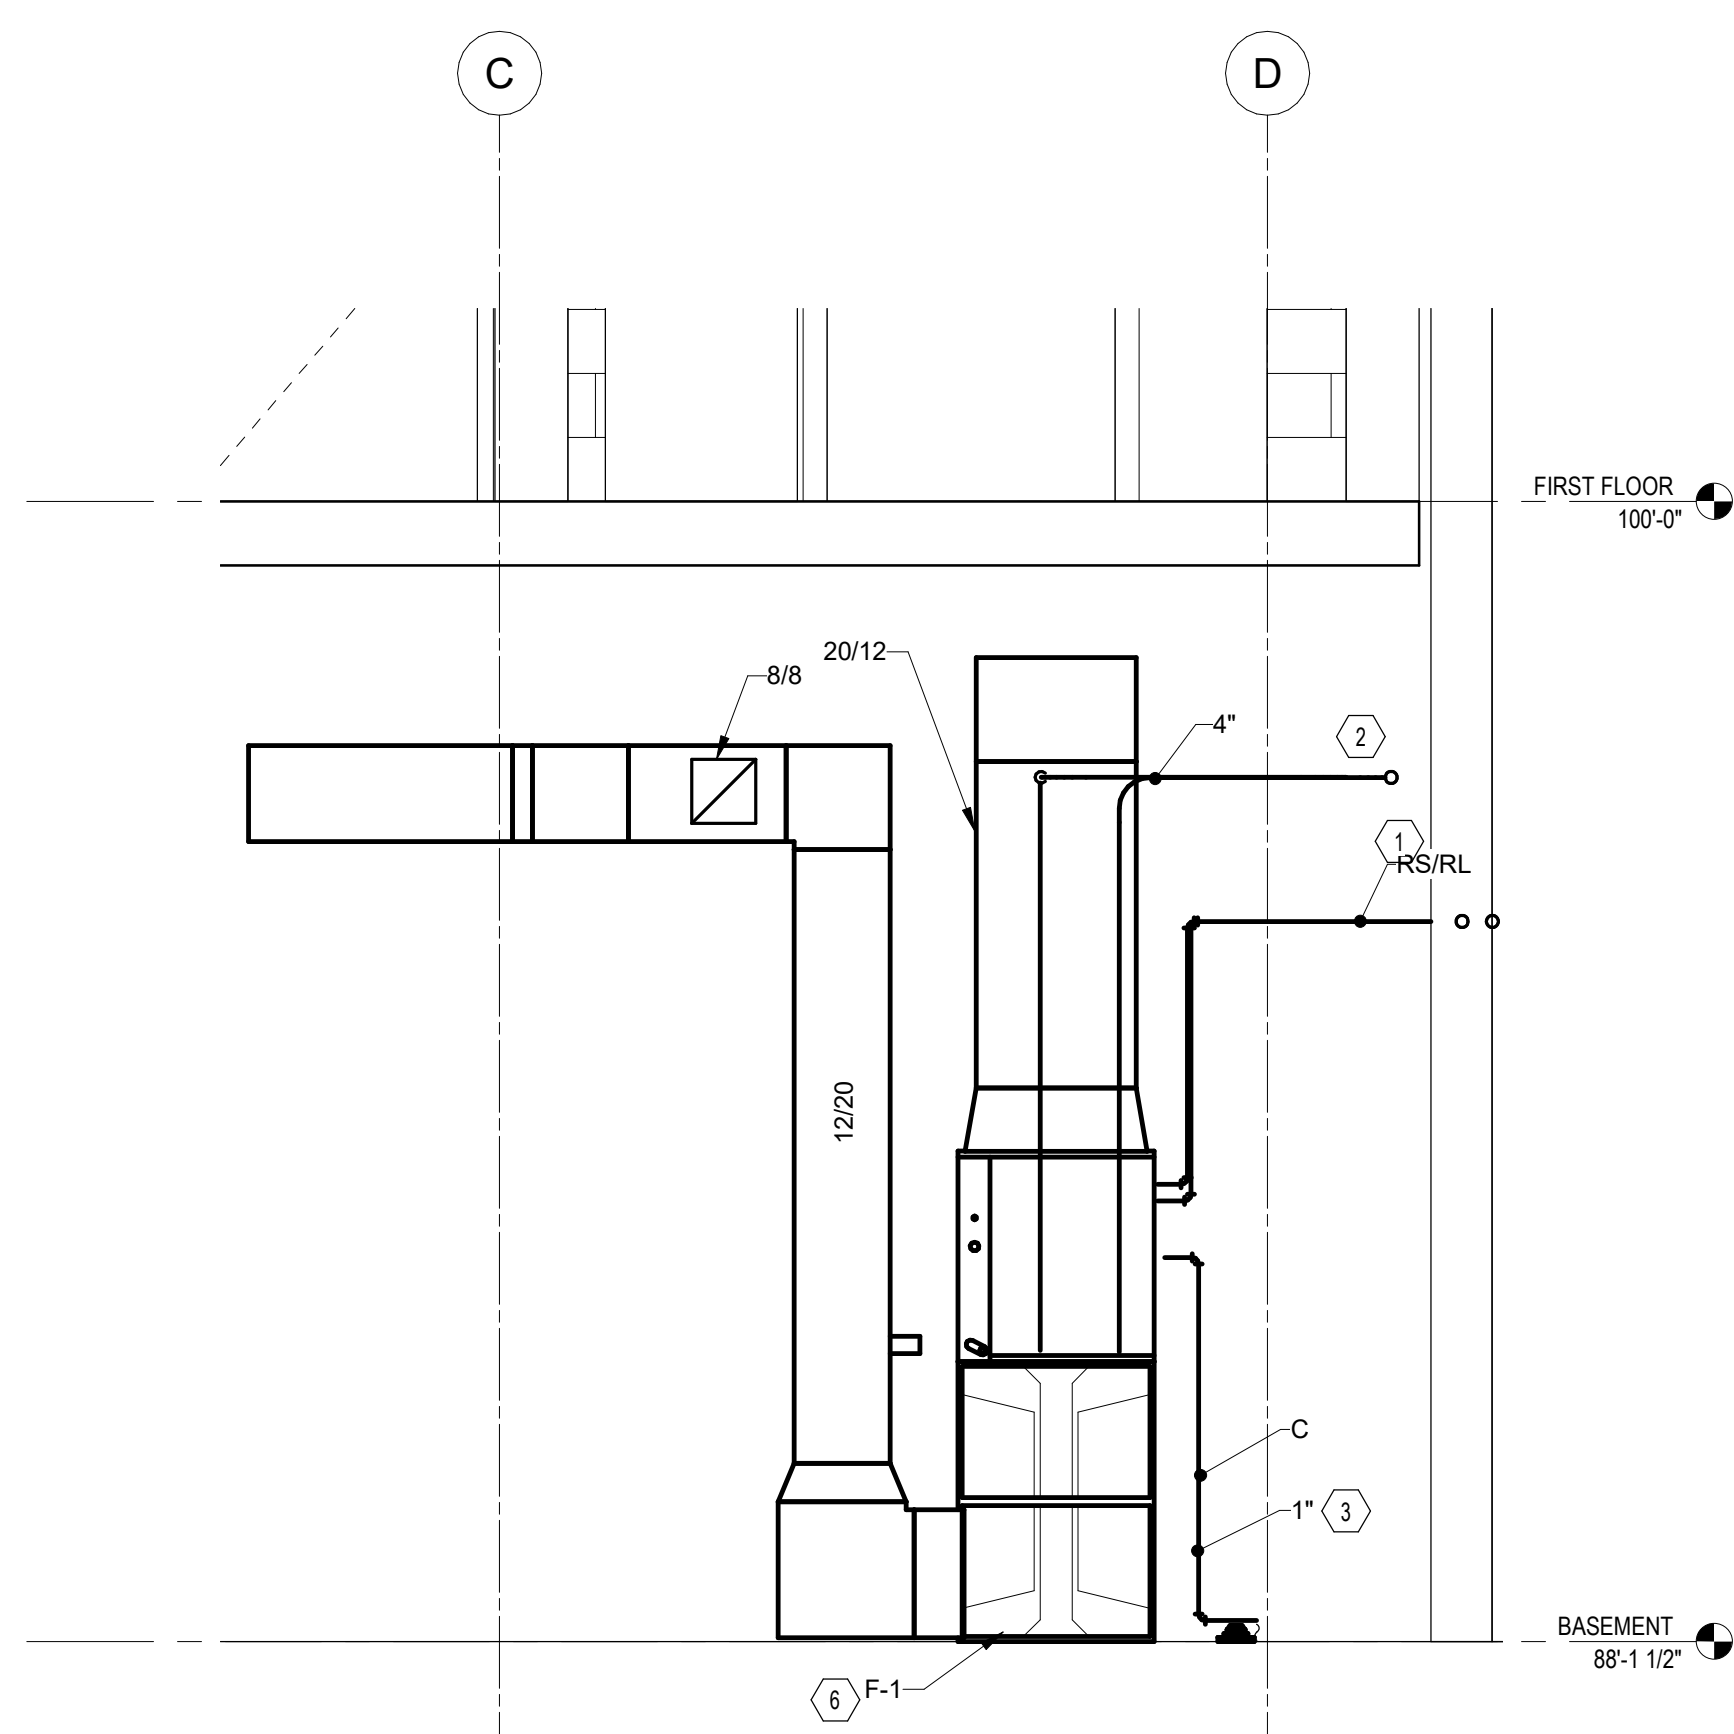

2 PLAN SECTION F-1
1/2" = 1'-0"

CODED NOTES:

1. ROUTE REFRIGERANT PIPING FROM INDOOR EVAPORATOR COILS TO AIR-COOLED CONDENSING UNIT. REFER TO SHEET M-201 FOR CONTINUATION.
2. ROUTE COMBUSTION AIR INTAKE/VENT PIPING TO EXISTING CHASE. REFER TO M-201 FOR CONTINUATION.
3. ROUTE 1" CONDENSATE PIPE TO NEAREST FLOOR DRAIN.
4. PROVIDE 120V MOTORIZED OUTSIDE AIR DAMPER.
5. REFER TO DETAIL 5M-501 FOR TWINNED FURNACE CONFIGURATION.
6. REFER TO DETAIL 4M-501 FOR FURNACE CONFIGURATION.

#	DATE	CHANGE DESCRIPTION


RENOVATION OF HEARTLAND BANK DUBLIN
6500 FRANTZ ROAD
DUBLIN, OH 43017
FOR
HEARTLAND BANK

MOODY-NOLAN
300 SPRUCE STREET
SUITE 300
COLUMBUS, OHIO 43215
PHONE: (614) 461-4664
FAX: (614) 280-8881

DRAWING TITLE:

SECTIONS - MECHANICAL

PROGRESS DRAWING NOT FOR CONSTRUCTION	11/30/2020
	DRAWN BY: Author CHECKED BY: Checker
	20022
	M-301
	FINAL DEVELOPMENT PLAN

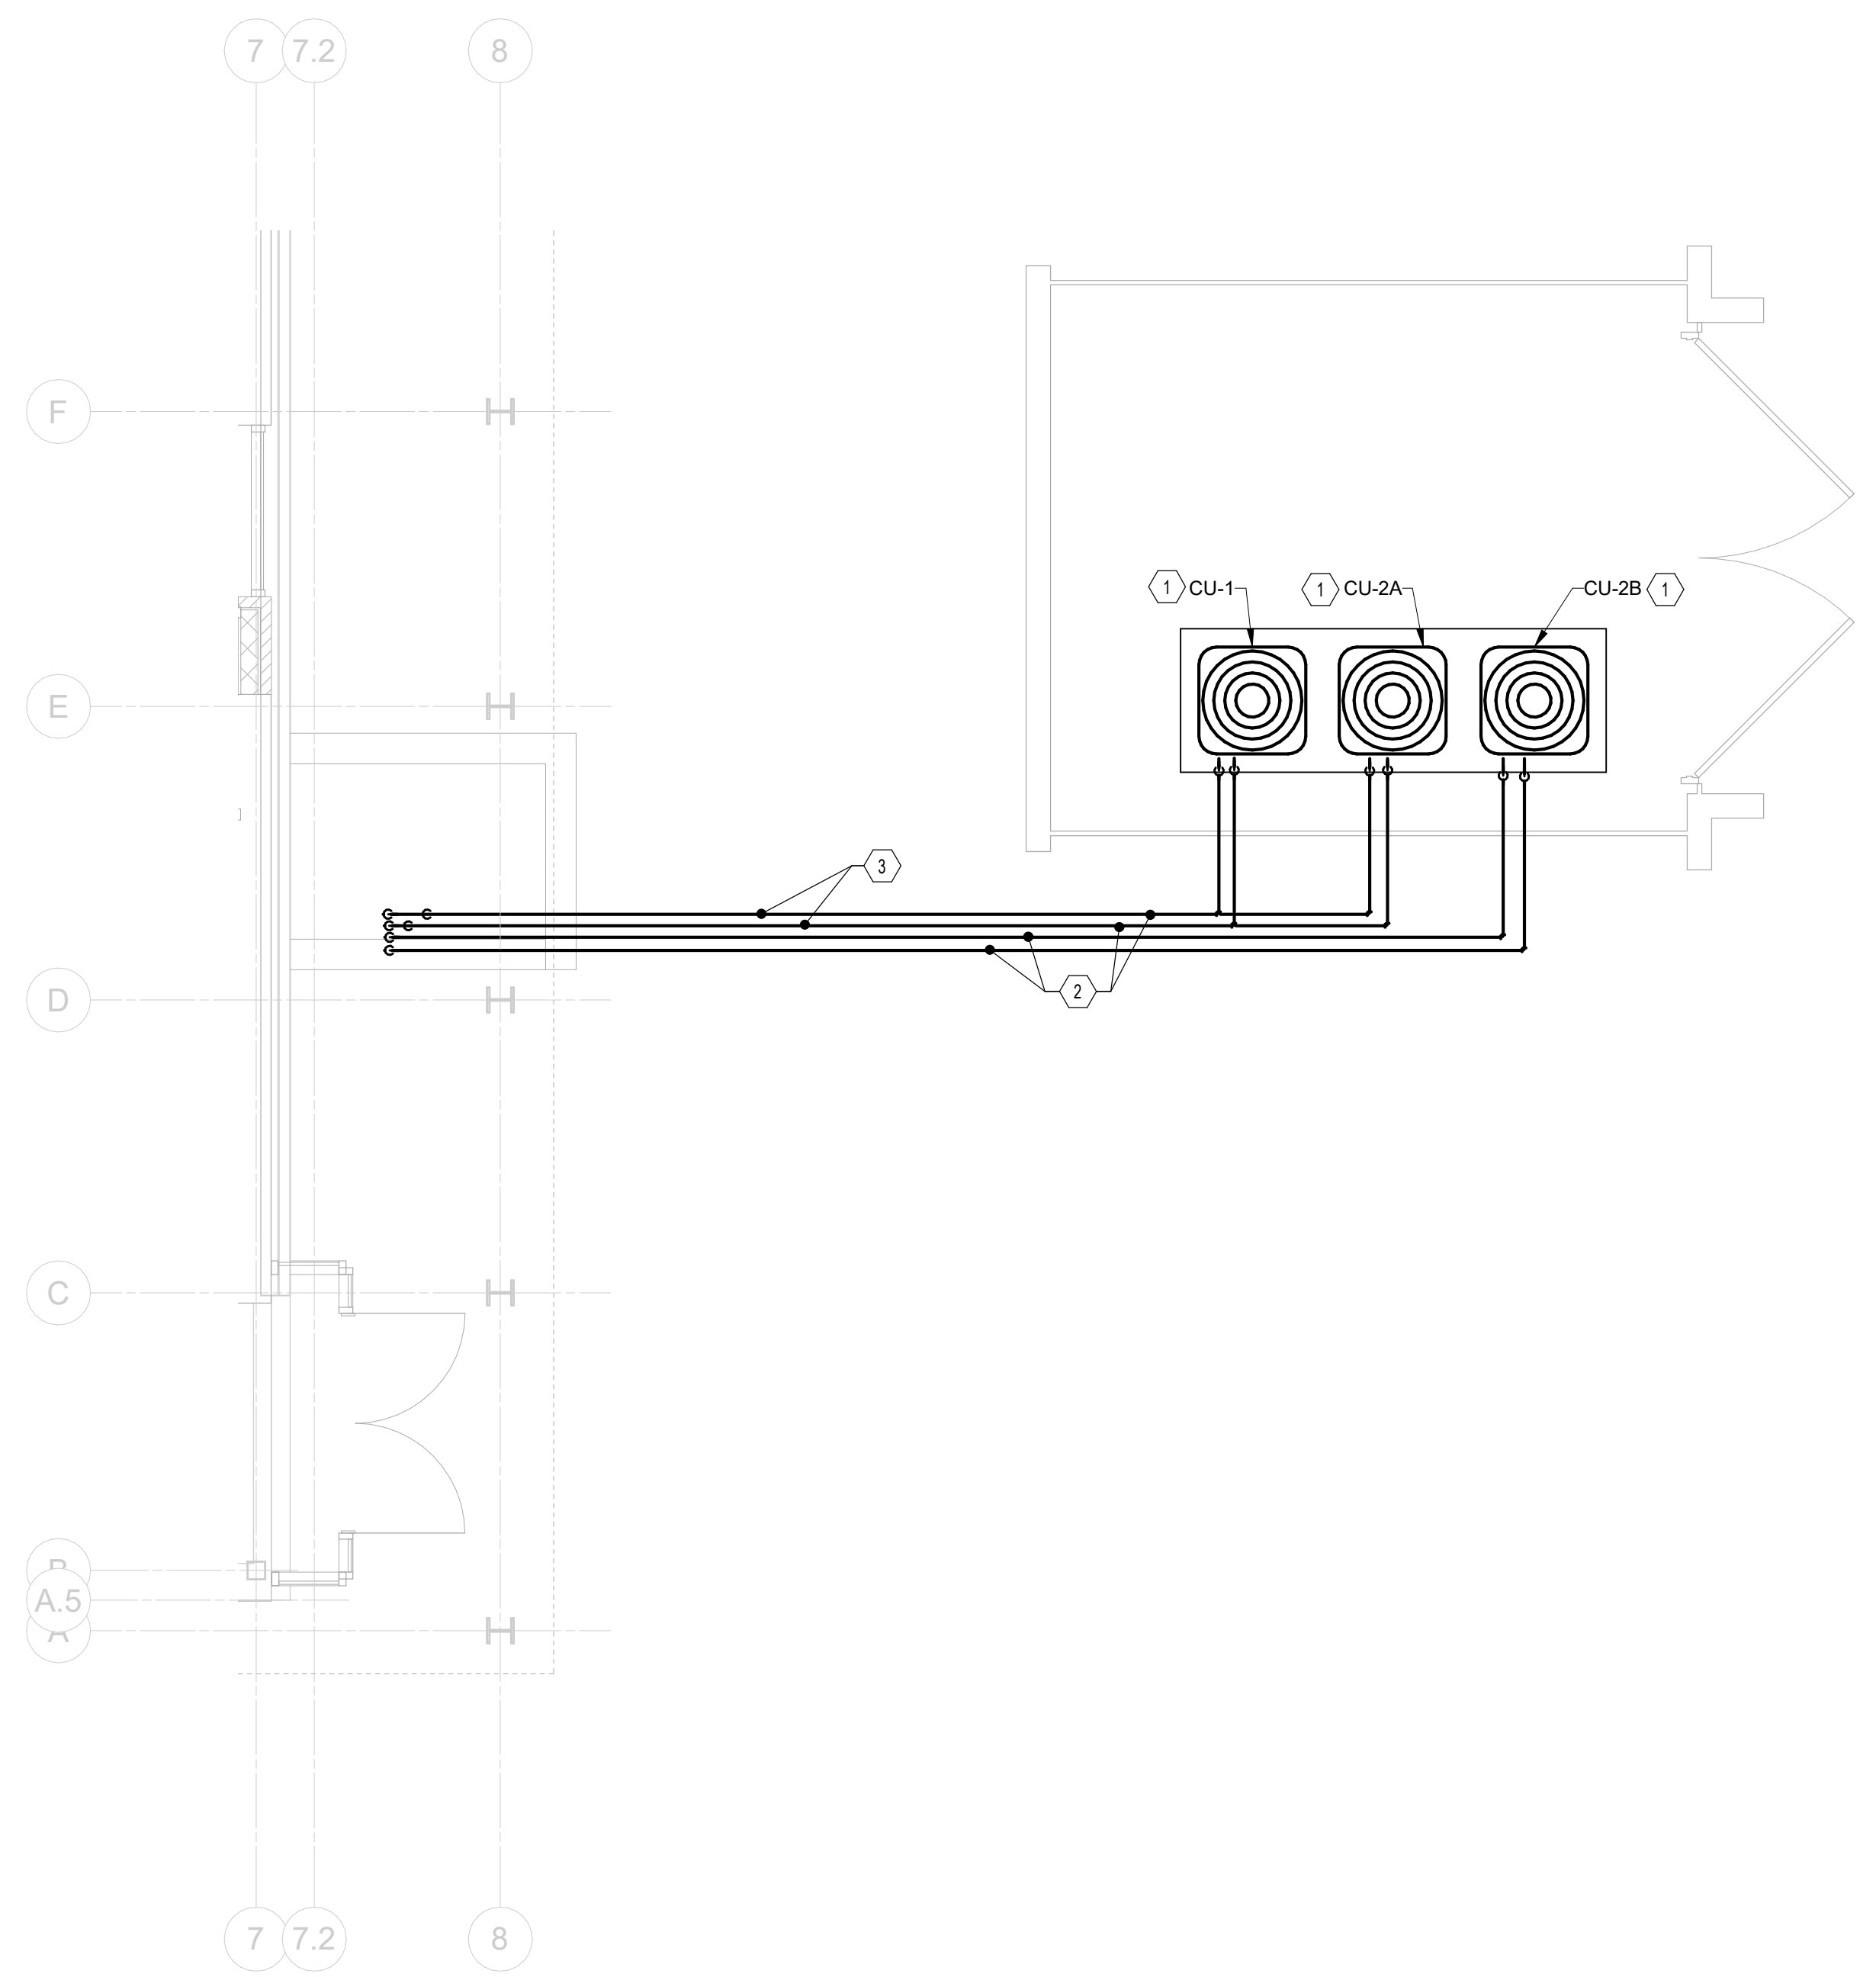

- CODED NOTES:
1. PROVIDE AIR-COOLED CONDENSING UNIT IN MECHANICAL YARD. PROVIDE EXTERIOR EQUIPMENT PAD. REFER TO SCHEDULE SHEET FOR MORE INFORMATION. REFER TO DETAIL 914-502.
 2. ROUTE REFRIGERANT PIPING FROM AIR-COOLED CONDENSING UNIT TO INDOOR EVAPORATOR COILS. INSTALL PER MANUFACTURERS RECOMMENDATIONS. PROVIDE TRENCHING AND EXCAVATION FOR INSTALLATION.
 3. TWO SETS OF REFRIGERANT PIPING STACKED.

1 PLAN EQUIPMENT YARD PLAN - MECHANICAL
1/4" = 1'-0"

#	DATE	CHANGE DESCRIPTION

RENOVATION OF HEARTLAND BANK DUBLIN
6500 FRANTZ ROAD
DUBLIN, OH 43017
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300 SPRUCE STREET
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DRAWING TITLE:
ENLARGED PLANS - MECHANICAL

PROGRESS DRAWING NOT FOR CONSTRUCTION	11/30/2020
	DRAWN BY: Author CHECKED BY: Checker
	20022
	M-401
FINAL DEVELOPMENT PLAN	


DUCT CONSTRUCTION DETAILS

DESCRIPTION	DUCTWORK AS SHOWN ON THE PLANS		DETAILED CONSTRUCTION REQUIRED
	DOUBLE LINE DRAWING	SINGLE LINE DRAWING	
DUCT TAKEOFF FROM 2 IN PRESSURE CLASS OR LESS MAIN			
ELBOW AND SPLIT (2 IN PRESSURE CLASS OR LESS DUCTWORK ONLY)			
ELBOW			
SQUARE OR RECTANGULAR RADIUS ELBOW			
UNEQUAL ELBOWS (2 IN PRESSURE CLASS OR LESS DUCTWORK ONLY)			
DUCT TAKEOFF FROM RECTANGULAR 2 IN PRESSURE CLASS OR LESS MAIN WITH BELLMOUTH FITTING			


NOTES:

- SUPPLY AND RETURN AIR DUCTWORK SHOWN AS INDICATED TO HAVE TURNING VANES.
- DUCT PRESSURES CLASSES
RECTANGULAR DUCT - SUPPLY, RETURN OR EXHAUST TO BE CONSTRUCTED TO MEET SMACNA STANDARDS FOR 2" WG PRESSURE.
- FROM 0 - 35° USE 2 GORE FITTINGS, 35 - 71° USE 3 GORE FITTINGS, 72 - 90° USE 5 GORE FITTINGS. FOR ELBOWS WHICH EXCEED 90°, ADD ONE GORE FOR EACH ADDITIONAL 18° FOR FITTING CONSTRUCTION. NOTE: 90° ELBOW DEPICTED REQUIRES 5 GORE FITTING CONSTRUCTION.


1 DETAIL DUCT CONSTRUCTION
NTS

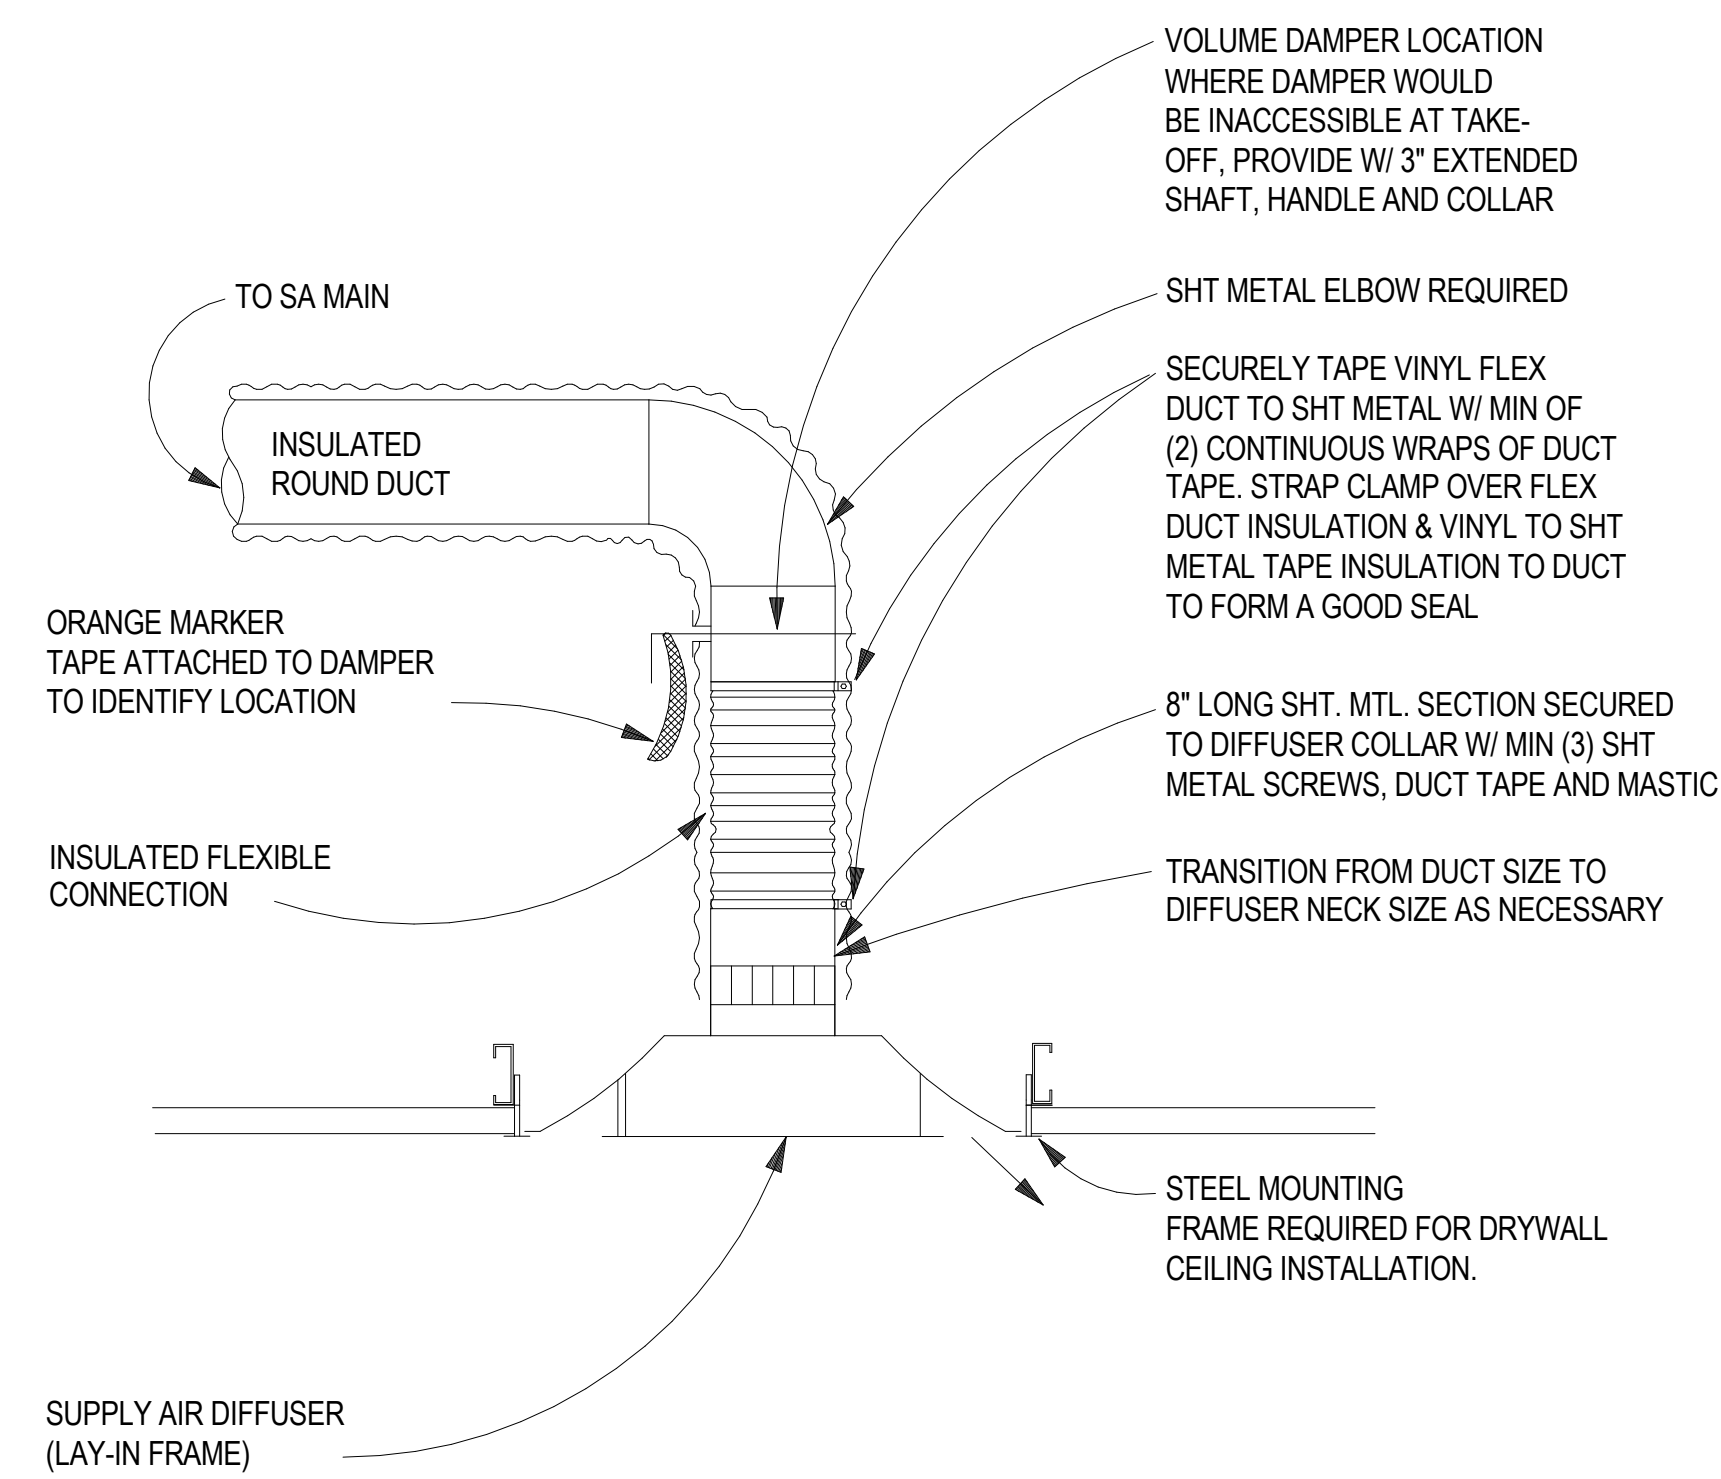


2 DETAIL DIFFUSER MOUNTING
NTS

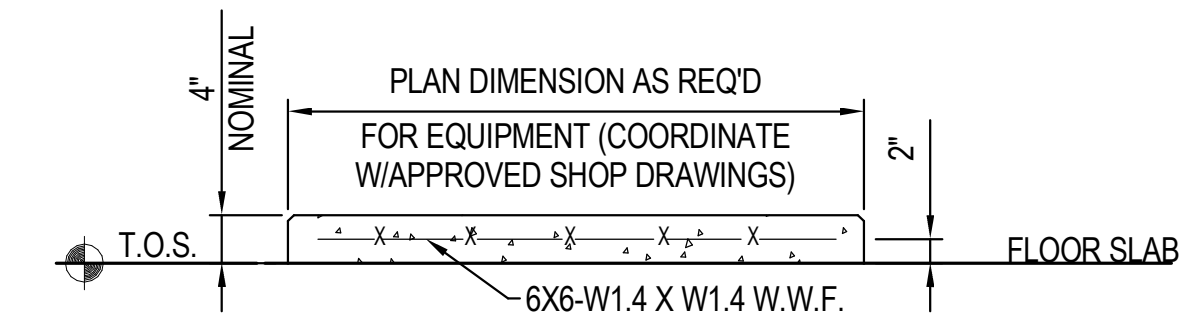

3 DETAIL INTERIOR EQUIPMENT PAD
NTS

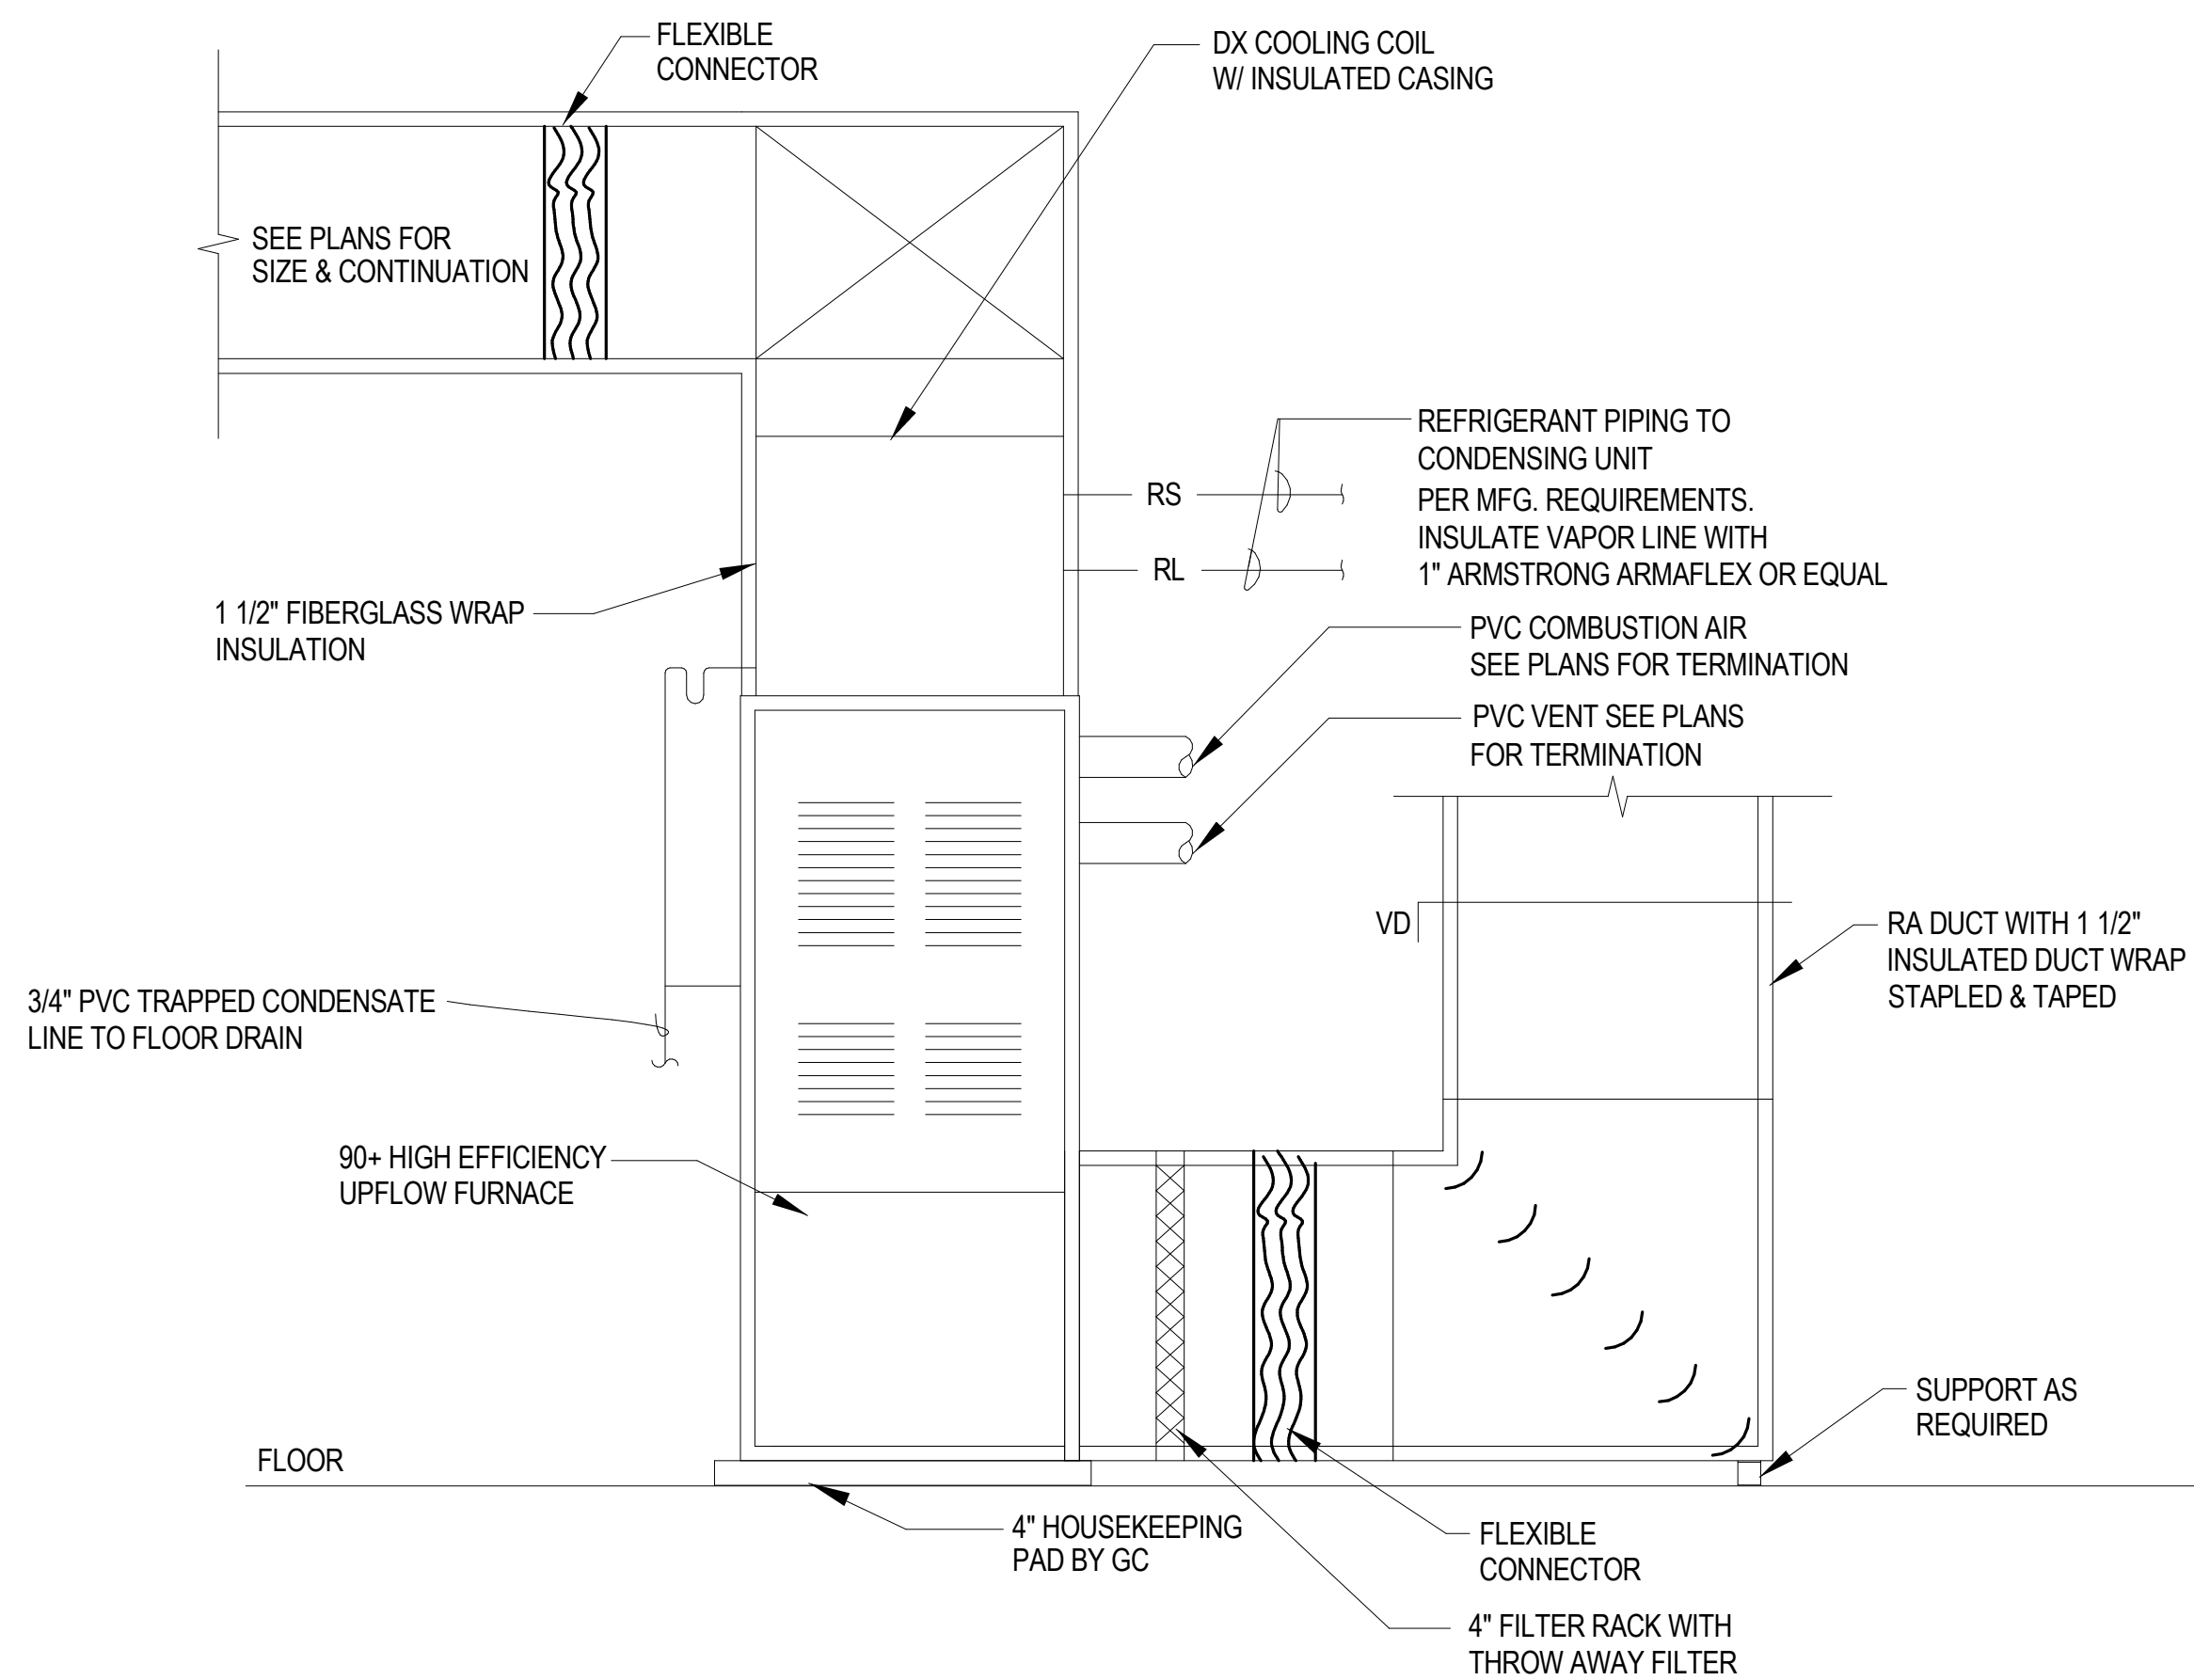

4 DETAIL FURNACE (F-1)
NTS

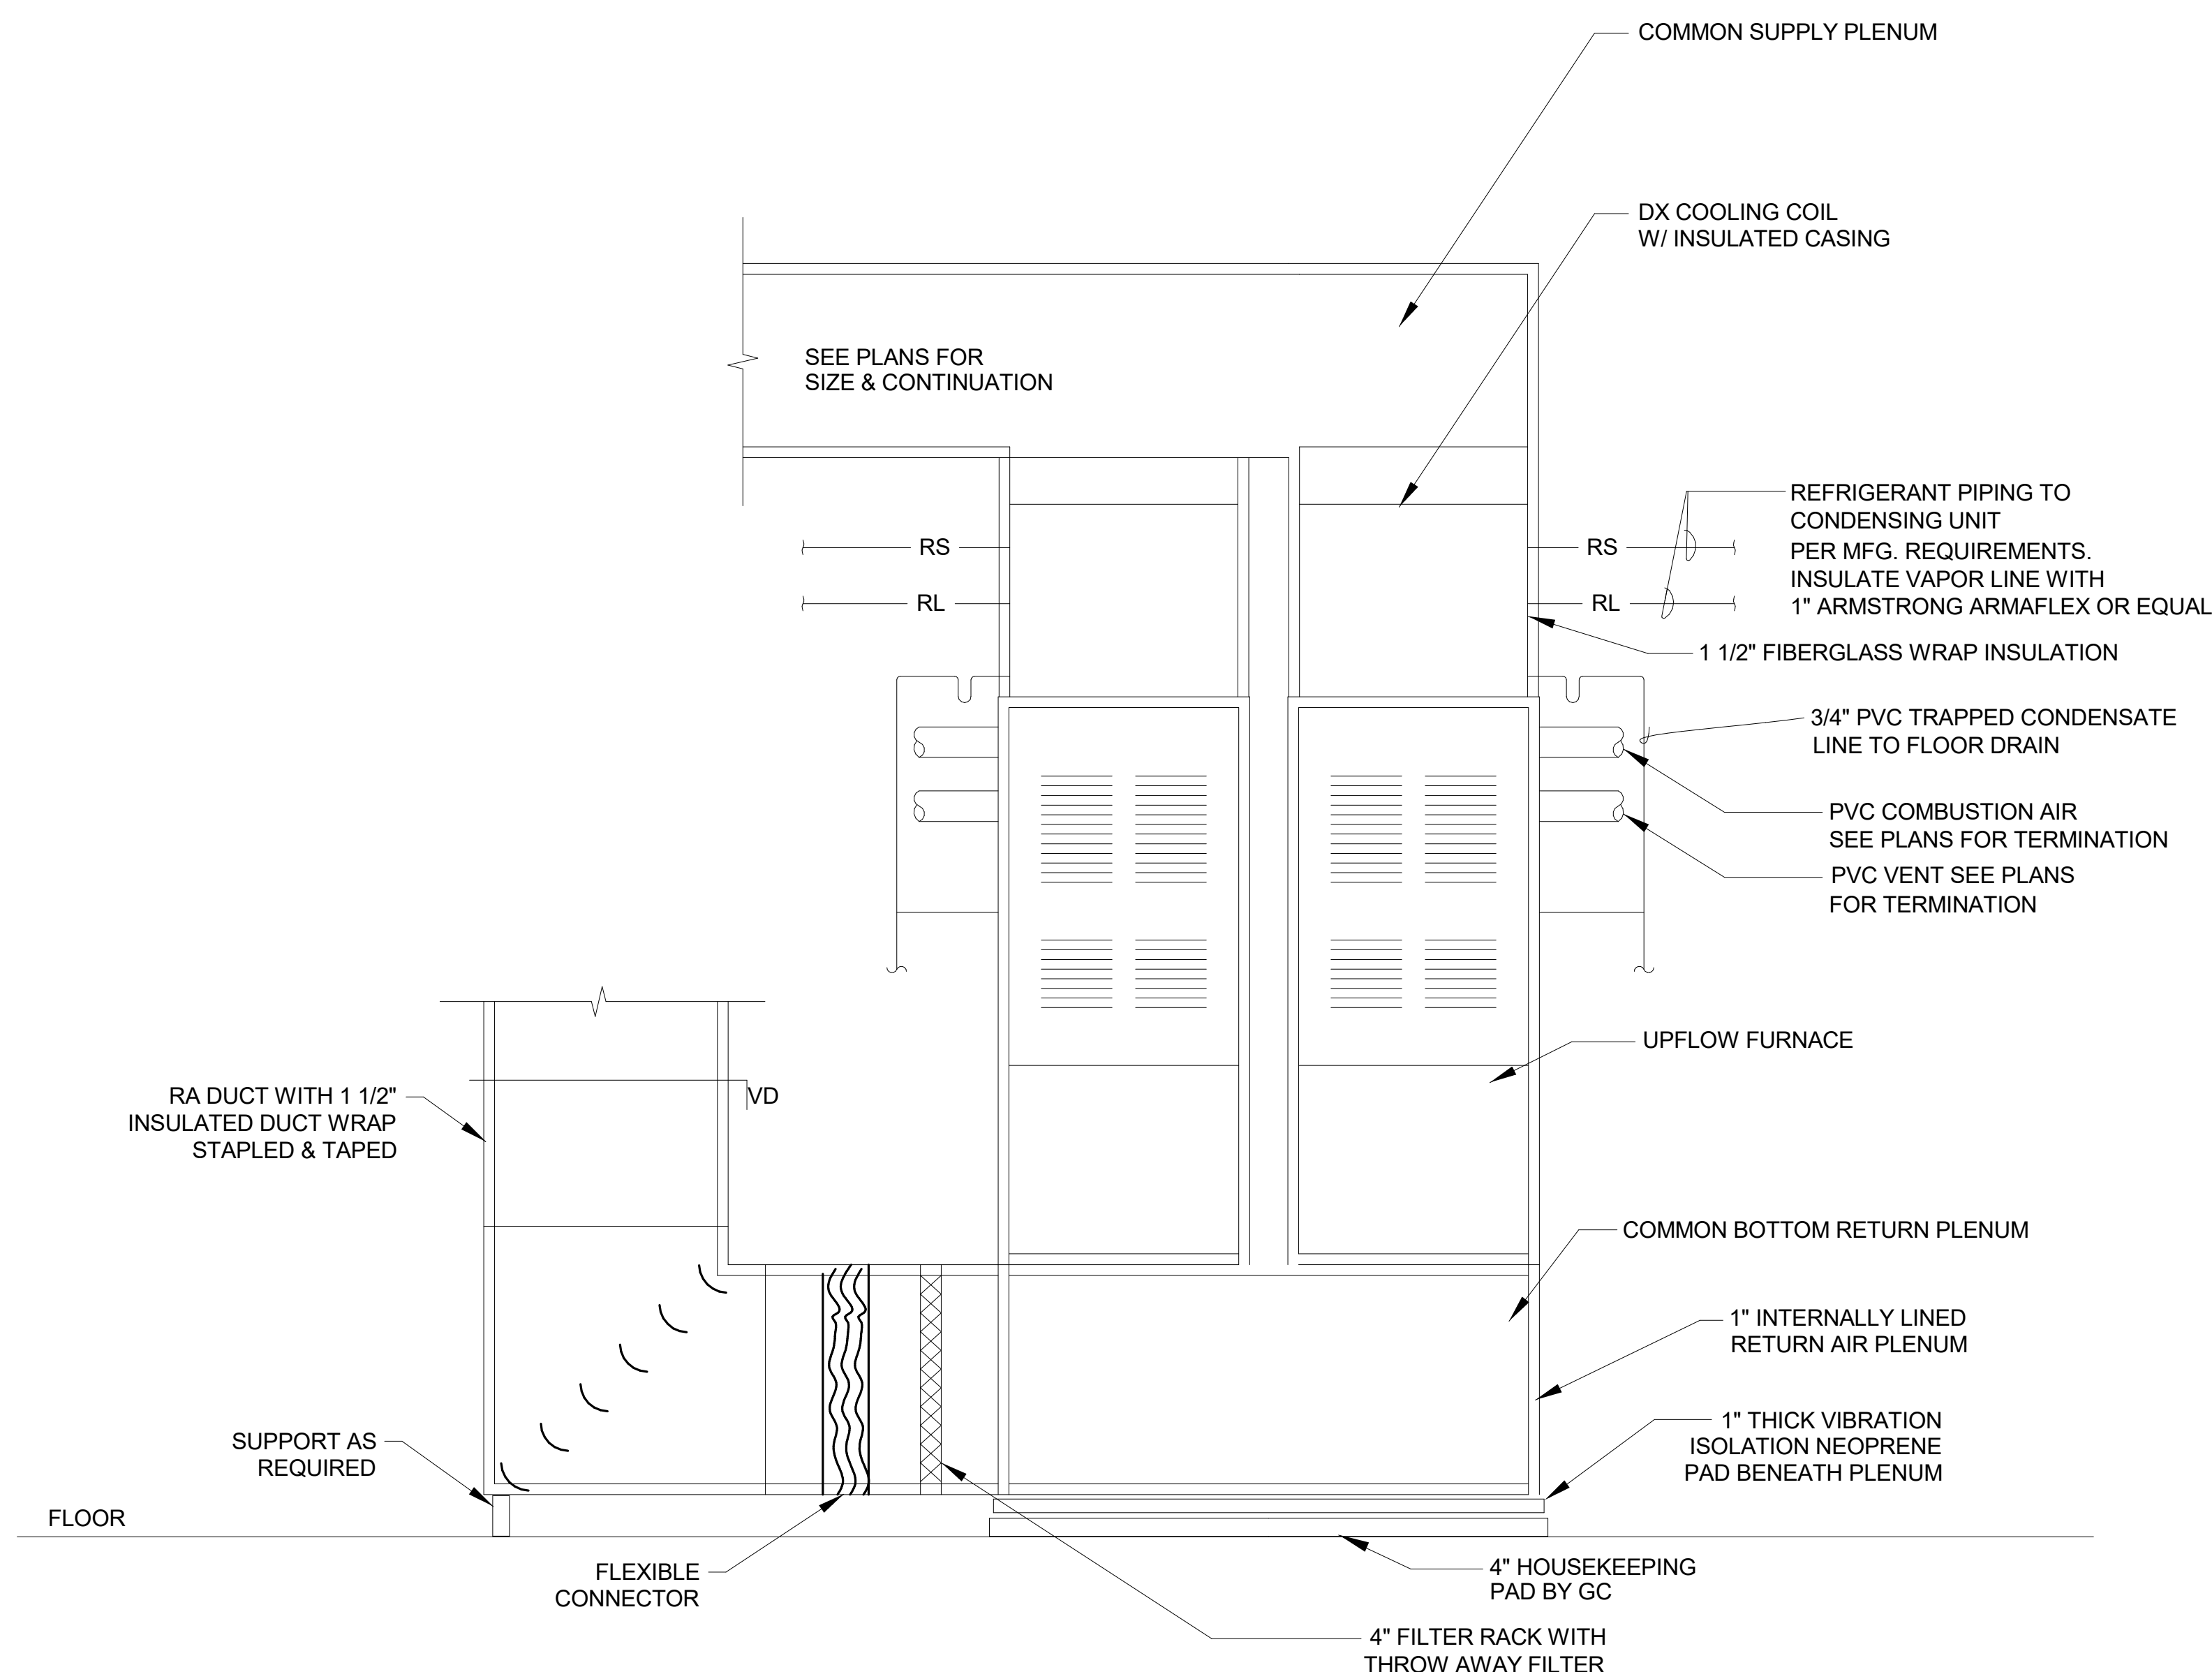

5 DETAIL TWINNED FURNACES (F-2)
NTS

#	DATE	CHANGE DESCRIPTION


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MOODY-NOLAN
300 SPRUCE STREET
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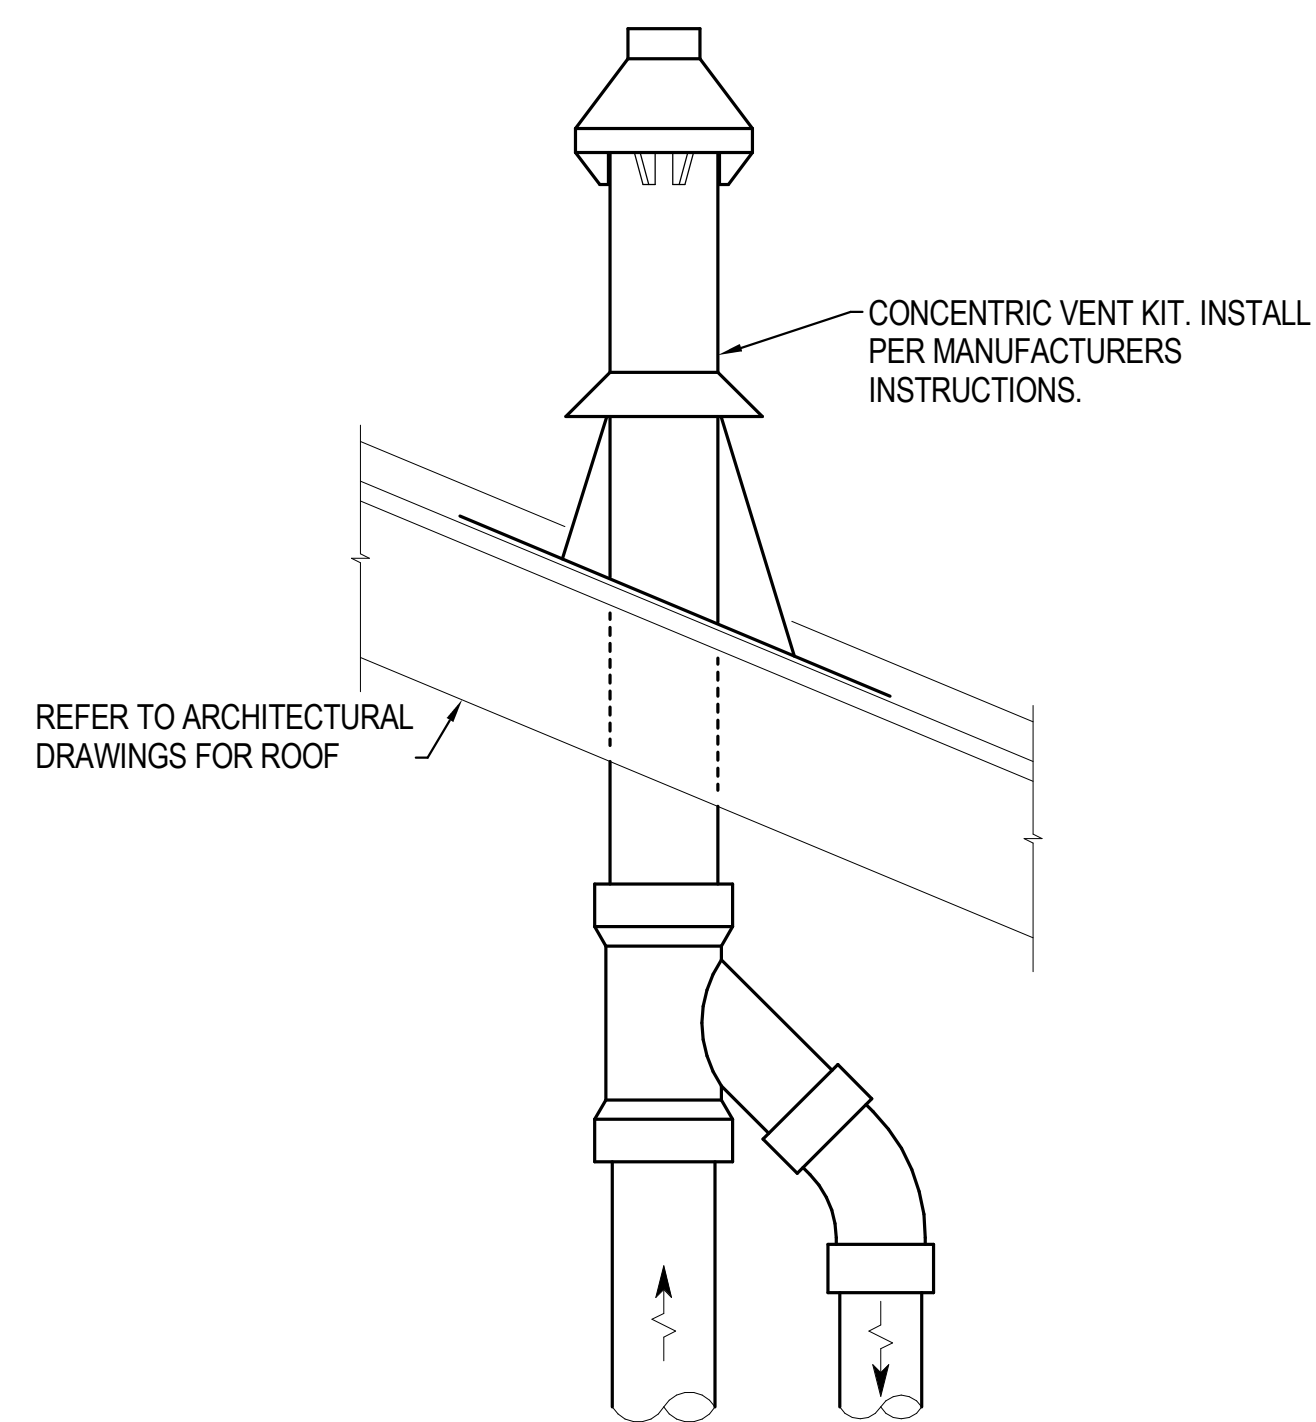
DRAWING TITLE:

DETAILS - MECHANICAL


PROGRESS DRAWING NOT FOR CONSTRUCTION	11/30/2020
	DRAWN BY: Author CHECKED BY: Checker
	20022
M-501	
FINAL DEVELOPMENT PLAN	




1 **DETAIL** DETAIL - CEILING MOUNTED EXHAUST FAN
NTS

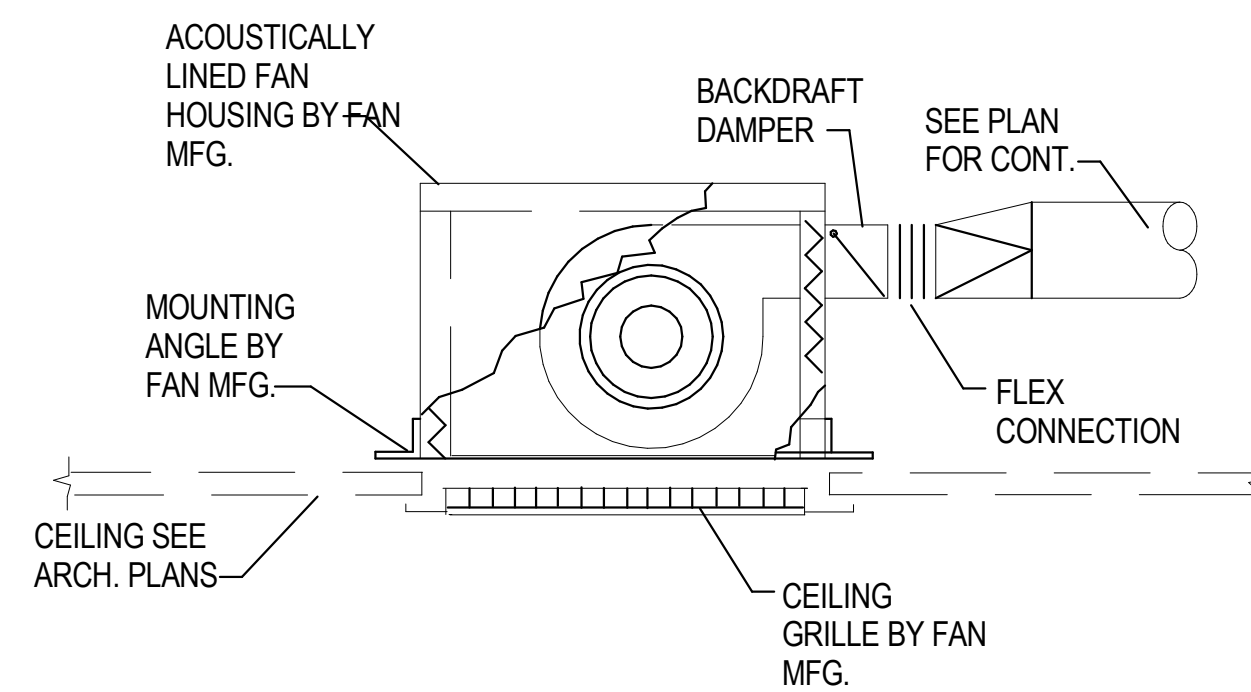


2 **DETAIL** DETAIL - FURNACE VENTING
NTS

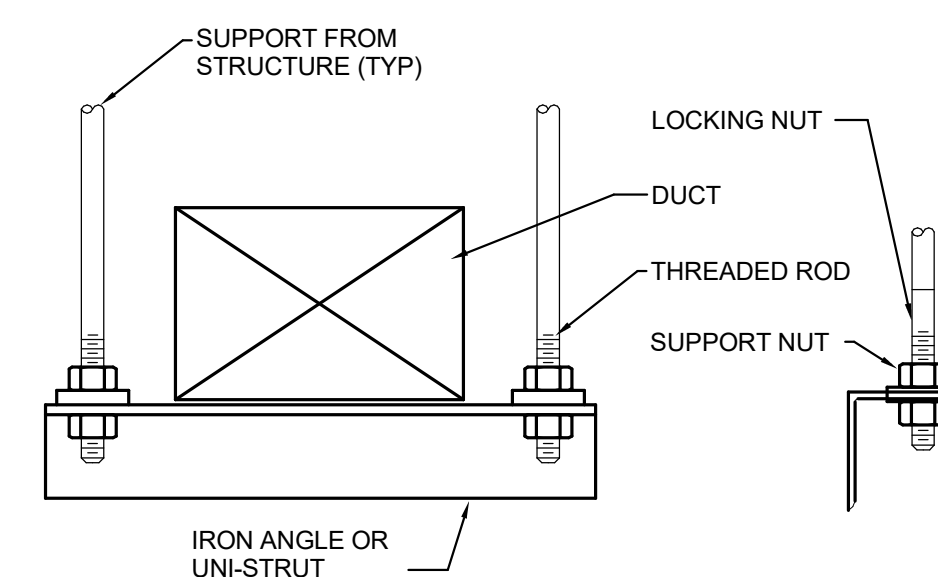


3 **DETAIL** DETAIL - TYPICAL DUCT SUPPORT
NTS

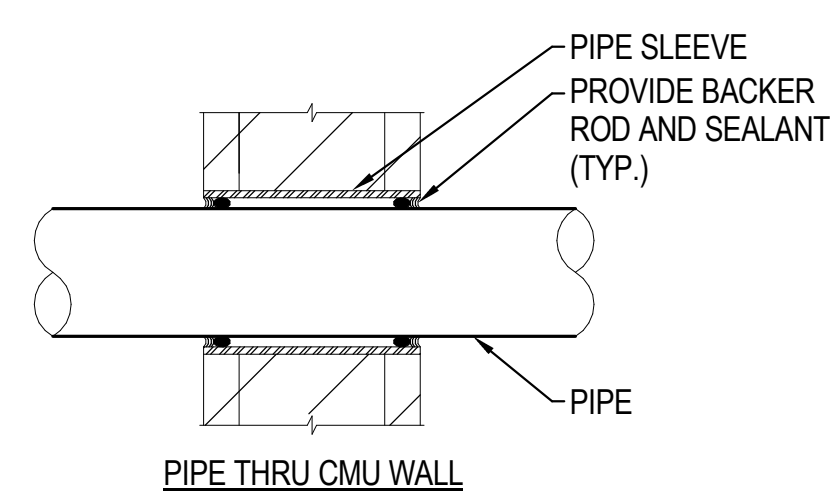

4 **DETAIL** DETAIL - TYPICAL WALL PENETRATION
NTS

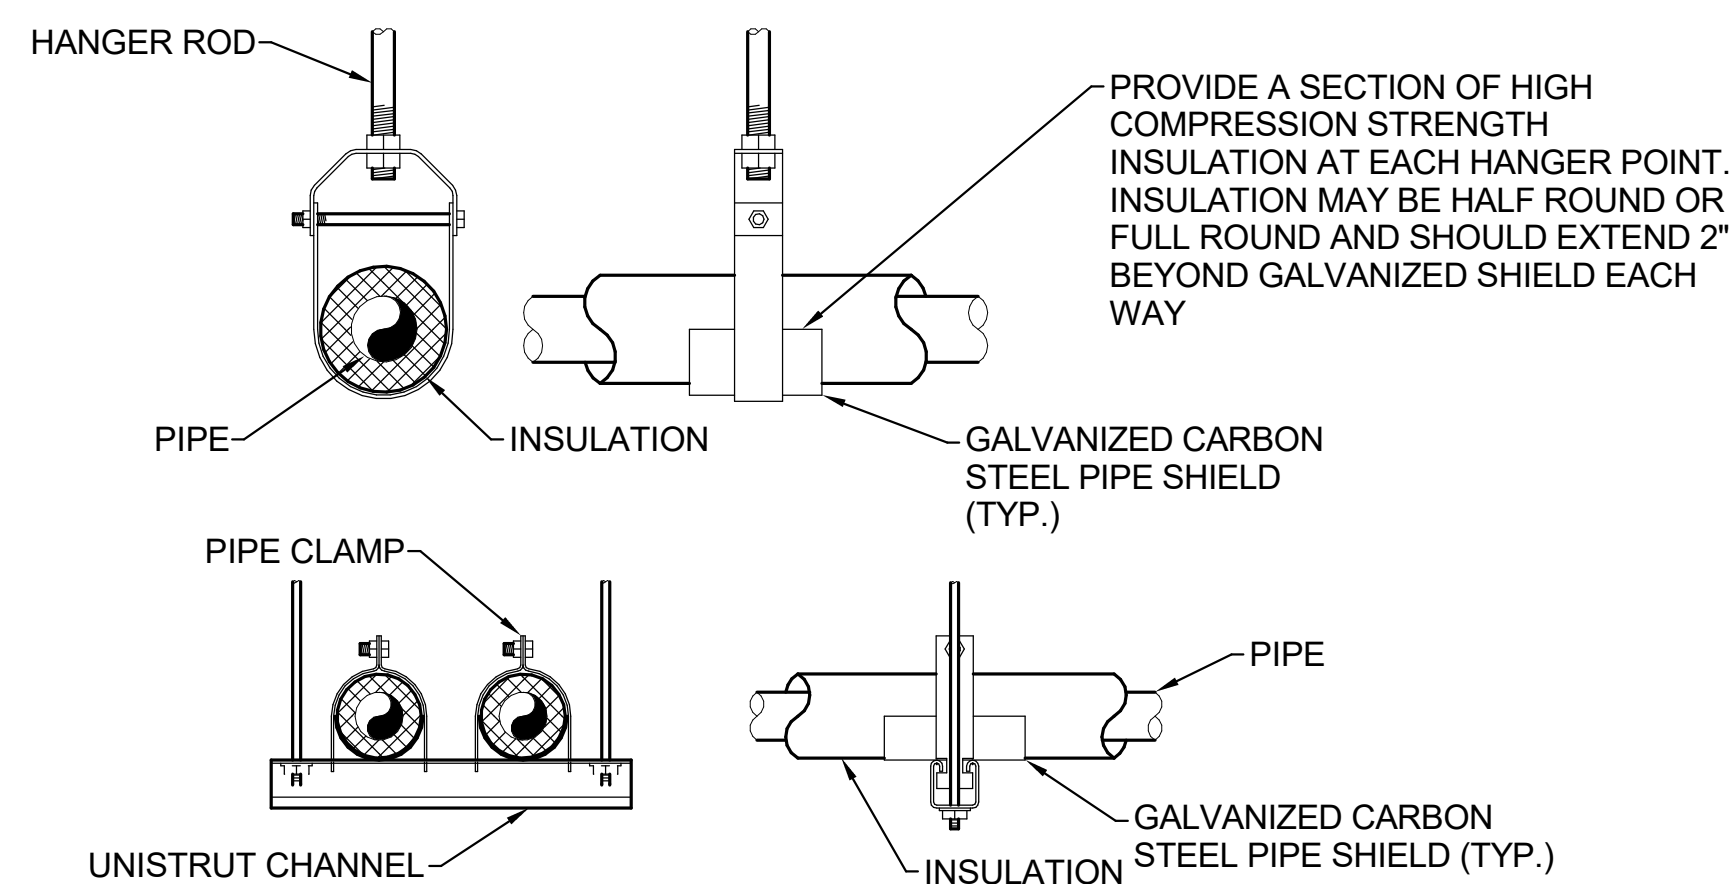


5 **DETAIL** DETAIL - TYPICAL PIPE HANGER
NTS

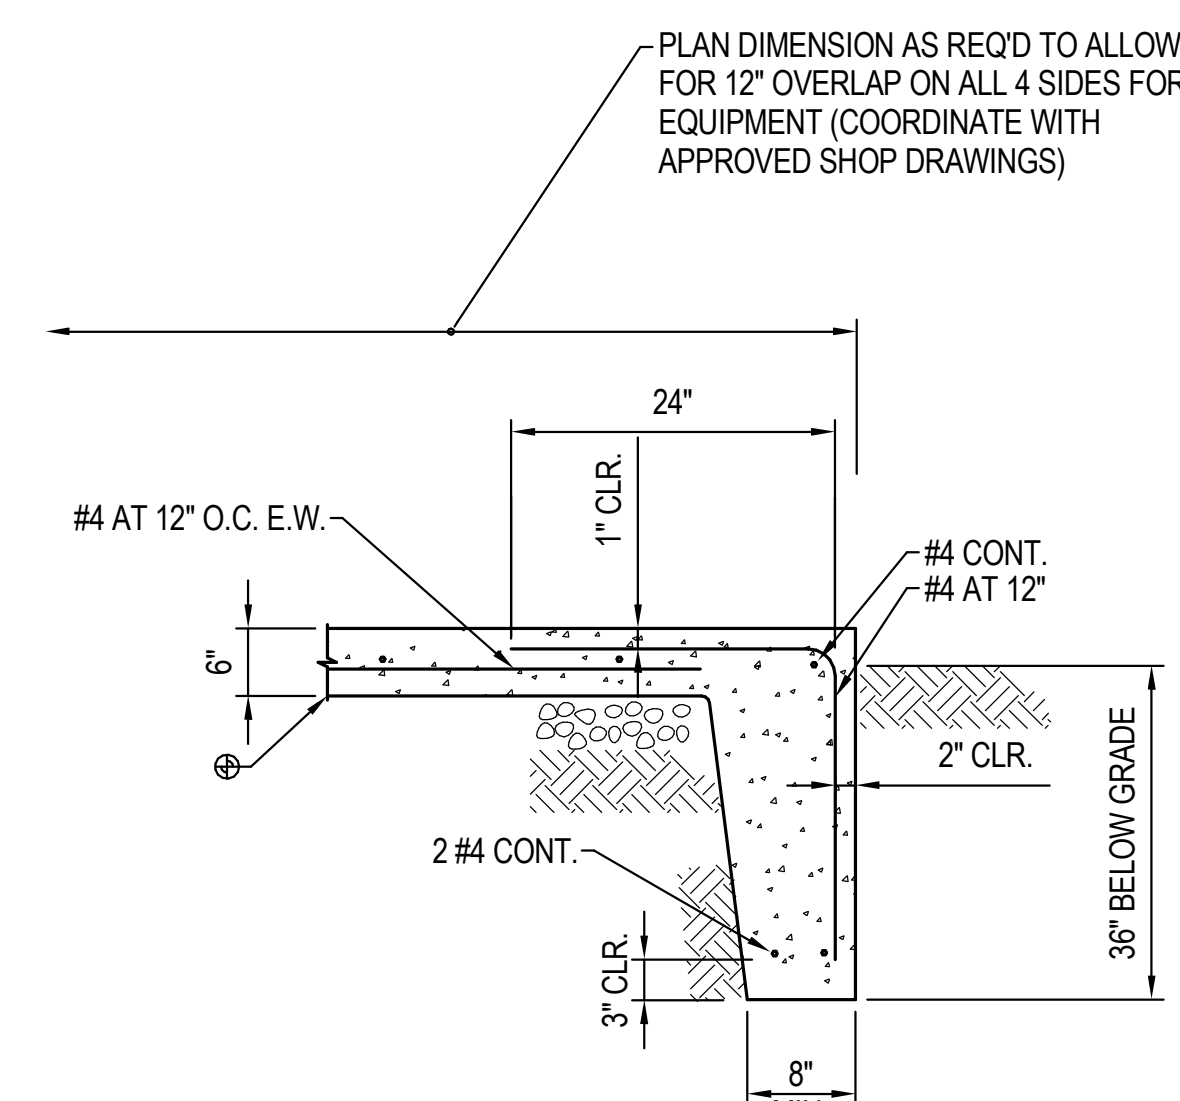

6 **DETAIL** DETAIL - EXTERIOR CONCRETE PAD
NTS

NOTE: "A" DENOTES 0 TO 2 IN BETWEEN THE FIRST 2 VENTS. THIRD VENT (AND FOURTH VENT, IF USED) MUST BE 36 IN. AWAY.

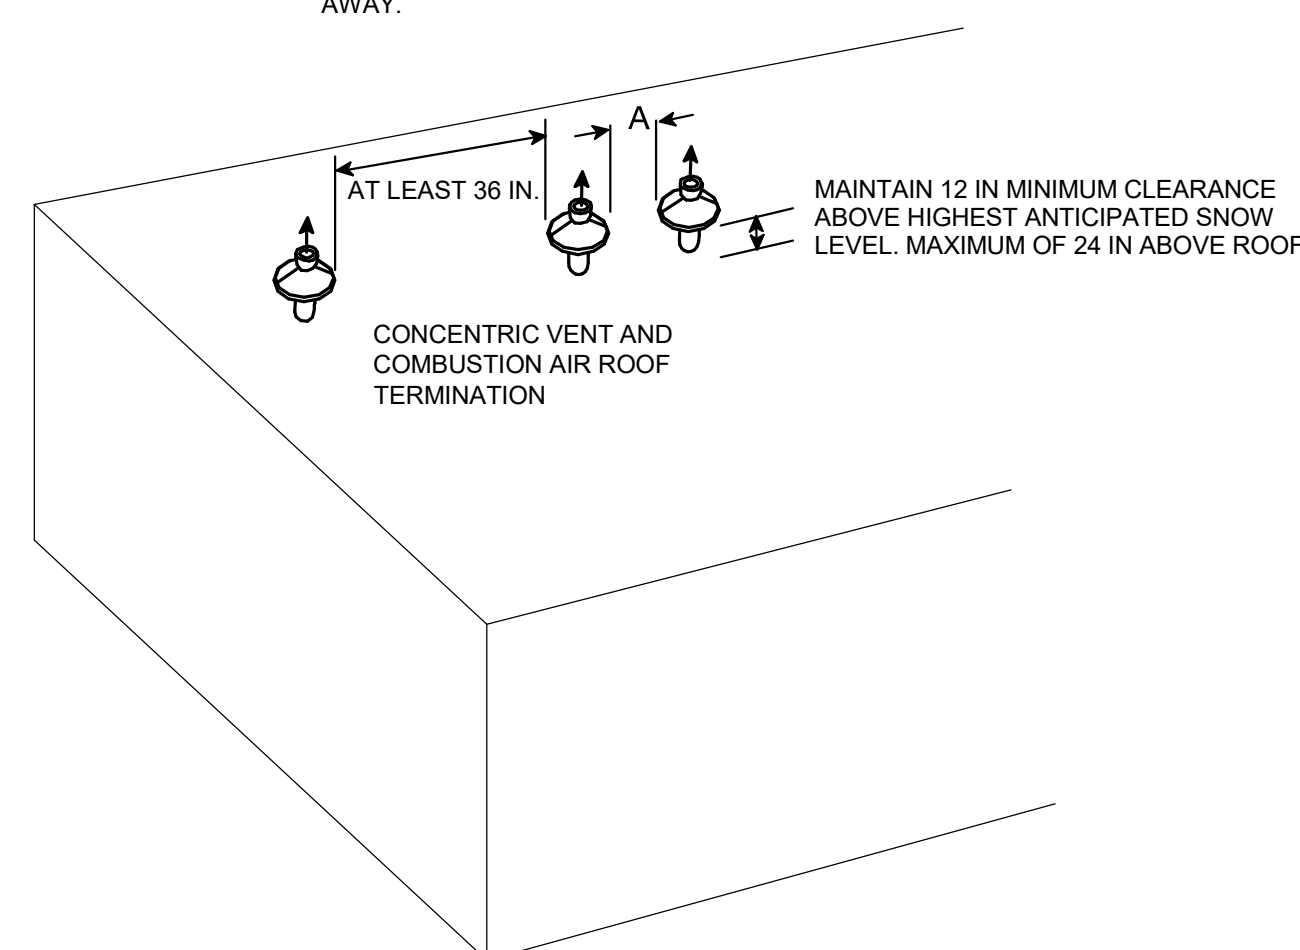

7 **DETAIL** DETAIL - CONCENTRIC VENT CLEARANCES
NTS

#	DATE	CHANGE DESCRIPTION

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DUBLIN, OH 43017
FOR
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MOODY-NOLAN
300 SPRUCE STREET
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DRAWING TITLE:

DETAILS - MECHANICAL

PROGRESS DRAWING NOT FOR CONSTRUCTION	11/30/2020
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	20022
	M-502
	FINAL DEVELOPMENT PLAN

NATURAL GAS FURNACES																										
EQUIPMENT BASED ON BRYANT UNLESS NOTED OTHERWISE																										
REFRIGERANT TO BE R-410A																										
FURNACE & BLOWER												COOLING COIL				CONDENSING UNITS							REMARKS			
TAG	SERVICE	MODEL NO.	TYPE	INPUT (MBH)	OUTPUT (MBH)	AFUE %	CFM	MIN VENT AIR CFM	ESP (IN WC)	BLOWER HP	VOLT	PHASE	MODEL NO.	EAT °F		COOLING CAPACITY (MEH)		UNIT TAG	MODEL NO.	MCA	VOLT	PHASE		AHR/ SEER	WEIGHT (LBS)	SOUND POWER (dBA)
														DB	WB	TOTAL	SENSIBLE									
F-1	BASEMENT	926TA66120V24	DIRECT-VENT FIXED-CAPACITY	120	117	96.0	1,400	250	0.5	1	115	1	CNPVP4324ALA	80	67	41.5	31.67	CU-1	113ANAD420N0	23.5	208	1	14.5	188	78	PROGRAMMABLE THERMOSTAT WITH AUTO CHANGE-OVER, CRANKCASE HEATER, FILTER DRIER, LIQUID-LINE SOLENOID VALVE, LOW-AMBIENT CONTROLLER, WINTER START CONTROL, MERV-13 FILTER
F-2	BASEMENT	926TA66120V24	DIRECT-VENT FIXED-CAPACITY	120	117	96.0	1,400	210	0.5	1	115	1	CNPVP4324ALA	80	67	41.5	31.67	CU-2A	113ANAD420N0	23.5	208	1	14.5	188	78	PROGRAMMABLE THERMOSTAT WITH AUTO CHANGE-OVER, CRANKCASE HEATER, FILTER DRIER, LIQUID-LINE SOLENOID VALVE, LOW-AMBIENT CONTROLLER, WINTER START CONTROL, MERV-13 FILTER, TWINNING KIT MODEL KGATW0801HS
		926TA66120V24	DIRECT-VENT FIXED-CAPACITY	120	117	96.0	1,400																			

SEQUENCE OF OPERATIONS

SPLIT SYSTEM SEQUENCE

THERE ARE 2 SPLIT SYSTEM SERVING THE BUILDING. EACH SPLIT SYSTEM CONSISTS OF AN INDOOR FURNACE UNIT WITH EVAPORATOR COIL (F-1 THRU F-2) AND AN OUTDOOR CONDENSING UNIT (CU-1, CU-2A, CU-2B).

THE INDOOR FURNACE FAN SPEED SHALL BE CONTROLLED BY THE SPLIT-SYSTEM CONTROLLER'S BUILT-IN CONTROL SYSTEM. AT ANY TIME THE BUILDING IS IN OCCUPIED MODE, THE OUTDOOR AIR DAMPER SHALL OPEN AND THE FAN SHALL OPERATE CONTINUOUSLY.

EACH SPLIT-SYSTEM SHALL CYCLE ITS REFRIGERANT CIRCUIT IN HEATING OR COOLING MODE DEPENDENT UPON SPACE DEMAND FROM THE ZONE SPACE THERMOSTAT TO MAINTAIN SETPOINT (HEATING: 70 DEGREES, ADJUSTABLE; COOLING: 75 DEGREES, ADJUSTABLE).

IF A ZONE FURNACE IS OPERATING IN THE HEATING MODE, THE GAS FURNACE SHALL BE ENABLED AND THE OUTDOOR CONDENSING UNIT SHALL SHUT DOWN. THE GAS FURNACE SHALL MODULATE ITS BURNER DEPENDENT UPON SPACE DEMAND FROM THE ZONE SPACE THERMOSTAT TO MAINTAIN SETPOINT (70 DEGREES, ADJUSTABLE).

THE SPLIT-SYSTEM FACTORY CONTROLLER SHALL OPERATE ON ITS OWN CONTROLS AND SAFETIES. UPON ACTIVATION OF A DUCT MOUNTED SMOKE DETECTOR, THE UNIT SHALL SHUT DOWN.

ELECTRIC UNIT HEATER SEQUENCE

RECESSED CEILING MOUNTED ELECTRIC UNIT HEATERS (EUH-1,2,3) SERVE THE VESTIBULE AND STAIRWELL SPACES IN THE BUILDING.

ELECTRIC UNIT HEATER SHALL ACTIVATE UPON A SIGNAL FROM ITS INTEGRAL THERMOSTAT WHEN THE SPACE TEMPERATURE DROPS BELOW SETPOINT (70 DEGREES, ADJUSTABLE).

JANITOR CLOSET EXHAUST FAN SEQUENCE

EXHAUST FAN EF-3 SHALL RUN CONTINUOUSLY.

RESTROOM EXHAUST FAN SEQUENCE (EF-1,2,4)

EXHAUST FANS EF-1,2, AND 4 SHALL BE TIED INTO THE LIGHT SWITCH. UPON ACTIVATION OF THE LIGHT SWITCH, THE FAN SHALL RUN.

VAV ZONE DIFFUSER SEQUENCE

THE VAV ZONE DIFFUSERS SHALL BE CONTROLLED BY A REMOTE THERMOSTAT. CONFERENCE ROOM 103 INCLUDES A MASTER VAV DIFFUSER AND DRONE VAV DIFFUSER. ALL OTHER SPACES WITH ZONE DIFFUSERS ONLY CONSIST OF A MASTER VAV ZONE DIFFUSER.

SUMMER

THE VAV ZONE DIFFUSER(S) SHALL BE CONTROLLED BY A DIFFUSER MOUNTED TEMPERATURE SENSOR IN COOLING MODE. A WALL MOUNTED ASSEMBLY WILL PROVIDE SET-POINT ADJUSTMENT.

THE VAV ZONE DIFFUSER(S) SHALL BE NORMALLY FULLY OPEN. UPON A DROP IN SPACE TEMPERATURE BELOW THE COOLING SETPOINT (75°F SUMMER (ADJ.)) THE DAMPER(S) SHALL MODULATE CLOSED UNTIL THE SPACE TEMPERATURE IS SATISFIED. UPON A RISE IN SPACE TEMPERATURE ABOVE THE COOLING SETPOINT (75°F SUMMER (ADJ.)), THE DAMPER(S) SHALL MODULATE OPEN UNTIL THE SPACE TEMPERATURE IS SATISFIED.

WINTER

THE VAV ZONE DIFFUSER(S) SHALL BE CONTROLLED BY A WALL MOUNTED ASSEMBLY IN HEATING MODE AND SHALL PROVIDE SET-POINT ADJUSTMENT.

THE VAV ZONE DIFFUSER(S) SHALL BE NORMALLY FULLY OPEN. UPON A RISE IN SPACE TEMPERATURE ABOVE THE HEATING SETPOINT (70°F (ADJ.)) THE DAMPER(S) SHALL MODULATE CLOSED UNTIL THE SPACE TEMPERATURE IS SATISFIED. UPON A DROP IN SPACE TEMPERATURE BELOW THE HEATING SETPOINT (70°F (ADJ.)), THE DAMPER(S) SHALL MODULATE OPEN UNTIL THE SPACE TEMPERATURE IS SATISFIED.

FC - FORWARD CURVE															FANS							
TAG	LOCATION	SERVICE	FAN TYPE	WHEEL TYPE	CFM	RPM	ESP (IN WC)	MOTOR			MAX SONES	MANUFACTURER AND MODEL	WEIGHT (LBS)	REMARKS								
								WATTS	PH	VOLT												
EF-1,2	RESTROOMS	EXHAUST	CENTRIFUGAL	FC	100	784	0.5	24	1	115	3.5	GREENHECK SP-A390-VG	32	PROVIDE WITH DISCONNECT SWITCH, GRAVITY BACKDRAFT DAMPER, ROUND DUCT CONNECTION STANDARD GRILLE								
EF-3	JAN CLST.	EXHAUST	CENTRIFUGAL	FC	50	935	0.549	6	1	115	2.0	GREENHECK SP-80-VG	12	PROVIDE WITH DISCONNECT SWITCH, GRAVITY BACKDRAFT DAMPER, ROUND DUCT CONNECTION STANDARD GRILLE								
EF-4	RESTROOM	EXHAUST	CENTRIFUGAL	FC	70	935	0.487	6	1	115	2.0	GREENHECK SP-80-VG	19	PROVIDE WITH DISCONNECT SWITCH, GRAVITY BACKDRAFT DAMPER, ROUND DUCT CONNECTION STANDARD GRILLE, PITCHED ROOF CAP WBUILT-IN BIRDSCREEN								

DIFFUSER, REGISTER, AND GRILLES												
TAG	SERVICE	NECK SIZE (IN)	TYPE	DAMPER	FACE SIZE	MATERIAL	FINISH	PATTERN	MANUFACTURER	MODEL NO.	CONTROL POWER (V)	REMARKS
D1	CEILING SUPPLY AIR	SEE PLANS	SQUARE LAY-IN	YES	24x24	STEEL	WHITE	4-WAY	ACCUTHERM	ADV	120	ALL
D2	CEILING SUPPLY AIR	SEE PLANS	SQUARE LAY-IN	NO	24x24	STEEL	WHITE	4-WAY	TITUS	OMNI	-	-
D3	CEILING SUPPLY AIR	SEE PLANS	SLOT DIFFUSER LAY-IN	YES	-	ALUMINUM	WHITE	2-WAY	ACCUTHERM	ADVL	120	ALL
D4	CEILING SUPPLY AIR	SEE PLANS	SLOT DIFFUSER LAY-IN	NO	-	ALUMINUM	WHITE	1-WAY	TITUS	ML-38	-	4
D5	CEILING SUPPLY AIR	SEE PLANS	SLOT DIFFUSER LAY-IN	NO	-	ALUMINUM	WHITE	1-WAY	TITUS	ML-38	-	5
G1	RETURN/ TRANSFER AIR	SEE PLANS	GRILLE SURFACE	NO	NECK SIZE +1.75"	STEEL	WHITE	-	TITUS	350RL	-	-
G2	RETURN AIR	SEE PLANS	GRILLE LAY-IN	NO	NECK SIZE +1.75"	STEEL	WHITE	-	TITUS	350RL	-	-

NOTES:
 1. PROVIDE WITH WALL MOUNTED THERMOSTAT.
 2. PROVIDE WITH 115V TO 24V (ONBOARD) TRANSFORMER FOR MASTER.
 3. 2-SLOT, 2-WAY AIRFLOW, 60" LENGTH. PROVIDE WITH INSULATED PLENUM.
 4. 2-SLOT, 60" LENGTH. PROVIDE WITH TITUS MP9-38 INSULATED PLENUM.
 5. 2-SLOT, 48" LENGTH. PROVIDE WITH TITUS MP9-38 INSULATED PLENUM.

LOUVER SCHEDULE											
EQUIPMENT BASED ON GREENHECK UNLESS NOTED OTHERWISE											
TAG	MODEL	LOCATION	SERVICE	CFM	TYPE	MATERIAL	DIMENSION HxWxD (IN)	FREE FACE AREA (SF)	MAX SP DROP	FREE AREA VEL (FPM)	REMARKS
L-1	ESD-635	MECH ROOM	INTAKE	460	STATIONARY DRAINABLE	ALUM	14x26x6	1.1	0.03	420	ALL

NOTES: 1. PROVIDE WITH BIRDSCREEN.

ELECTRIC UNIT HEATER SCHEDULE									
EQUIPMENT BASED ON QMARK UNLESS NOTED OTHERWISE									
UNIT DATA				HEATING ELEMENTS					REMARKS
TAG	SERVICE	MODEL	TYPE	CFM	AMPS	TOTAL KW	VOLTS	PHASE	
EUH1	VESTIBULE 101	CDF-548	RECESSED	300	19.2	4	208	1	ALL
EUH2	STAIRS 105	CDF-548	RECESSED	300	19.2	4	208	1	ALL
EUH3	STAIRS 111	CDF-548	RECESSED	300	19.2	4	208	1	ALL

NOTES:
 1. PROVIDE INTEGRAL THERMOSTAT.
 2. PROVIDE INTEGRAL DISCONNECT SWITCH.
 3. PROVIDE RECESSED ENCLOSURE.

#	DATE	CHANGE DESCRIPTION

RENOVATION OF HEARTLAND BANK DUBLIN
 6500 FRANTZ ROAD
 DUBLIN, OH 43017
 FOR
HEARTLAND BANK

MOODY-NOLAN
 300 SPRUCE STREET
 SUITE 300
 COLUMBUS, OHIO 43215
 PHONE: (614) 461-4664
 FAX: (614) 280-8881

DRAWING TITLE:

SCHEDULES - MECHANICAL

PROGRESS DRAWING NOT FOR CONSTRUCTION	11/30/2020	
	DRAWN BY: Author	CHECKED BY: Checker
	20022	
	M-601	
FINAL DEVELOPMENT PLAN		

ABBREVIATIONS	
NOTE: NOT ALL ABBREVIATIONS MAY BE USED.	
(A)	EXISTING TO BE ABANDONED
(D)	EXISTING TO BE DEMOLISHED
(E)	EXISTING TO REMAIN
(F)	FUTURE
(R)	EXISTING TO BE RELOCATED
A	AMPERE
AC	ALTERNATING CURRENT OR AIR CONDITIONER
AFF	ABOVE FINISHED FLOOR
AFG	ABOVE FINISHED GRADE
AIC	AMPS INTERRUPTING CAPACITY
ANNC	ANNUNCIATOR
AWG	AMERICAN WIRE GAUGE
BPS	BOLTED PRESSURE SWITCH
C	CONDUIT
CB	CIRCUIT BREAKER
CCTV	CLOSED CIRCUIT TELEVISION
CKT	CIRCUIT
CM	CONSTRUCTION MANAGER
DC	DIRECT CURRENT
DP	DISTRIBUTION PANELBOARD
DTT	DOUBLE TWIN TUBE
EB	ELECTRONIC BALLAST
EC	ELECTRICAL CONTRACTOR
EM	EMERGENCY
EMT	ELECTRICAL METAL TUBING
EWC	ELECTRIC WATER COOLER
FA	FIRE ALARM
FLA	FULL LOAD AMPS
G	GROUND
GC	GENERAL TRADES CONTRACTOR
GFCI	GROUND FAULT CIRCUIT INTERRUPTER
GEN	GENERATOR
HOA	HAND-OFF-AUTOMATIC
HP	HORSEPOWER
HPC	HIGH PRESSURE CONTACT SWITCH
HZ	HERTZ
IG	ISOLATED GROUND
IMC	INTERMEDIATE METAL CONDUIT
INCD	INCANDESCENT
KVA	KILOVOLT AMPERE
KW	KILOWATT
LTG	LIGHTING OR LIGHT
LRA	LOCKED ROTOR AMPS
MCA	MINIMUM CIRCUIT AMPACITY
MCB	MAIN CIRCUIT BREAKER
MCC	MOTOR CONTROL CENTER
MDP	MAIN DISTRIBUTION PANEL
MLO	MAIN LUGS ONLY
MOCP	MAXIMUM OVERCURRENT PROTECTION
MSB	MAIN SWITCHBOARD
MH	METAL HALIDE
MTS	MANUAL TRANSFER SWITCH
NAC	NOTIFICATION APPLIANCE CIRCUIT
NC	NORMALLY CLOSED
NO	NORMALLY OPEN
NF	NON-FUSED
OCC	OCCUPANCY
PA	PUBLIC ADDRESS
PB	PULL BOX OR PUSH BUTTON
PVC	POLYVINYL CHLORIDE (PLASTIC PIPE)
PWR	POWER
RECP	RECEPTACLE
STP	SHIELDED, TWISTED PAIR
TC	TIME CLOCK
TRT	TRIPLE TUBE
TYP	TYPICAL
UNO	UNLESS NOTED OTHERWISE
UTP	UNSHIELDED, TWISTED PAIR
V	VOLT
W	WATT
WAP	WIRELESS ACCESS POINT
WH	WATTHOUR
WP	WEATHERPROOF, NEMA 3R UNO
XFMR	TRANSFORMER
Z	IMPEDANCE
∅	PHASE

LIGHTING SYMBOLS	
NOTE: NOT ALL SYMBOLS MAY BE USED.	
	GENERAL PURPOSE LUMINAIRE: REFER TO LUMINAIRE SCHEDULE FOR ADDITIONAL INFORMATION
	GENERAL PURPOSE LUMINAIRE ON EMERGENCY POWER: REFER TO LUMINAIRE SCHEDULE FOR ADDITIONAL INFORMATION
	GENERAL PURPOSE DUAL BALLAST LUMINAIRE ONE BALLAST ON EMERGENCY POWER: REFER TO LUMINAIRE SCHEDULE FOR ADDITIONAL INFORMATION
	ROUND LUMINAIRE: REFER TO LUMINAIRE SCHEDULE FOR ADDITIONAL INFORMATION
	WALL WASHER: REFER TO LUMINAIRE SCHEDULE FOR ADDITIONAL INFORMATION
	WALL MOUNTED LUMINAIRE: REFER TO LUMINAIRE SCHEDULE FOR ADDITIONAL INFORMATION
	WALL MOUNTED DECORATIVE LUMINAIRE: REFER TO LUMINAIRE SCHEDULE FOR ADDITIONAL INFORMATION
	WALL MOUNTED FLOOD LIGHT: REFER TO LUMINAIRE SCHEDULE FOR ADDITIONAL INFORMATION
	TRACK LIGHTING
	TRACK LIGHTING HEAD
	REMOTE HEAD
	STEP LIGHT
	EMERGENCY LIGHT
	EXIT SIGN
	CEILING MOUNTED ILLUMINATED EXIT SIGN WITH DIRECTIONAL ARROWS
	EMERGENCY DUAL FACE ILLUMINATED EXIT SIGN WITH DIRECTIONAL ARROWS
	EXIT SIGN WITH INTEGRAL HEADS
	SWITCH: X=BLANK-SINGLE POLE 20A, TOGGLE; X=S-THREE WAY, X=H-FOUR WAY, X=P-PILOT LIGHT; X=K-KEY, X=MS-MOMENTARY
	PHOTOCELL
	WALL MOUNTED OCCUPANCY SENSOR: X=BLANK-DUAL TECHNOLOGY; X=IR-PASSIVE INFRARED; X=US-ULTRASONIC
	CEILING MOUNTED OCCUPANCY SENSOR: X=BLANK-DUAL TECHNOLOGY; X=IR-PASSIVE INFRARED; X=US-ULTRASONIC
	DIMMER
	POWER PACK
	JUNCTION BOX
	PANELBOARD
	LIGHTING CONTROL PANEL
	LOW VOLTAGE TRANSFORMER

POWER SYMBOLS	
NOTE: NOT ALL SYMBOLS MAY BE USED.	
	20A DUPLEX RECEPTACLE WITH COVER PLATE: X=TYPE, Y=NON-STANDARD MOUNTING HEIGHT, Z=SPECIAL DESIGNATION, (18" AFF TYPICAL)
	DUPLEX RECEPTACLE ON EMERGENCY CIRCUIT WITH COVER PLATE: X=TYPE, Y=NON-STANDARD MOUNTING HEIGHT, Z=SPECIAL DESIGNATION, (18" AFF TYPICAL)
	FLOOR OR CEILING MOUNTED DUPLEX RECEPTACLE:
	DUPLEX RECEPTACLE: ABOVE COUNTER (48" AFF TYPICAL)
	DOUBLE DUPLEX RECEPTACLE WITH SINGLE COVER PLATE
	SIMPLEX RECEPTACLE WITH COVER PLATE
	WEATHER RESISTANT DUPLEX RECEPTACLE, GROUND FAULT CIRCUIT INTERRUPTING WITH IN-USE COVER
	WALL MOUNTED SPECIAL RECEPTACLE: REFER TO PLANS FOR ADDITIONAL INFORMATION
	FLOOR OR CEILING MOUNTED SPECIAL RECEPTACLE: F=FLOOR, C=CEILING REFER TO PLANS FOR ADDITIONAL INFORMATION
	SURFACE MOUNTED RACEWAY
	STANDARD DISCONNECT SWITCH: X=DISCONNECT SIZE, Y=NUMBER OF POLES
	STANDARD FUSED DISCONNECT SWITCH: X=DISCONNECT SIZE, Y=FUSE SIZE, Z=NUMBER OF POLES
	MOTOR STARTER: X=STARTER SIZE, Y=NUMBER OF POLES
	COMBINATION MOTOR STARTER/DISCONNECT SWITCH: X=STARTER SIZE, Y=FUSE SIZE, Z=NUMBER OF POLES
	MOTOR (BY OTHERS); PROVIDE POWER AS INDICATED
	UTILITY METER
	FRACTIONAL HORSEPOWER MANUAL MOTOR STARTER
	JUNCTION BOX
	TRANSFORMER
	HANDHOLE/POLE BOX: SEE DETAILS FOR ADDITIONAL INFORMATION
	CONTROL PANEL
	SURGE PROTECTIVE DEVICE
	PANELBOARD
	AUTOMATIC TRANSFER SWITCH
	VARIABLE FREQUENCY DRIVE (BY DIVISION 23)
	PUSH BUTTON
	POWER POLE
	CORD REEL
	GROUND ROD
	POKE THROUGH SERVICE FITTING: X=TYPE

TELECOMM SYMBOLS	
NOTE: NOT ALL SYMBOLS MAY BE USED.	
	WALL MOUNTED DATA OUTLET (18" AFF): X=NUMBER OF OUTLETS
	CEILING MOUNTED DATA OUTLET: C=CEILING
	WALL MOUNTED PHONE/DATA OUTLET (18" AFF): X=NUMBER OF OUTLETS (P=PHONE, D=DATA)
	WIRELESS ACCESS POINT
	POKE THROUGH DEVICE: PROVIDE (1) DUPLEX OUTLET AND (2) CAT6 DATA JACKS, TERMINATE DATA ON PATCH PANEL IN NEAREST IT CLOSET: A=POWER / AV / DATA, B=POWER / DATA
	SURFACE MOUNTED RACEWAY
	CABLE TRAY
	EQUIPMENT RACK
	TELEPHONE TERMINAL BOARD: PLYWOOD BACKBOARD: REFER TO PLANS FOR ACTUAL LENGTHS

SECURITY SYMBOLS	
NOTE: NOT ALL SYMBOLS MAY BE USED.	
	CAMERA: PTZ=PAN, TILT, AND ZOOM; F=FIXED DIRECTIONAL; D=DOME CAMERA
	ALARM HORN
	CARD READER
	DOOR LATCH
	INTERCOM
	KEY PAD
	LATCH MONITOR
	MONITORING STATION
	MOTION DETECTOR
	TAMPER SWITCH
	POWER SUPPLY
	REQUEST EXIT
	ELECTRIC STRIKE
	PUSH BUTTON
	CCTV EQUIPMENT RACK

PAGING SYMBOLS	
NOTE: NOT ALL SYMBOLS MAY BE USED.	
	MICROPHONE OUTLET
	WALL MOUNTED HORN
	CEILING MOUNTED HORN
	WALL MOUNTED SPEAKER
	CEILING MOUNTED SPEAKER
	VOLUME CONTROL STATION
	EQUIPMENT RACK

DRAWING INDEX	
DWG NO.	SHEET TITLE
E-001	GENERAL INFORMATION - ELECTRICAL
ED10X	FLOOR PLAN - ELECTRICAL - DEMOLITION
E-10X	FLOOR PLAN - LIGHTING
E-20X	FLOOR PLAN - POWER
E-30X	FLOOR PLAN - SYSTEMS
E-40X	ENLARGED PLANS - ELECTRICAL
E-50X	DETAILS - ELECTRICAL
E-60X	SCHEDULES - ELECTRICAL
E-70X	DIAGRAMS - ELECTRICAL

LINE TYPE LEGEND	
	EXISTING TO REMAIN
	EXISTING TO BE REMOVED
	NEW WORK


#	DATE	CHANGE DESCRIPTION

RENOVATION OF HEARTLAND BANK DUBLIN
 6500 FRANTZ ROAD
 DUBLIN, OH 43017
 FOR
HEARTLAND BANK

MOODY-NOLAN
 300 SPRUCE STREET
 SUITE 300
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DRAWING TITLE:
GENERAL INFORMATION - ELECTRICAL

PROGRESS DRAWING NOT FOR CONSTRUCTION	11/30/2020
	DRAWN BY: Author CHECKED BY: Checker
	20022
E-001	
FINAL DEVELOPMENT PLAN	

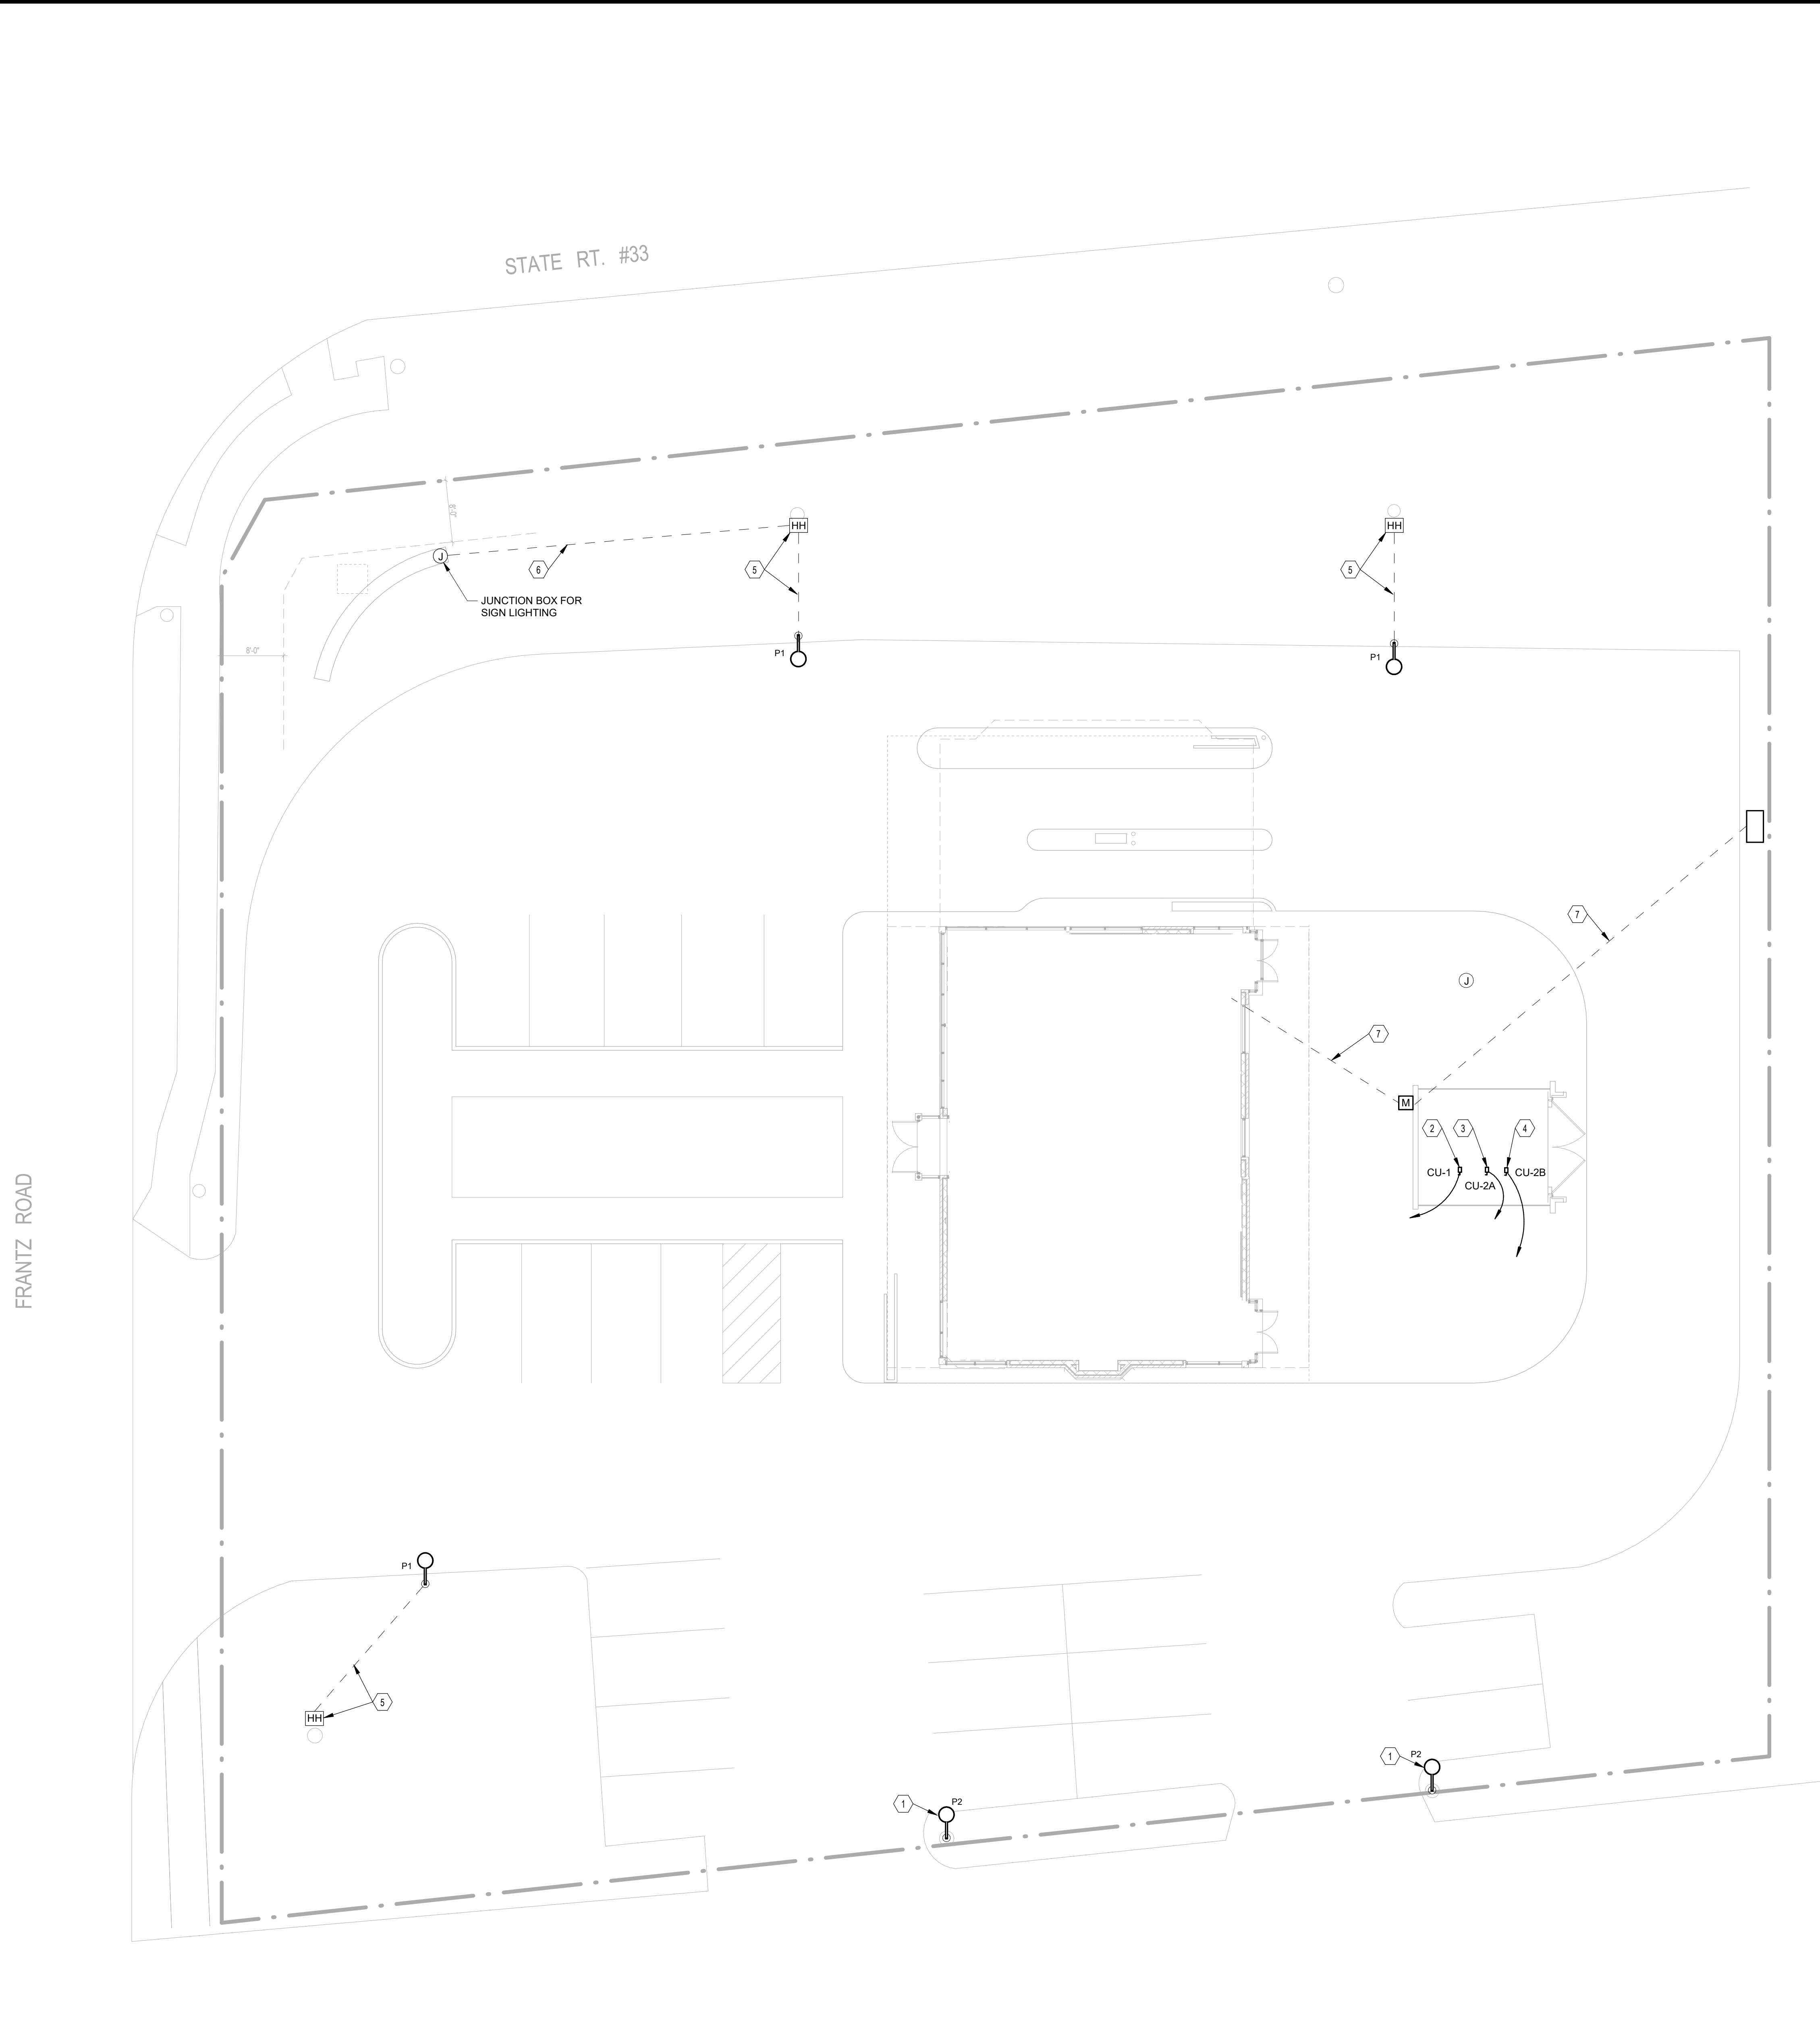

1 PLAN SITE PLAN - ELECTRICAL
 1" = 10'-0"

GENERAL NOTES:

- A. UNLESS NOTED OTHERWISE, MINIMUM CONDUIT SIZE FOR ALL EXTERIOR INSTALLATIONS SHALL BE 1".
- B. UNDERGROUND CONDUIT ROUTING SHOWN IS DIAGRAMATIC. CONTRACTOR SHALL CONDUCT UNDERGROUND UTILITY LOCATING AND DETERMINE EXACT ROUTING. CONTRACTOR SHALL ALSO CONTACT "DUPS" NO LESS THAN 7 CALENDAR DAYS PRIOR TO DIGGING.
- C. COORDINATE ALL SITE WORK WITH OTHER TRADES AND EXISTING UNDERGROUND UTILITIES.

CODED NOTES:

- 1. PROVIDE 20' LIGHT POLE AND LUMINAIRE ON EXISTING POLE BASE. EXTEND EXISTING CIRCUIT TO LUMINAIRE.
- 2. CU-1, 208V, 1PH 23.5A: PROVIDE 30/2 NEMA 3R FUSED DISCONNECT. PROVIDE UNISTRUT SUPPORT AS NECESSARY.
- 3. CU-2A, 208V, 1PH 23.5A: PROVIDE 30/2 NEMA 3R FUSED DISCONNECT. PROVIDE UNISTRUT SUPPORT AS NECESSARY.
- 4. CU-2B, 208V, 1PH 23.5A: PROVIDE 30/2 NEMA 3R FUSED DISCONNECT. PROVIDE UNISTRUT SUPPORT AS NECESSARY.
- 5. DEMOLISH EXISTING POLE LIGHT AND BASE. PROVIDE HANDHOLE, INTERCEPT CIRCUIT, MATCH WIRE SIZE, MAKE JUNCTIONS AND EXTEND TO NEW LIGHT POLE.
- 6. EXTEND EXISTING LIGHTING CIRCUIT FROM HANDHOLE TO SIGN LIGHTING.
- 7. CONDUIT IN CONCRETE ENCASEMENT FOR SERVICE ENTRANCE. REFER TO ONE LINE DIAGRAM AND DETAILS FOR ADDITIONAL REQUIREMENTS.

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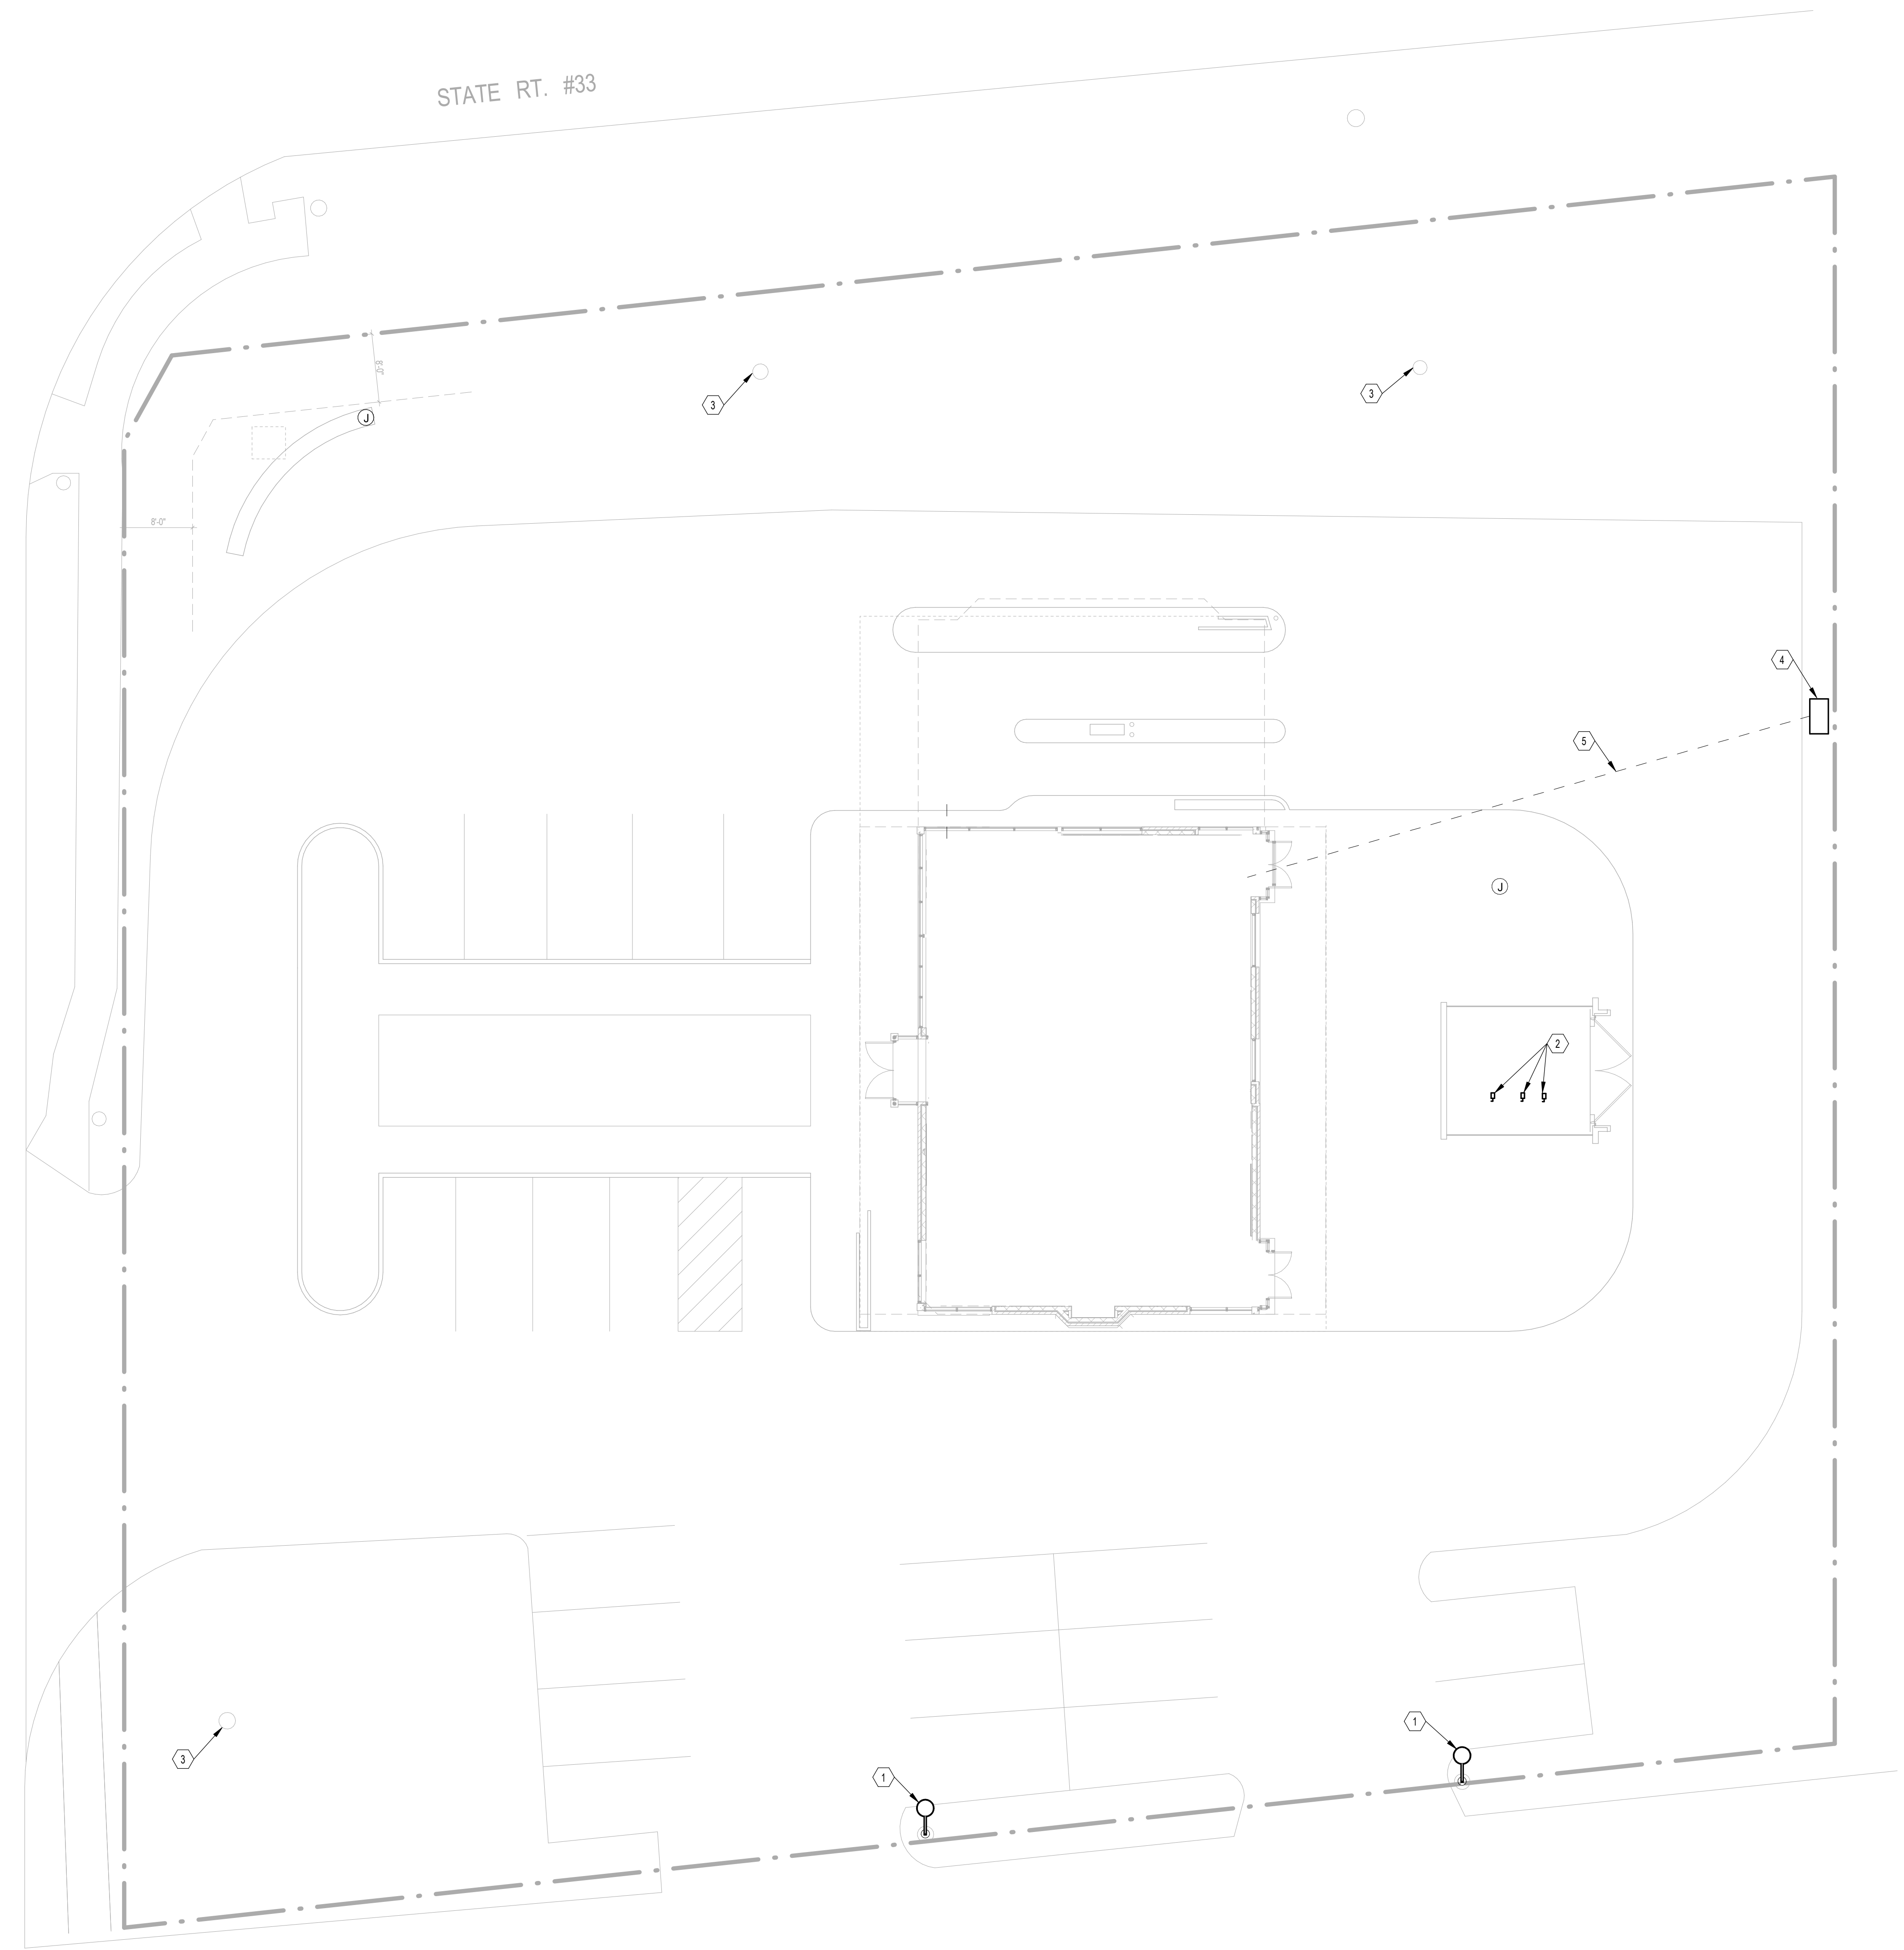
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SITE PLAN - ELECTRICAL

PROGRESS DRAWING NOT FOR CONSTRUCTION	11/30/2020
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	2022
	ES-100
FINAL DEVELOPMENT PLAN	

FRANTZ ROAD

STATE RT. #33



1 PLAN SITE PLAN - ELECTRICAL DEMOLITION
1" = 10'-0"

- CODED NOTES:**
1. DEMOLISH EXISTING LUMINAIRE AND LIGHT POLE. EXISTING BASE AND CIRCUITING TO REMAIN FOR REUSE.
 2. POWER CONNECTION TO CONDENSING UNIT. DISCONNECT SWITCH AND CONDUCTORS TO BE DEMOLISHED BACK TO SOURCE.
 3. DEMOLISH EXISTING POLE LIGHT AND BASE. PROVIDE HANDHOLE TO INTERCEPT CIRCUIT REFER TO NEW WORK PLAN FOR ADDITIONAL REQUIREMENTS.
 4. EXISTING UTILITY TRANSFORMER
 5. EXISTING SECONDARY CONDUIT TO BE ABANDONED IN PLACE.


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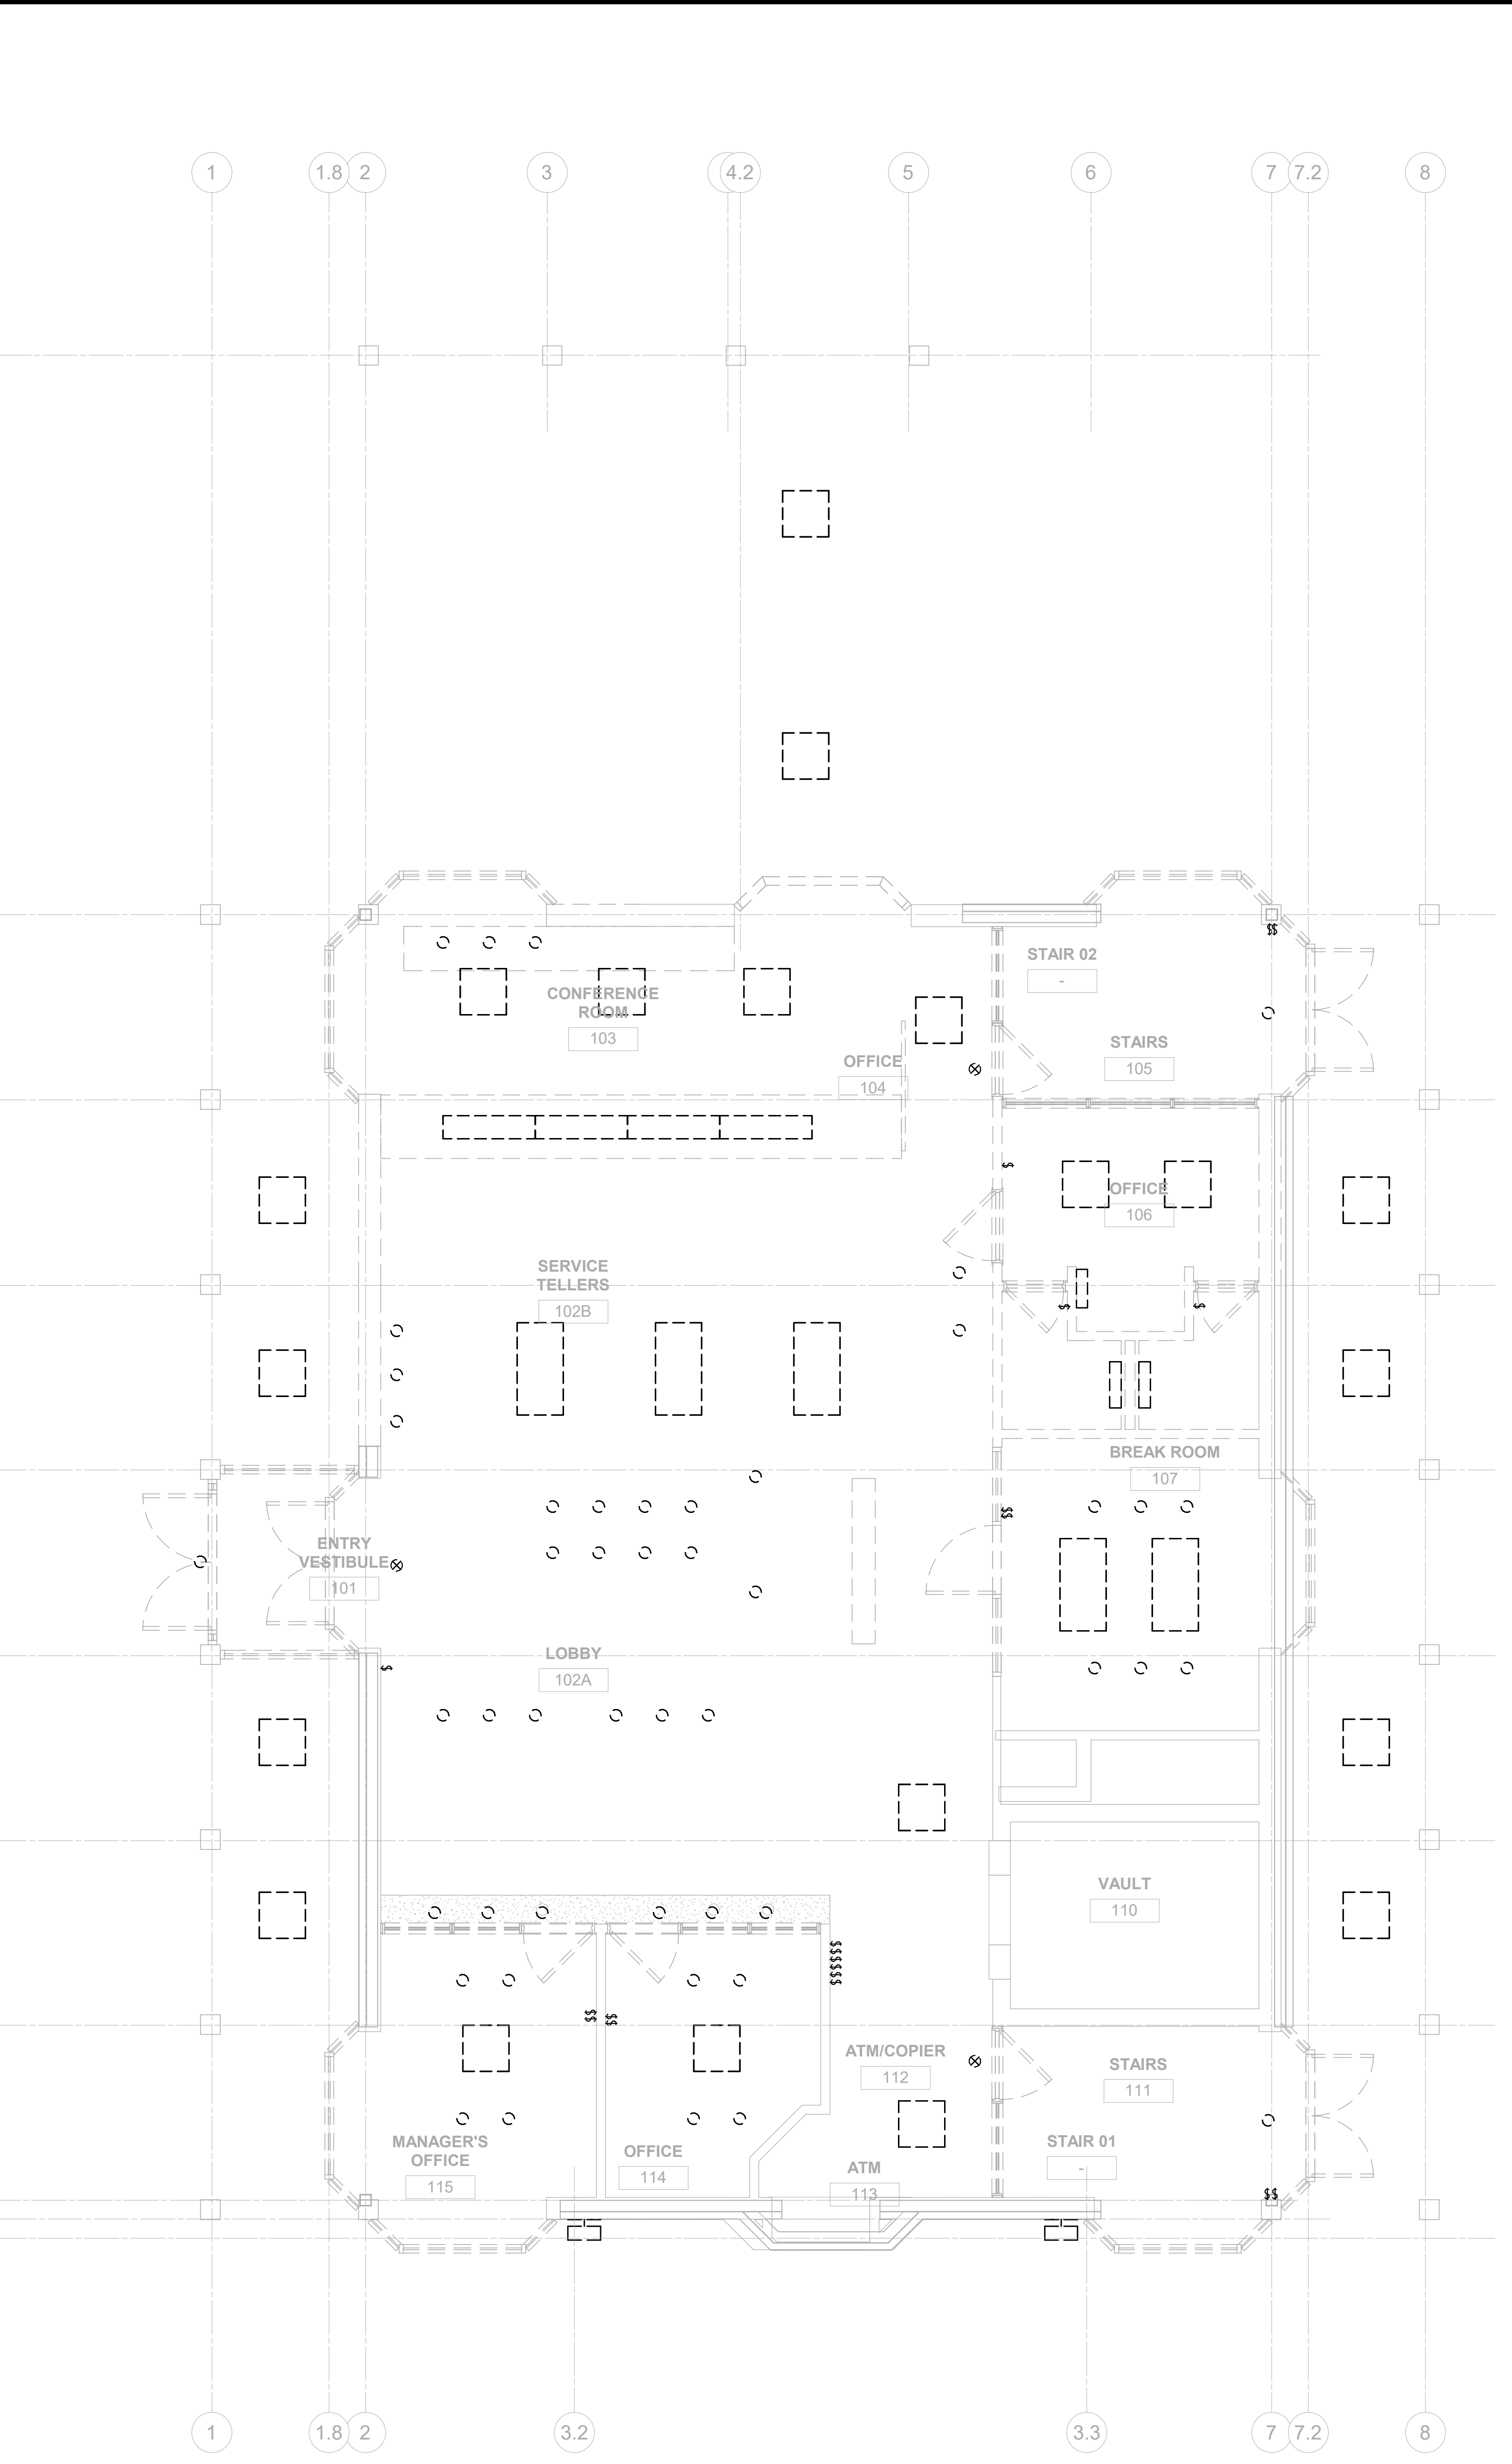
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SITE PLAN - ELECTRICAL - DEMOLITION

PROGRESS DRAWING NOT FOR CONSTRUCTION	11/30/2020
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	20022
	ED-100
FINAL DEVELOPMENT PLAN	



2 PLAN BASEMENT CEILING PLAN - ELECTRICAL - DEMOLITION
 1/4" = 1'-0"

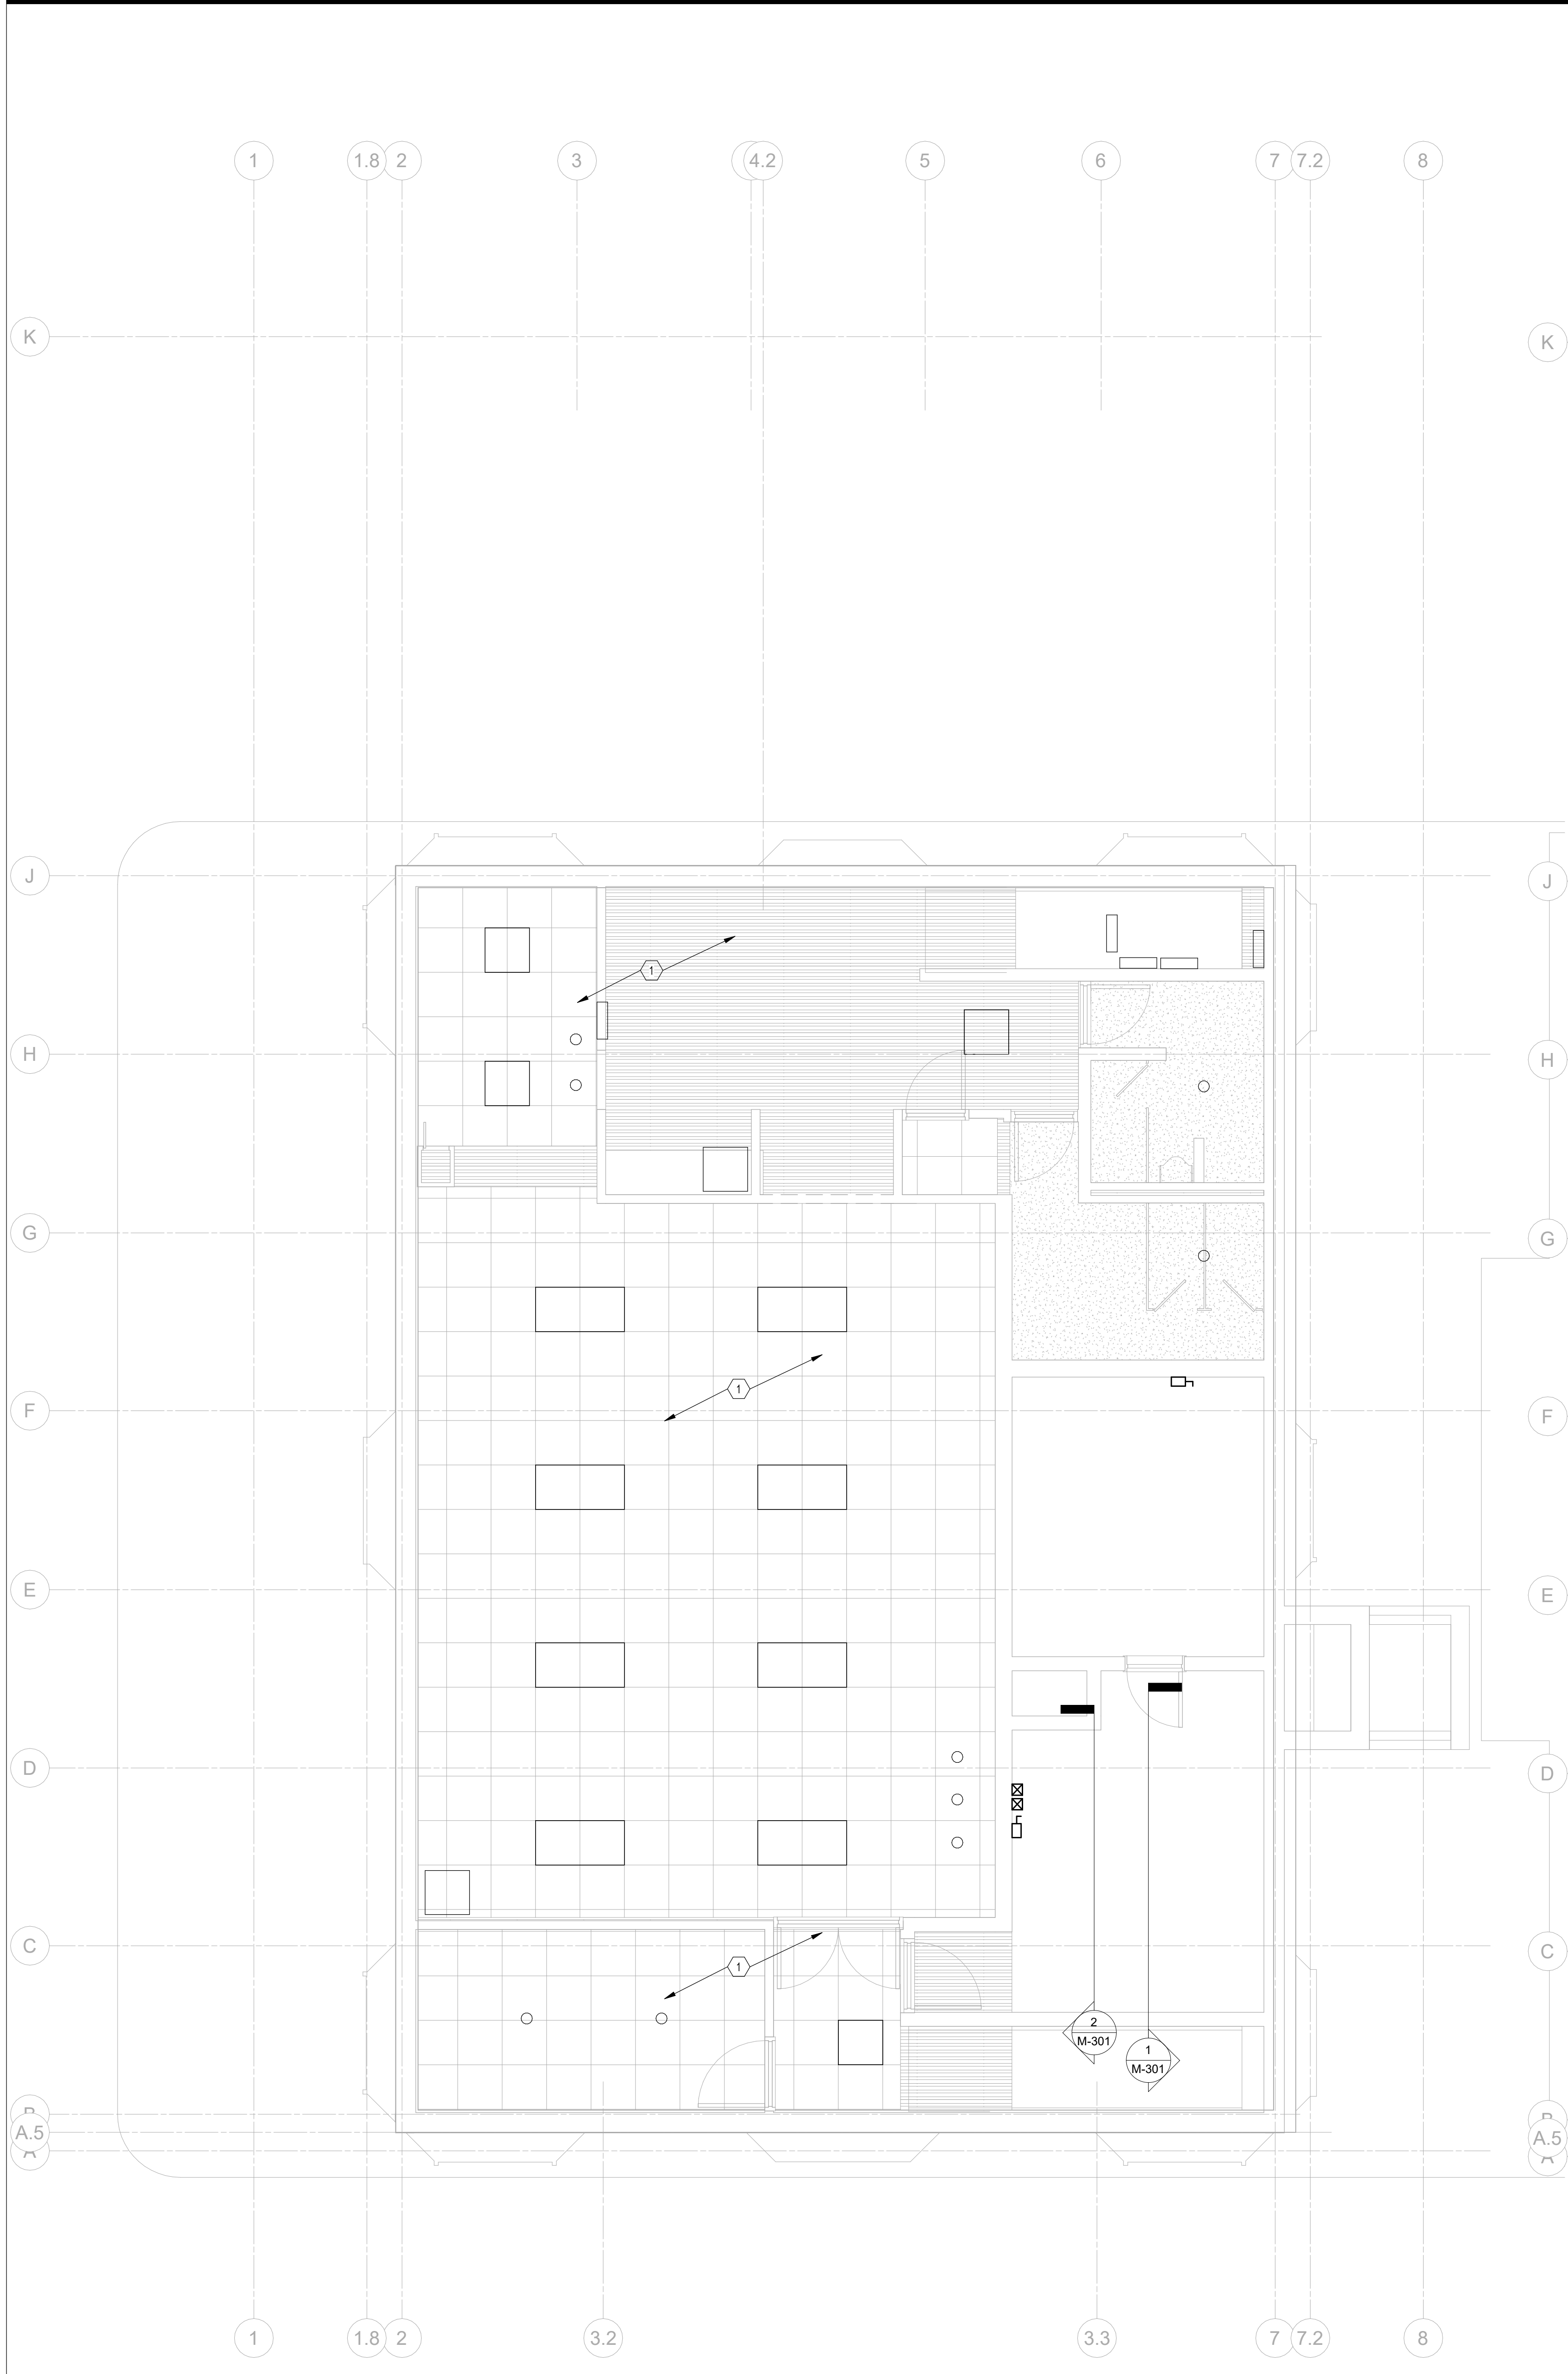

1 PLAN FIRST FLOOR CEILING PLAN - LIGHTING - DEMOLITION
 1/4" = 1'-0"

- GENERAL NOTES:**
- A. UNLESS NOTED OTHERWISE ALL 1ST FLOOR INTERIOR LUMINAIRES AND CONTROLS SHALL BE DEMOLISHED.
 - B. DRAWINGS ARE DIAGRAMMATIC IN NATURE AND REPRESENT AN APPROXIMATION OF INITIAL CONDITIONS. INFORMATION PROVIDED IS BASED ON THE BEST AVAILABLE DATA. ELECTRICAL CONTRACTOR SHALL VERIFY EXISTING CONDITIONS AND EXTENT OF THE NEW WORK PRIOR TO CONSTRUCTION.
 - C. ENSURE THAT ALL LIGHTING FIXTURES AND WIRING DEVICES IN ADJACENT SPACES AND BASEMENT REMAIN OPERATIONAL DURING DEMOLITION AND AFTER RENOVATION IS COMPLETED. PROVIDE NEW BRANCH CIRCUITING AS REQUIRED TO MAINTAIN SERVICE.
 - D. ALL EQUIPMENT TO BE REMOVED SHALL BE DISPOSED OF BY THE CONTRACTOR IN ACCORDANCE WITH STATE, LOCAL LAWS, ORDINANCES, RULES AND REGULATIONS.
 - E. UNLESS NOTED OTHERWISE, ALL CONDUCTORS OF DEMOLISHED DEVICES AND EQUIPMENT THAT ARE NOT INDICATED FOR REUSE SHALL BE COMPLETELY REMOVED BACK TO SOURCE.
- CODED NOTES:**
- 1. PROVIDE ONE FOR ONE REPLACEMENT OF LUMINAIRES IN BASEMENT WHERE AFFECTED BY MECHANICAL WORK. MAINTAIN EXISTING CONTROLS. PROVIDE CHANGES COMPLETE PER ROOM MODIFIED.


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DRAWING TITLE:
FLOOR PLANS - LIGHTING - DEMOLITION

PROGRESS DRAWING NOT FOR CONSTRUCTION	11/30/2020
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ED-101	
FINAL DEVELOPMENT PLAN	



1 PLAN BASEMENT FLOOR PLAN - ELECTRICAL - DEMOLITION
1/4" = 1'-0"

2 PLAN FIRST FLOOR PLAN - ELECTRICAL - DEMOLITION
1/4" = 1'-0"

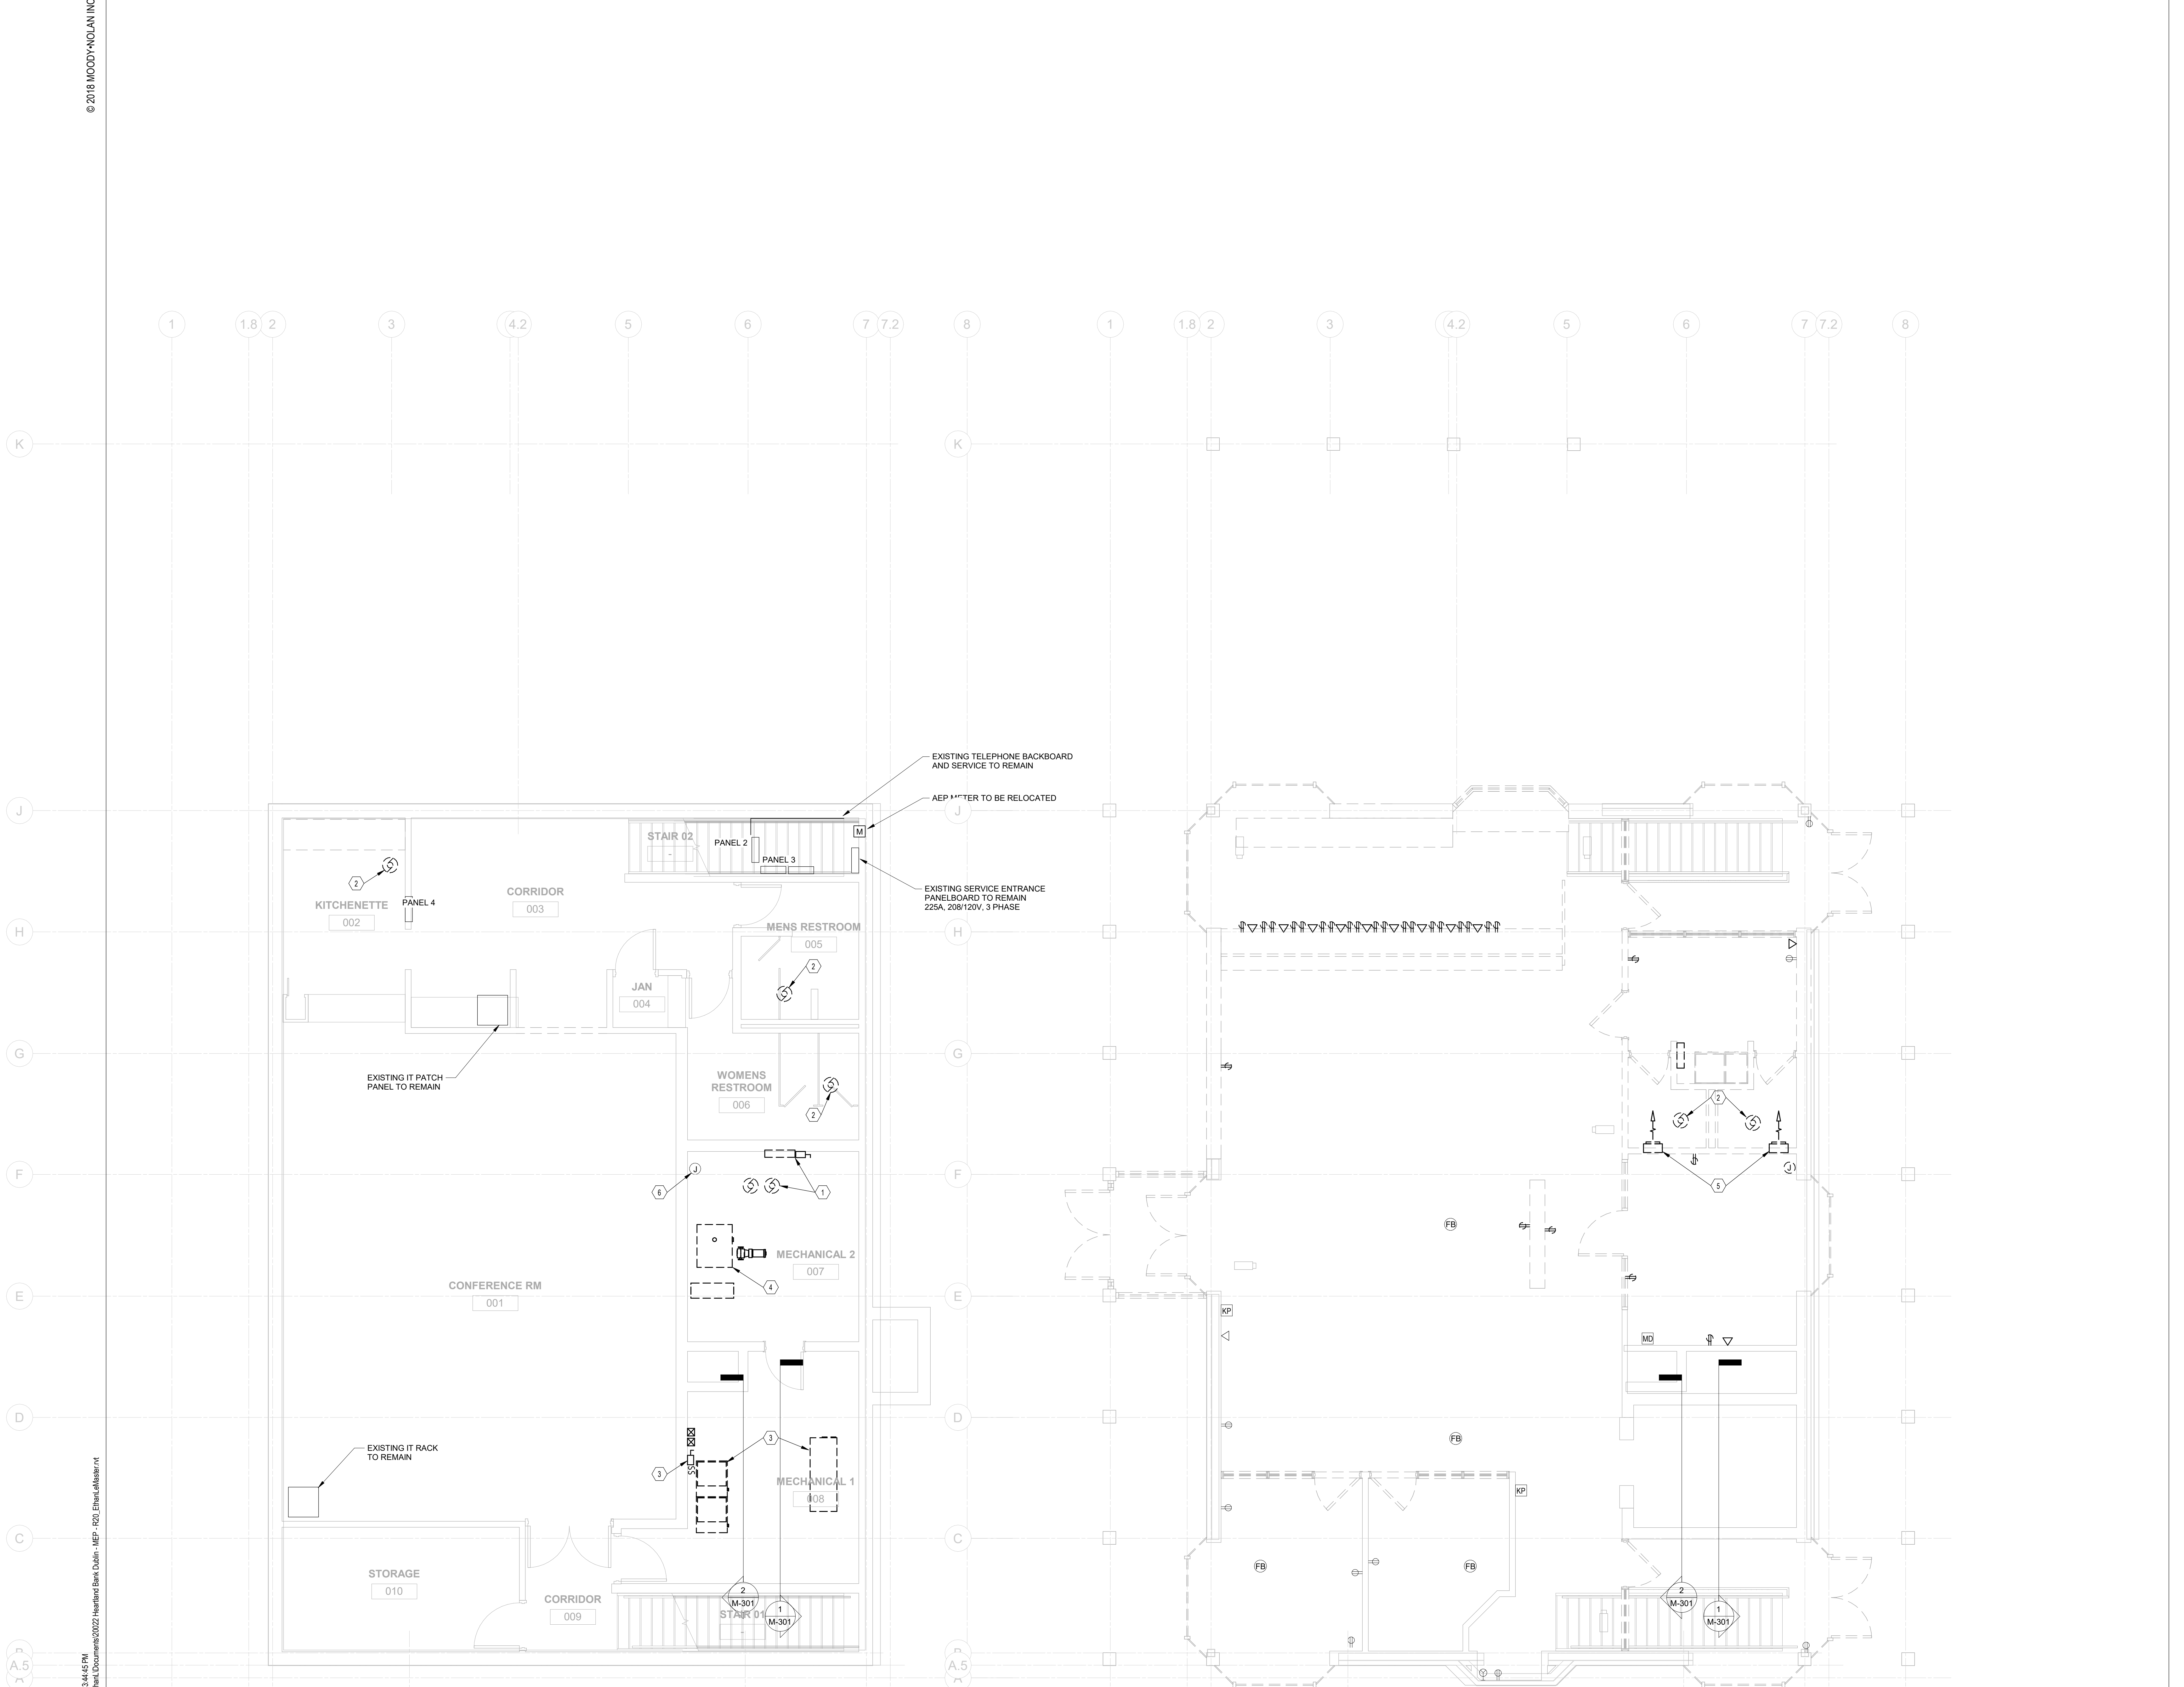GENERAL NOTES:

- A. DRAWINGS ARE DIAGRAMMATIC IN NATURE AND REPRESENT AN APPROXIMATION OF INITIAL CONDITIONS. INFORMATION PROVIDED IS BASED ON THE BEST AVAILABLE DATA. ELECTRICAL CONTRACTOR SHALL FIELD VERIFY EXISTING CONDITIONS AND EXTENT OF THE NEW WORK PRIOR TO CONSTRUCTION.
- B. ENSURE THAT ALL WIRING DEVICES IN ADJACENT SPACES AND BASEMENT REMAIN OPERATIONAL DURING DEMOLITION AND AFTER RENOVATION IS COMPLETED. PROVIDE NEW BRANCH CIRCUITING AS REQUIRED TO MAINTAIN SERVICE.
- C. ALL EQUIPMENT TO BE REMOVED SHALL BE DISPOSED OF BY THE CONTRACTOR IN ACCORDANCE WITH STATE, LOCAL LAWS, ORDINANCES, RULES AND REGULATIONS.
- D. UNLESS NOTED OTHERWISE, ALL CONDUCTORS OF DEMOLISHED DEVICES AND EQUIPMENT THAT ARE NOT INDICATED FOR REUSE SHALL BE COMPLETELY REMOVED BACK TO SOURCE.

CODED NOTES:

- 1. POWER CONNECTION TO SEWAGE EJECTOR PUMP AND SUMP PUMP TO BE DEMOLISHED. DEMOLISH EXISTING CONTROL PANEL AND ASSOCIATED HARDWARE. MAINTAIN AND PROTECT EXISTING CIRCUITS FOR USE WITH NEW PUMPS.
- 2. POWER CONNECTION TO EXHAUST FAN TO BE DEMOLISHED.
- 3. POWER CONNECTION TO FURNACE AND ASSOCIATED HARDWARE TO BE DEMOLISHED.
- 4. POWER CONNECTION TO BOILER AND ASSOCIATED HARDWARE TO BE DEMOLISHED.
- 5. POWER CONNECTION TO UNIT HEATER TO BE DEMOLISHED.
- 6. WATER HEATER TO REMAIN.


#	DATE	CHANGE DESCRIPTION

RENOVATION OF HEARTLAND BANK DUBLIN
 6500 FRANTZ ROAD
 DUBLIN, OH 43017
 FOR
HEARTLAND BANK


MOODY-NOLAN
 300 SPRUCE STREET
 SUITE 300
 COLUMBUS, OHIO 43215
 PHONE: (614) 461-4664
 FAX: (614) 280-8881

FLOOR PLANS - POWER/SYSTEMS - DEMOLITION

11/30/2020
 DRAWN BY: Author CHECKED BY: Checker
 20022
ED-201
 FINAL DEVELOPMENT PLAN

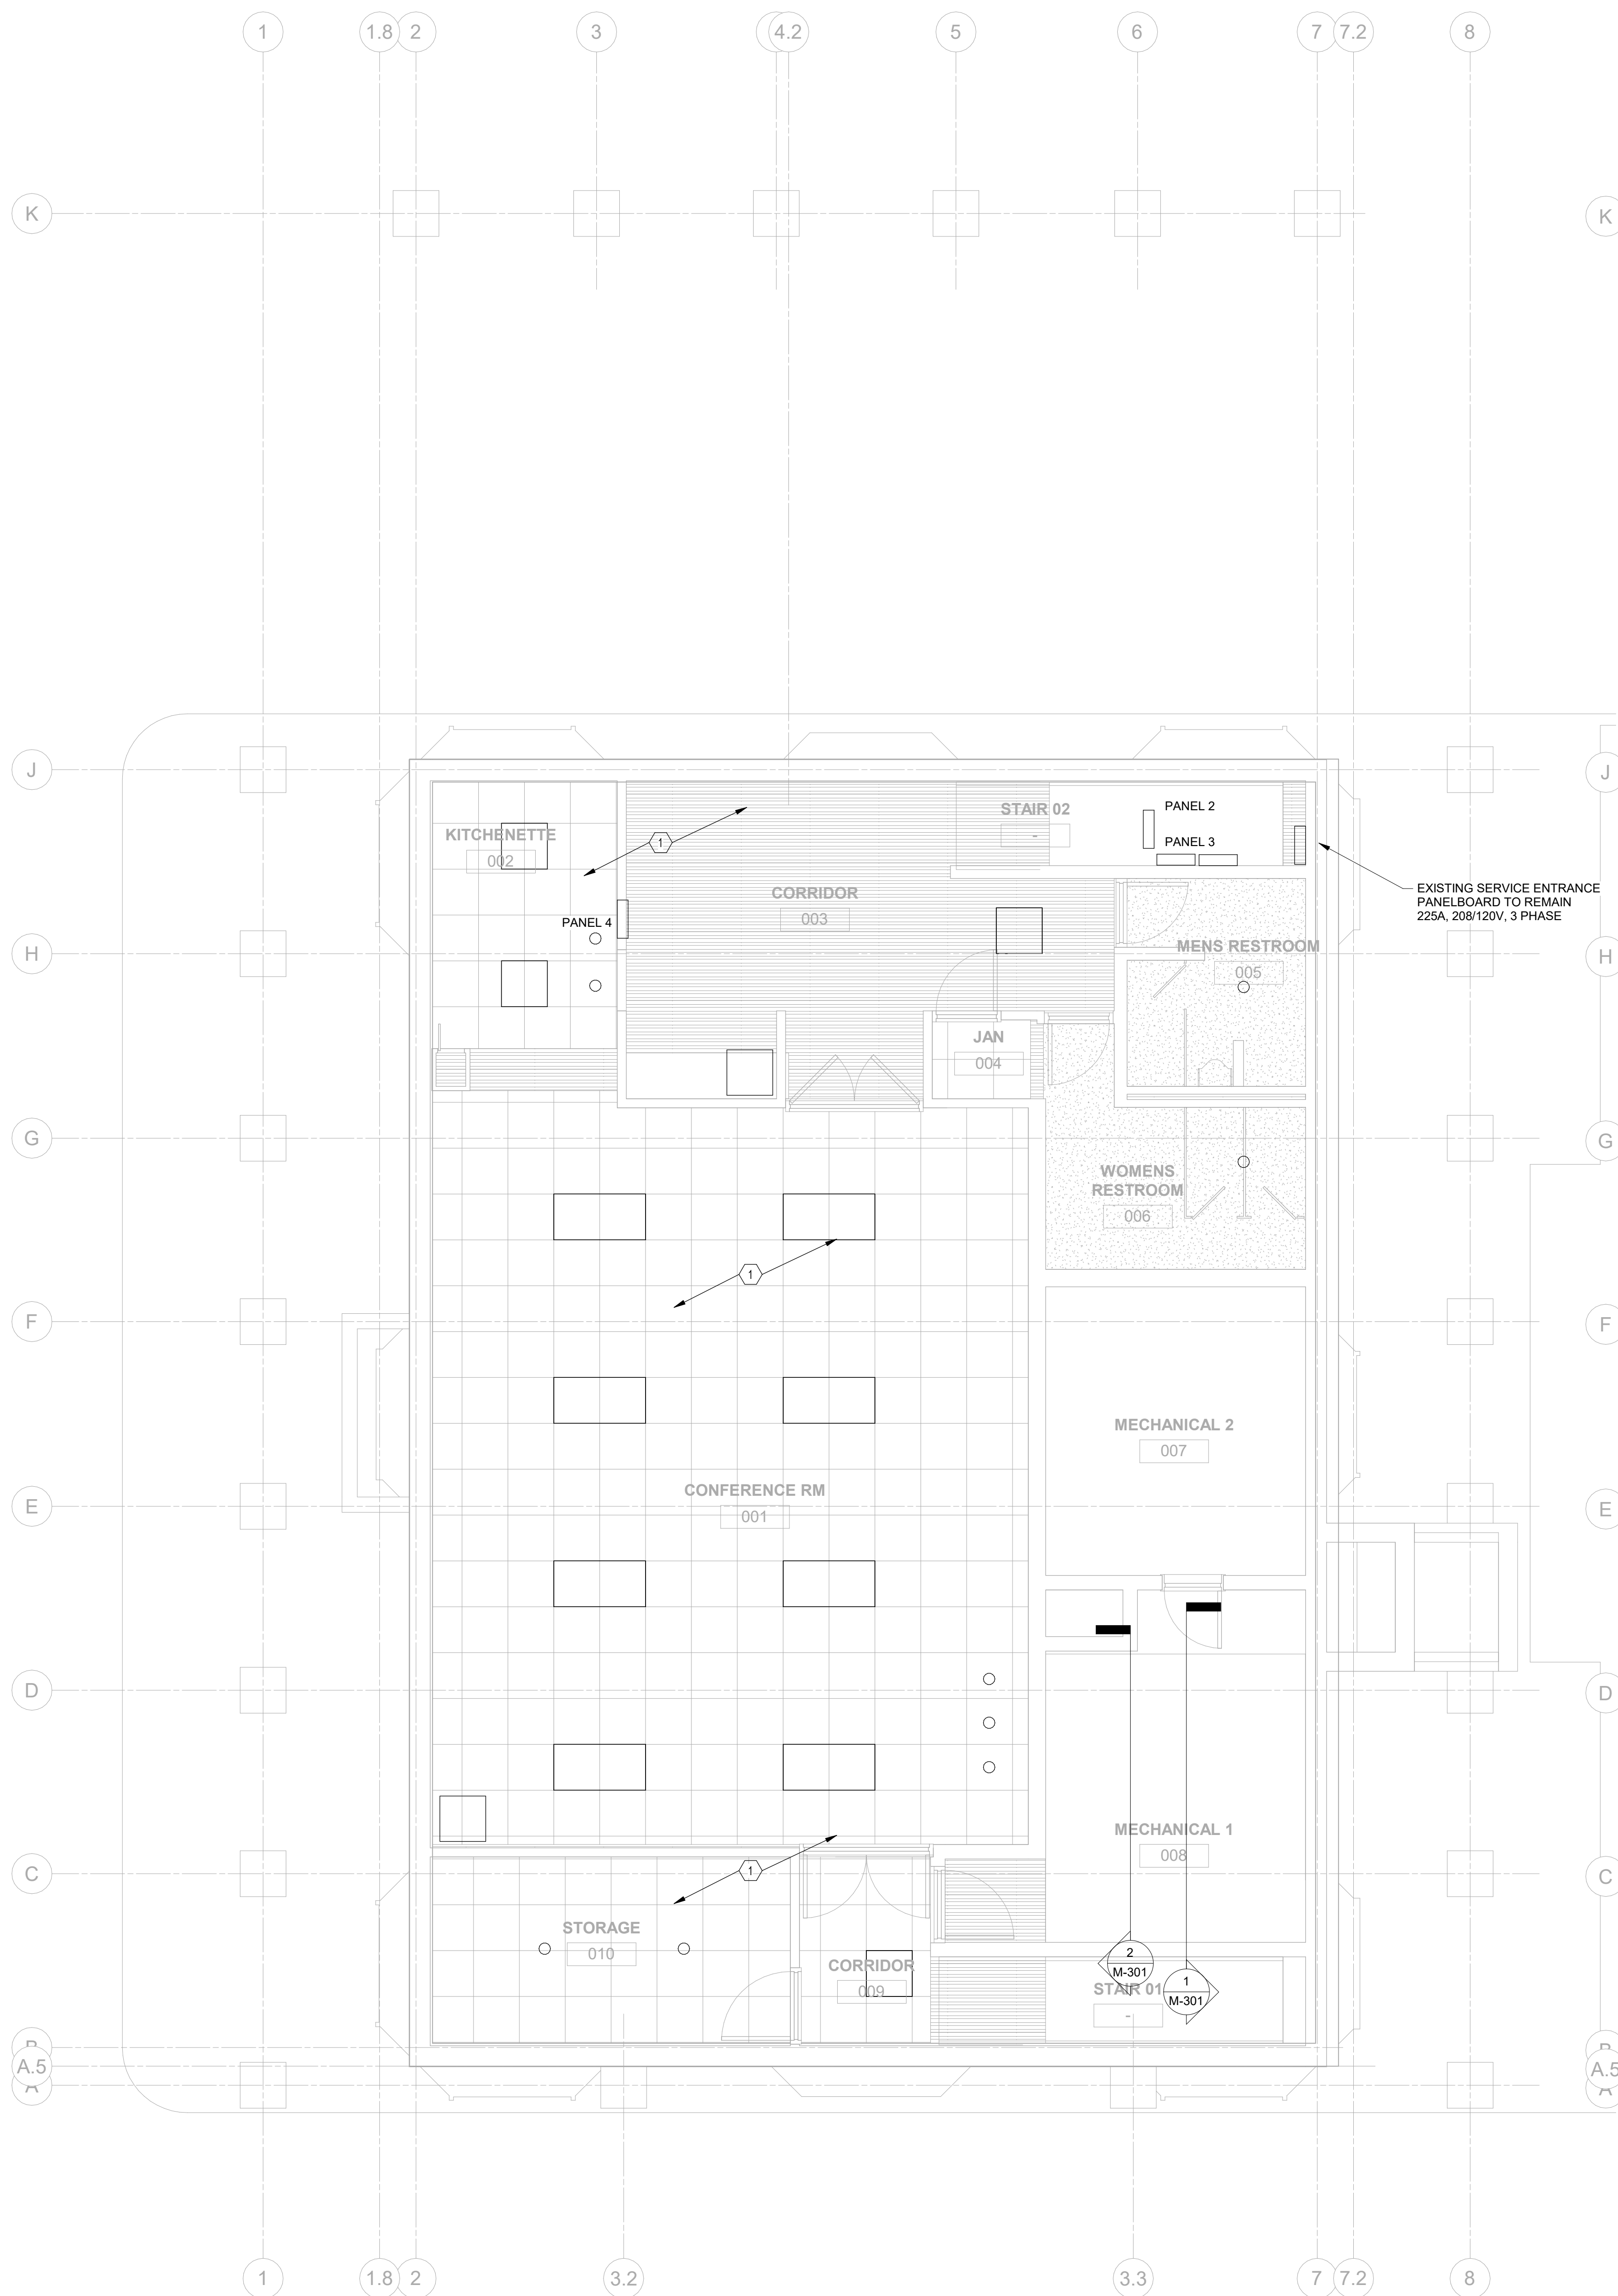

1 PLAN BASEMENT CEILING PLAN - LIGHTING
 1/4" = 1'-0"

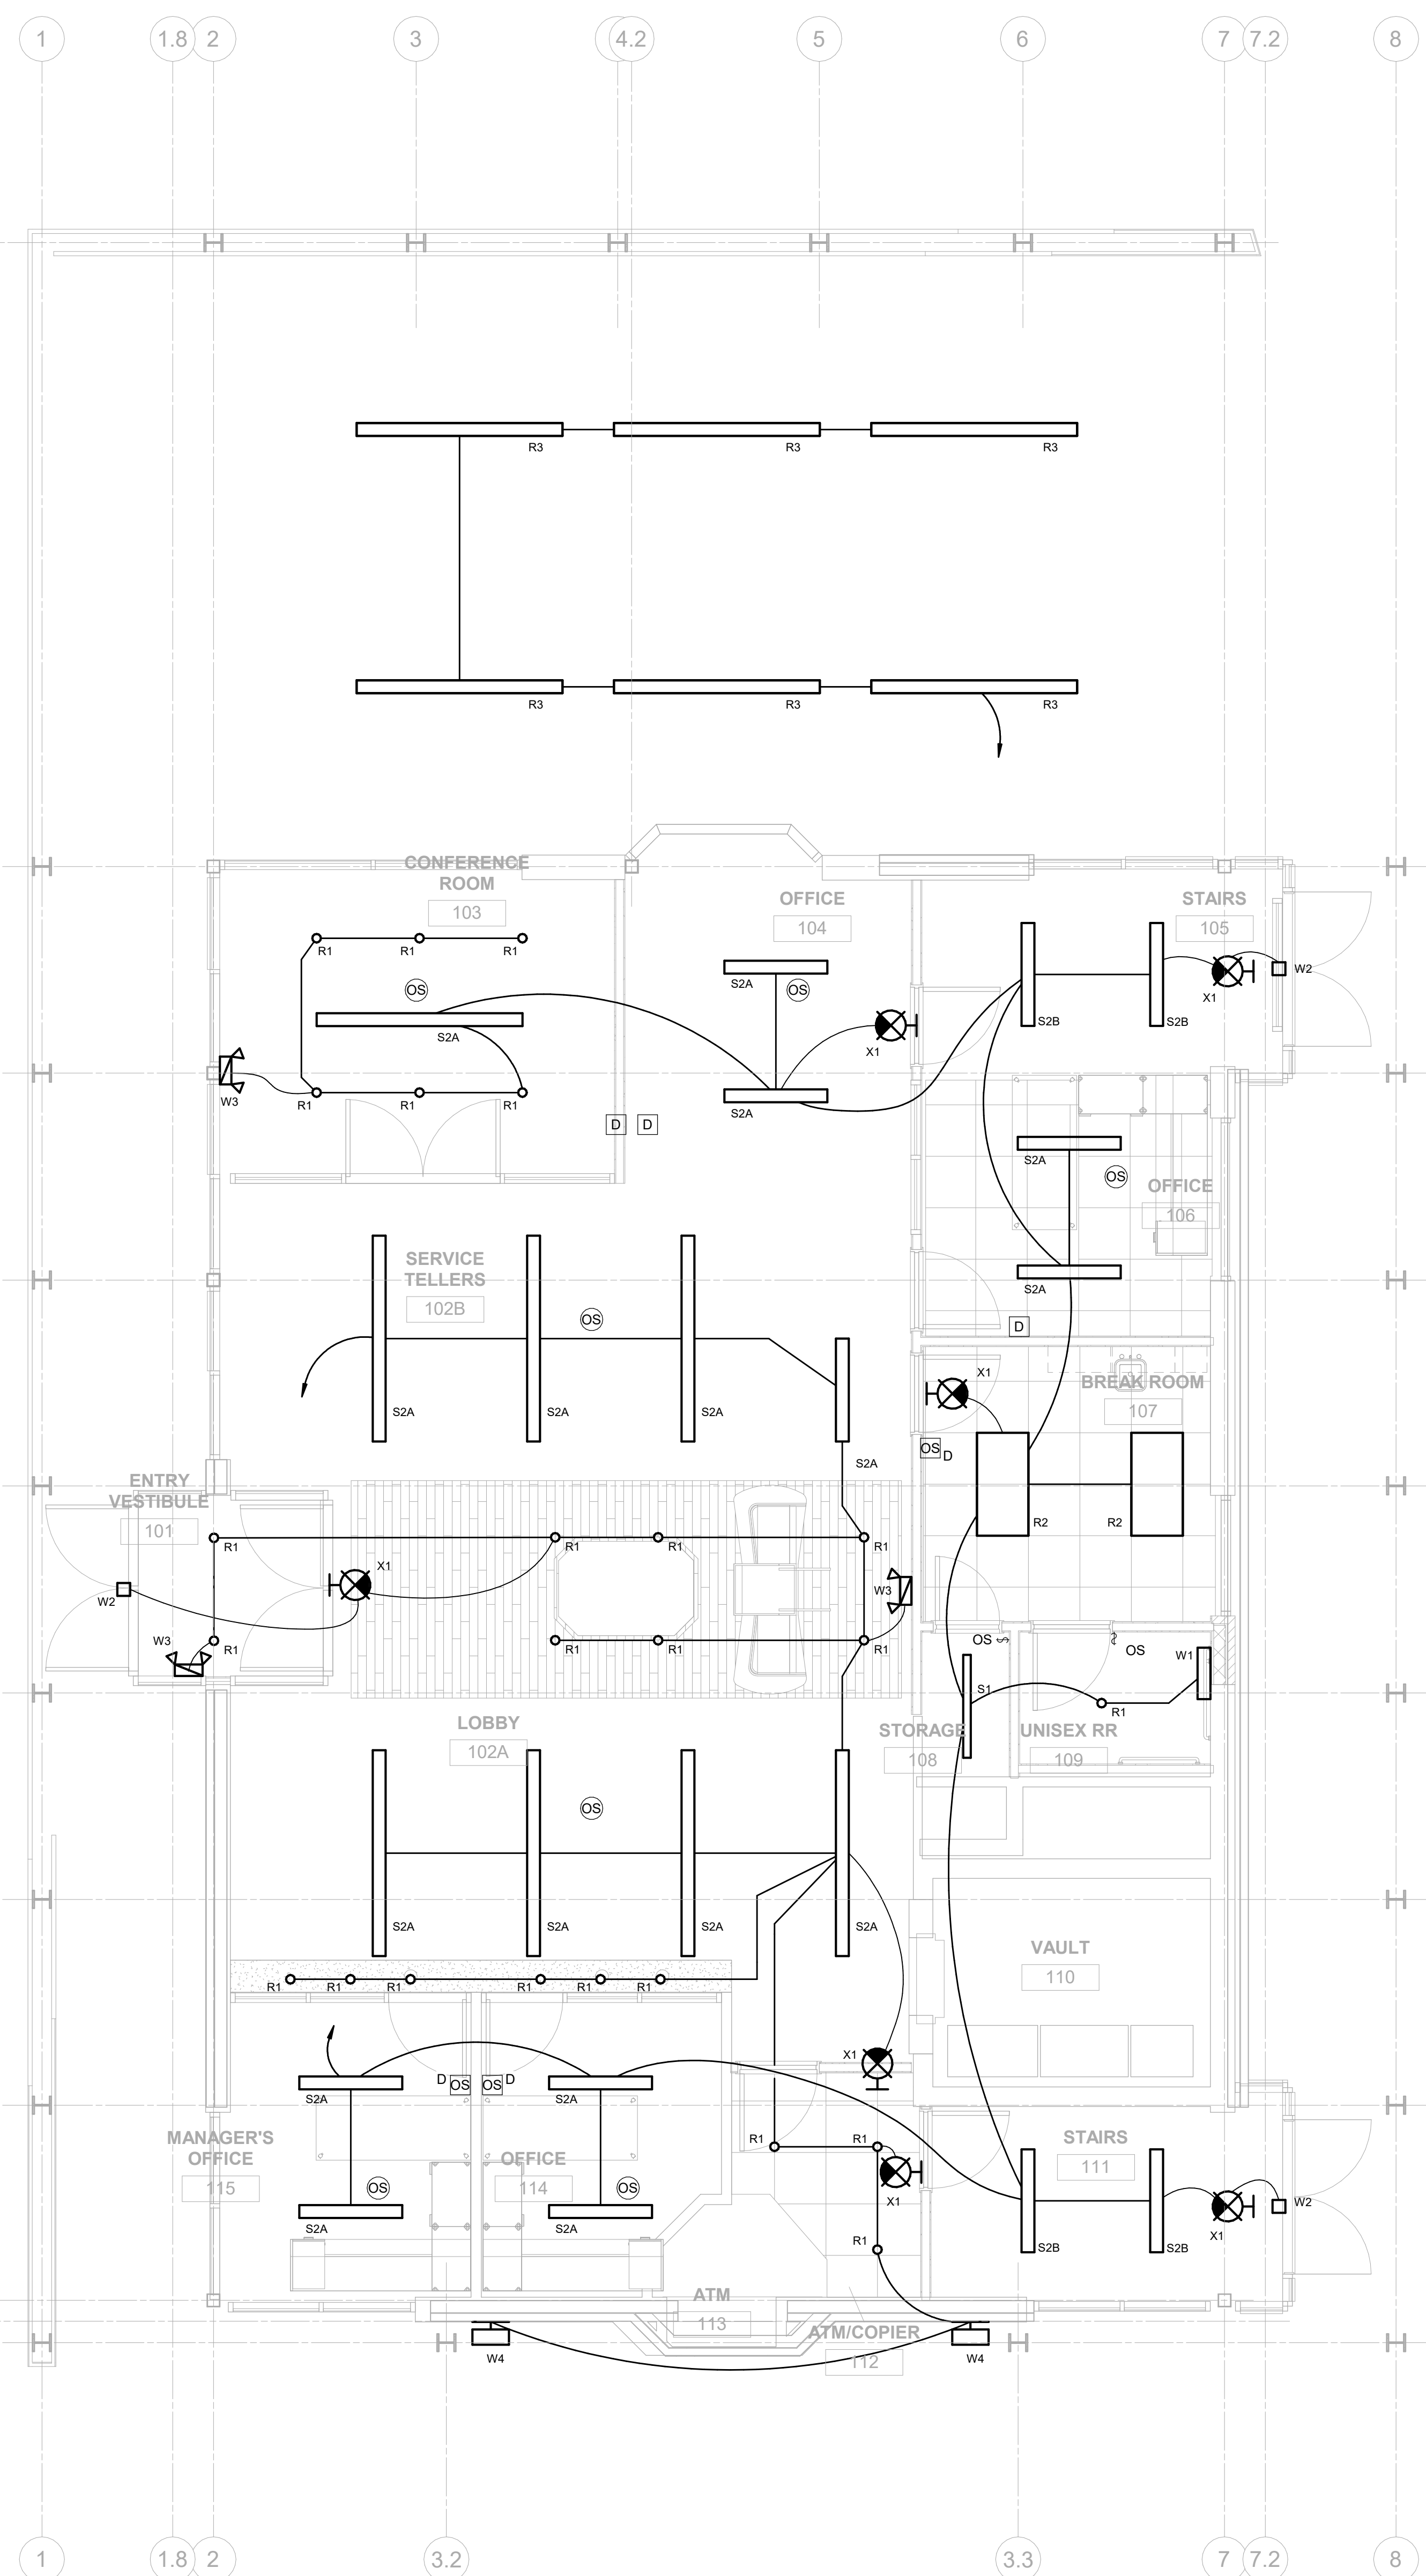

2 PLAN FIRST FLOOR CEILING PLAN - LIGHTING
 1/4" = 1'-0"

- GENERAL NOTES:**
- A. COORDINATE EXACT LOCATION OF LUMINAIRES WITH ARCHITECTURAL REFLECTED CEILING PLAN AND HVAC PLANS PRIOR TO ROUGH-IN TO AVOID CONFLICTS.
 - B. CONTRACTOR SHALL FIELD VERIFY EXISTING PANEL CIRCUITING FOR CIRCUIT MODIFICATIONS SHOWN. MAINTAIN CIRCUITRY CONTINUITY FOR DOWNSTREAM DEVICES.
 - C. POWER PACKS AND SLAVE PACKS ARE NOT SHOWN FOR CLARITY. POWER PACKS AND SLAVE PACKS SHALL BE LOCATED WITHIN EACH ROOM ABOVE CEILING ADJACENT TO THE ENTRY DOOR.
 - D. NO SHARED NEUTRALS - EACH NEW CIRCUIT SHALL HAVE DEDICATED NEUTRAL CONDUCTOR.
 - E. PROVIDE ALL MOUNTING HARDWARE PER MANUFACTURER'S WRITTEN INSTRUCTIONS TO SUPPORT LUMINAIRES. CONTRACTOR TO VERIFY MOUNTING HEIGHTS WITH ARCHITECTURAL ELEVATIONS PRIOR TO ROUGH-IN. LUMINAIRES SHALL NOT BE SUPPORTED BY CEILINGS.
 - F. STRAIGHT LINES INDICATE LUMINAIRES CIRCUITED TO COMMON CONTROLS. ARCHED LINES INDICATE A COMMON BRANCH CIRCUIT BUT SEPARATE CONTROLS.
 - G. EMERGENCY EGRESS LIGHTING, EXIT SIGNS AND NIGHT LIGHTS SHALL BE CONNECTED TO LOCAL LIGHTING CIRCUIT AHEAD OF ANY SWITCHING OR CONTROLS WITH A MINIMUM OF #12 CONDUCTORS.
- CODED NOTES:**
- 1. PROVIDE ONE FOR ONE REPLACEMENT OF LUMINAIRES IN BASEMENT WHERE AFFECTED BY MECHANICAL WORK. MAINTAIN EXISTING CONTROLS. PROVIDE CHANGES COMPLETE PER ROOM MODIFIED.


#	DATE	CHANGE DESCRIPTION

RENOVATION OF HEARTLAND BANK DUBLIN
 6500 FRANTZ ROAD
 DUBLIN, OH 43017
 FOR
HEARTLAND BANK

MOODY-NOLAN
 300 SPRUCE STREET
 SUITE 300
 COLUMBUS, OHIO 43215
 PHONE: (614) 461-4664
 FAX: (614) 280-8881

DRAWING TITLE:
FLOOR PLANS - LIGHTING

PROGRESS DRAWING NOT FOR CONSTRUCTION	11/30/2020 DRAWN BY: Author CHECKED BY: Checker 20022 E-101 FINAL DEVELOPMENT PLAN
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1 PLAN BASEMENT FLOOR PLAN - ELECTRICAL
 1/4" = 1'-0"

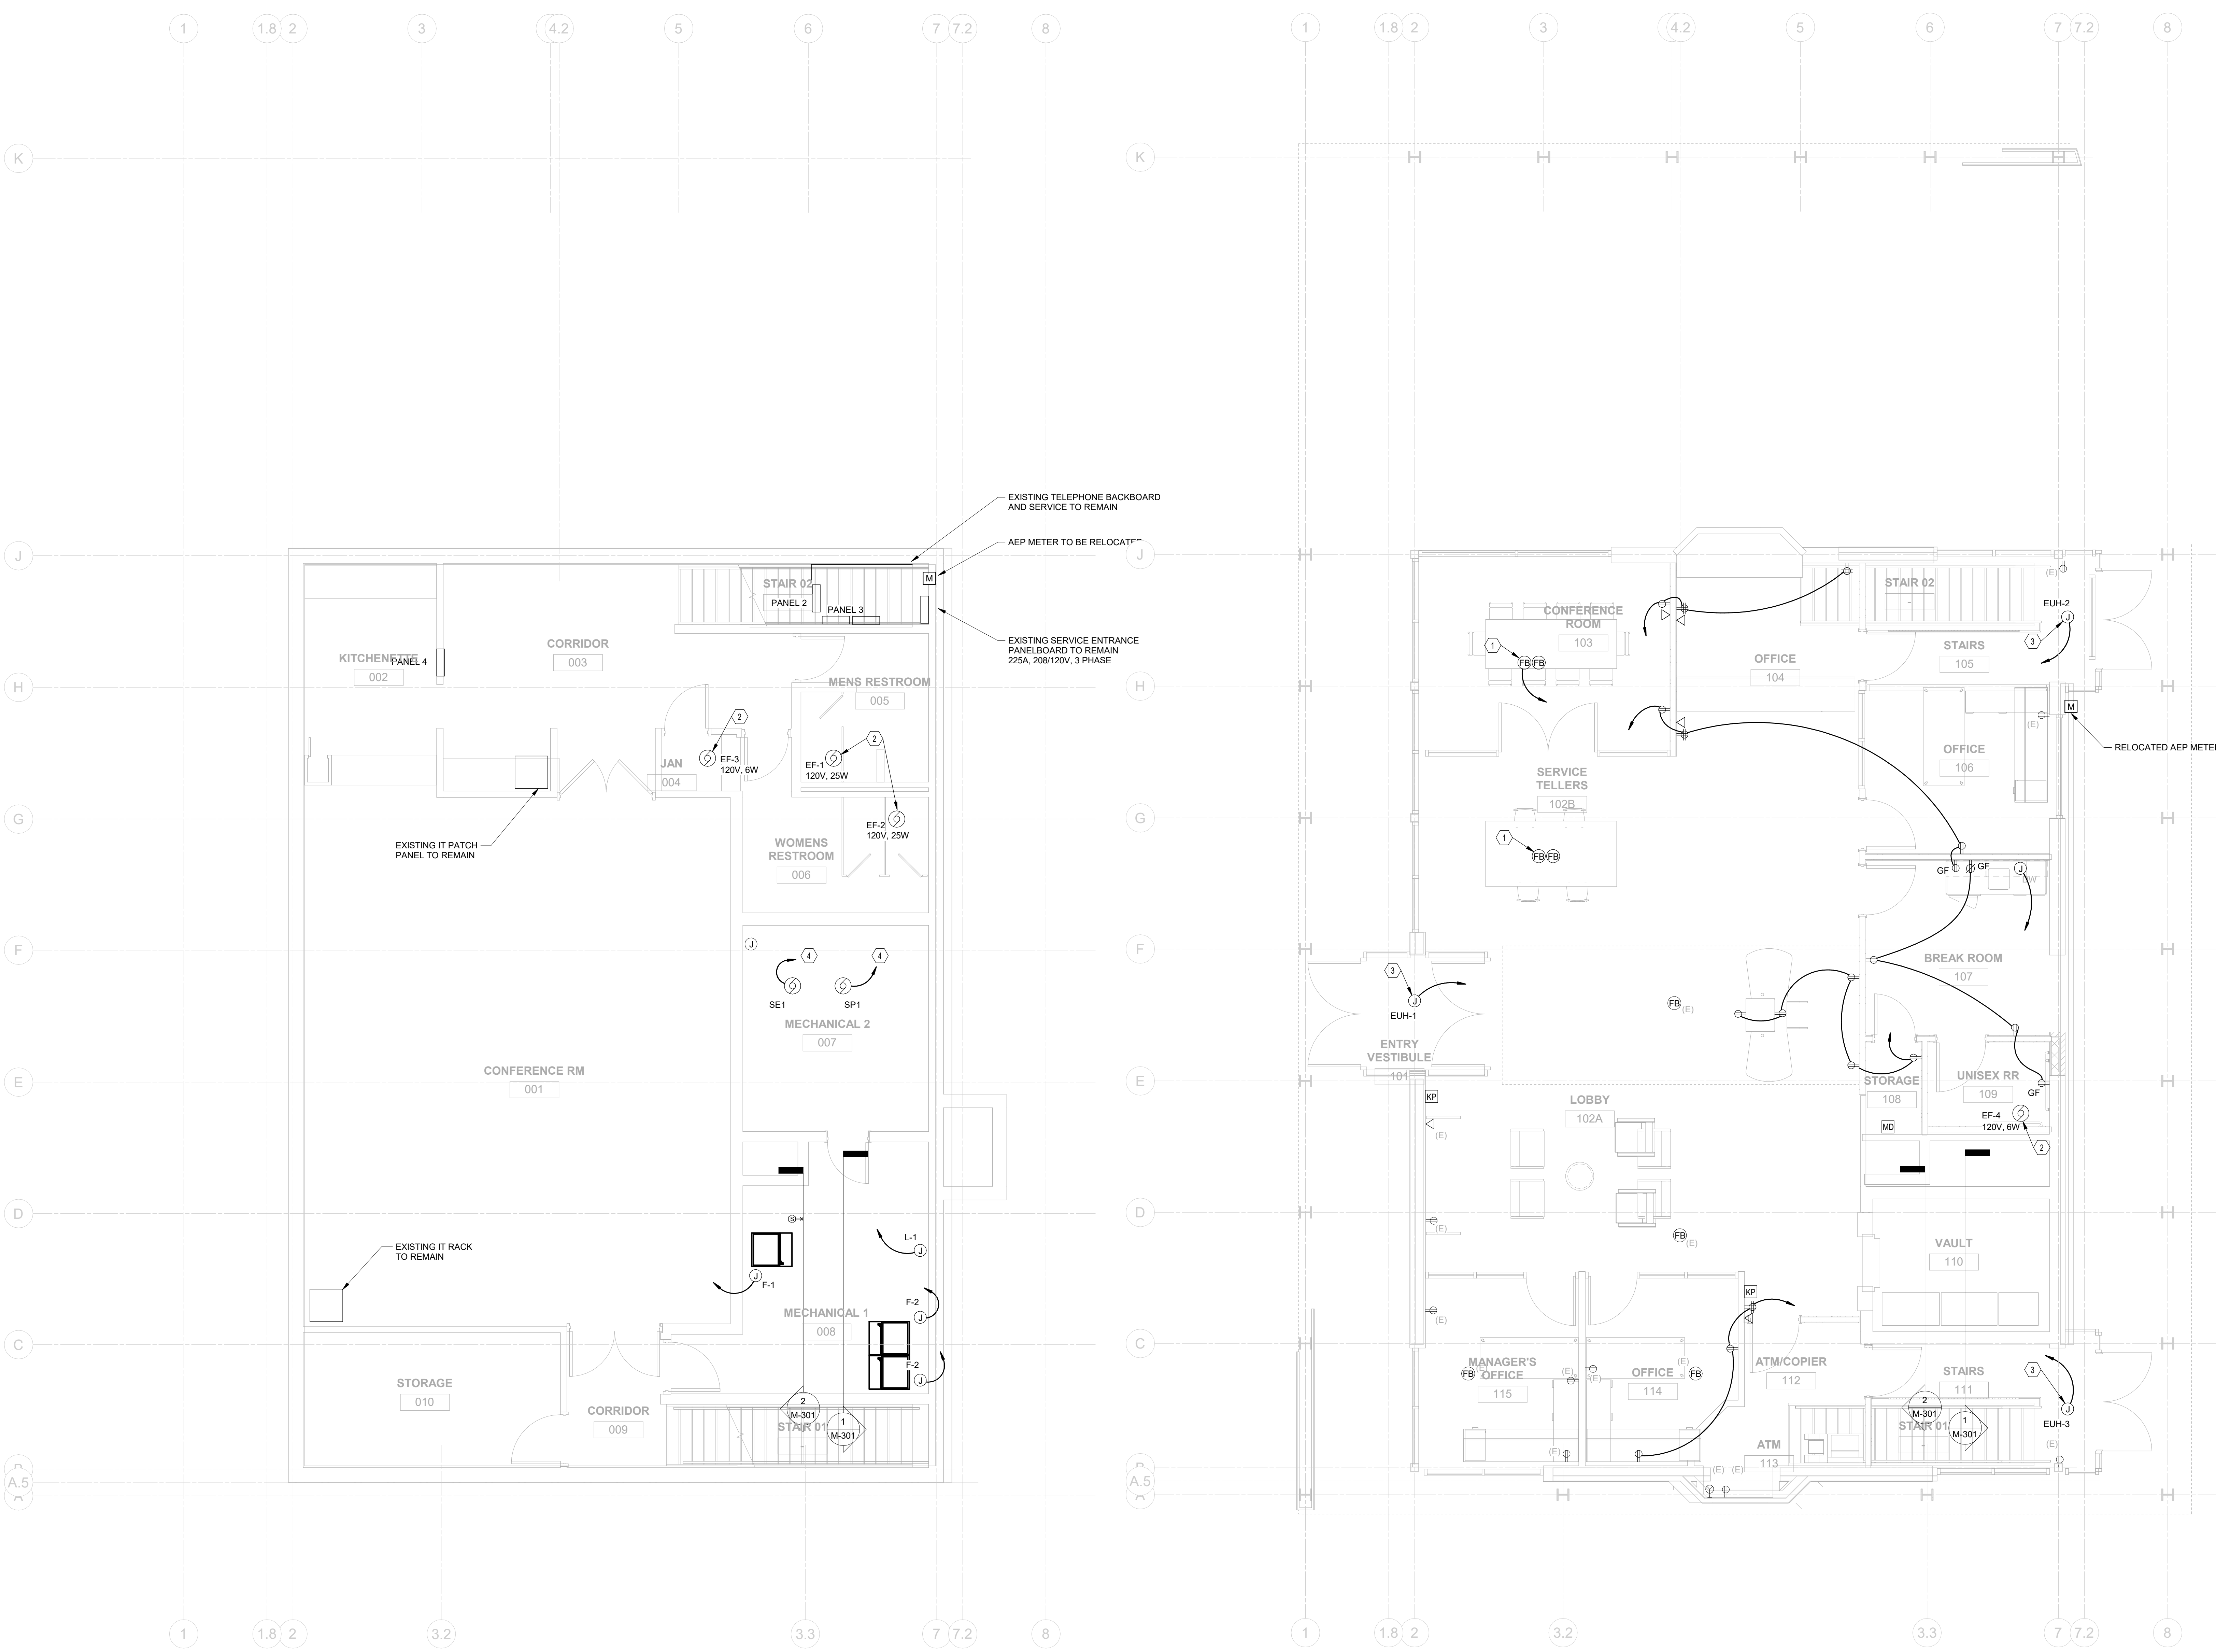2 PLAN FIRST FLOOR PLAN - ELECTRICAL
 1/4" = 1'-0"

- GENERAL NOTES:**
- A. UNLESS NOTED OTHERWISE NO ELECTRICAL WORK ANTICIPATED IN BASEMENT.
- CODED NOTES:**
1. PROVIDE POKE THRU RECEPTACLE AND DATA OUTLET.
 2. EXHAUST FAN 120V FRACTIONAL HP WITH INTEGRAL DISCONNECT. FAN SHALL BE CIRCUITED AND CONTROLLED WITH LIGHTS SERVING THE SPACE.
 3. ELECTRIC UNIT HEATER. 208V SINGLE PHASE 19.2A WITH INTEGRAL DISCONNECT.
 4. UTILIZE EXISTING CIRCUIT RETAINED FROM DEMOLITION PHASE TO SERVE NEW EQUIPMENT. INTERCEPT CIRCUIT, MATCH WIRE SIZE, MAKE JUNCTIONS AND EXTEND TO NEW EQUIPMENT AS NECESSARY.


#	DATE	CHANGE DESCRIPTION

RENOVATION OF HEARTLAND BANK DUBLIN
 6500 FRANTZ ROAD
 DUBLIN, OH 43017
 FOR
HEARTLAND BANK


MOODY-NOLAN
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 SUITE 300
 COLUMBUS, OHIO 43215
 PHONE: (614) 461-4664
 FAX: (614) 280-8881

DRAWING TITLE:
FLOOR PLANS - POWER/SYSTEMS


PROGRESS DRAWING NOT FOR CONSTRUCTION	11/30/2020
	DRAWN BY: Author CHECKED BY: Checker
	20022
E-201	
FINAL DEVELOPMENT PLAN	

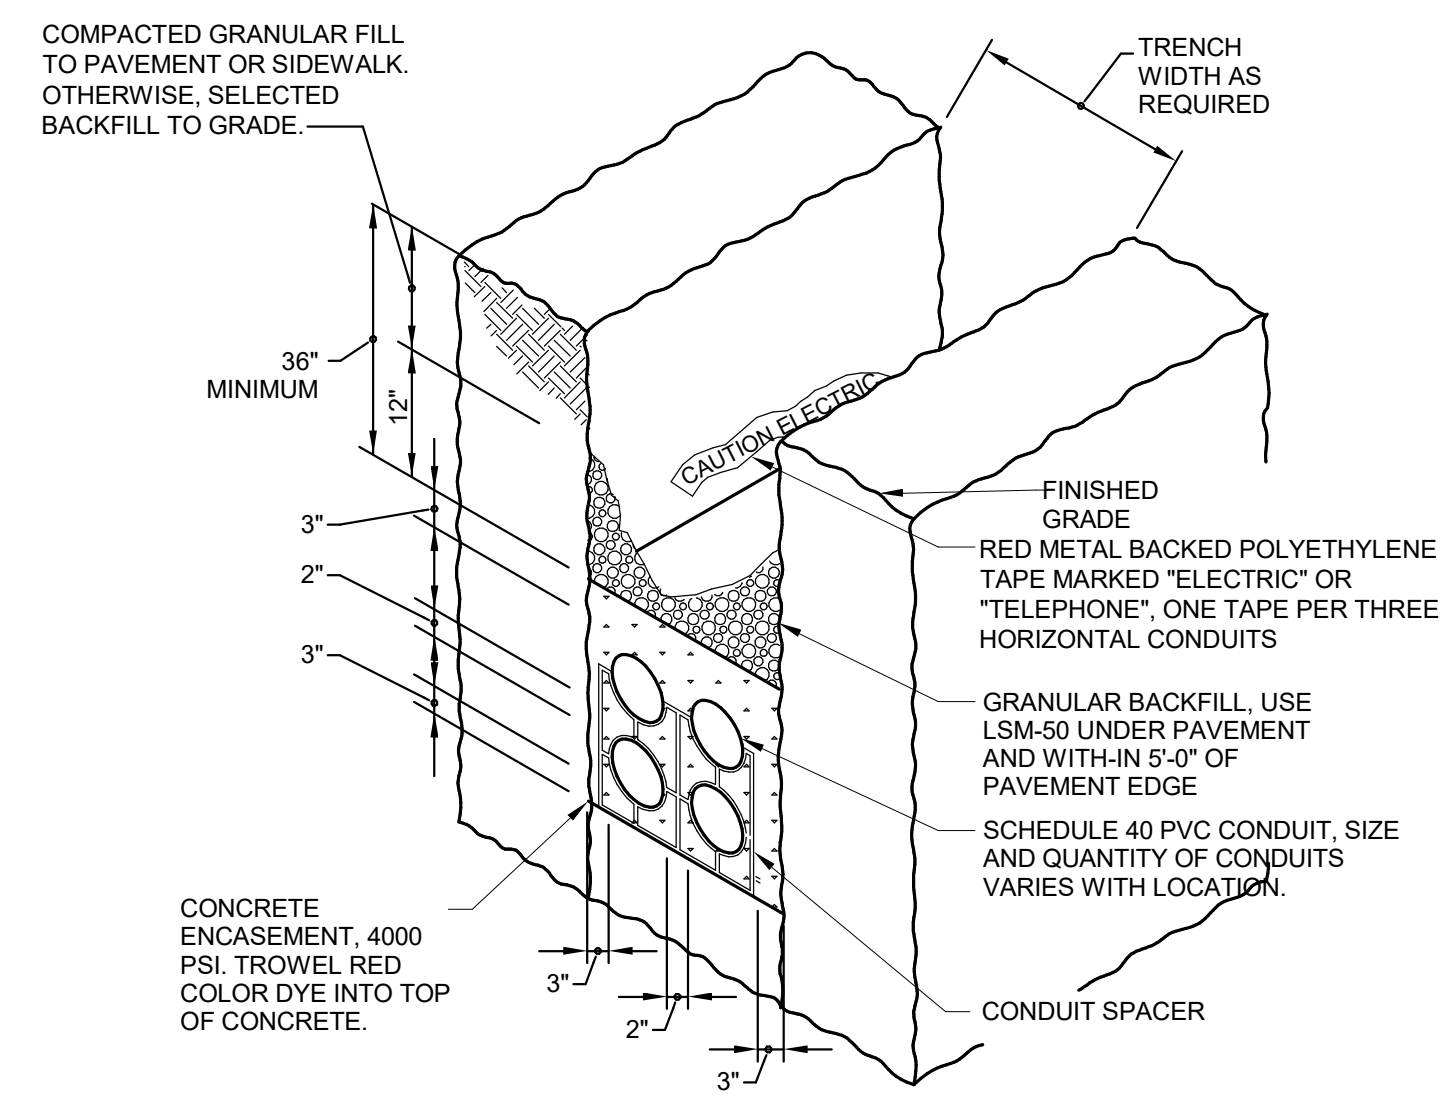

1 **DETAIL - CONCRETE ENCASED CONDUIT**
NTS

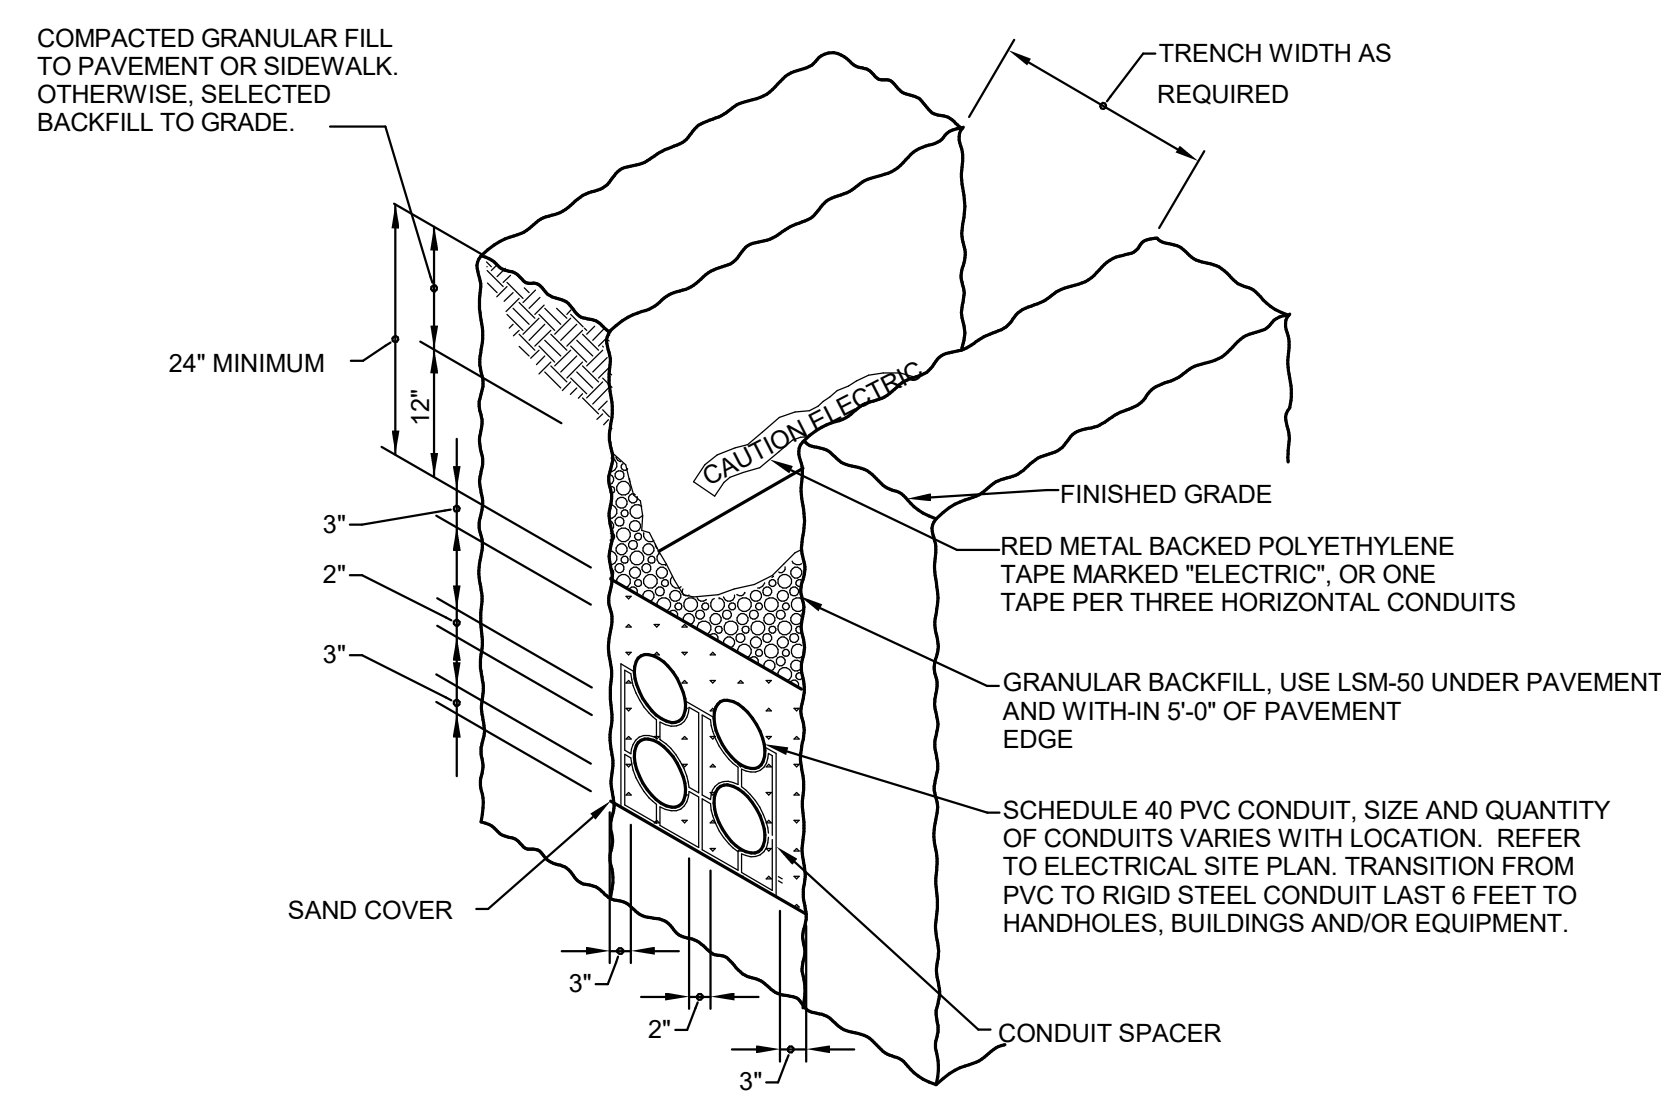

2 **DETAIL - DIRECT BURIED CONDUIT**
NTS

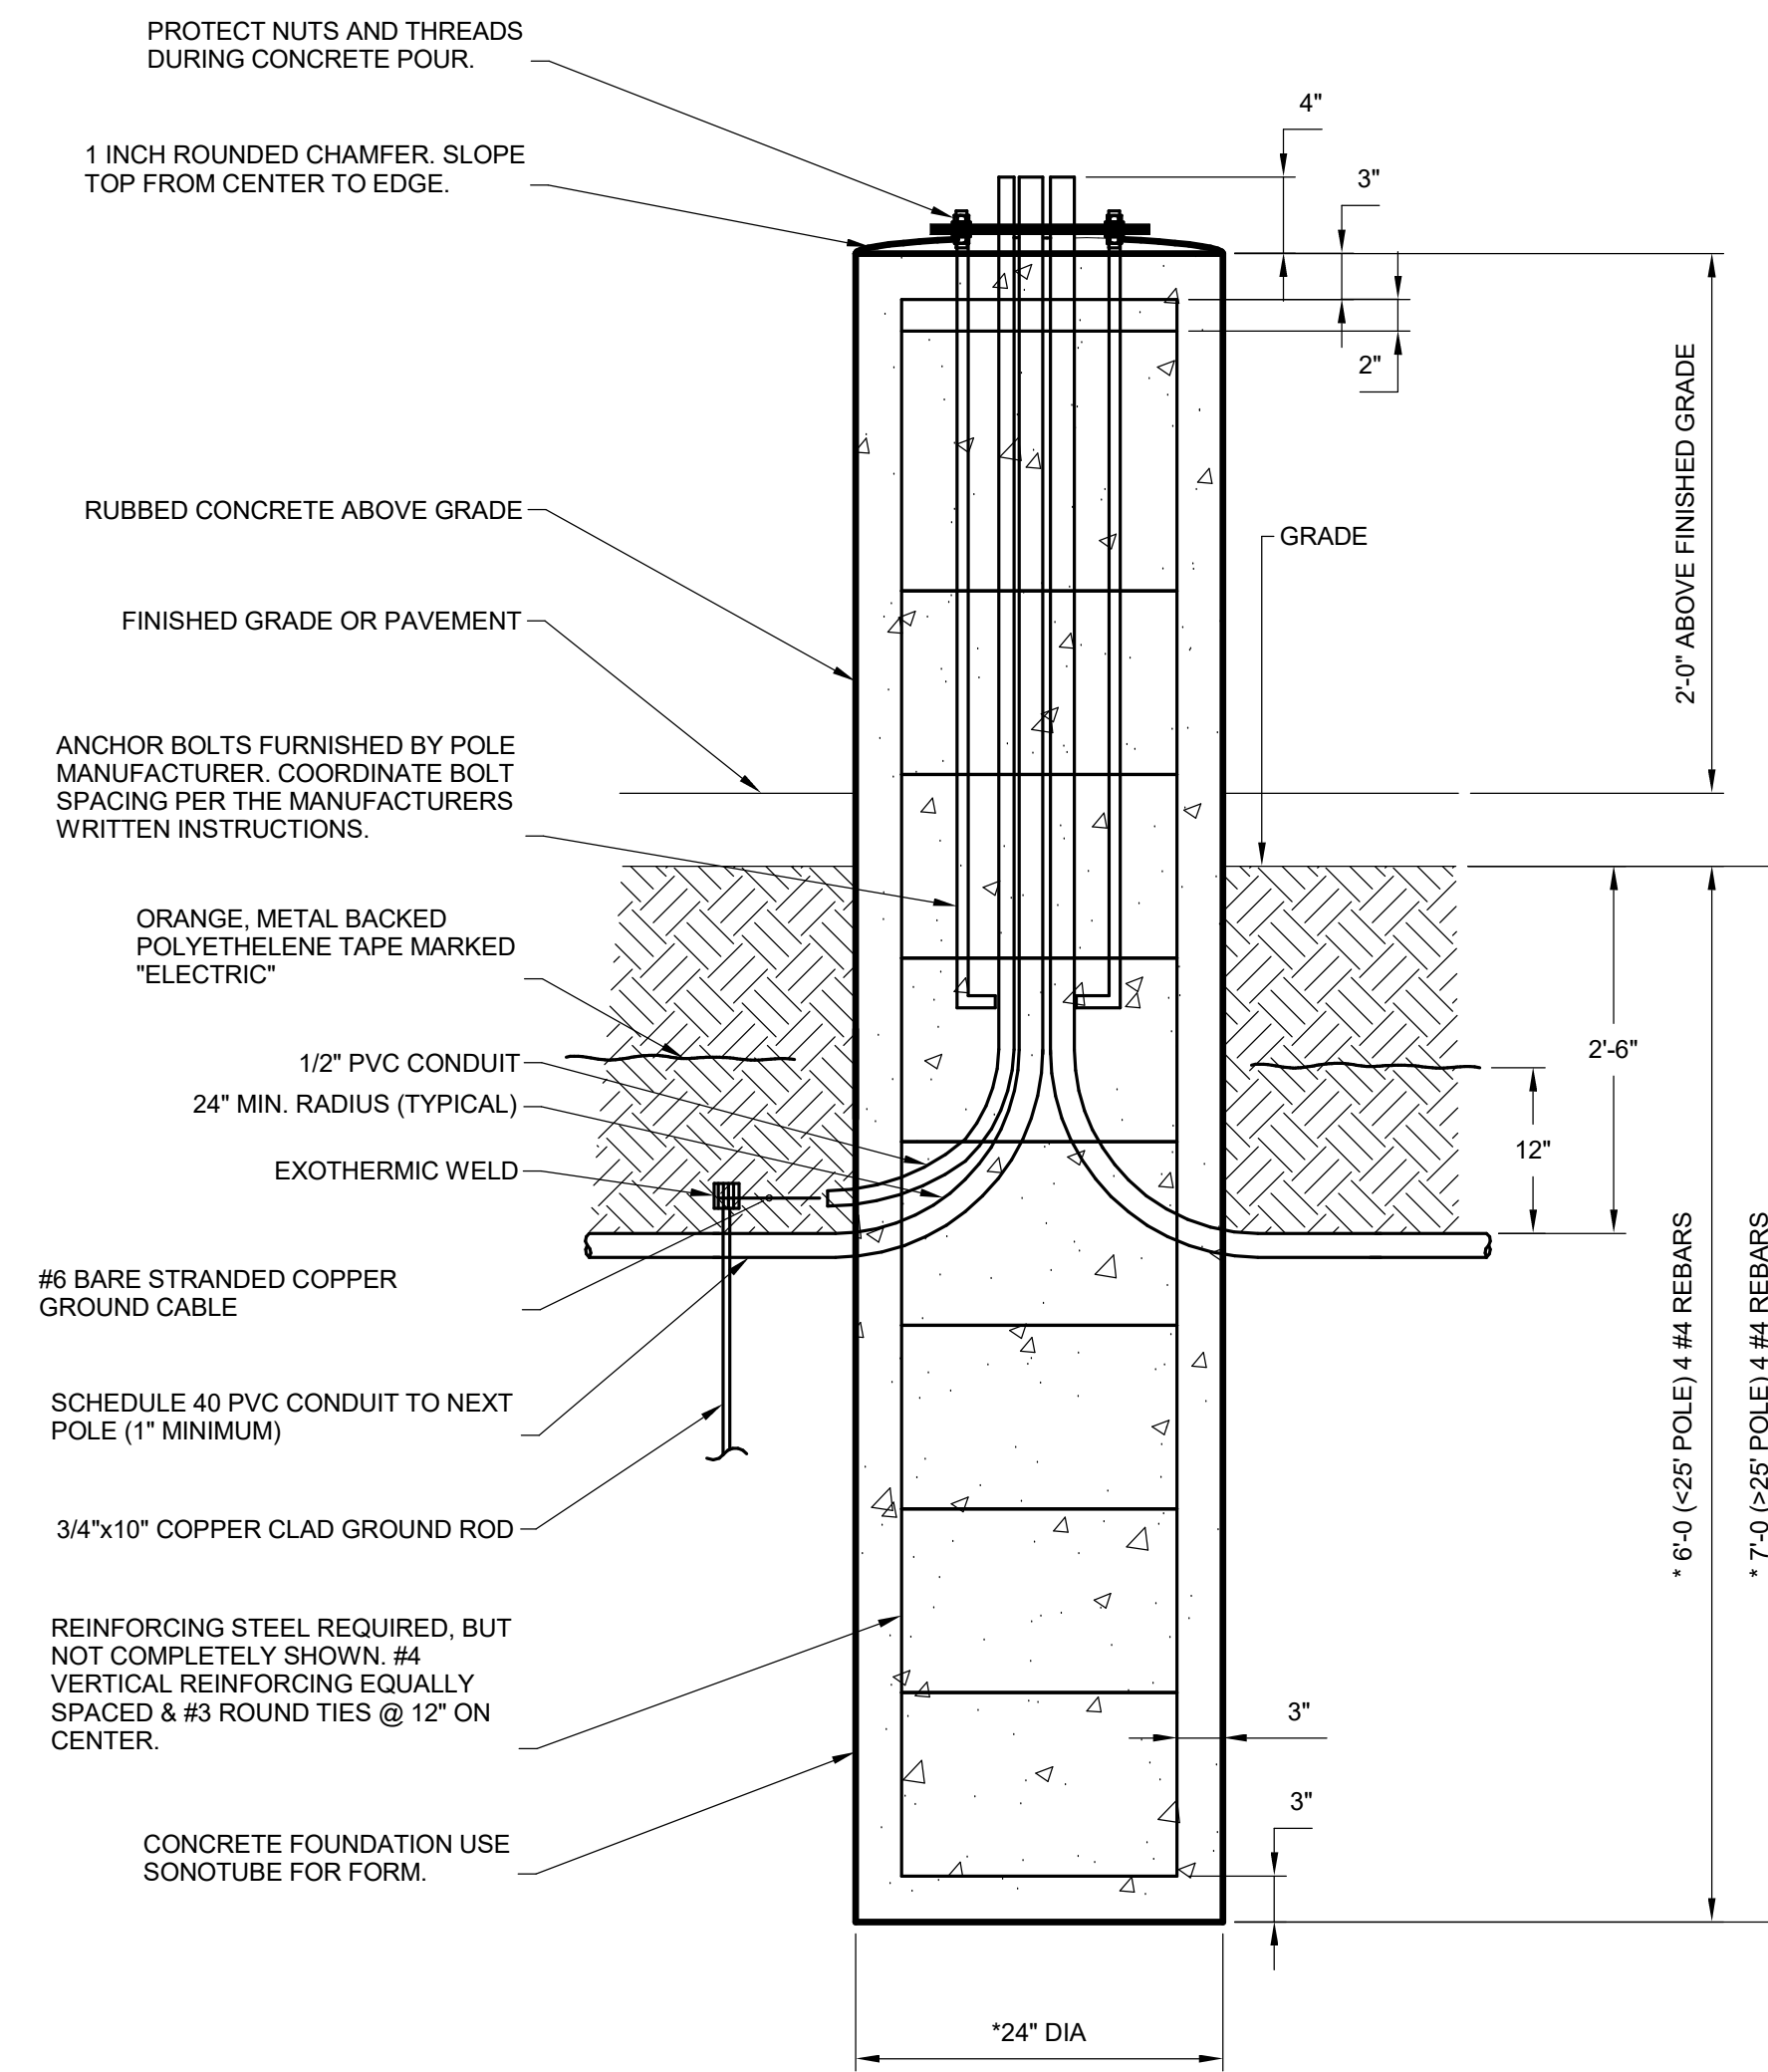

3 **DETAIL - CONCRETE POLE BASE**
NTS

#	DATE	CHANGE DESCRIPTION

RENOVATION OF HEARTLAND BANK DUBLIN
6500 FRANTZ ROAD
DUBLIN, OH 43017
FOR
HEARTLAND BANK

MOODY-NOLAN
300 SPRUCE STREET
SUITE 300
COLUMBUS, OHIO 43215
PHONE: (614) 461-4664
FAX: (614) 280-8881

DRAWING TITLE:
DETAILS ELECTRICAL

PROGRESS DRAWING NOT FOR CONSTRUCTION	11/30/2020
	DRAWN BY: Author CHECKED BY: Checker
	20022
E-501	
FINAL DEVELOPMENT PLAN	

Panel:

Location: STAIR 02 -
Supply From: MOUNTING: Recessed
Enclosure: Type 1

Volts: 120/208 Wye
Phases: 3
Wires: 4

A.I.C. Rating:
Mains Type:
Mains Rating: 100 A
MCB Rating: 225 A

CK T	Circuit Description	Trip	Pole s	A	B	C	Pole s	Trip	Circuit Description	CK T
1	(E) UPS	20 A	1	0.0	0.0		1	20 A	(E) EXISTING LOAD	2
3	(E) WEST WALL #1	20 A	1				1	20 A	(E) EXISTING LOAD	4
5	(E) SOUTH WALL #2	20 A	1				1	20 A	(E) EXISTING LOAD	6
7	(E) WEST WALL #2	20 A	1	0.0	0.0		1	20 A	(E) EXISTING LOAD	8
9	SPARE	20 A	1				1	20 A	(E) EXISTING LOAD	10
11	(E) IRRIGATION TIMER	20 A	1				1	20 A	(E) EXISTING LOAD	12
13	(E) SOUTH WALL #1	20 A	1	0.0	0.0		1	20 A	SPARE	14
15	SPARE	20 A	1				1	20 A	SPARE	16
17	SPACE	--	--				--	--	SPACE	18
19	SPACE	--	--				--	--	SPACE	20
21	SPACE	--	--				--	--	SPACE	22
23	SPACE	--	--				--	--	SPACE	24
Total Load:				0.0 kVA	0.0 kVA	0.0 kVA				
Total...				0 A	0 A	0 A				
Conn. Load:										
Demand Load:										
Demand...										

Panel: PANEL 2

Location: STAIR 02 -
Supply From: MOUNTING: Recessed
Enclosure: Type 1

Volts: 120/208 Wye
Phases: 3
Wires: 4

A.I.C. Rating:
Mains Type:
Mains Rating: 100 A
MCB Rating: 225 A

CK T	Circuit Description	Trip	Pole s	A	B	C	Pole s	Trip	Circuit Description	CK T
1	(E) UPS	30 A	1	0.0	0.0		1	30 A	(E) SORTER	2
3	(E) WEST WALL #1	20 A	1				1	20 A	(E) EAST WALL #2	4
5	(E) SOUTH WALL #2	20 A	1				1	20 A	(E) EAST WALL #3	6
7	(E) WEST WALL #2	20 A	1	0.0	0.0		1	20 A	(E) EAST WALL #1	8
9	SPARE	20 A	1				1	20 A	SPARE	10
11	(E) IRRIGATION TIMER	20 A	1				1	20 A	SPARE	12
13	(E) SOUTH WALL #1	20 A	1	0.0	0.0		1	20 A	SPARE	14
15	SPARE	20 A	1				1	20 A	SPARE	16
17	SPACE	--	--				--	--	SPACE	18
19	SPACE	--	--				--	--	SPACE	20
21	SPACE	--	--				--	--	SPACE	22
23	SPACE	--	--				--	--	SPACE	24
Total Load:				0.0 kVA	0.0 kVA	0.0 kVA				
Total...				0 A	0 A	0 A				
Conn. Load:										
Demand Load:										
Demand...										

Panel: PANEL 3

Location: STAIR 02 -
Supply From: MOUNTING: Recessed
Enclosure: Type 1

Volts: 120/208 Wye
Phases: 3
Wires: 4

A.I.C. Rating:
Mains Type:
Mains Rating: 100 A
MCB Rating: 225 A

CK T	Circuit Description	Trip	Pole s	A	B	C	Pole s	Trip	Circuit Description	CK T
1	(E) MAIN UPS	20 A	2	0.0	0.0		1	20 A	(E) GEN	2
3	SPACE	--	--				1	20 A	(E) SUMP PUMP	4
5	SPACE	--	--				1	20 A	SPACE	6
7	SPACE	--	--				1	20 A	SPACE	8
Total Load:				0.0 kVA	0.0 kVA	0.0 kVA				
Total...				0 A	0 A	0 A				
Conn. Load:										
Demand Load:										
Demand...										

Panel: PANEL 4

Location: KITCHENETTE 002
Supply From: MOUNTING: Recessed
Enclosure: Type 1

Volts: 120/208 Wye
Phases: 3
Wires: 4

A.I.C. Rating:
Mains Type:
Mains Rating: 100 A
MCB Rating: 100 A

CK T	Circuit Description	Trip	Pole s	A	B	C	Pole s	Trip	Circuit Description	CK T
1	(E) LTG DRIVE THRU	20 A	1	0.0	0.0		1	20 A	(E) RECPT TELLER	2
3	SPARE	20 A	1				1	20 A	(E) LTG MEETING RM	4
5	(E) RECPT DRIVE THRU	20 A	1				1	20 A	(E) RECPT FRONT	6
7	(E) LTG CANOPY	20 A	1	0.0	0.0		1	20 A	(E) RECPT DRIVE THRU	8
9	(E) LANE RTS (TWIN)	20 A	1				1	20 A	(E) RECPT FLOOR	10
11	(E) LANE RTS	20 A	1				1	20 A	(E) LTG ENTRANCE	12
13	(E) LANE RTS	30 A	1	0.0	0.0		1	20 A	(E) RECPT/DYE	14
15	(E) LTG EXTERIOR	20 A	1				--	--	(E) RECPT FLOOR	16
17	(E) LTG EXTERIOR	20 A	1				1	20 A	(E) RECPT TELLER	18
19	(E) LTG SIGN	20 A	1	0.0	0.0		1	20 A	(E) RECPT DRIVE THRU	20
Total Load:				0.0 kVA	0.0 kVA	0.0 kVA				
Total...				0 A	0 A	0 A				
Conn. Load:										
Demand Load:										
Demand...										

LUMINAIRE SCHEDULE

TYPE	DIMENSIONS	MOUNTING	CONSTRUCTION AND FINISH	DESCRIPTION AND OPTIONS	LAMPS	DRIVER(S)	VOLTAGE/OAD	APPROVED MANUFACTURER(S)
P1			20" SQUARE STEEL POLE (BRONZE)	AREA LIGHT TYPE 3 DISTRIBUTION	4000K	ELECTRONIC 0-10V DRIVER	120/277V 52W	LITHONIA RSX1
P2			20" SQUARE STEEL POLE (BRONZE)	AREA LIGHT TYPE 4 DISTRIBUTION	4000K	ELECTRONIC 0-10V DRIVER	120/277V 52W	LITHONIA RSX1
R1	4" DIA x 6" DEEP	RECESSED GRID OR DRYWALL	COLD ROLLED FORMED STEEL, FLAT ACRYLIC LENS	RECESSED DOWN LIGHT MEDIUM DISTRIBUTION	INTEGRAL 4000K 2000 LUMENS	ELECTRONIC 0-10V DRIVER	120/277V 18W	GOTHAM EVO4
R2	2"x4" MAX 5.25" DEEP	RECESSED CEILING GRID	STEEL FORMED STEEL, ACRYLIC DIFFUSER	RECESSED TROFFER	INTEGRAL 4000K 4300 LUMENS	ELECTRONIC 0-10V DRIVER	120/277V 40W	LITHONIA EPANL
R3	6" X 8" MAX 5.25" DEEP	RECESSED	EXTRUDED ALUMINUM BODY WITH MICROPRISMATIC ACRYLIC LENS	RECESSED LINEAR WET LISTED	INTEGRAL 4000K 375LU/FT	ELECTRONIC 0-10V DRIVER	120/277V 6W/FT	MARK S1LD
S1	6" X 4' 6" DEEP	SUSPENDED	COLD ROLLED FORMED STEEL, FLAT ACRYLIC LENS	LINEAR INDUSTRIAL	INTEGRAL 4000K 4000 LUMENS	ELECTRONIC 0-10V DRIVER	120/277V 40W	LITHONIA CLX
S2A	6" X LENGTH AS SHOWN ON DRAWINGS	SUSPENDED	EXTRUDED ALUMINUM BODY WITH MICROPRISMATIC ACRYLIC LENS	LINEAR SUSPENDED DIRECT/INDIRECT	INTEGRAL 4000K 375LU/FT	ELECTRONIC 0-10V DRIVER	120/277V 6W/FT	MARK S1LD
S2B	6" X 4'	SUSPENDED	EXTRUDED ALUMINUM BODY WITH MICROPRISMATIC ACRYLIC LENS	LINEAR SUSPENDED DIRECT/INDIRECT INTEGRAL MOTION SENSOR AND 90 MINUTE BATTERY BACKUP	INTEGRAL 4000K 375LU/FT	ELECTRONIC 0-10V DRIVER	120/277V 6W/FT	MARK S1LD
W1	6" X 2'	SURFACE/WALL	STEEL FORMED STEEL, ACRYLIC DIFFUSER	VANITY LIGHT	INTEGRAL 4000K 1200 LUMENS	ELECTRONIC 0-10v DRIVER	120/277V 18W	ACCESS 62518
W2		SURFACE/WALL	THERMOPLASTIC	REMOTE HEAD WEATHERPROOF	4000K	N/A	9.6V 3W	LITHONIA ERE-GY-SGL-WP-SQ-M12
W3	12.6" X 9.1" X 1.9" DEEP	SURFACE/WALL	LOW PROFILE, THERMOPLASTIC HOUSING, INJECTION-MOLDED	EMERGENCY WALL PACK DUAL HEAD, 90 MINUTE BATTERY	4000K	N/A	120/277V 1.5W	LITHONIA ELMILT
W4	8" X 11" X 3" DEEP	SURFACE/WALL	DIE CAST ALUMINUM HOUSING	WALL PACK INTEGRAL PHOTOCELL	INTEGRAL 4000K 2900 LUMENS	ELECTRONIC 0-10V DRIVER	120/277V 24W	LITHONIA WPX1 LED P2 40K
X1	10.75" X 13" 4" DEEP	UNIVERSAL SURFACE CEILING/WALL	THERMOPLASTIC	UNIVERSAL MOUNT EXIT INTEGRAL EMERGENCY LIGHT BAR NICAD BATTERY	LED	N/A	120/277V 1.5W	LITHONIA ECBR

#	DATE	CHANGE DESCRIPTION

RENOVATION OF HEARTLAND BANK DUBLIN
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FOR
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300 SPRUCE STREET
SUITE 300
COLUMBUS, OHIO 43215
PHONE: (614) 461-4664
FAX: (614) 280-8881

DRAWING TITLE:

SCHEDULES - ELECTRICAL

11/30/2020
DRAWN BY: Author CHECKED BY: Checker
20022
E-601
FINAL DEVELOPMENT PLAN

PROGRESS DRAWING NOT FOR CONSTRUCTION