
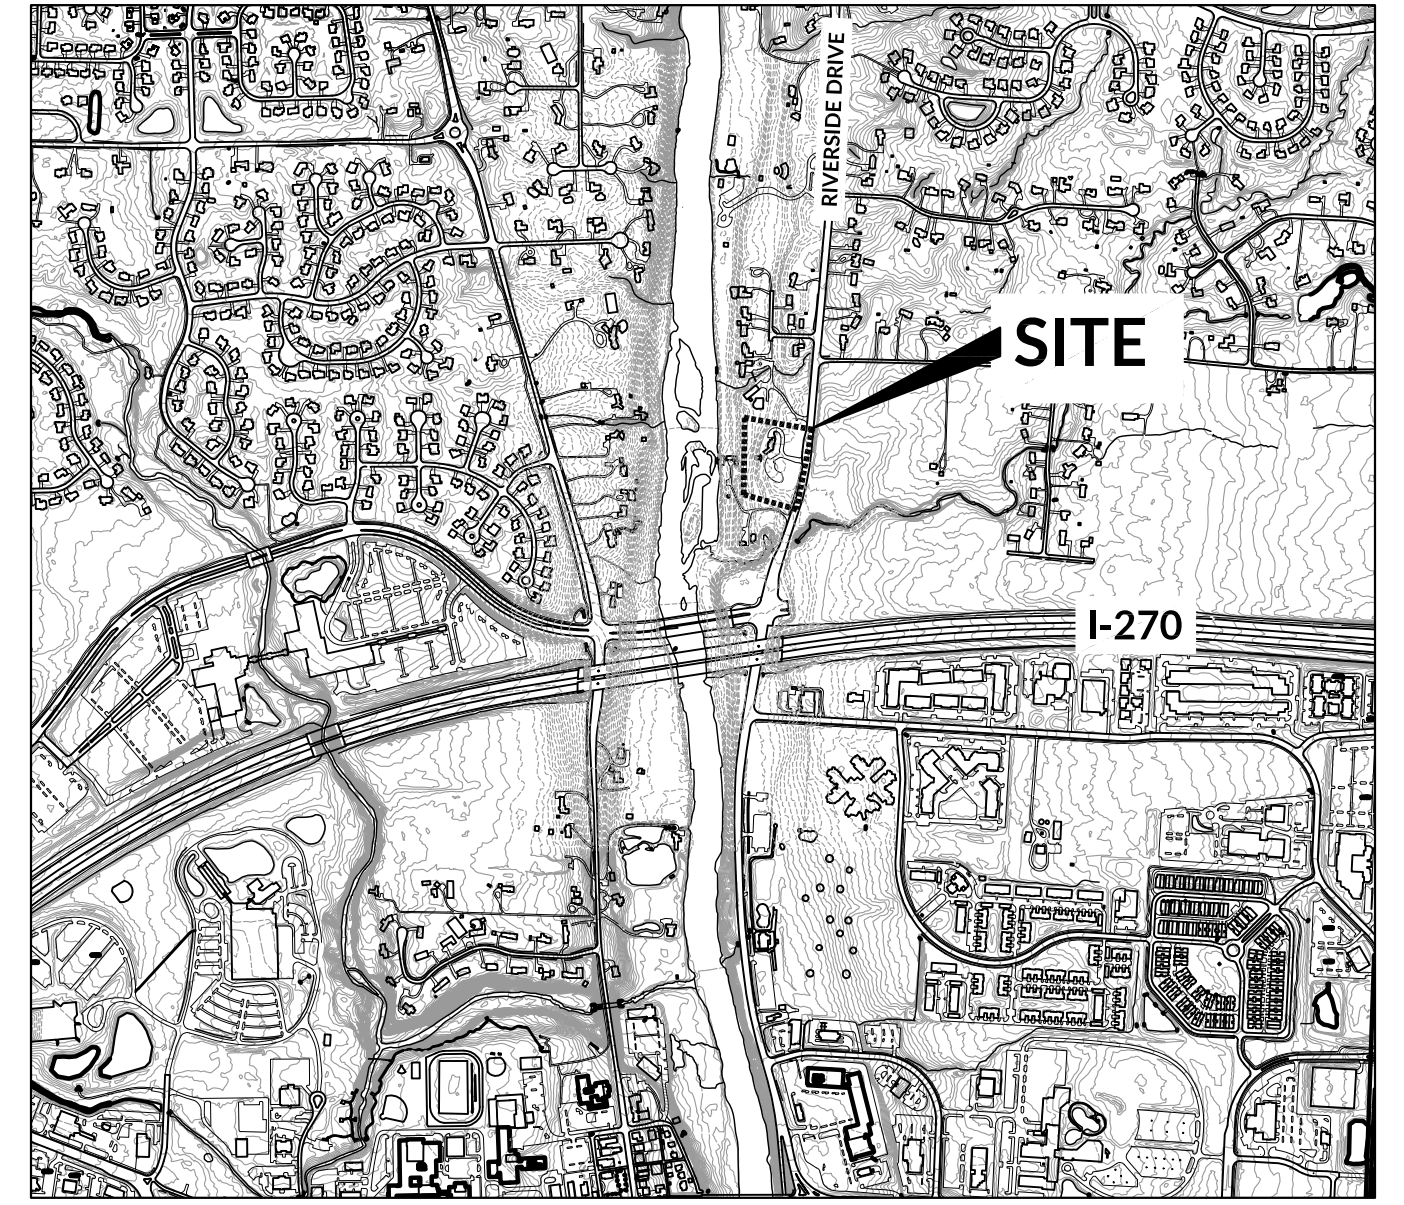


MINOR PROJECT REVIEW
FOR
DUBLIN ARTS CENTER
CABIN RECONSTRUCTION AND REAR TERRACE IMPROVEMENTS
7125 RIVERSIDE DRIVE
DUBLIN, OHIO 43016

SHEET INDEX	
SHEET NUMBER	TITLE
GENERAL SHEETS	
G001	EXISTING CONDITIONS/TOPOGRAPHIC SURVEY
G002	OVERALL SITE MASTER PLAN
G003	ADA & ZONING PLAN
PHASE 1 CABIN CONSTRUCTION	
L001	GENERAL NOTES
L101	DEMOLITION PLAN
L201	LAYOUT & MATERIALS PLAN
L301	GRADING PLAN
L401	PLANTING PLAN
L501	CABIN ENLARGEMENT PLAN
L502	SOUTH ENTRY ENLARGEMENT PLAN
L601	CONSTRUCTION DETAILS
L602	CONSTRUCTION DETAILS
L603	CONSTRUCTION DETAILS
L604	CONSTRUCTION DETAILS
L701	PLANT MATERIALS
L702	LIGHTING SPECIFICATION
L703	LIGHTING PHOTOMETRICS
L704	STONE MATERIALS
1	DRAINAGE & UTILITY PLAN

GENERAL PROJECT INFORMATION	
ADDRESS	7125 RIVERSIDE DRIVE
PARCEL NO. (NORTH PARCEL)	273-009098-00
PARCEL NO. (SOUTH PARCEL)	273-009097-00
LEGAL ACRES (NORTH PARCEL)	4.584
LEGAL ACRES (SOUTH PARCEL)	1.371
LEGAL ACRES (TOTAL)	5.955
OWNER/DEVELOPER	CITY OF DUBLIN OHIO
	P.O. BOX 800
	DUBLIN OH 43017
ZONING CLASSIFICATION/ DISTRICT	R1 - RESTRICTED SUBURBAN RESIDENTIAL DISTRICT
ZONING CLASSIFICATION/ DISTRICT OF ADJACENT PARCELS	R1 - RESTRICTED SUBURBAN RESIDENTIAL DISTRICT
TOTAL ACREAGE	5.95 AC (PER SURVEY BOUNDARY)
PHASE 1 WORK AREA	0.86 AC
PHASE 2 WORK AREA	0.55 AC

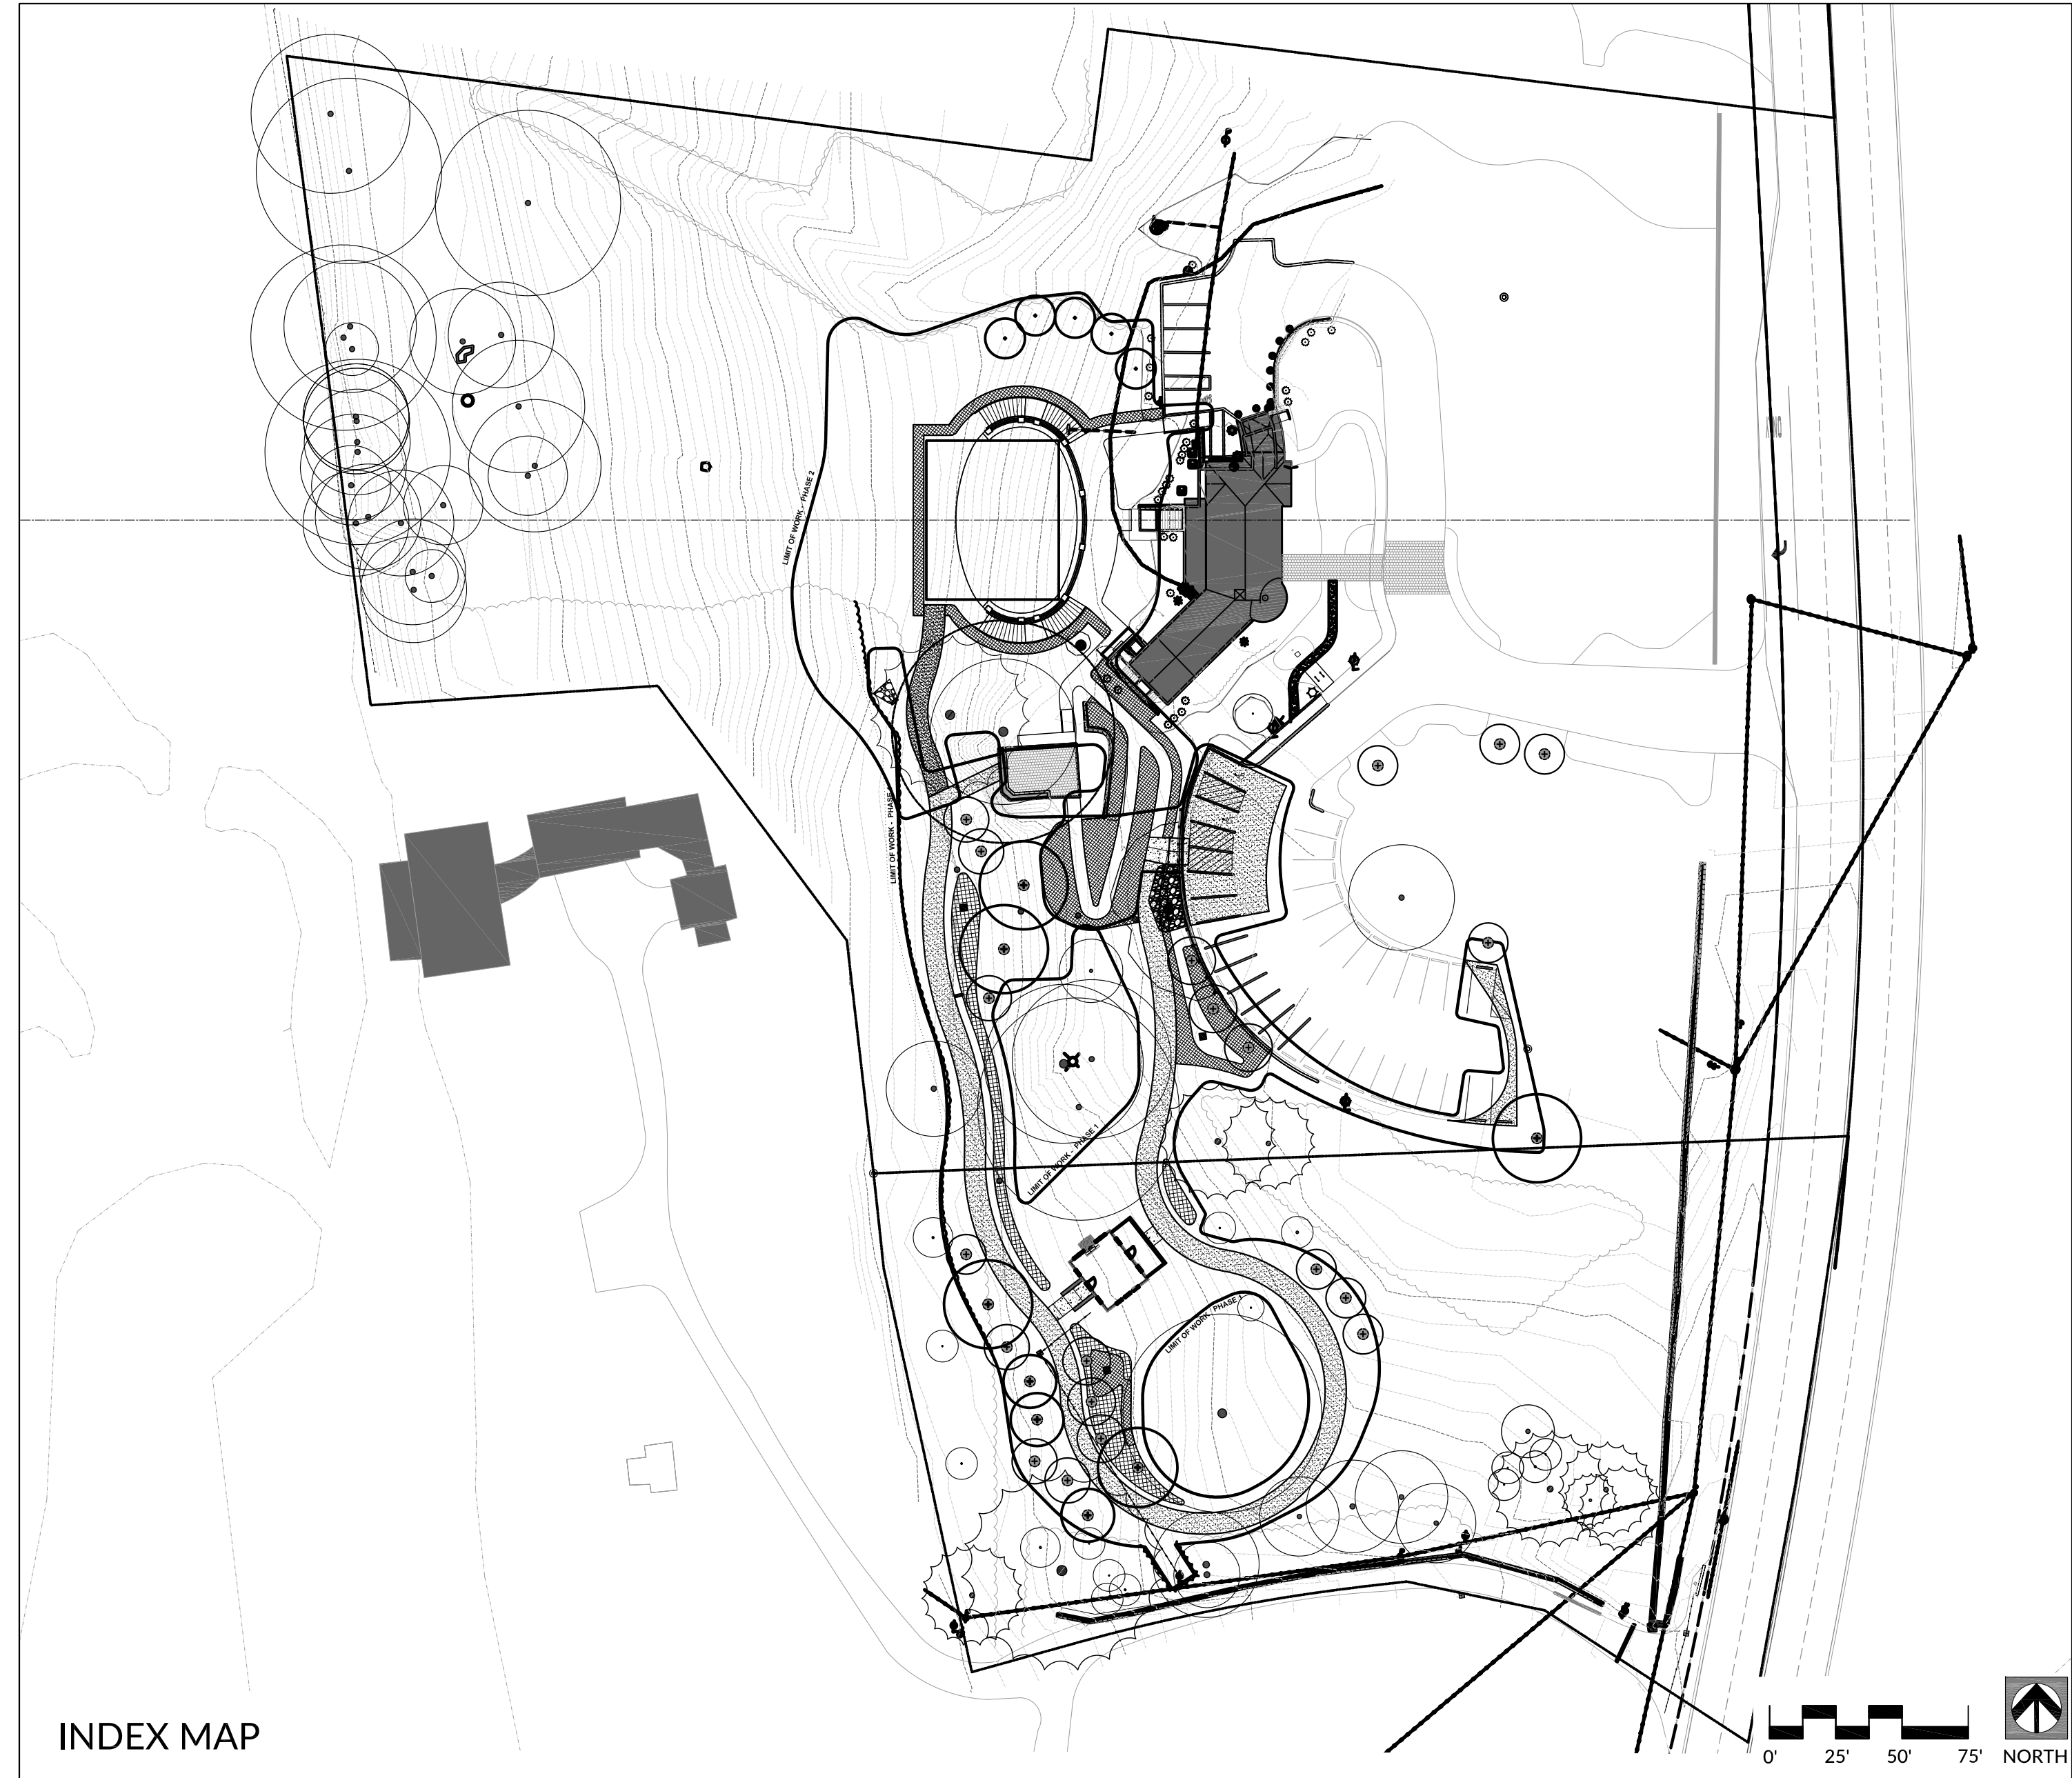

LOCATION MAP
NOT TO SCALE

PROJECT SCOPE OF WORK NARRATIVE:

THIS PROJECT INCLUDES SEVERAL SITE ENHANCEMENTS AND THE RELOCATION OF A HISTORIC LOG CABIN TO THE GROUNDS OF THE DUBLIN ARTS CENTER.

THE PROJECT HAS BEEN SPLIT INTO SEVERAL PHASES. THE FIRST PHASE WILL INCLUDE CONSTRUCTION OF THE HISTORIC LOG CABIN ON THE SOUTH SIDE OF THE PROPERTY. THIS PHASE INCLUDES AN ADA-COMPLIANT TRAIL FROM THE EXISTING PARKING LOT TO THE FRONT AND BASEMENT DOORS OF THE CABIN. THIS PHASE ALSO INCLUDES RECONSTRUCTION OF A PORTION OF THE EXISTING PARKING LOT TO MEET CURRENT ADA GUIDELINES AS WELL AS VARIOUS SITE ELEMENTS WHICH WILL IMPROVE DRAINAGE.

THE SECOND PHASE OF THE PROJECT IS FOR REFERENCE ONLY AT THIS TIME BUT IS EXPECTED TO BE CONSTRUCTED IN THE NEXT SEVERAL YEARS. THIS PHASE INCLUDES CONSTRUCTION OF A LARGE STONE RETAINING WALL WHICH WILL CREATE A FLAT LAWN AREA TO HOST EVENTS AND OTHER ACTIVITIES. THIS PHASE WILL ALSO INCLUDE VARIOUS WALKWAYS, PLANTINGS, AND DRAINAGE FEATURES TO SUPPORT THE EVENT LAWN.

A FUTURE PHASE OF THE PROJECT WILL INCLUDE A 8' SHARED USE PATH FROM THE EVENT LAWN DOWN TO THE EDGE OF THE SCIOTO RIVER. A SECONDARY PATH WILL ACCOMMODATE ADA ACCESSIBILITY AND THE PROJECT WILL INCLUDE SIGNIFICANT REGRADING OF THE EXISTING LAWN HILLSIDE. THIS PHASE OF THE PROJECT HAS NO TIMELINE FOR CONSTRUCTION AND IS CONCEPTUAL IN ITS DESIGN DEVELOPMENT.

PROJECT OWNER:



LANDSCAPE ARCHITECT:


DESIGNING LOCAL
LANDSCAPE ARCHITECTURE

1223 EAST MAIN ST., SUITE 311
COLUMBUS, OH 43205
CONTACT: MATTHEW LEASURE, PLA
PHONE: 614.893.7178
EMAIL: MATT@DESIGNINGLOCAL.COM

ENGINEER:



SURVEYOR OF RECORD:

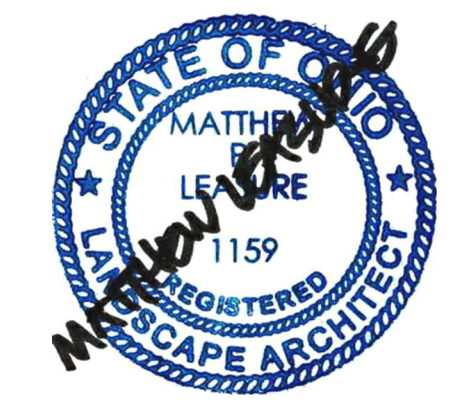

DATE
BY: **MATTHEW LEASURE** APRIL 8, 2022
MATTHEW P. LEASURE, PLA
OHIO REGISTRATION NO. 0701159



LEGEND - EXISTING CONDITIONS


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+	EX. SIGN	—	EX. WATER MAIN
⊕	EX. FIRE HYDRANT	—	EX. GAS MAIN
⊗	EX. WATER VALVE	—	EX. STORM
⊠	EX. CATCH BASIN	—	EX. COMBINED SEWER
○	EX. SAN. MANHOLE	—	EX. OVERHEAD EL.
⊞	EX. CURB INLET	—	EX. TREELINE
⊙	EX. STORM MANHOLE	—	EX. DECIDUOUS TREE
⊘	EX. GUY POLE	—	EX. EVERGREEN TREE
⊙	EX. UTILITY POLE	—	EX. TREE CRITICAL ROOT ZONE
⊙	EX. GUY WIRE		
⊙	EX. BENCHMARK		
—720	EX. MAJOR CONTOUR		
—719	EX. MINOR CONTOUR		


TOPOGRAPHIC SURVEY BY:



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LANDSCAPE ARCHITECTURE

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LEGEND - EXISTING CONDITIONS

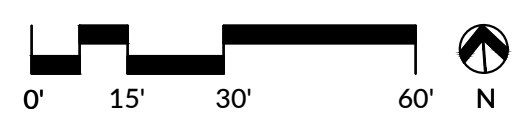⊛	EX. LIGHT POLE	—	EX. SANITARY
⊙	EX. SIGN	—	EX. WATER MAIN
⊕	EX. FIRE HYDRANT	—	EX. GAS MAIN
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—720—	EX. MAJOR CONTOUR		
—719—	EX. MINOR CONTOUR		

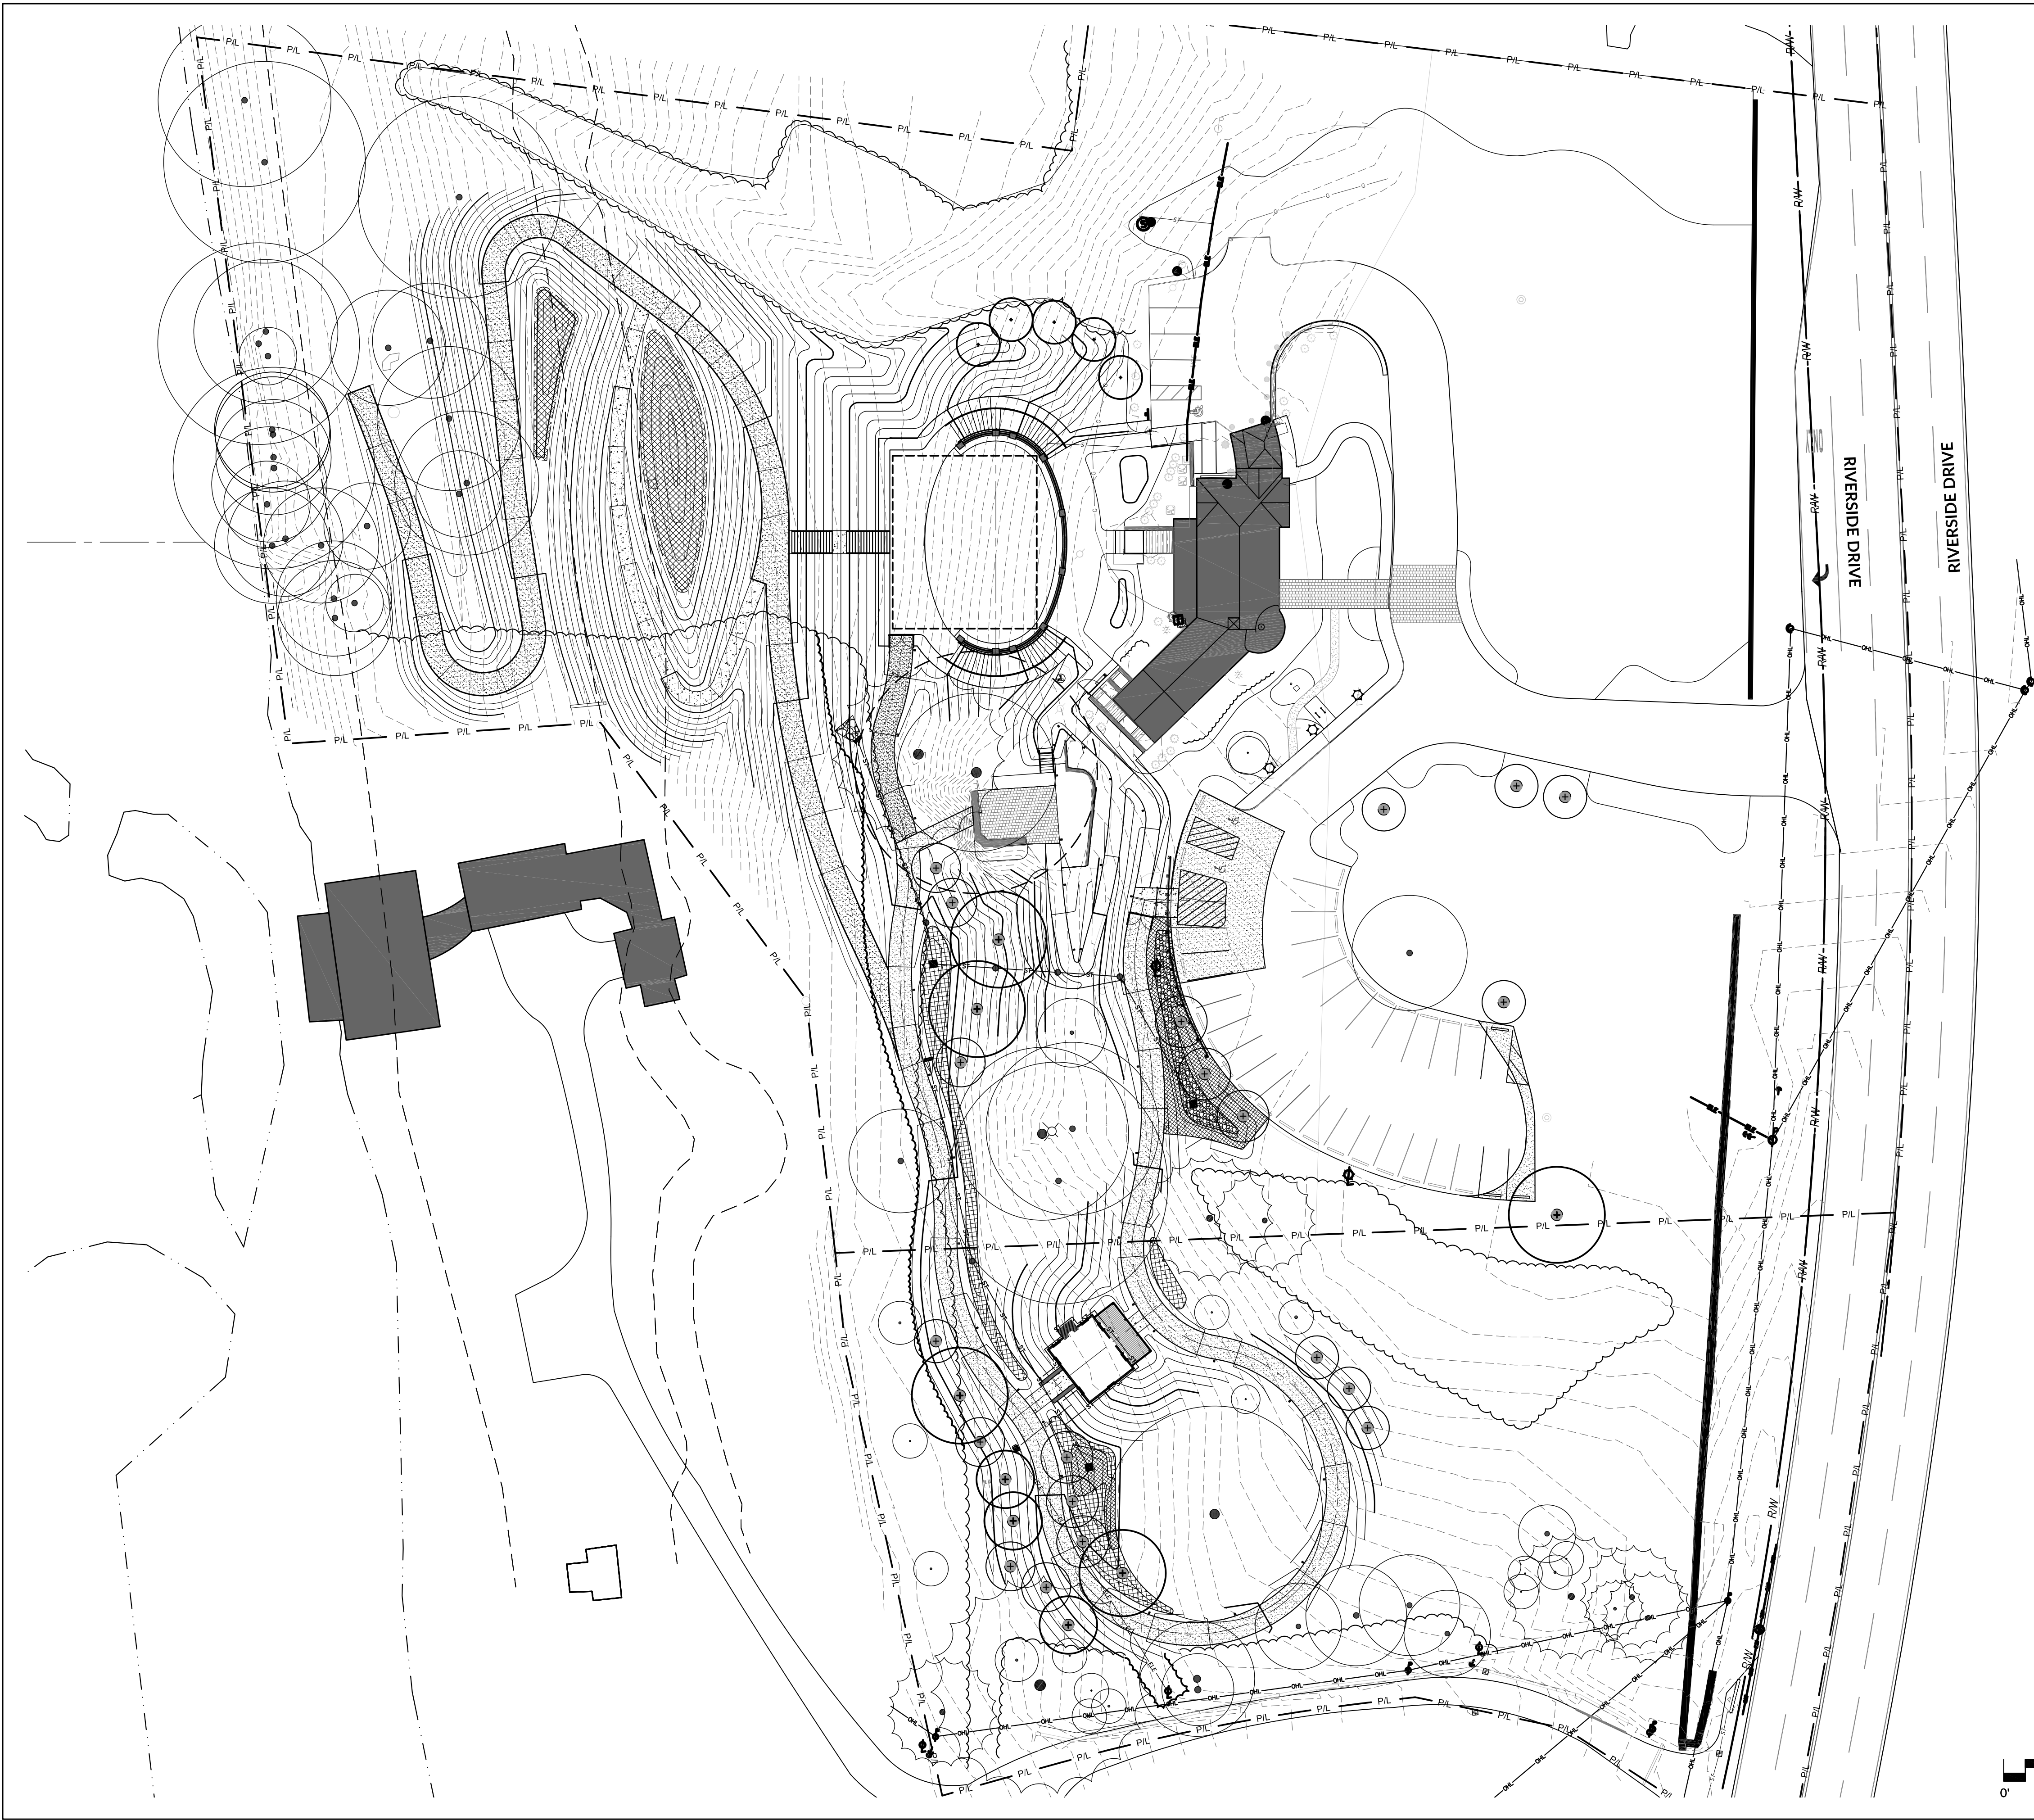


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PHASE 2 TERRACE CONSTRUCTION DRAWINGS FOR REFERENCE ONLY

THIS DRAWING PACKAGE IS PRELIMINARY AND SHALL BE USED ONLY FOR REVIEW AND COORDINATION PURPOSES. PERMIT REVIEW AND CONSTRUCTION DRAWINGS WILL BE PROVIDED IN SUBSEQUENT DESIGN PHASES AND/OR DRAWING PACKAGES.

<p>ISSUE DATE APRIL 6, 2022 CITY OF DUBLIN MINOR PROJECT REVIEW</p>	<p>DUBLIN ARTS CENTER GROUNDS IMPROVEMENTS</p>	<p>PROJECT OWNER CITY OF DUBLIN PARKS & RECREATION 5555 Penimeter Drive Dublin, Ohio 43017</p>	<p>SHEET TITLE OVERALL MASTER PLAN Site Plan</p>
<p>PROJECT ADDRESS DUBLIN ARTS CENTER 700 Bluff Road Columbus, OH 43216</p>	<p>SHEET NUMBER G002</p>		



- LEGEND - EXISTING CONDITIONS**
- ☼ EX. LIGHT POLE
 - EX. SIGN
 - ⊕ EX. FIRE HYDRANT
 - ⊕ EX. WATER VALVE
 - EX. CATCH BASIN
 - EX. SAN. MANHOLE
 - EX. CURB INLET
 - EX. STORM MANHOLE
 - ⊕ EX. GUY POLE
 - ⊕ EX. UTILITY POLE
 - ⊕ EX. GUY WIRE
 - ⊕ EX. BENCHMARK
 - 720- EX. MAJOR CONTOUR
 - 719- EX. MINOR CONTOUR
 - EX. SANITARY
 - EX. WATER MAIN
 - EX. GAS MAIN
 - EX. STORM
 - EX. COMBINED SEWER
 - EX. OVERHEAD EL.
 - EX. TREELINE
 - EX. DECIDUOUS TREE
 - EX. EVERGREEN TREE
 - TREE CRITICAL ROOT ZONE

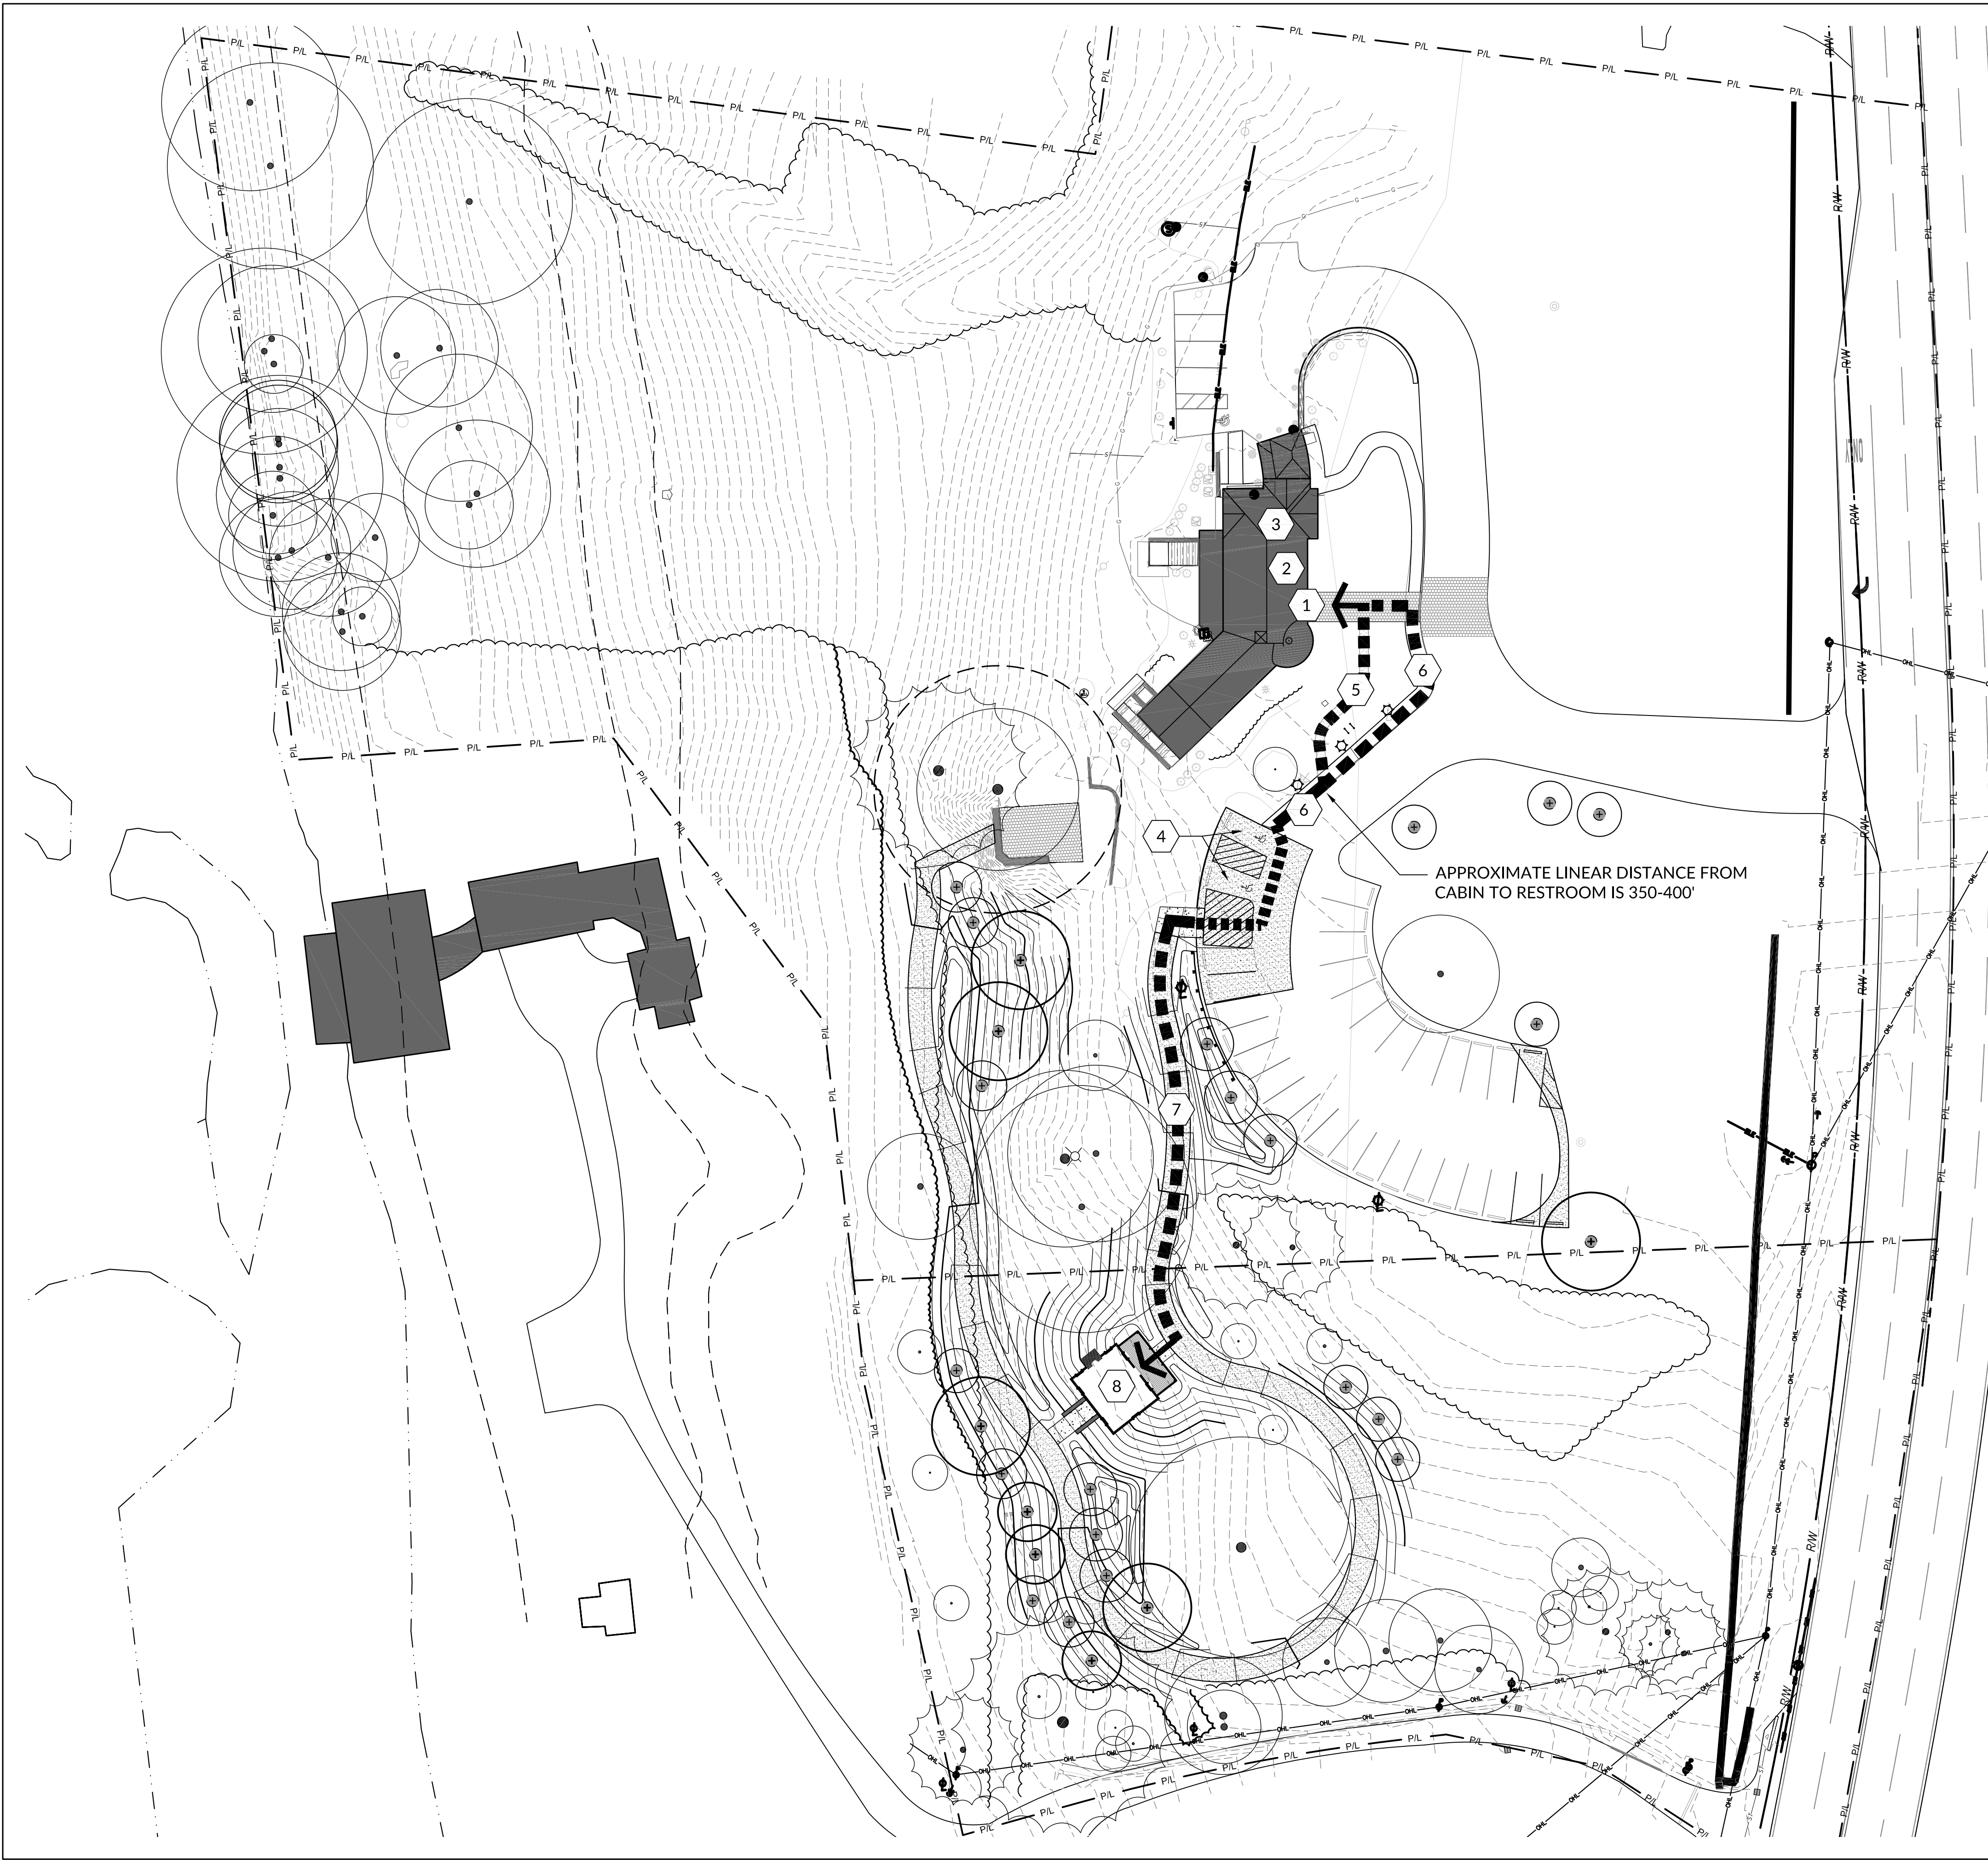- CODED NOTES - LAYOUT AND MATERIALS PLAN**
- 1 ACCESSIBLE ENTRANCE TO DAC BUILDING.
 - 2 APPROXIMATE LOCATION OF MAIN FLOOR BATHROOM.
 - 3 APPROXIMATE LOCATION OF LOWER FLOOR ADA BATHROOMS WHICH ARE ACCESSIBLE VIA EXISTING ELEVATOR.
 - 4 RECONSTRUCTED ADA-COMPLIANT PARKING SPACES.
 - 5 ADA-COMPLIANT CRUSHED AGGREGATE SLOPING WALK, MAX SLOPE IS LESS THAN 5%.
 - 6 ADA-COMPLIANT CONCRETE/BLUESTONE SLOPING WALK, MAX SLOPE IS LESS THAN 5%.
 - 7 ADA-COMPLIANT ASPHALT SLOPING WALK, MAX SLOPE IS LESS THAN 5%.
 - 8 ACCESSIBLE ENTRANCE TO CABIN.

PARKING CALCULATIONS

USE	SQUARE FOOTAGE	CODE REQUIREMENTS	REQUIRED SPACES
MUSEUM (DAC EXISTING BUILDING)	5,001 SF	1 SPACE PER 1,000 SF (125% MAX ALLOWED)	5 SPACES MIN., 7 SPACES MAX.
MUSEUM (CABIN NEW BUILDING)	480 SF	1 SPACE PER 1,000 SF (125% MAX ALLOWED)	1 SPACES MIN., 1 SPACES MAX.
TOTAL PARKING REQUIRED			6 SPACES MIN., 8 SPACES MAX.



TOTAL BUILDING PARKING REQUIRED	TOTAL SPACES	ADA SPACES (INCLUDED IN TOTAL SPACES)
PROVIDED PARKING (SOUTH LOT)	32 EXISTING, 32 PROPOSED (NO CHANGE)	2 EXISTING (NON-COMPLIANT), 2 PROPOSED (COMPLIANT)
PROVIDED PARKING (NORTH LOT)	5 EXISTING, 5 PROPOSED (NO CHANGE)	1 EXISTING, 1 PROPOSED (NO CHANGE)
BICYCLE PARKING	1 PER 20 SPACED REQUIRED, 2 TOTAL REQUIRED.	2 PROVIDED (TO BE CONSTRUCTED IN PHASE 2)

LOT COVERAGE CALCULATIONS

ITEM	EXISTING	PHASE 1 ADDITIONS	PHASE 1 TOTAL	PHASE 2 ADDITIONS	PHASE 3 ADDITIONS	OVERALL TOTALS
BUILDINGS / STRUCTURES	3,166 SF	480 SF	3,646 SF	0 SF	0 SF	3,646 SF
VEHICULAR PAVEMENT	23,206 SF	390 SF	23,596 SF	0 SF	0 SF	23,596 SF
PEDESTRIAN PAVEMENT	2,423 SF	5,469 SF	7,892 SF	4,847 SF	6,250 SF	18,989 SF
RIPRAP / LANDSCAPE STONE / WALLS	1,797 SF	550 SF	2,347 SF	425 SF	0 SF	2,772 SF
TOTALS	30,592 SF	6,889 SF	37,481 SF	5,272 SF	6,250 SF	49,003 SF

TOTAL LOT AREA	4.61 AC. NORTH LOT, 1.40 AC. SOUTH LOT, 261,795 SF TOTAL SITE AREA				
TOTAL LOT COVERAGE	11.69%		14.29%		18.72%

DESIGNING LOCAL
LANDSCAPE ARCHITECTURE
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COLUMBUS, OH 43205
614.893.7178

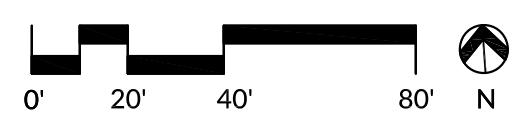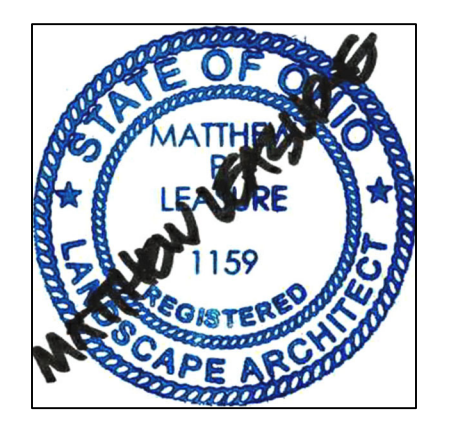

GENERAL NOTES

- ALL WORK IS SHOWN BASED ON SURVEY PROVIDED BY CESO, INC. SEE SURVEY SHEET FOR KEY INFORMATION.
- THE OWNER'S REPRESENTATIVE SHALL BE NOTIFIED IMMEDIATELY IF ANY DISCREPANCIES ARE DISCOVERED BETWEEN WHAT IS SHOWN ON THE DRAWINGS AND ACTUAL FIELD CONDITIONS.
- CONTRACTOR SHALL BE RESPONSIBLE FOR BECOMING FAMILIAR WITH ALL UNDERGROUND UTILITIES, PIPES, AND STRUCTURES. CONTRACTOR SHALL TAKE SOLE RESPONSIBILITY FOR ANY DAMAGE TO UTILITIES.
- CONTRACTOR SHALL BE RESPONSIBLE FOR ANY COORDINATION WITH SUBCONTRACTORS AS REQUIRED TO ACCOMPLISH THEIR PERSPECTIVE WORK.
- CONTRACTOR SHALL PROVIDE ALL NECESSARY SAFETY MEASURES DURING CONSTRUCTION OPERATIONS TO PROTECT THE PUBLIC ACCORDING TO ALL APPLICABLE CODES AND PRACTICES.
- CONTRACTOR SHALL OBTAIN PERMITS FOR THE WORK AS REQUIRED AND COMPLY WITH ALL LAWS, ORDINANCES, RULES AND REGULATIONS OF THE LOCAL JURISDICTION, THE STATE, AND ALL AUTHORITIES HAVING JURISDICTION.
- ALL DIMENSIONS SHOWN REFERENCE EDGE OF PAVEMENTS, THE FACE OF CURBS AND THE FACE OF STRUCTURES UNLESS OTHERWISE NOTED.

DEMOLITION NOTES

- REFER TO CIVIL PLANS FOR DEMOLITION RELATED TO UTILITIES OR DRAINAGE.
- COORDINATE WITH OWNER FOR DISPOSAL AND/OR STOCKPILING OF EXISTING PARK ITEMS.

GRADING NOTES

- ALL EROSION CONTROL MEASURES ARE TO BE CONSTRUCTED TO MEET FIELD CONDITIONS AT THE TIME OF CONSTRUCTION AND PRIOR TO ANY GRADING OR DISTURBANCE OF EXISTING CONDITIONS.
- CONTRACTOR SHALL VERIFY ALL EXISTING GRADES IN THE FIELD AND REPORT ANY DISCREPANCIES IMMEDIATELY TO THE LANDSCAPE ARCHITECT.
- ALL PAVED AND PLANTED SURFACES SHALL BE CONSTRUCTED TO POSITIVELY DRAIN AWAY FROM ALL VERTICAL ELEMENTS SUCH AS BUILDINGS, WALLS, COLUMNS, ETC., AND INTO THE SITE DRAINAGE SYSTEM.
- CONTRACTOR SHALL PROVIDE A MINIMUM OF 1/8" PER FOOT CROSS SLOPE IN THE DIRECTION OF SURFACE DRAINAGE ON ALL WALKWAYS

LAYOUT NOTES


- THE PLANS ASSUME THAT THE LAYOUT AND STAKING WILL BY ACCOMPLISHED USING TOTAL STATIONING/ DIGITAL METHODS. ANY INFORMATION PROVIDED IS INTENDED TO SUPPORT INFORMATION ALREADY CONTAINED IN CAD FILES.
- CONTRACTOR SHALL VERIFY ALL EXISTING CONDITIONS AND LAYOUT DIMENSIONS IN THE FIELD. REPORT ANY DISCREPANCIES TO THE LANDSCAPE ARCHITECT PRIOR TO COMMENCING WORK.
- ALL DIMENSIONS ARE TO THE EDGE OF PAVEMENT, FACE OF WALL, OR FACE OF CURB UNLESS NOTED OTHERWISE.
- ALL RADII ON WALKWAY INTERSECTIONS SHALL BE 5' UNLESS NOTED OTHERWISE.
- PROVIDE ISOLATION JOINTS WHERE CONCRETE PAVING OR PAVING BASE MEETS A FIXED EXISTING OR PROPOSED STRUCTURE.

PLANTING NOTES

- CONTRACTOR TO BACKFILL ALL TREE AND SHRUB PITS WITH APPROVED PLANTING SOIL MIX ONLY. DO NOT USE ANY REMAINING EXCAVATED MATERIAL OR OTHER FILL MATERIALS WHICH DOES NOT CONFORM TO SOIL SPECIFICATIONS.
- SUBSTITUTIONS OF SPECIFIED PLANT SPECIES MUST BE APPROVED BY THE OWNER OR LANDSCAPE ARCHITECT.
- ALL AREAS DISTURBED BY CONSTRUCTION ARE TO BE RESTORED, FINE GRADED AND SEEDED.
- THE CONTRACTOR SHALL PROVIDE AND PLACE ALL APPROVED STOCKPILED TOPSOIL FOR ALL LANDSCAPED AREAS TO REQUIRED GRADES.
- SEE SHEET L604/608 FOR PLANTING DETAILS.
- ALL TREES PLANTED IN LAWN AREAS SHALL HAVE A 5' DIAMETER MULCH RING AS SHOWN ON PLANS AND DETAILS.

NOTES:

- COORDINATE WITH LANDSCAPE ARCHITECT FOR ANY QUESTIONS REGARDING WHICH TREES OR AREAS REQUIRE TREE PROTECTION.

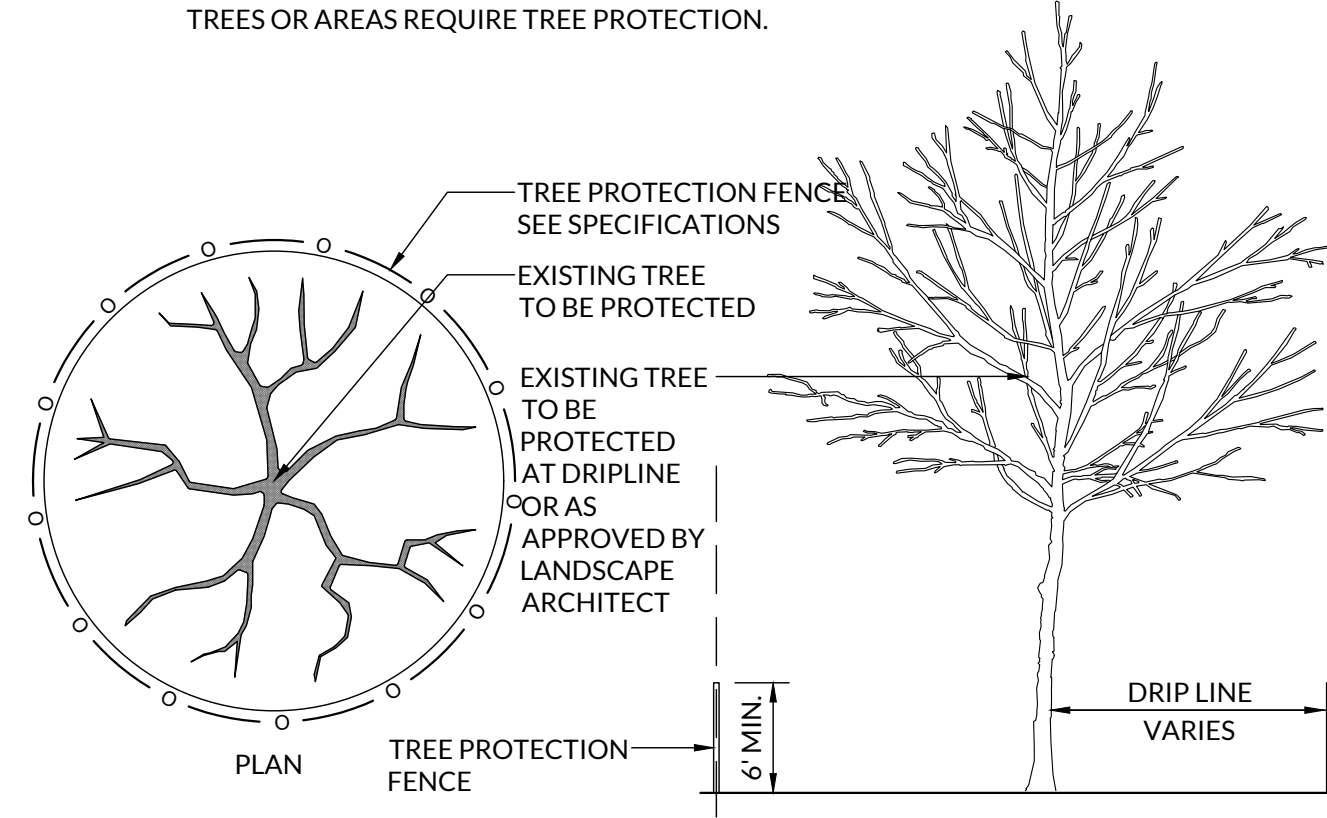


01 TREE PROTECTION
NOT TO SCALE

TREE IMPACT SCHEDULE							
	SHEET	TYPE	CALIPER SIZE (DBH)	CRITICAL ROOT ZONE DIAMETER (CRZ)	IMPACT	REPLACEMENT CALIPER INCHES REQUIRED	REPLACEMENT TREES REQUIRED (2.5")
T1	L101	DECIDUOUS	6" DBH	12'	REMOVED	6"	3
T2	L101	DECIDUOUS	6" DBH	12'	REMOVED	6"	3
T3	L101	DECIDUOUS	40" DBH	80'	CRZ ENCROACHMENT	1 REPLACEMENT	1
T4	L101	DECIDUOUS	6" DBH	12'	CRZ ENCROACHMENT	1 REPLACEMENT	1
T5	L101	DECIDUOUS	12" DBH	24'	CRZ ENCROACHMENT	1 REPLACEMENT	1
T6	L101	DECIDUOUS	7" DBH	14'	CRZ ENCROACHMENT	1 REPLACEMENT	1
T7	L101	CONIFEROUS	30" DBH	60'	CRZ ENCROACHMENT	1 REPLACEMENT	1
T8	L101	CONIFEROUS	30" DBH	60'	CRZ ENCROACHMENT	1 REPLACEMENT	1
T9	L101	CONIFEROUS	4" DBH	8'	CRZ ENCROACHMENT	1 REPLACEMENT	1
T10	L101	CONIFEROUS	4" DBH	8'	CRZ ENCROACHMENT	1 REPLACEMENT	1
T11	L101	CONIFEROUS	4" DBH	8'	CRZ ENCROACHMENT	1 REPLACEMENT	1
T12	L101	DECIDUOUS	42" DBH	84'	CRZ ENCROACHMENT	1 REPLACEMENT	1
T13	L101	DECIDUOUS	42" DBH	84'	CRZ ENCROACHMENT	1 REPLACEMENT	1
T14	L101	DECIDUOUS	15" DBH	30'	CRZ ENCROACHMENT	1 REPLACEMENT	1
T15	L101	DECIDUOUS	24" DBH	48'	CRZ ENCROACHMENT	1 REPLACEMENT	1
T16	L101	DECIDUOUS	42" DBH	84'	CRZ ENCROACHMENT	1 REPLACEMENT	1
T17	L101	DECIDUOUS	24" DBH	48'	CRZ ENCROACHMENT	1 REPLACEMENT	1
T18	L101	DECIDUOUS	24" DBH	48'	CRZ ENCROACHMENT	1 REPLACEMENT	1
T19	L101	DECIDUOUS	10" DBH	20'	CRZ ENCROACHMENT	1 REPLACEMENT	1
T20	L101	DECIDUOUS	6" DBH	12'	CRZ ENCROACHMENT	1 REPLACEMENT	1
T21	L101	CONIFEROUS	38" DBH	76'	CRZ ENCROACHMENT	1 REPLACEMENT	1
T22	L101	DECIDUOUS	30" DBH	60'	CRZ ENCROACHMENT	1 REPLACEMENT	1
T23	L101	DECIDUOUS	27" DBH	54'	CRZ ENCROACHMENT	1 REPLACEMENT	1
T24	L101	DECIDUOUS	20" DBH	40'	CRZ ENCROACHMENT	1 REPLACEMENT	1
T25	L101	DECIDUOUS	24" DBH	48'	CRZ ENCROACHMENT	1 REPLACEMENT	1
PHASE 1: TOTAL 2.5" CALIPER REPLACEMENT TREES REQUIRED							29
T26	L102	DECIDUOUS	12" DBH	24'	REMOVED	12"	5
PHASE 2: TOTAL 2.5" CALIPER REPLACEMENT TREES REQUIRED							5

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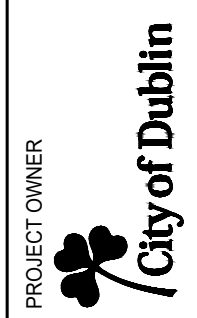
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ISSUE DATE
APRIL 9, 2022
CITY OF DUBLIN MINOR
PROJECT REVIEW

**DUBLIN ARTS CENTER
GROUNDS IMPROVEMENTS**

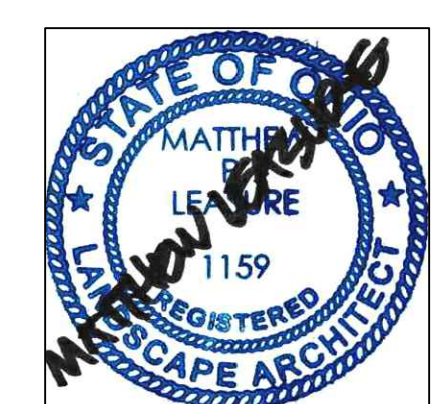
CITY OF DUBLIN
PARKS & RECREATION
5555 Penmar Drive
Dublin, Ohio 43017



PROJECT OWNER
DUBLIN ARTS CENTER
7700 East Main St.
Columbus, OH 43216

SHEET TITLE
PHASE 1 CABIN CONSTRUCTION
General Notes

SHEET NUMBER
L001


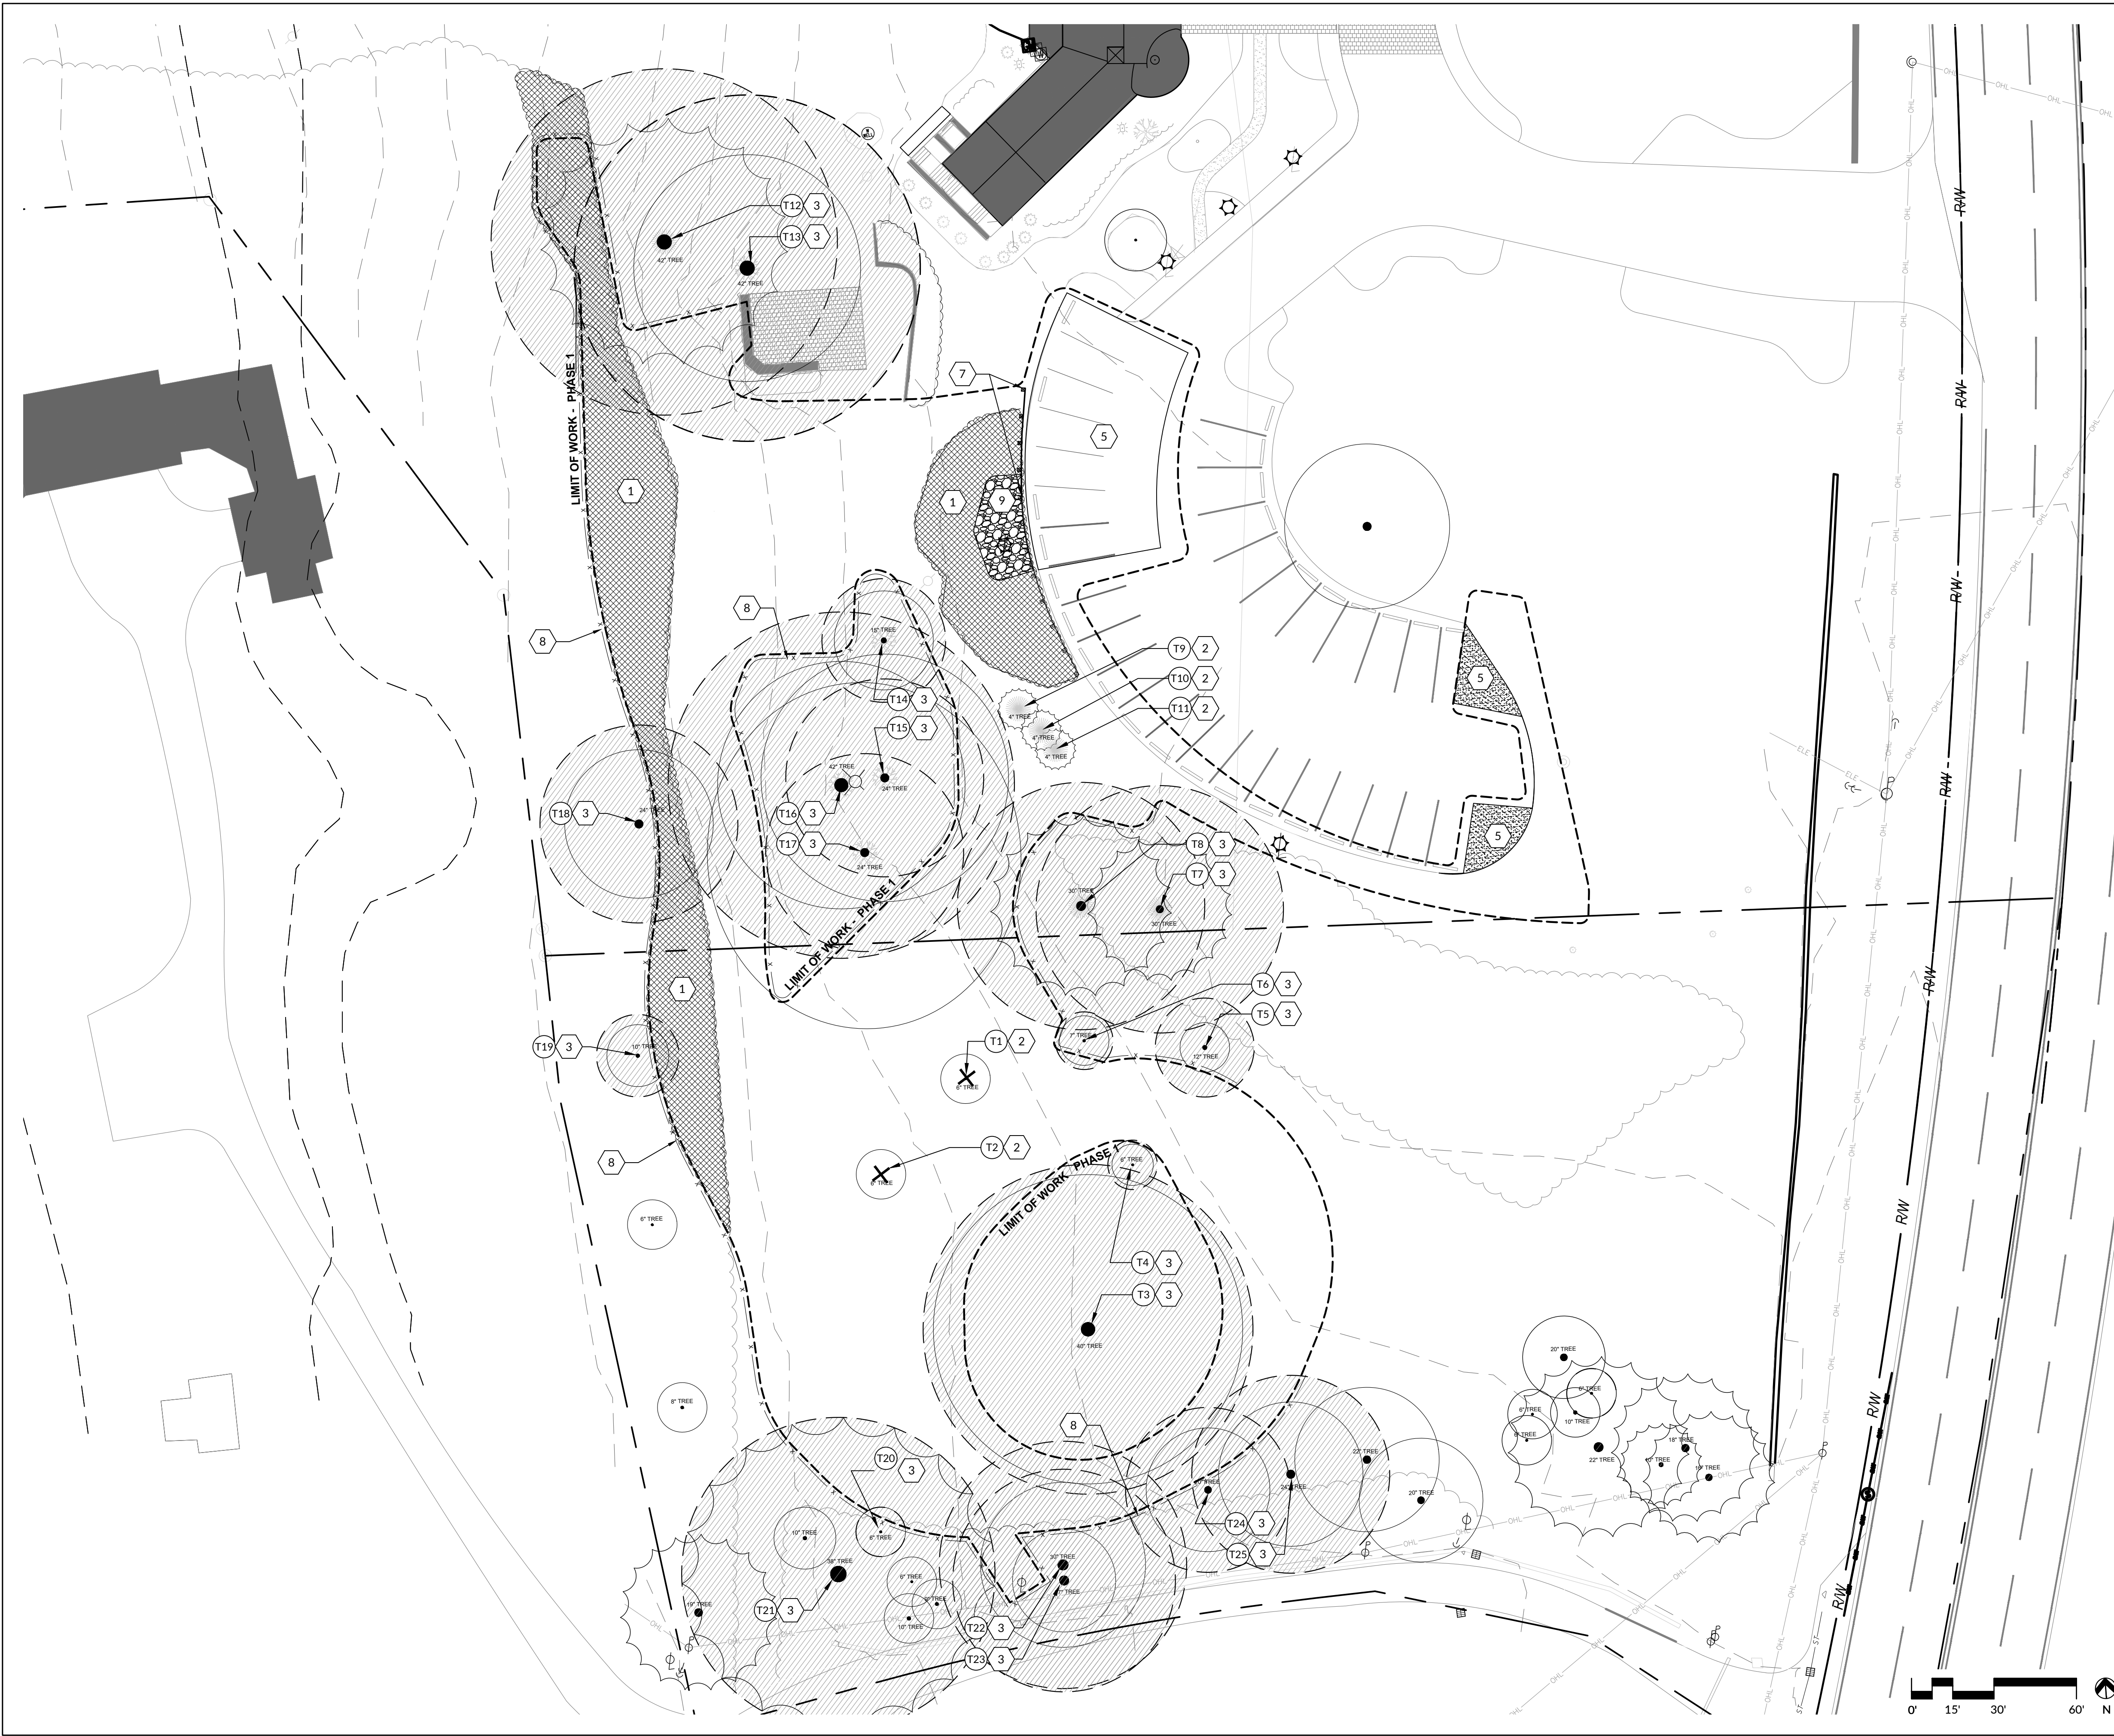


LEGEND - EXISTING CONDITIONS

☆	EX. LIGHT POLE	---	EX. SANITARY
+	EX. SIGN	---	EX. WATER MAIN
⊙	EX. FIRE HYDRANT	---	EX. GAS MAIN
⊗	EX. WATER VALVE	---	EX. STORM
□	EX. CATCH BASIN	---	EX. COMBINED SEWER
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⊙	EX. UTILITY POLE	○	TREE CRITICAL ROOT ZONE
⊙	EX. GUY WIRE		
⊙	EX. BENCHMARK		
-720-	EX. MAJOR CONTOUR		
-719-	EX. MINOR CONTOUR		

- CODED NOTES - DEMOLITION PLAN**
- 1 EXISTING VEGETATION TO BE CLEARED.
 - 2 EXISTING TREE TO BE REMOVED.
 - 3 TREE CRITICAL ROOT ZONE IS IMPACTED IN PHASE 1 CABIN PROJECT. TREE REQUIREMENTS ARE ACCOUNTED FOR IN PHASE 1. SEE SHEET L001.
 - 4 WOOD DECK STRUCTURE TO BE REMOVED BELOW GRADE. (PHASE 2 ONLY)
 - 5 EXISTING ASPHALT PAVEMENT TO BE ALTERED, SEE LAYOUT & MATERIALS PLAN.
 - 6 EXISTING DRAINAGE PIPE TO BE MOVED. (PHASE 2 ONLY)
 - 7 EXISTING GUARDRAIL TO BE REMOVED. REMOVE 4 POSTS AND BOARDS COMPLETE AS SHOWN. APPROX. 24 LF. FILL AND COMPACT POST HOLES WITH SOIL. SEE LAYOUT FOR PROPOSED WORK THIS AREA.
 - 8 TREE PROTECTION FENCING. SEE SHEET L001/L002, DETAIL 01.
 - 9 EXISTING COBBLESTONE TO BE RE-USED WITH NEW DECORATIVE RIP RAP. SEE LAYOUT FOR PROPOSED WORK.

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1223 EAST MAIN ST., SUITE 311
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ISSUE DATE
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CITY OF DUBLIN MINOR
PROJECT REVIEW

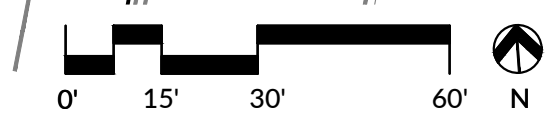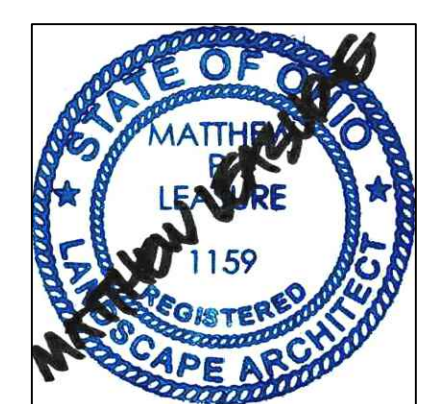**DUBLIN ARTS CENTER
GROUNDS IMPROVEMENTS**


CITY OF DUBLIN
PARKS & RECREATION
5555 Penmar Drive
Dublin, Ohio 43017



PROJECT ADDRESS
DUBLIN ARTS CENTER
705 East Main St.
Columbus, OH 43216

**PHASE 1 CABIN CONSTRUCTION
Demolition Plan**

SHEET NUMBER
L101

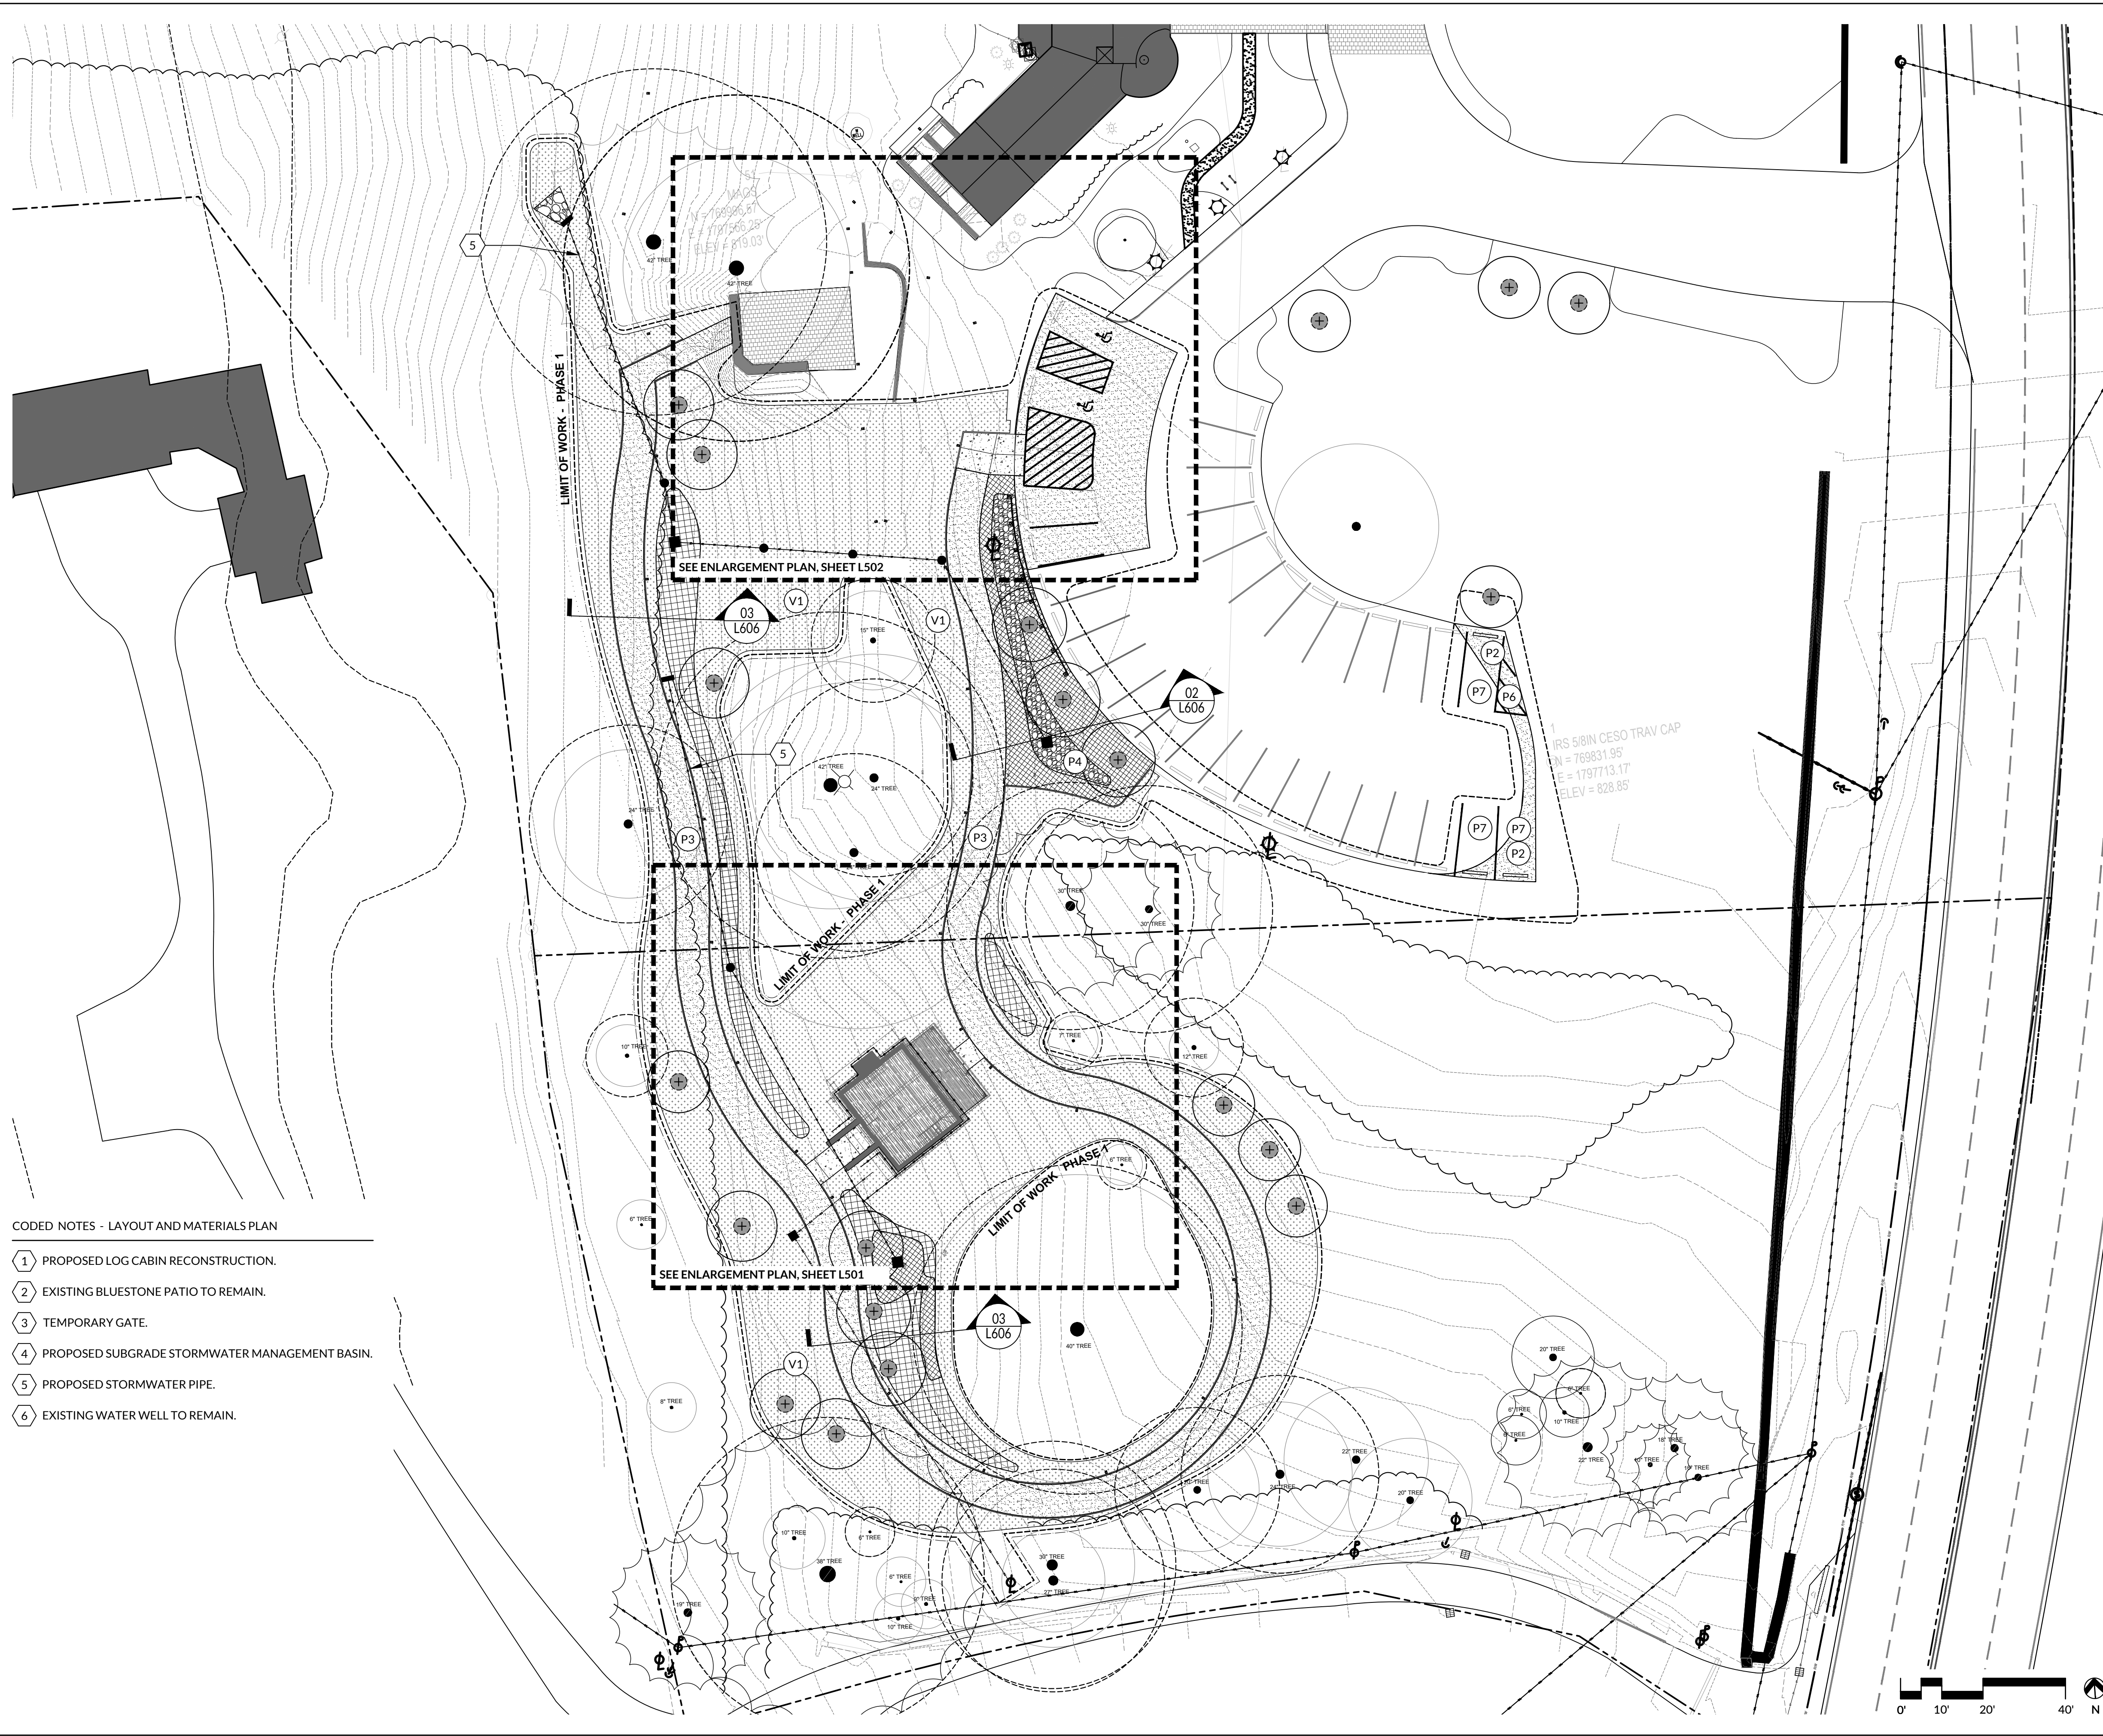


- CODED NOTES - LAYOUT AND MATERIALS PLAN**
- 1 PROPOSED LOG CABIN RECONSTRUCTION.
 - 2 EXISTING BLUESTONE PATIO TO REMAIN.
 - 3 TEMPORARY GATE.
 - 4 PROPOSED SUBGRADE STORMWATER MANAGEMENT BASIN.
 - 5 PROPOSED STORMWATER PIPE.
 - 6 EXISTING WATER WELL TO REMAIN.

- LEGEND - EXISTING CONDITIONS**
- EX. LIGHT POLE
 - EX. SIGN
 - EX. FIRE HYDRANT
 - EX. WATER VALVE
 - EX. CATCH BASIN
 - EX. SAN. MANHOLE
 - EX. CURB INLET
 - EX. STORM MANHOLE
 - EX. GUY POLE
 - EX. UTILITY POLE
 - EX. GUY WIRE
 - EX. BENCHMARK
 - EX. MAJOR CONTOUR
 - EX. MINOR CONTOUR
 - EX. SANITARY
 - EX. WATER MAIN
 - EX. GAS MAIN
 - EX. STORM
 - EX. COMBINED SEWER
 - EX. OVERHEAD EL.
 - EX. TREELINE
 - EX. DECIDUOUS TREE
 - EX. EVERGREEN TREE
 - TREE CRITICAL ROOT ZONE

- LEGEND - LAYOUT AND MATERIALS PLAN**
- P1 PEDESTRIAN CONCRETE PAVEMENT. SEE SHEET L601, DETAIL 01 (PHASE 1), SHEET L605, DETAIL 01 (PHASE 2).
 - P2 VEHICULAR ASPHALT PAVEMENT. SEE SHEET L601, DETAIL 04 (PHASE 1 ONLY).
 - P3 PEDESTRIAN ASPHALT TRAIL PAVEMENT. SEE SHEET L601, DETAIL 03 (PHASE 1), SHEET L605, DETAIL 03 (PHASE 2).
 - P4 DECORATIVE DUMP ROCK FILL. SEE SHEET L603, DETAIL 01 (PHASE 1 ONLY).
 - P5 DECORATIVE STONE GRAVEL. SEE SHEET L606, DETAIL 01 (PHASE 2 ONLY).
 - P6 4" PAVEMENT STRIPING
 - P7 9'x18' PARKING SPACE
 - P8 PAVEMENT DECAL - HANDICAP MARKING
 - W1 CABIN DECORATIVE STONE RETAINING WALL. SEE SHEET L602, DETAIL 01 (PHASE 1 ONLY).
 - W2 DECORATIVE STONE RETAINING WALL. SEE SHEET L606, DETAIL 01 (PHASE 2 ONLY).
 - HR1 METAL HANDRAIL. 1. SEE SHEET L607, DETAIL 01 (PHASE 02 ONLY).
 - GR1 DECORATIVE METAL GUARDRAIL. SEE SHEET L607, DETAIL 03 (PHASE 02 ONLY).
 - F1 4' HEIGHT DECORATIVE METAL FENCE.
 - G1 4' HEIGHT, 5' WIDTH DECORATIVE METAL GATE, SINGLE-LEAF.
 - G2 4' HEIGHT, 5' WIDTH DECORATIVE METAL GATE, DOUBLE-LEAF.
 - EO1 120V, 20 AMP DUPLEX ELECTRICAL OUTLET - PHASE 2 TERRACE CONSTRUCTION.
 - L1 BUILDING UPLIGHT - CABIN CONSTRUCTION. SEE SHEET L602, DETAIL 01 (PHASE 01).
 - L2 SMALL WALL UPLIGHT - PHASE 2 ADD ALTERNATE.
 - L3 LARGE WALL UPLIGHT - PHASE 2 ADD ALTERNATE.
 - L4 BOLLARD LIGHT - PHASE 2 ADD ALTERNATE.
 - S1 CONCRETE STAIR TYPE 1. SEE SHEET L605, DETAIL 05 (PHASE 2 ONLY).
 - S2 CONCRETE STAIR TYPE 2. SEE SHEET L607, DETAIL 01 (PHASE 2 ONLY).
 - V1 LAWN PLANTING AREA. SEE PLANTING PLANS.
 - V2 PLANTING BED. SEE PLANTING PLANS.
 - V3 SPECIALTY GRASS PLANTING AREA. SEE PLANTING PLANS.

DESIGNING LOCAL
LANDSCAPE ARCHITECTURE


1223 EAST MAIN ST., SUITE 311
COLUMBUS, OH 43205
614.893.7178

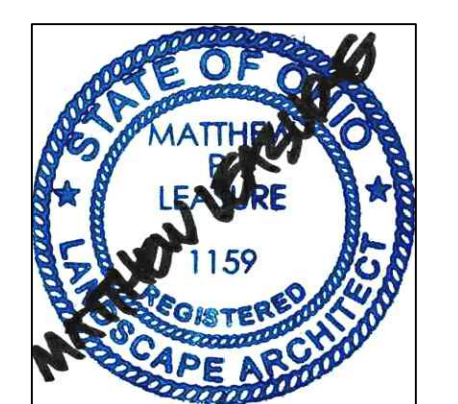

ISSUE DATE
APRIL 6, 2022
CITY OF DUBLIN MINOR
PROJECT REVIEW

**DUBLIN ARTS CENTER
GROUNDS IMPROVEMENTS**

CITY OF DUBLIN
PARKS & RECREATION
5555 Penmar Drive
Dublin, Ohio 43017

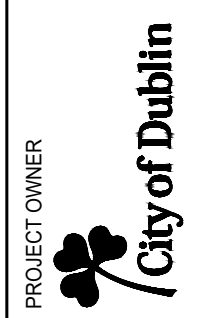


PROJECT OWNER
DUBLIN ARTS CENTER
7700 Bland Rd.
Columbus, OH 43216

PHASE 1 CABIN CONSTRUCTION
Layout & Materials Plan

SHEET NUMBER
L201



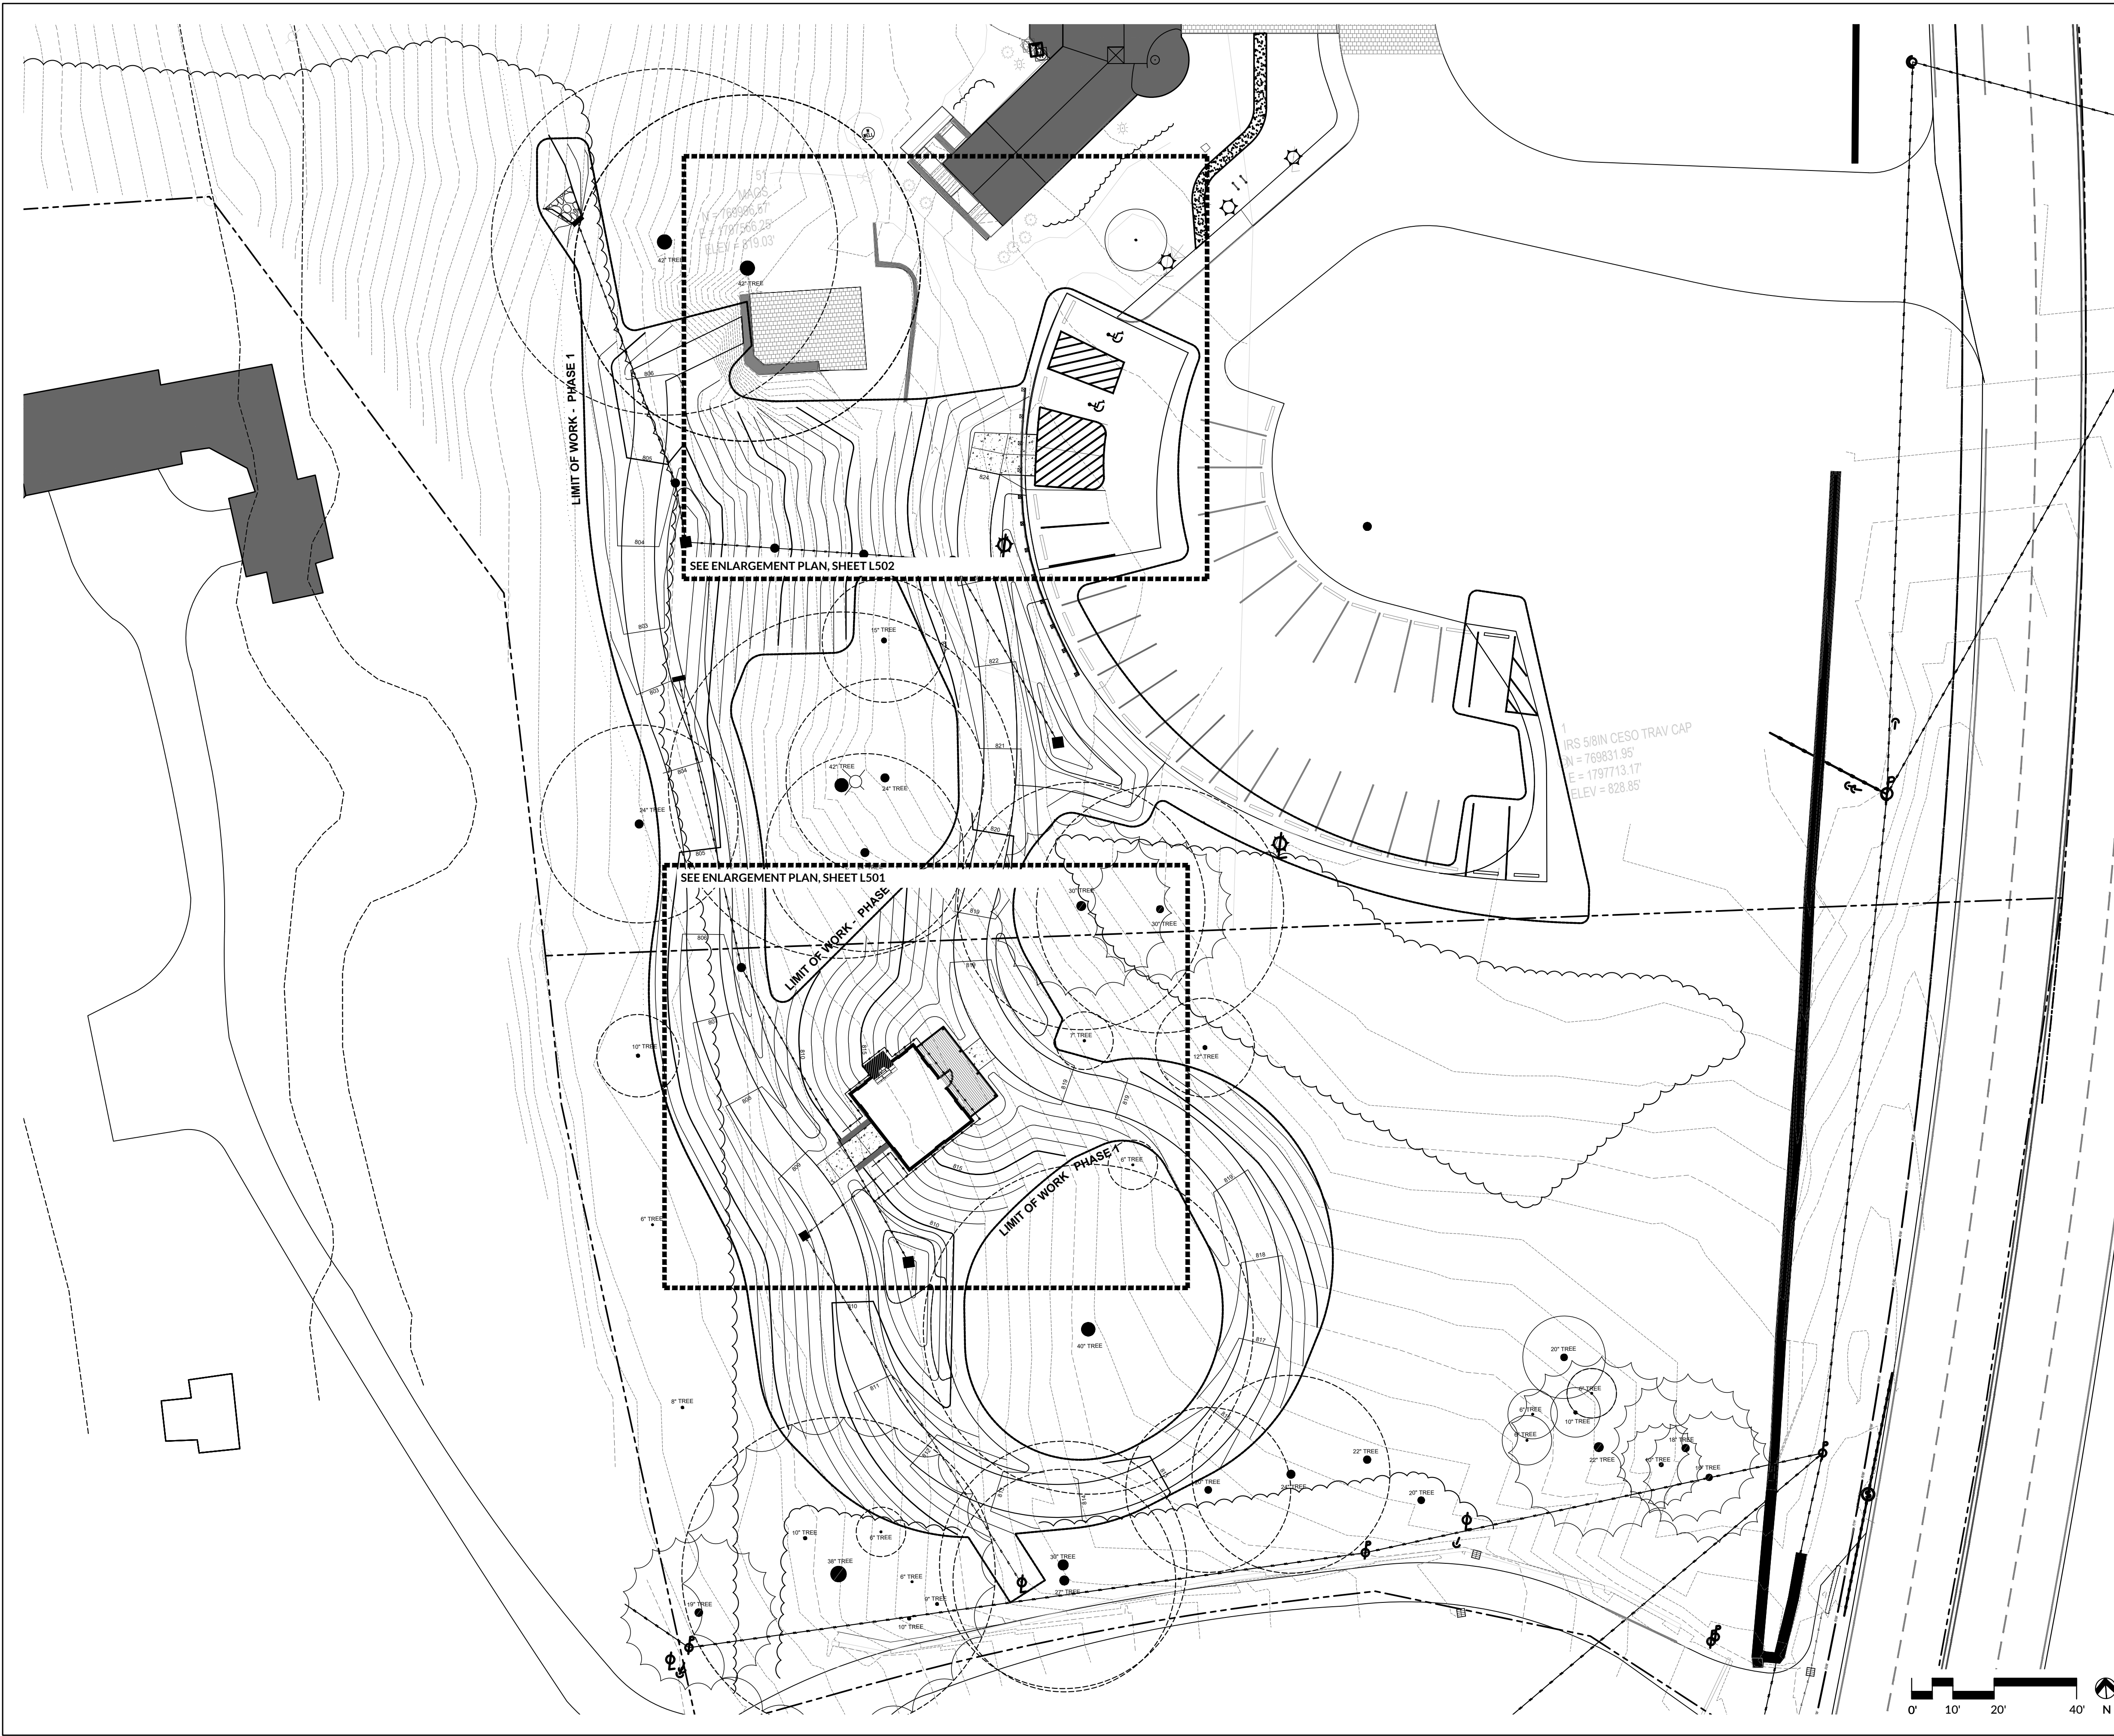


LEGEND - EXISTING CONDITIONS

☆	EX. LIGHT POLE	—	EX. SANITARY
+	EX. SIGN	—	EX. WATER MAIN
⊙	EX. FIRE HYDRANT	—	EX. GAS MAIN
⊗	EX. WATER VALVE	—	EX. STORM
□	EX. CATCH BASIN	—	EX. COMBINED SEWER
○	EX. CURB INLET	—	EX. OVERHEAD EL.
○	EX. SAN. MANHOLE	—	EX. TREELINE
○	EX. STORM MANHOLE	—	EX. DECIDUOUS TREE
⊕	EX. GUY POLE	—	EX. EVERGREEN TREE
⊗	EX. UTILITY POLE	—	EX. BENCHMARK
⊕	EX. GUY WIRE	—	EX. MAJOR CONTOUR
⊕	EX. BENCHMARK	—	EX. MINOR CONTOUR
—720—	EX. MAJOR CONTOUR	○	EX. DECIDUOUS TREE
—719—	EX. MINOR CONTOUR	○	EX. EVERGREEN TREE
		○	TREE CRITICAL ROOT ZONE

LEGEND - GRADING PLAN

—	PROPOSED 1' CONTOUR INTERVAL
XXX	PROPOSED 5' CONTOUR INDEX
(XXX.XX)	EXISTING SPOT ELEVATION
XXX.XX	PROPOSED SPOT ELEVATION
TS XXX.XX	TOP OF STRUCTURE ELEVATION
TC XXX.XX	TOP OF CURB ELEVATION
BC XXX.XX	BOTTOM OF CURB ELEVATION
HP XXX.XX	PROPOSED HIGH POINT ELEVATION
LP XXX.XX	PROPOSED LOW POINT ELEVATION
TW XXX.XX	TOP OF WALL ELEVATION
BW XXX.XX	BOTTOM OF WALL ELEVATION

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GROUNDS IMPROVEMENTS**

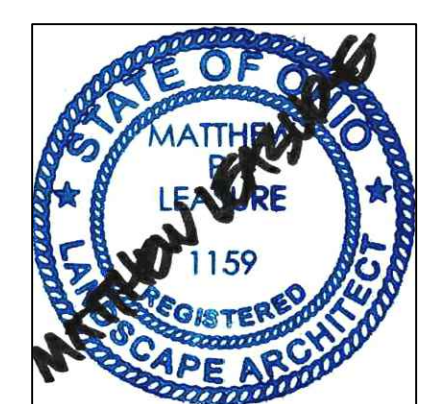
PROJECT OWNER
**CITY OF DUBLIN
PARKS & RECREATION**
5555 Penmar Drive
Dublin, Ohio 43017



PROJECT ADDRESS
DUBLIN ARTS CENTER
7 Columbus Ave.
Columbus, OH 43216

SHEET TITLE
**PHASE 1 CABIN CONSTRUCTION
Grading Plan**

SHEET NUMBER
L301

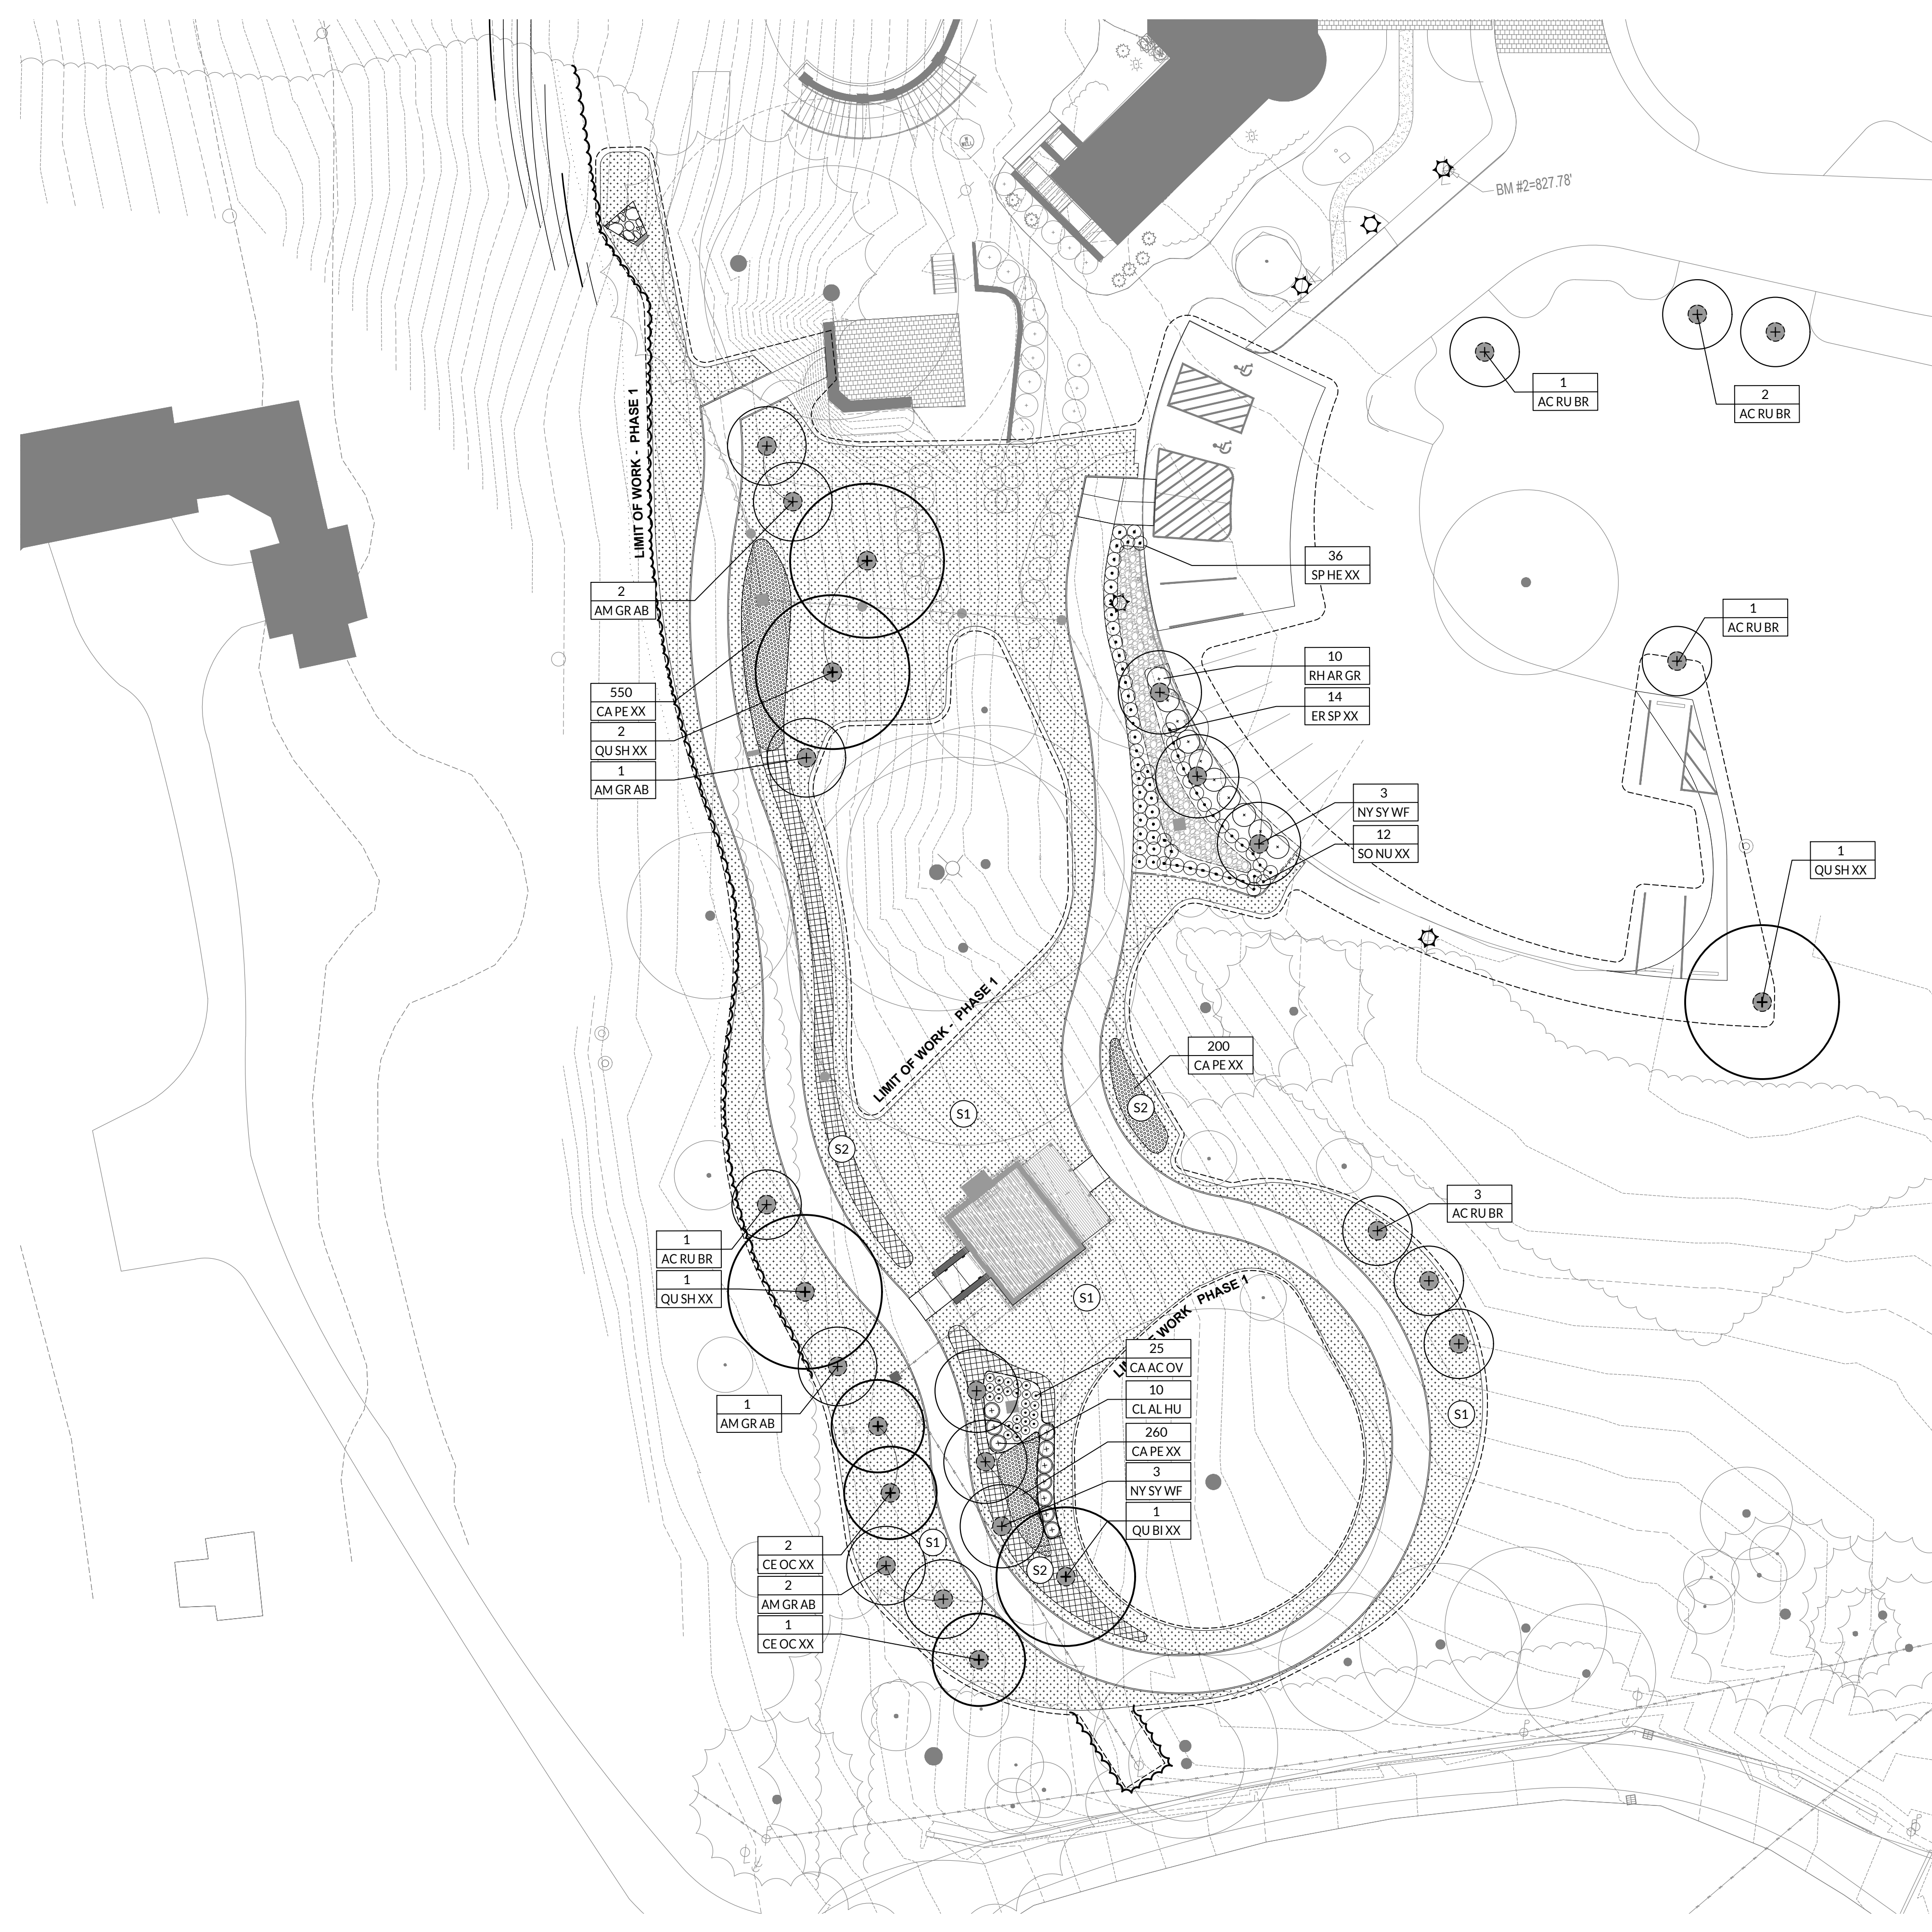

PLANTING LEGEND

- SEEDED LAWN AREA
- LOW-MOW SEEDED LAWN AREA
- SODDED LAWN AREA
- DECIDUOUS TREE
- DECIDUOUS SHRUB PLANTING AREA
- ORNAMENTAL GRASS PLANTING AREA


LEGEND - EXISTING CONDITIONS

- EX. LIGHT POLE
- EX. SIGN
- EX. FIRE HYDRANT
- EX. WATER VALVE
- EX. CATCH BASIN
- EX. SAN. MANHOLE
- EX. CURB INLET
- EX. STORM MANHOLE
- EX. GUY POLE
- EX. UTILITY POLE
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- EX. BENCHMARK
- EX. MAJOR CONTOUR
- EX. MINOR CONTOUR
- EX. SANITARY
- EX. WATER MAIN
- EX. GAS MAIN
- EX. STORM
- EX. COMBINED SEWER
- EX. OVERHEAD EL.
- EX. TREELINE
- EX. DECIDUOUS TREE
- EX. EVERGREEN TREE
- TREE CRITICAL ROOT ZONE


PLANT SCHEDULE


SYMBOL	BOTANICAL NAME	COMMON NAME	SIZE	PHASE 1		PHASE 2	
				SH.	#	SH.	#
DECIDUOUS TREES							
AC RU BR	<i>Acer rubrum</i> 'Brandywine'	Brandywine Red Maple	2.5" CAL.	L401	8		
AM GR AB	<i>Amelanchier grandiflora</i> 'Autumn Brilliance'	Autumn Brilliance Serviceberry	1.75" CAL.	L401	6		
CE OC XX	<i>Celtis occidentalis</i>	Common Hackberry	2" CAL.	L401	3		
NY SY XX	<i>Nyssa sylvatica</i> 'Wildfire'	Wildfire Black Gum	1.5" CAL.	L401	6		
QU BI XX	<i>Quercus bicolor</i>	Swamp White Oak	2.5" CAL.	L401	1		
QU SH XX	<i>Quercus shumardii</i>	Shumard Oak	2.5" CAL.	L401	5		
SHRUBS							
CL AL HU	<i>Clethra alnifolia</i> 'Hummingbird'	Hummingbird Summersweet	#3 Cont.	L401	10		
RH AR GR	<i>Rhus aromatica</i> 'Gro-low'	Gro-low Fragrant Sumac	#3 Cont.	L401	10		
GRASSES							
CA AC OV	<i>Calamagrostis acutiflora</i> 'Overdam'	Overdam Feather Reed Grass	#1 Cont.	L401	25		
CA PE XX	<i>Carex pensylvanica</i>	Pennsylvania Sedge	#1 Cont.	L401	1010		
ER SP XX	<i>Eragrostis spectabilis</i>	Purple Love Grass	#1 Cont.	L401	14		
SO NU XX	<i>Sorghastrum nutans</i>	Indian Grass	#1 Cont.	L401	12		
SP HE XX	<i>Sporobolus heterolepis</i>	Prairie Dropseed	#1 Cont.	L401	48		

All tree locations to be staked by contractor and final located in field with Landscape Architect and/or Owner. All other plant and plant groupings shall be final located in field. Plants used for this project are to exhibit the finest aesthetic and horticultural qualities associated with the species and varieties specified. All substitutions are to be approved by the Landscape Architect and/or Owner. Plants of same species and variety are to be acquired from a single source with stock in quantities large enough to secure replacements.

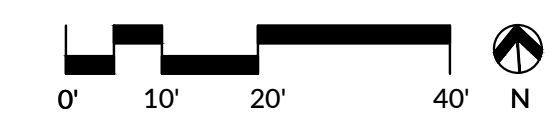

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24" TREE

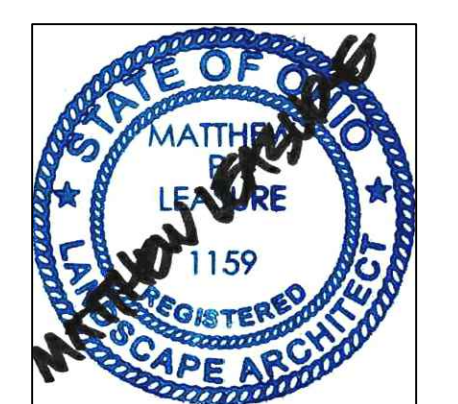CODED NOTES - LAYOUT AND MATERIALS PLAN

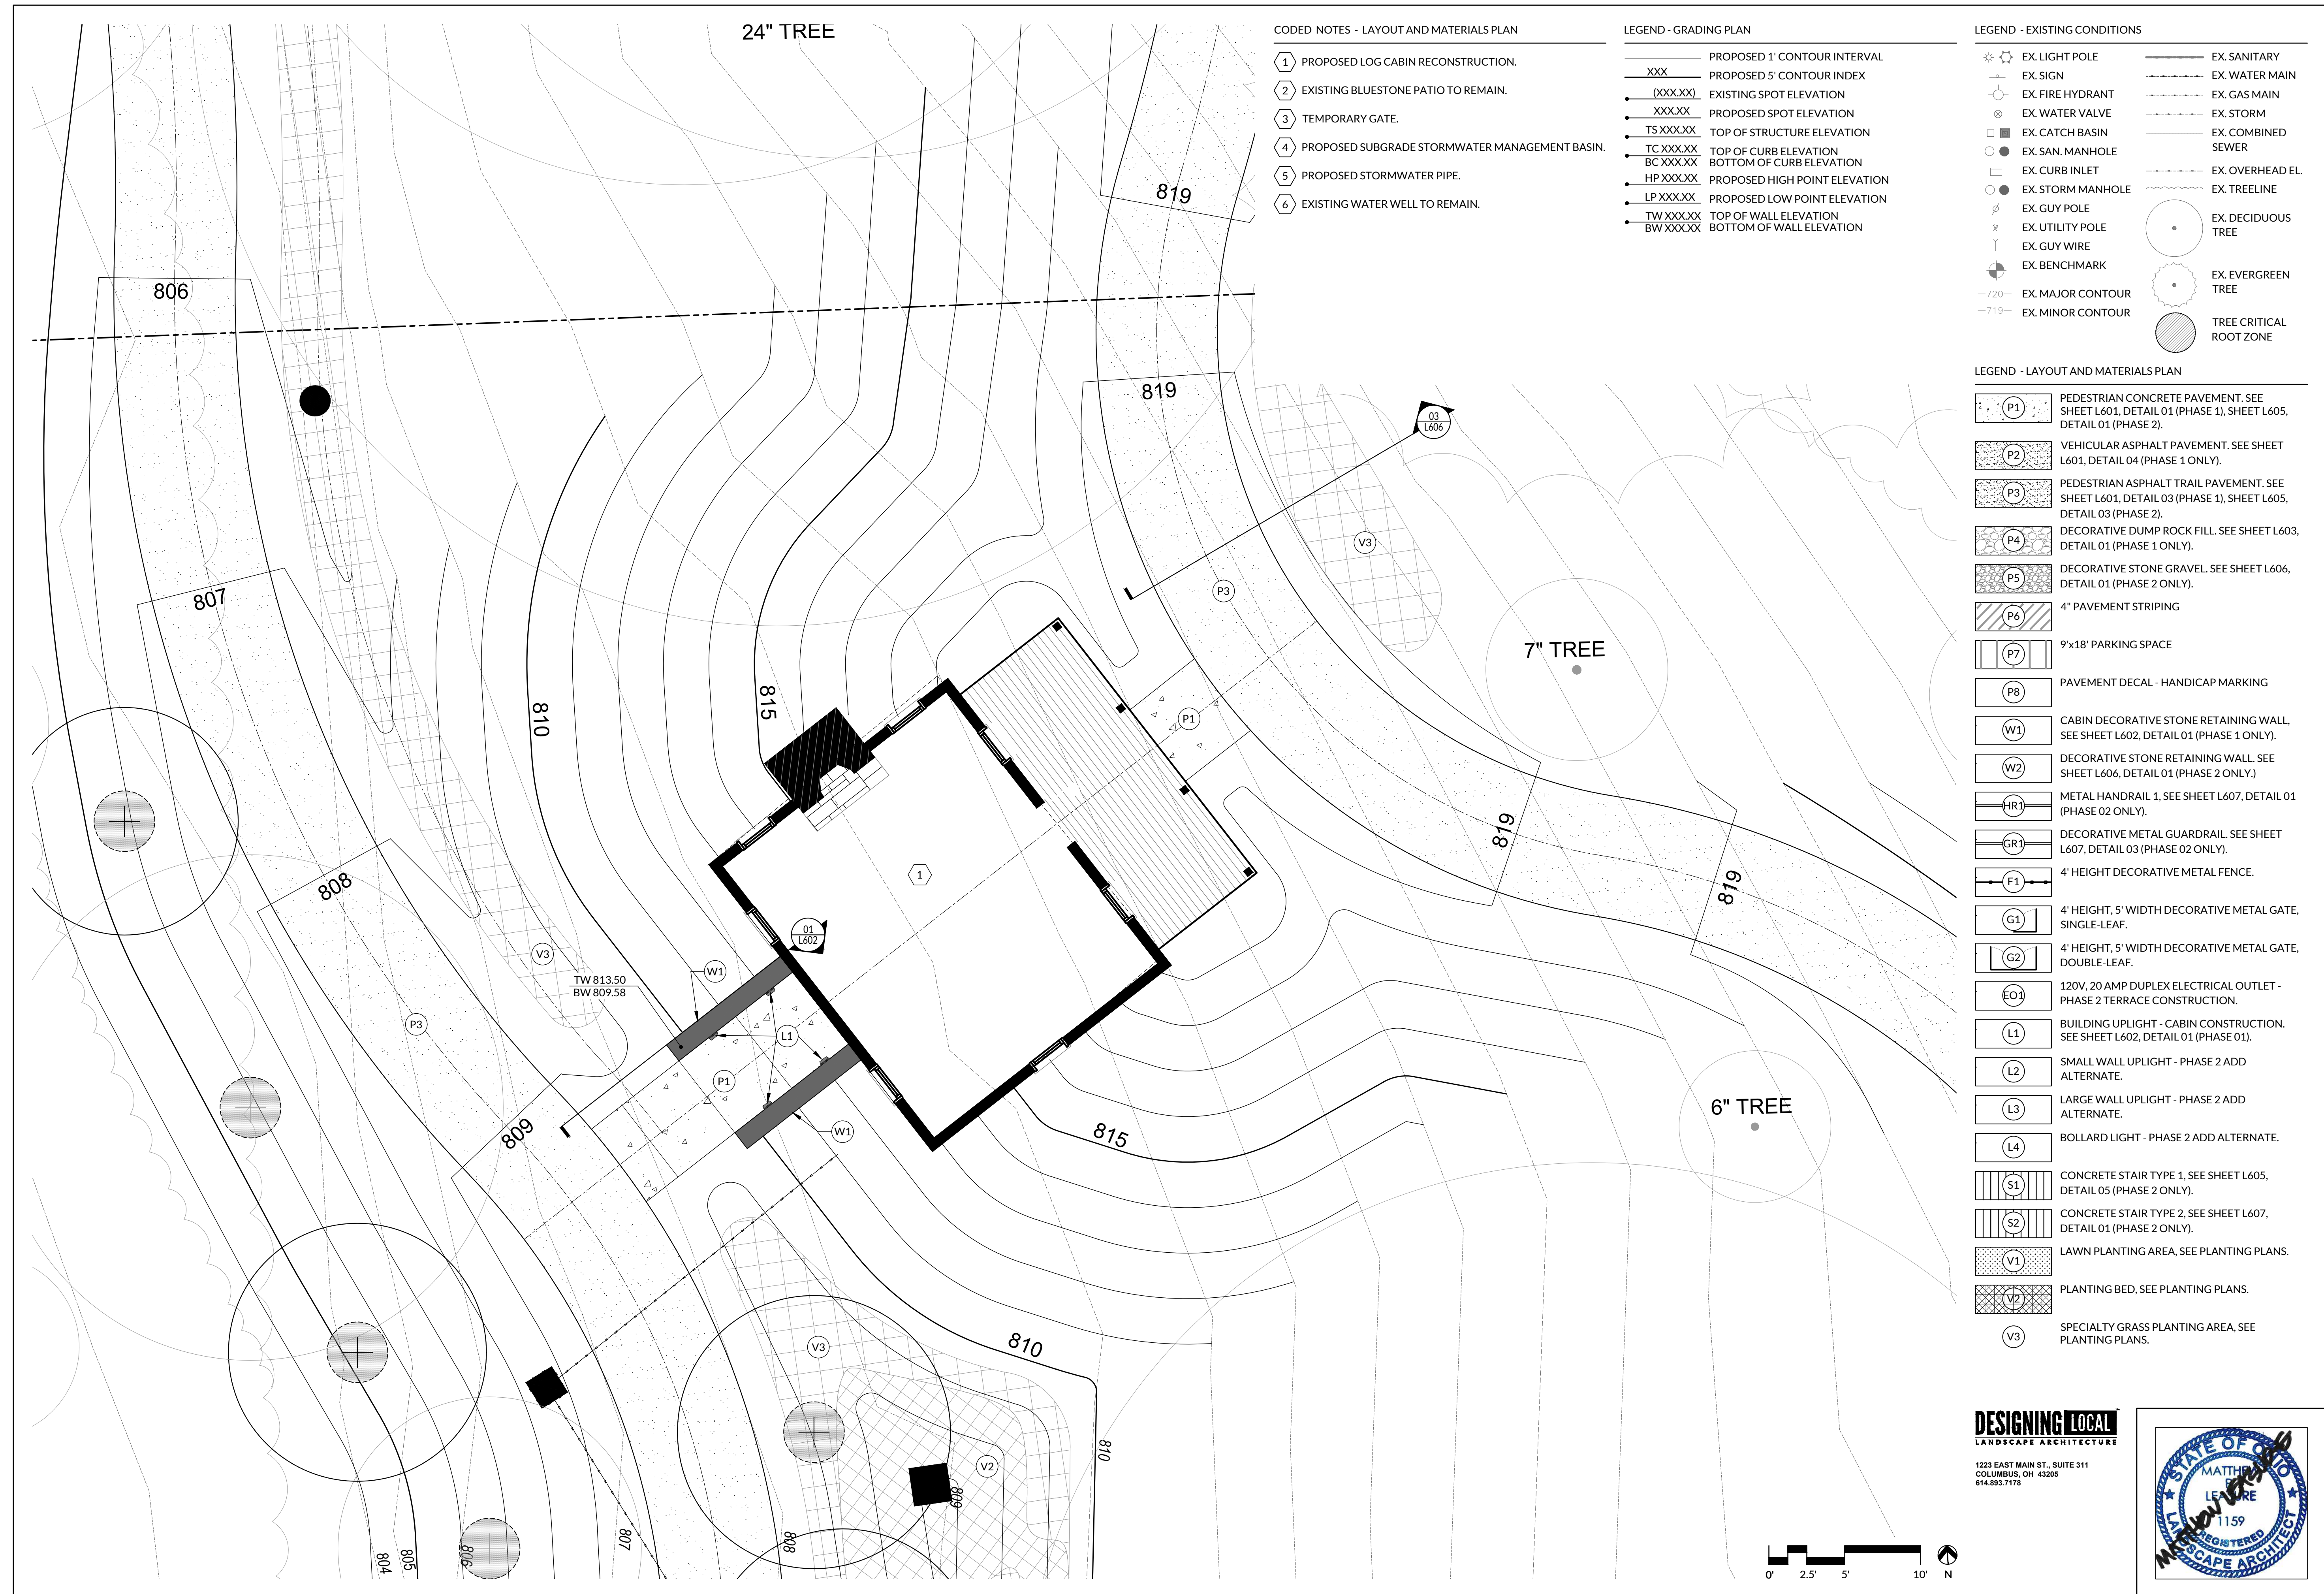- 1 PROPOSED LOG CABIN RECONSTRUCTION.
- 2 EXISTING BLUESTONE PATIO TO REMAIN.
- 3 TEMPORARY GATE.
- 4 PROPOSED SUBGRADE STORMWATER MANAGEMENT BASIN.
- 5 PROPOSED STORMWATER PIPE.
- 6 EXISTING WATER WELL TO REMAIN.

LEGEND - GRADING PLAN

- PROPOSED 1" CONTOUR INTERVAL
- XXX PROPOSED 5" CONTOUR INDEX
- (XXX.XX) EXISTING SPOT ELEVATION
- XXX.XX PROPOSED SPOT ELEVATION
- TS XXX.XX TOP OF STRUCTURE ELEVATION
- TC XXX.XX TOP OF CURB ELEVATION
- BC XXX.XX BOTTOM OF CURB ELEVATION
- HP XXX.XX PROPOSED HIGH POINT ELEVATION
- LP XXX.XX PROPOSED LOW POINT ELEVATION
- TW XXX.XX TOP OF WALL ELEVATION
- BW XXX.XX BOTTOM OF WALL ELEVATION

LEGEND - EXISTING CONDITIONS


- EX. LIGHT POLE
- EX. SIGN
- EX. FIRE HYDRANT
- EX. WATER VALVE
- EX. CATCH BASIN
- EX. SAN. MANHOLE
- EX. CURB INLET
- EX. STORM MANHOLE
- EX. GUY POLE
- EX. UTILITY POLE
- EX. GUY WIRE
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- EX. TREELINE
- EX. DECIDUOUS TREE
- EX. EVERGREEN TREE
- TREE CRITICAL ROOT ZONE

LEGEND - LAYOUT AND MATERIALS PLAN


- P1 PEDESTRIAN CONCRETE PAVEMENT. SEE SHEET L601, DETAIL 01 (PHASE 1), SHEET L605, DETAIL 01 (PHASE 2).
- P2 VEHICULAR ASPHALT PAVEMENT. SEE SHEET L601, DETAIL 04 (PHASE 1 ONLY).
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DESIGNING LOCAL
LANDSCAPE ARCHITECTURE

1223 EAST MAIN ST., SUITE 311
COLUMBUS, OH 43205
614.893.7178

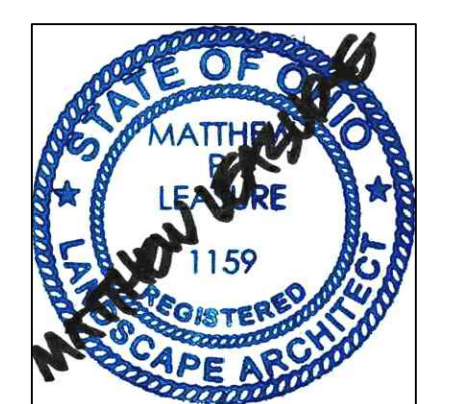

ISSUE DATE: APRIL 8, 2022
 CITY OF DUBLIN MINOR PROJECT REVIEW
DUBLIN ARTS CENTER
GROUNDINGS IMPROVEMENTS
 PROJECT OWNER: CITY OF DUBLIN PARKS & RECREATION
 5555 Penmar Drive, Dublin, Ohio 43017
 PROJECT ADDRESS: DUBLIN ARTS CENTER
 7050 Bala Road, Columbus, OH 43216
 SHEET TITLE: **PHASE 1 CABIN CONSTRUCTION**
 Cabin Area Enlargement Plan
 SHEET NUMBER: **L501**

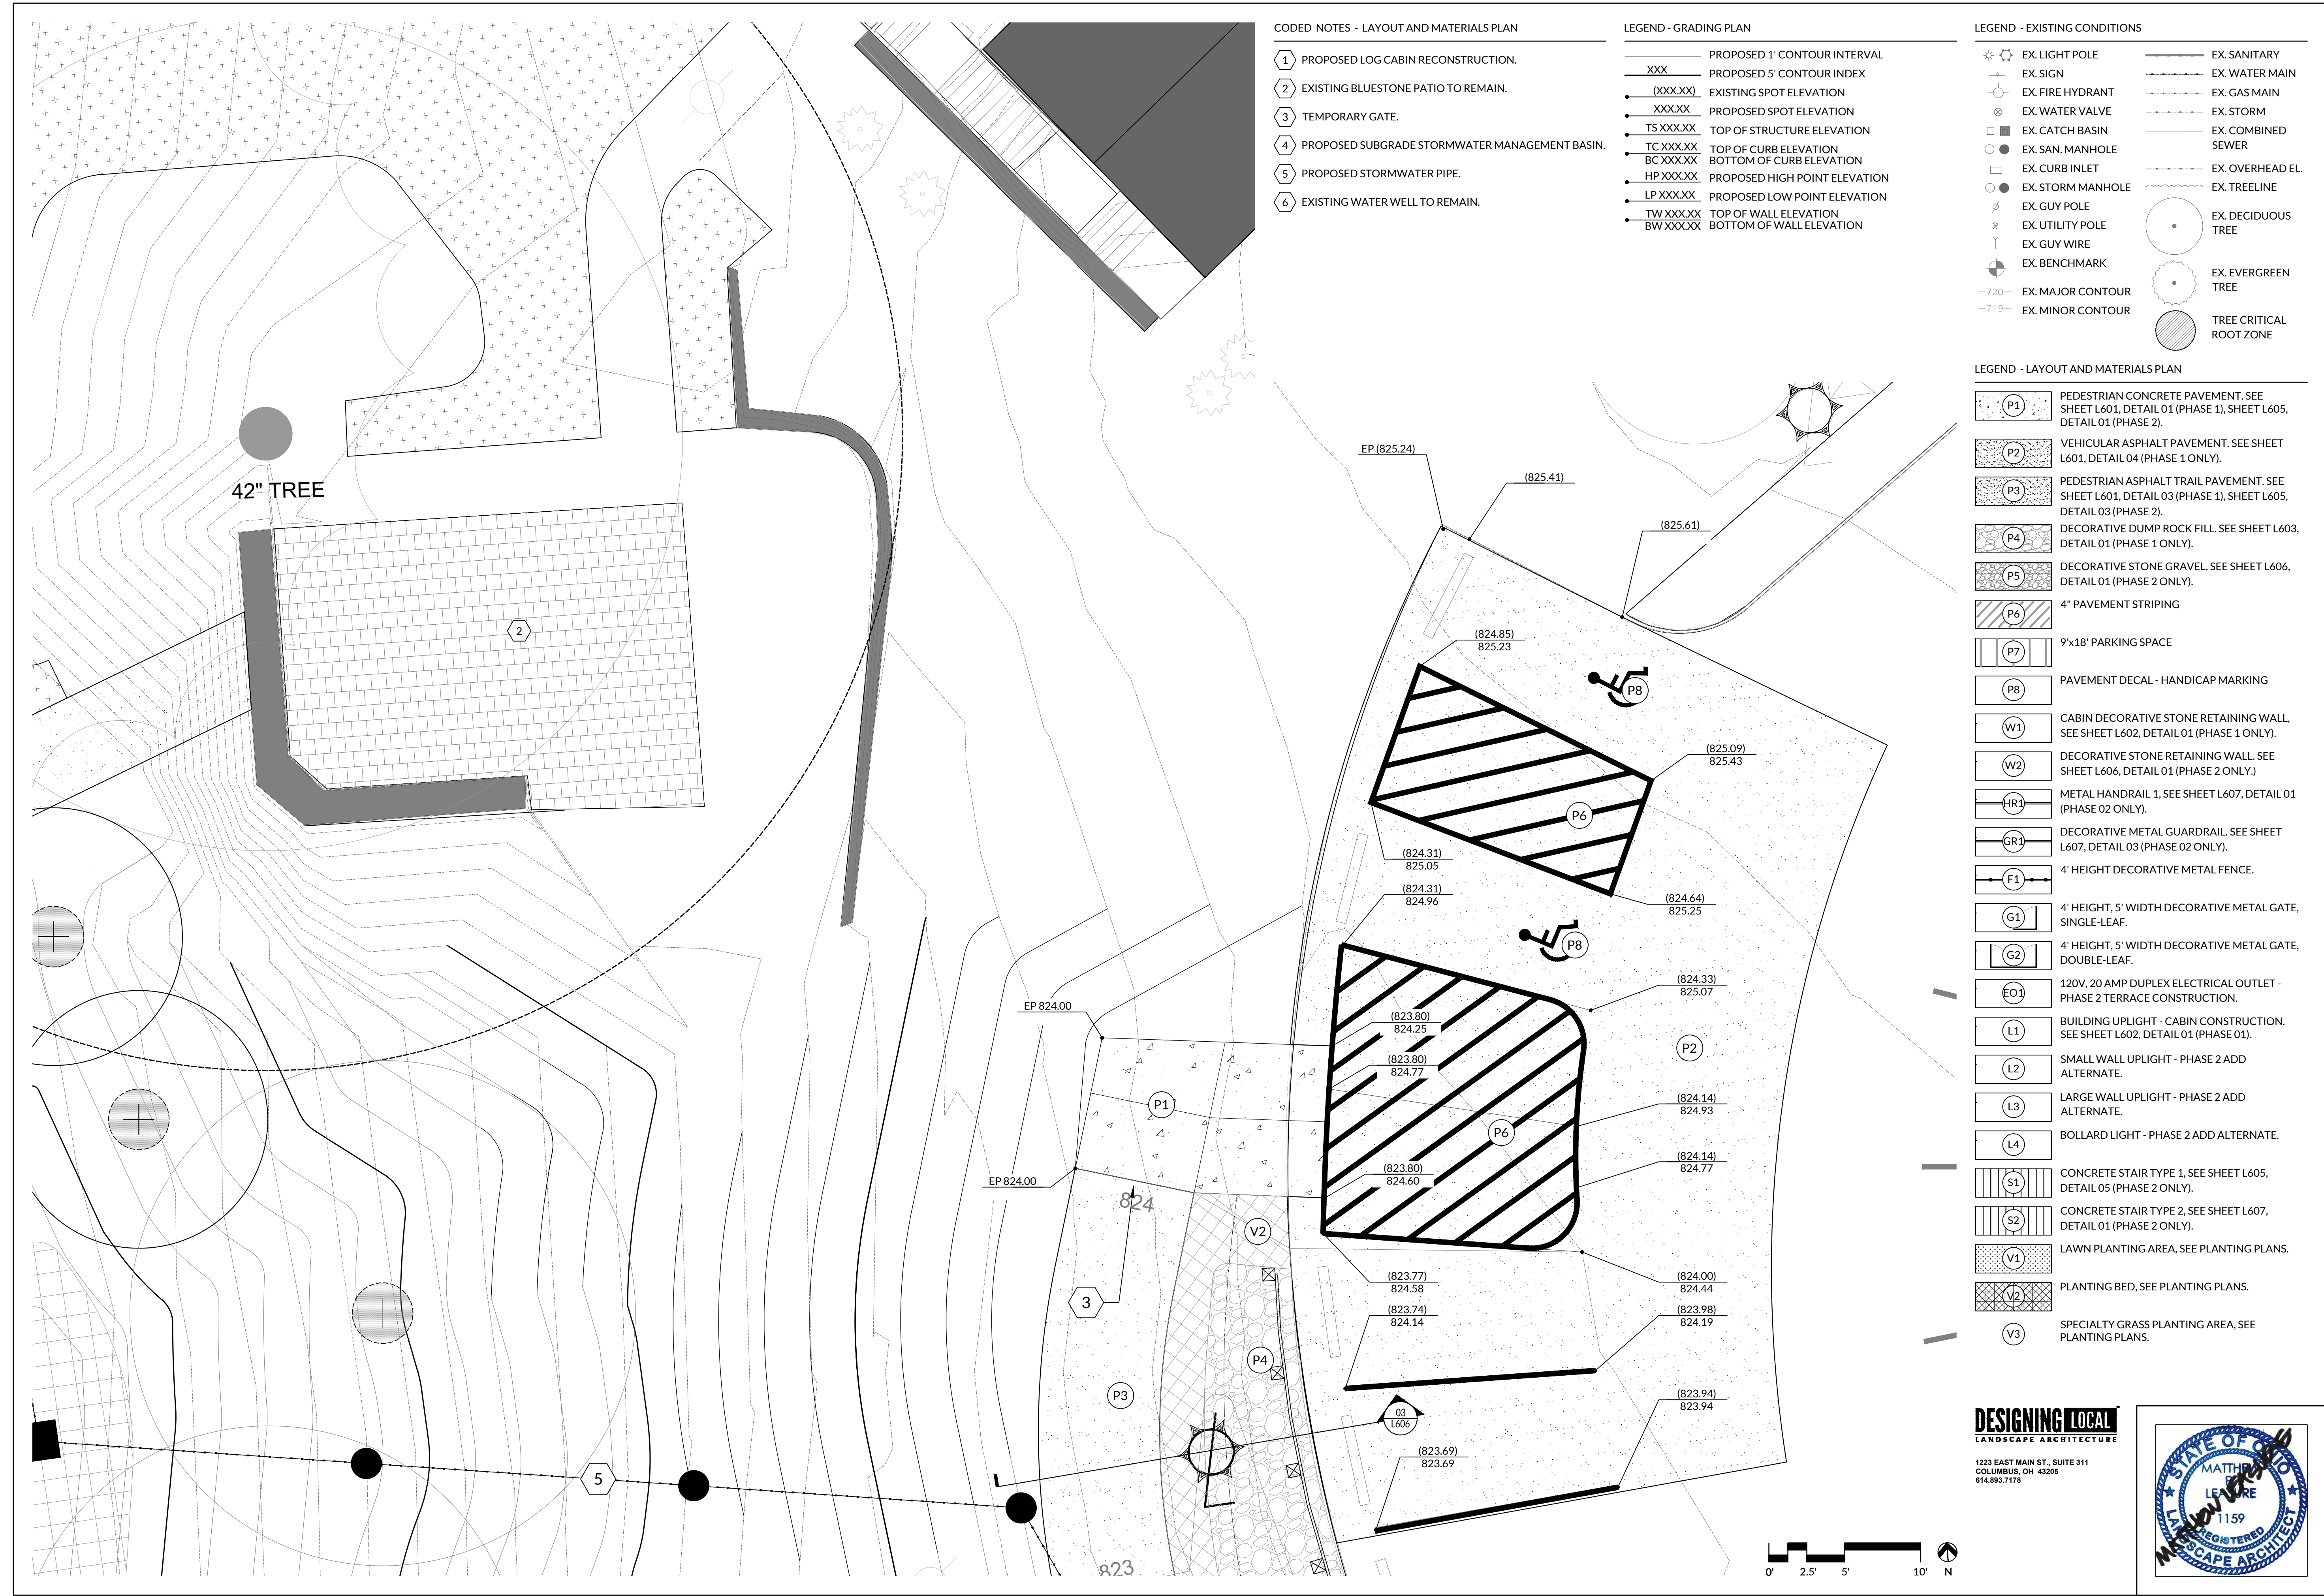

CODED NOTES - LAYOUT AND MATERIALS PLAN

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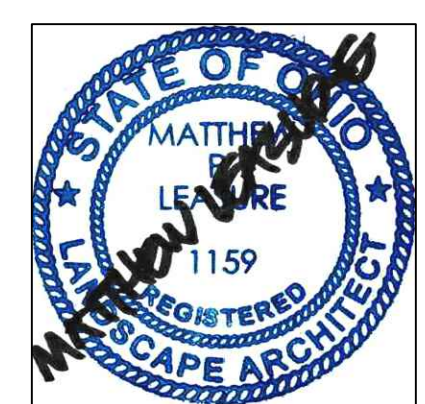
LEGEND - EXISTING CONDITIONS

- ☼ EX. LIGHT POLE
- EX. SIGN
- EX. FIRE HYDRANT
- EX. WATER VALVE
- EX. CATCH BASIN
- EX. SAN. MANHOLE
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- EX. STORM MANHOLE
- EX. GUY POLE
- EX. UTILITY POLE
- EX. GUY WIRE
- EX. BENCHMARK
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- EX. SANITARY
- EX. WATER MAIN
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- EX. TREELINE
- EX. DECIDUOUS TREE
- EX. EVERGREEN TREE
- TREE CRITICAL ROOT ZONE

LEGEND - LAYOUT AND MATERIALS PLAN


- P1 PEDESTRIAN CONCRETE PAVEMENT. SEE SHEET L601, DETAIL 01 (PHASE 1), SHEET L605, DETAIL 01 (PHASE 2).
- P2 VEHICULAR ASPHALT PAVEMENT. SEE SHEET L601, DETAIL 04 (PHASE 1 ONLY).
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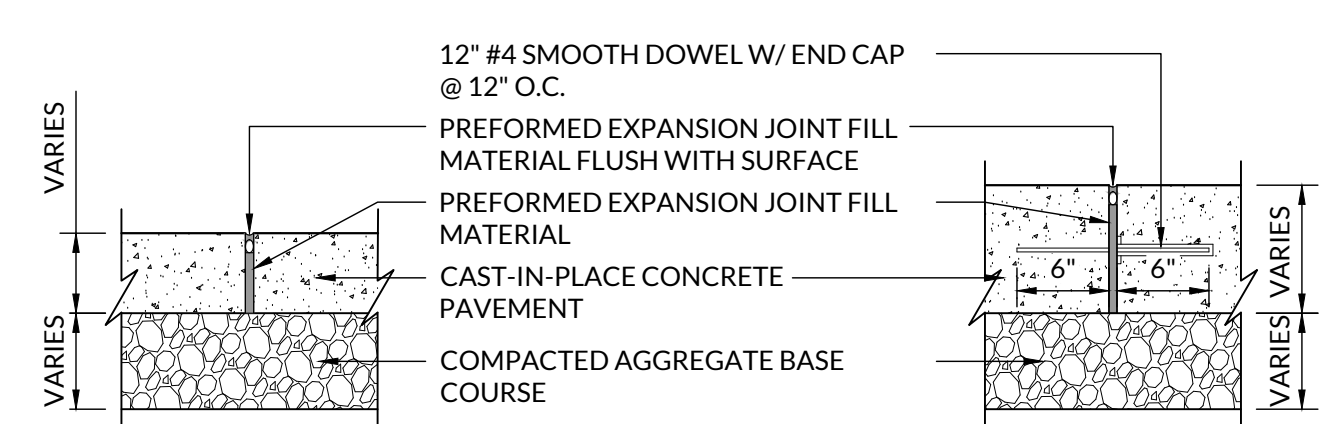
NOTES

- EXPANSION AND CONTROL JOINTS AS SHOWN ON PLAN. CONCRETE FINISH SHALL BE BROOM FINISH. PROVIDE FINISH ON CONCRETE SURFACES AFTER EDGE TOOLING. PROVIDE 1/2" RADIUS ON ALL SLAB EDGES.
- EXTEND COMPACTED AGGREGATE BASE 6" BEYOND EDGE OF PAVEMENT
- ITEM NUMBERS REFER TO THE CITY OF COLUMBUS CONSTRUCTION AND MATERIALS SPECIFICATIONS (CMSC), CURRENT EDITION. ALL WORK SHALL BE DONE IN ACCORDANCE WITH THESE SPECIFICATIONS.




01 CONCRETE PAVEMENT
SCALE: 1" = 1'-0"


REGULAR DUTY EXPANSION JOINT

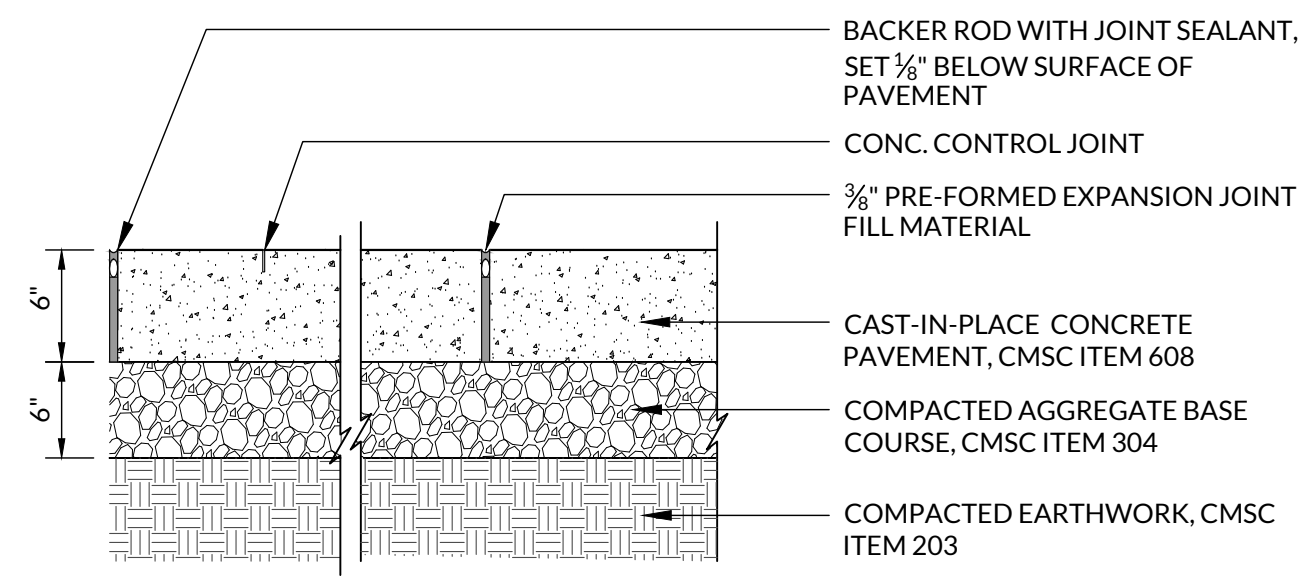


HEAVY DUTY EXPANSION JOINT

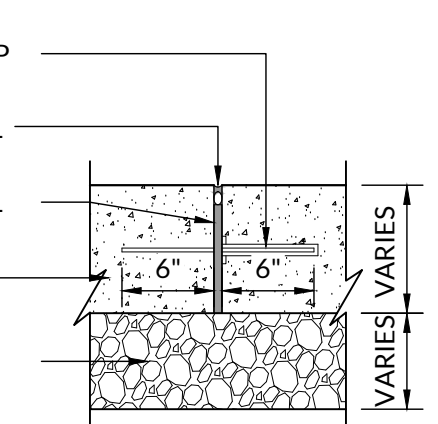

REGULAR DUTY CONTROL JOINT

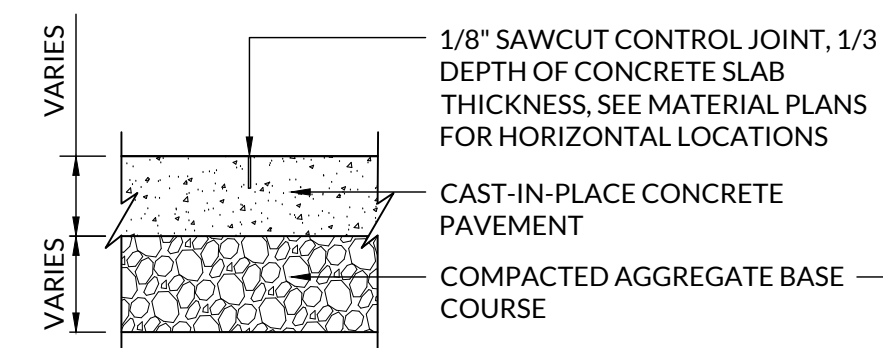


HEAVY DUTY CONTROL JOINT

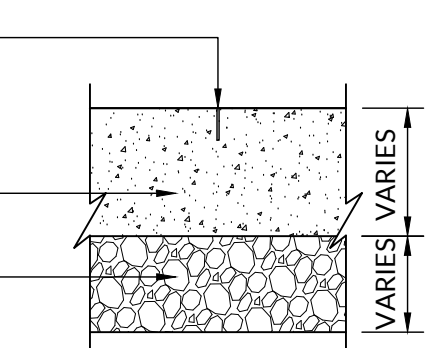

02 TYPICAL CONCRETE JOINT
SCALE: 1" = 1'-0"


*REFER TO CITY OF DUBLIN STANDARD DRAWINGS RD-06

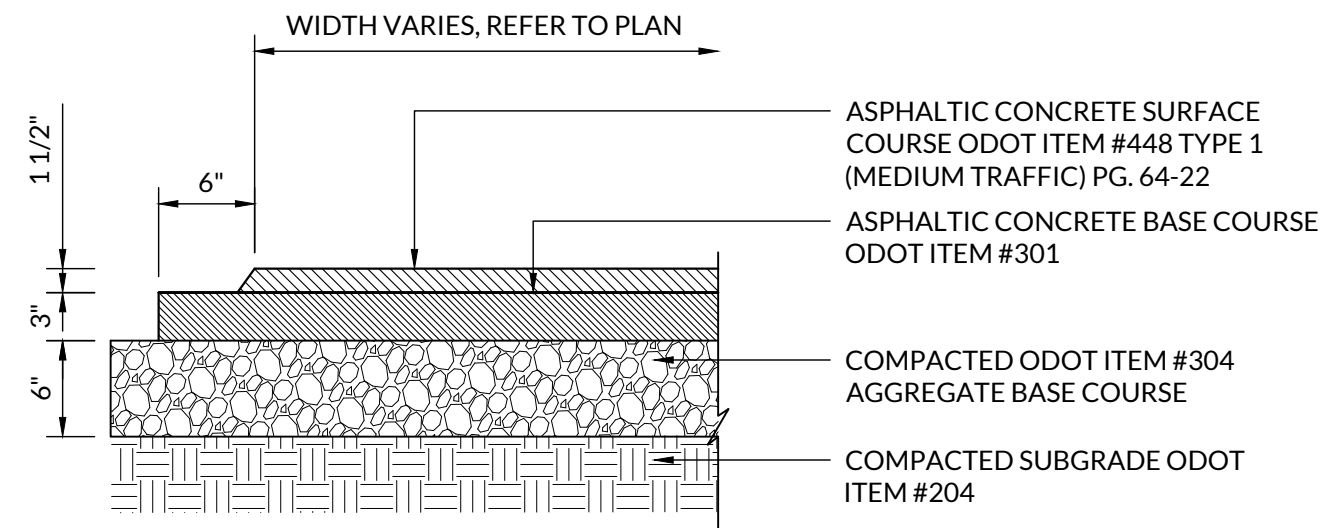

03 PEDESTRIAN ASPHALT TRAIL PAVEMENT
SCALE: 1" = 1'-0"

NOTES:


- ASPHALT PAVEMENT TO BE INSTALLED FOLLOWING GRADE ADJUSTMENT TO PROPOSED GRADES AND SUBSEQUENT SUBGRADE COMPACTION.

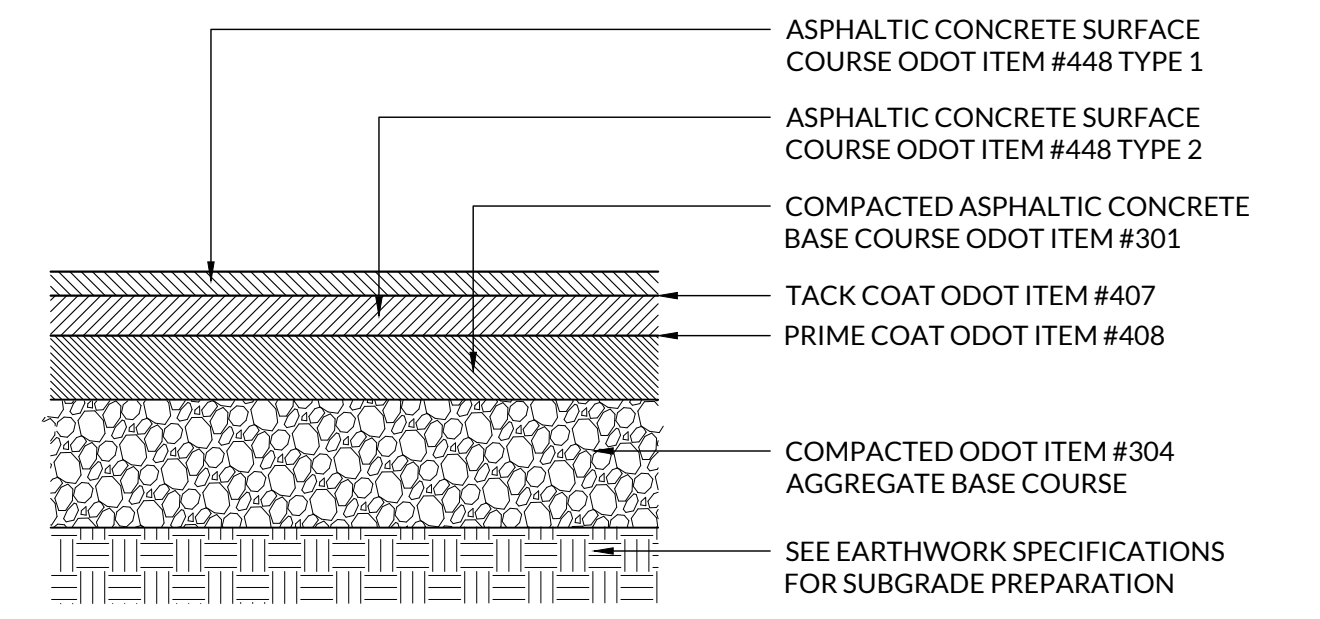

04 HEAVY DUTY ASPHALT PAVEMENT
SCALE: 1" = 1'-0"

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ISSUE DATE
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**DUBLIN ARTS CENTER
GROUNDS IMPROVEMENTS**


CITY OF DUBLIN
PARKS & RECREATION
5555 Penmar Drive
Dublin, Ohio 43017

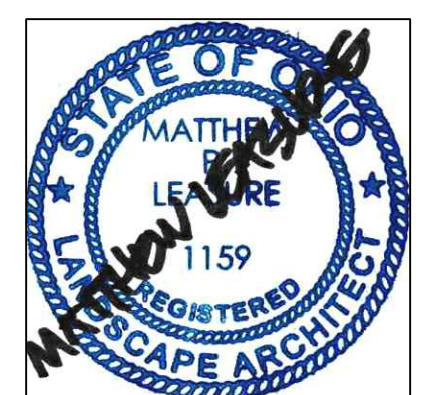PROJECT OWNER
City of Dublin

PROJECT ADDRESS
DUBLIN ARTS CENTER
700 East Dublin Road
Columbus, OH 43216


SHEET TITLE
**PHASE 1 CABIN CONSTRUCTION
Construction Details**

SHEET NUMBER
L601

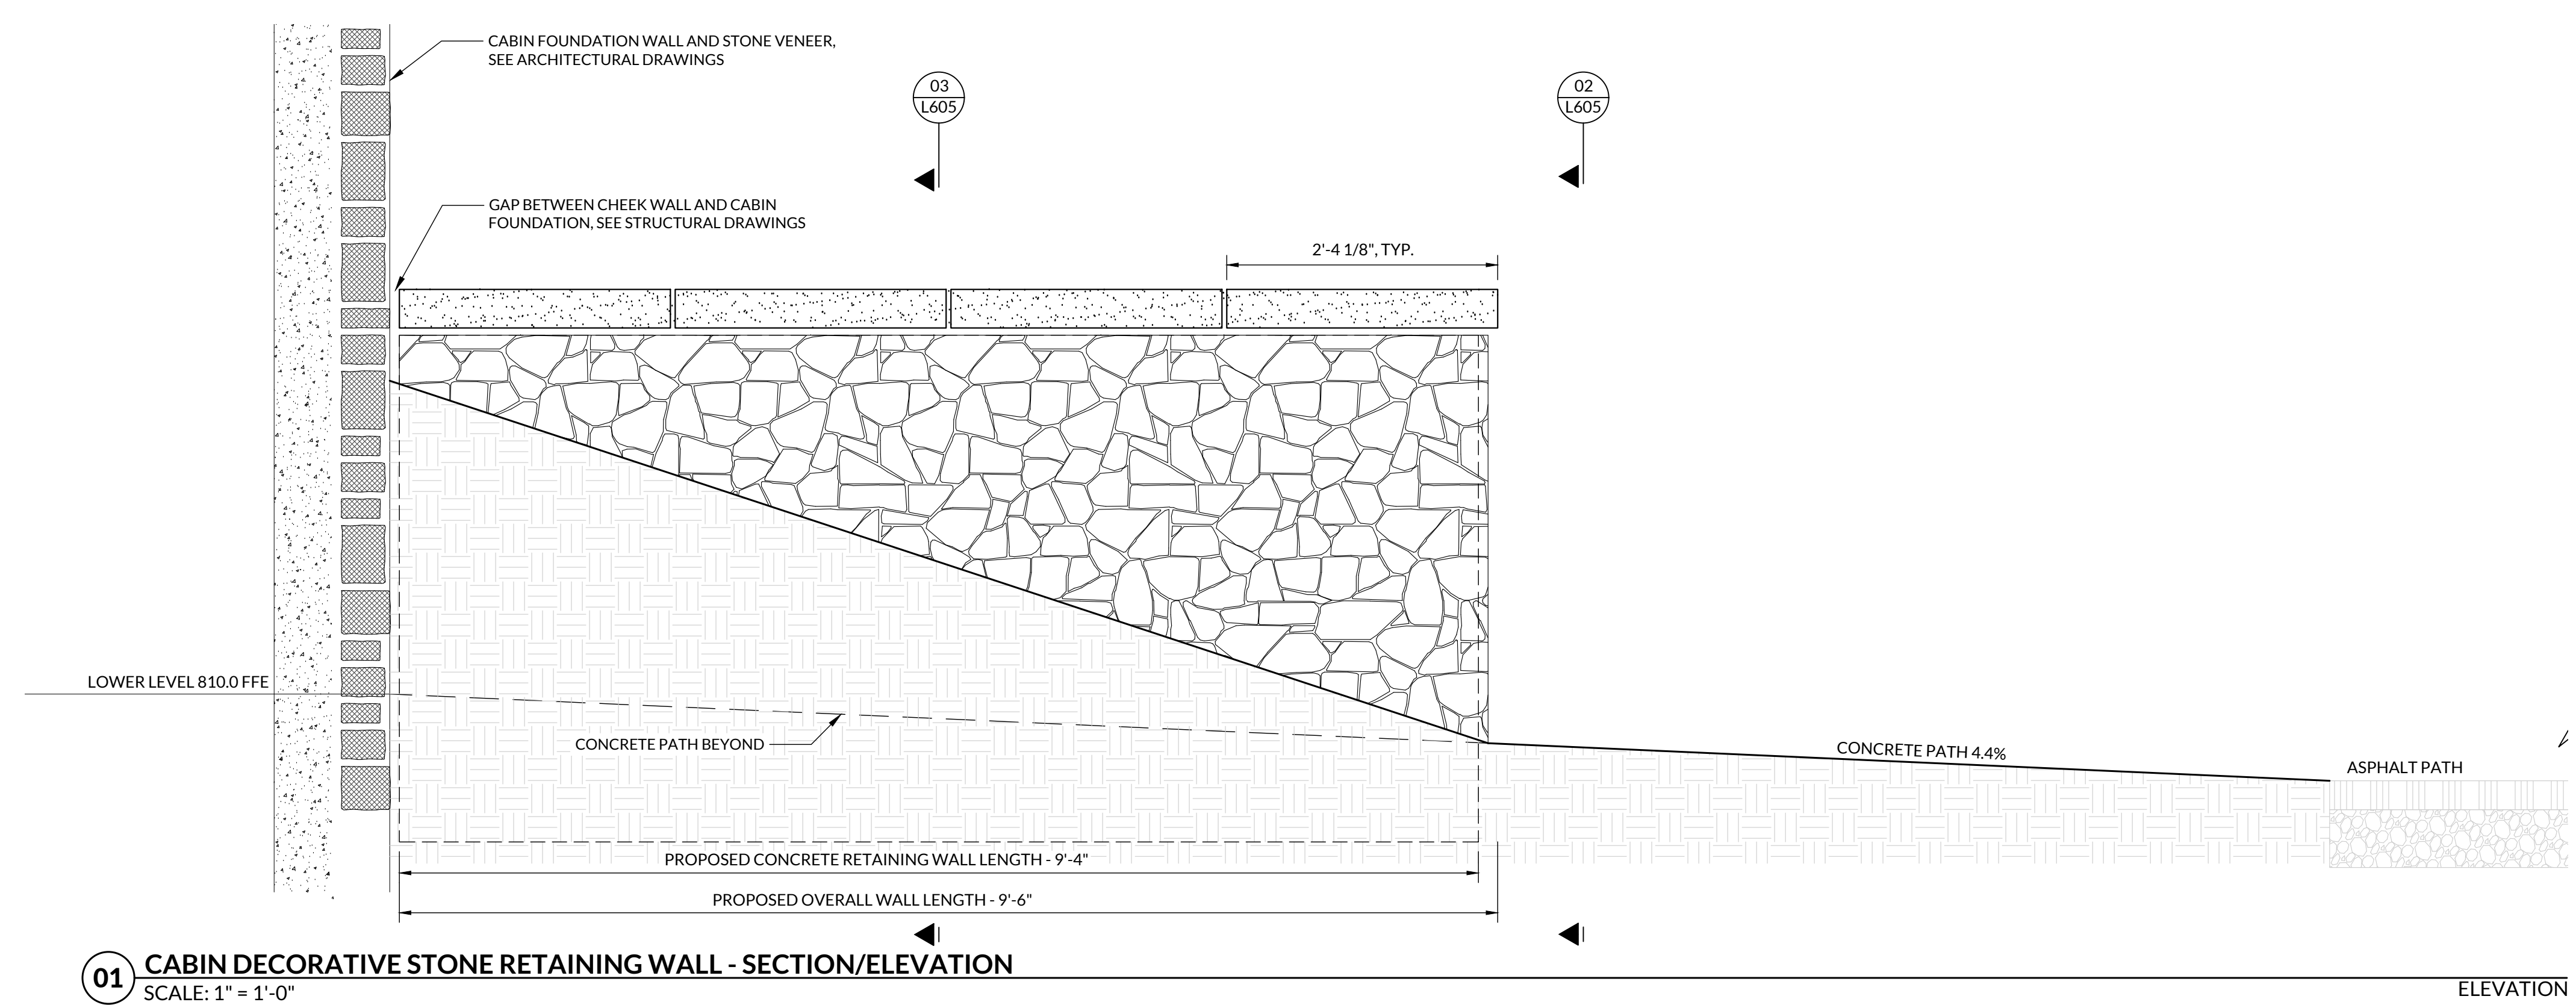


01 CABIN DECORATIVE STONE RETAINING WALL - SECTION/ELEVATION
SCALE: 1" = 1'-0"

ELEVATION

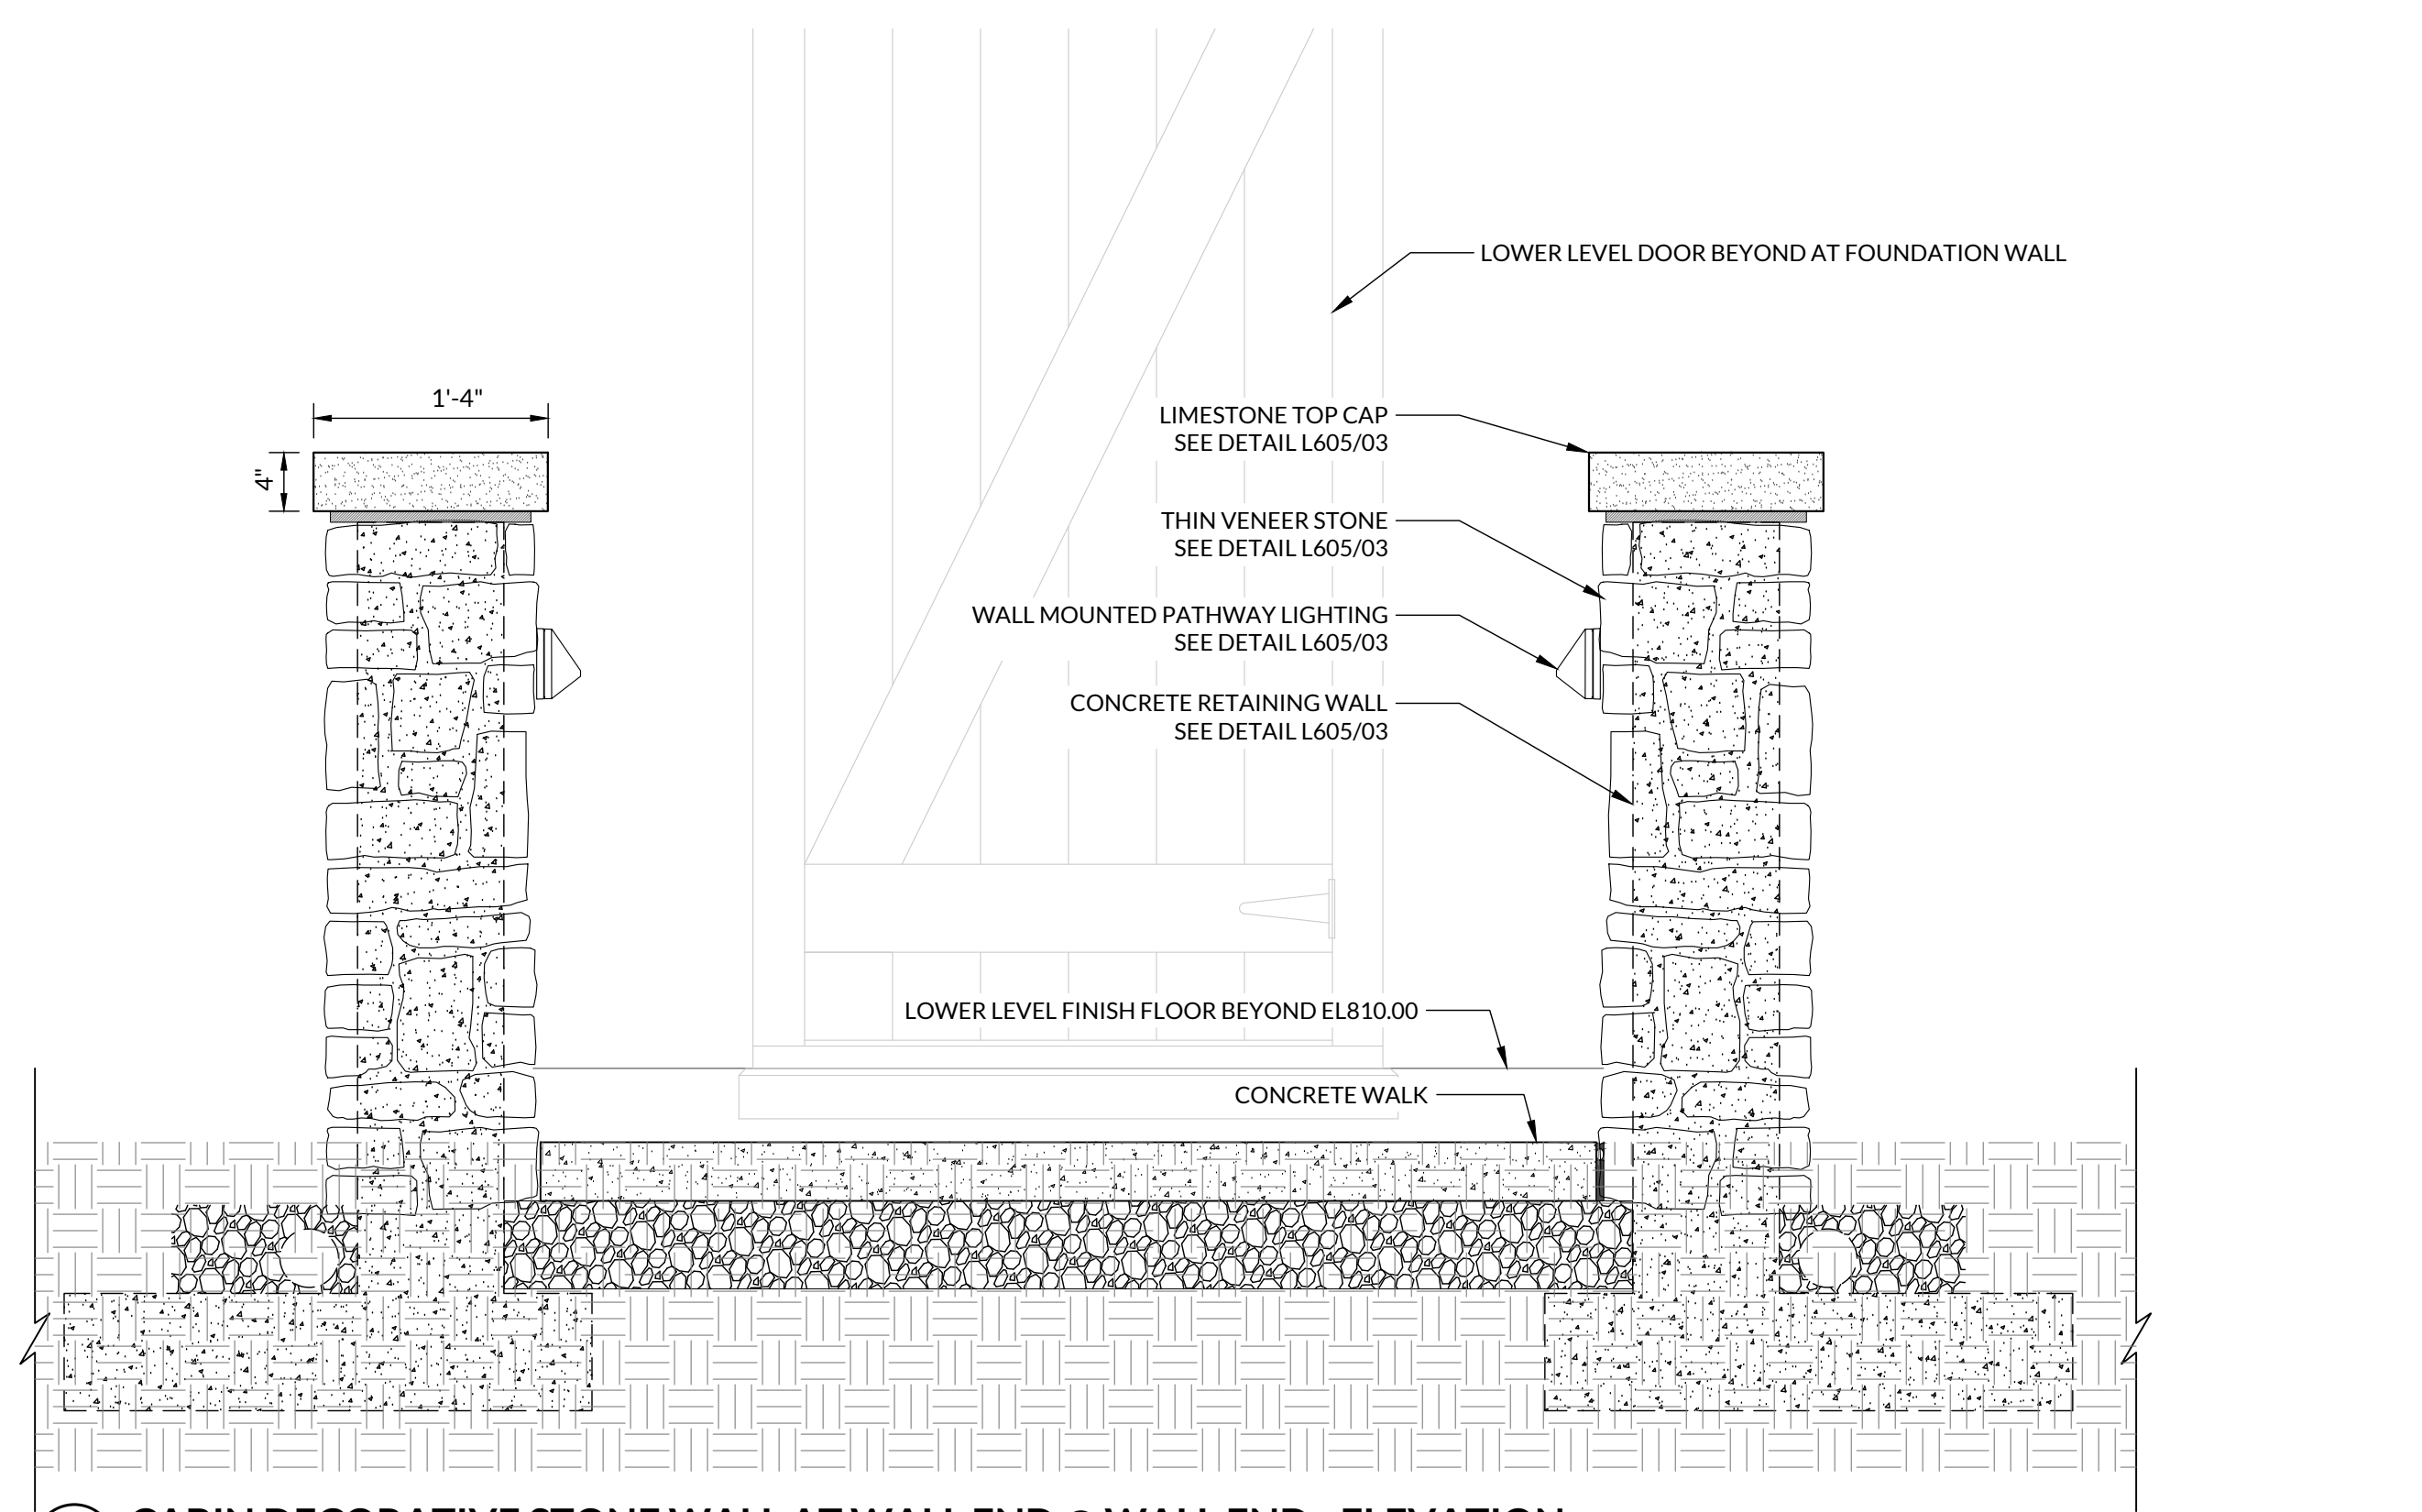

02 CABIN DECORATIVE STONE WALL AT WALL END @ WALL END - ELEVATION
SCALE: 1" = 1'-0"


ELEVATION

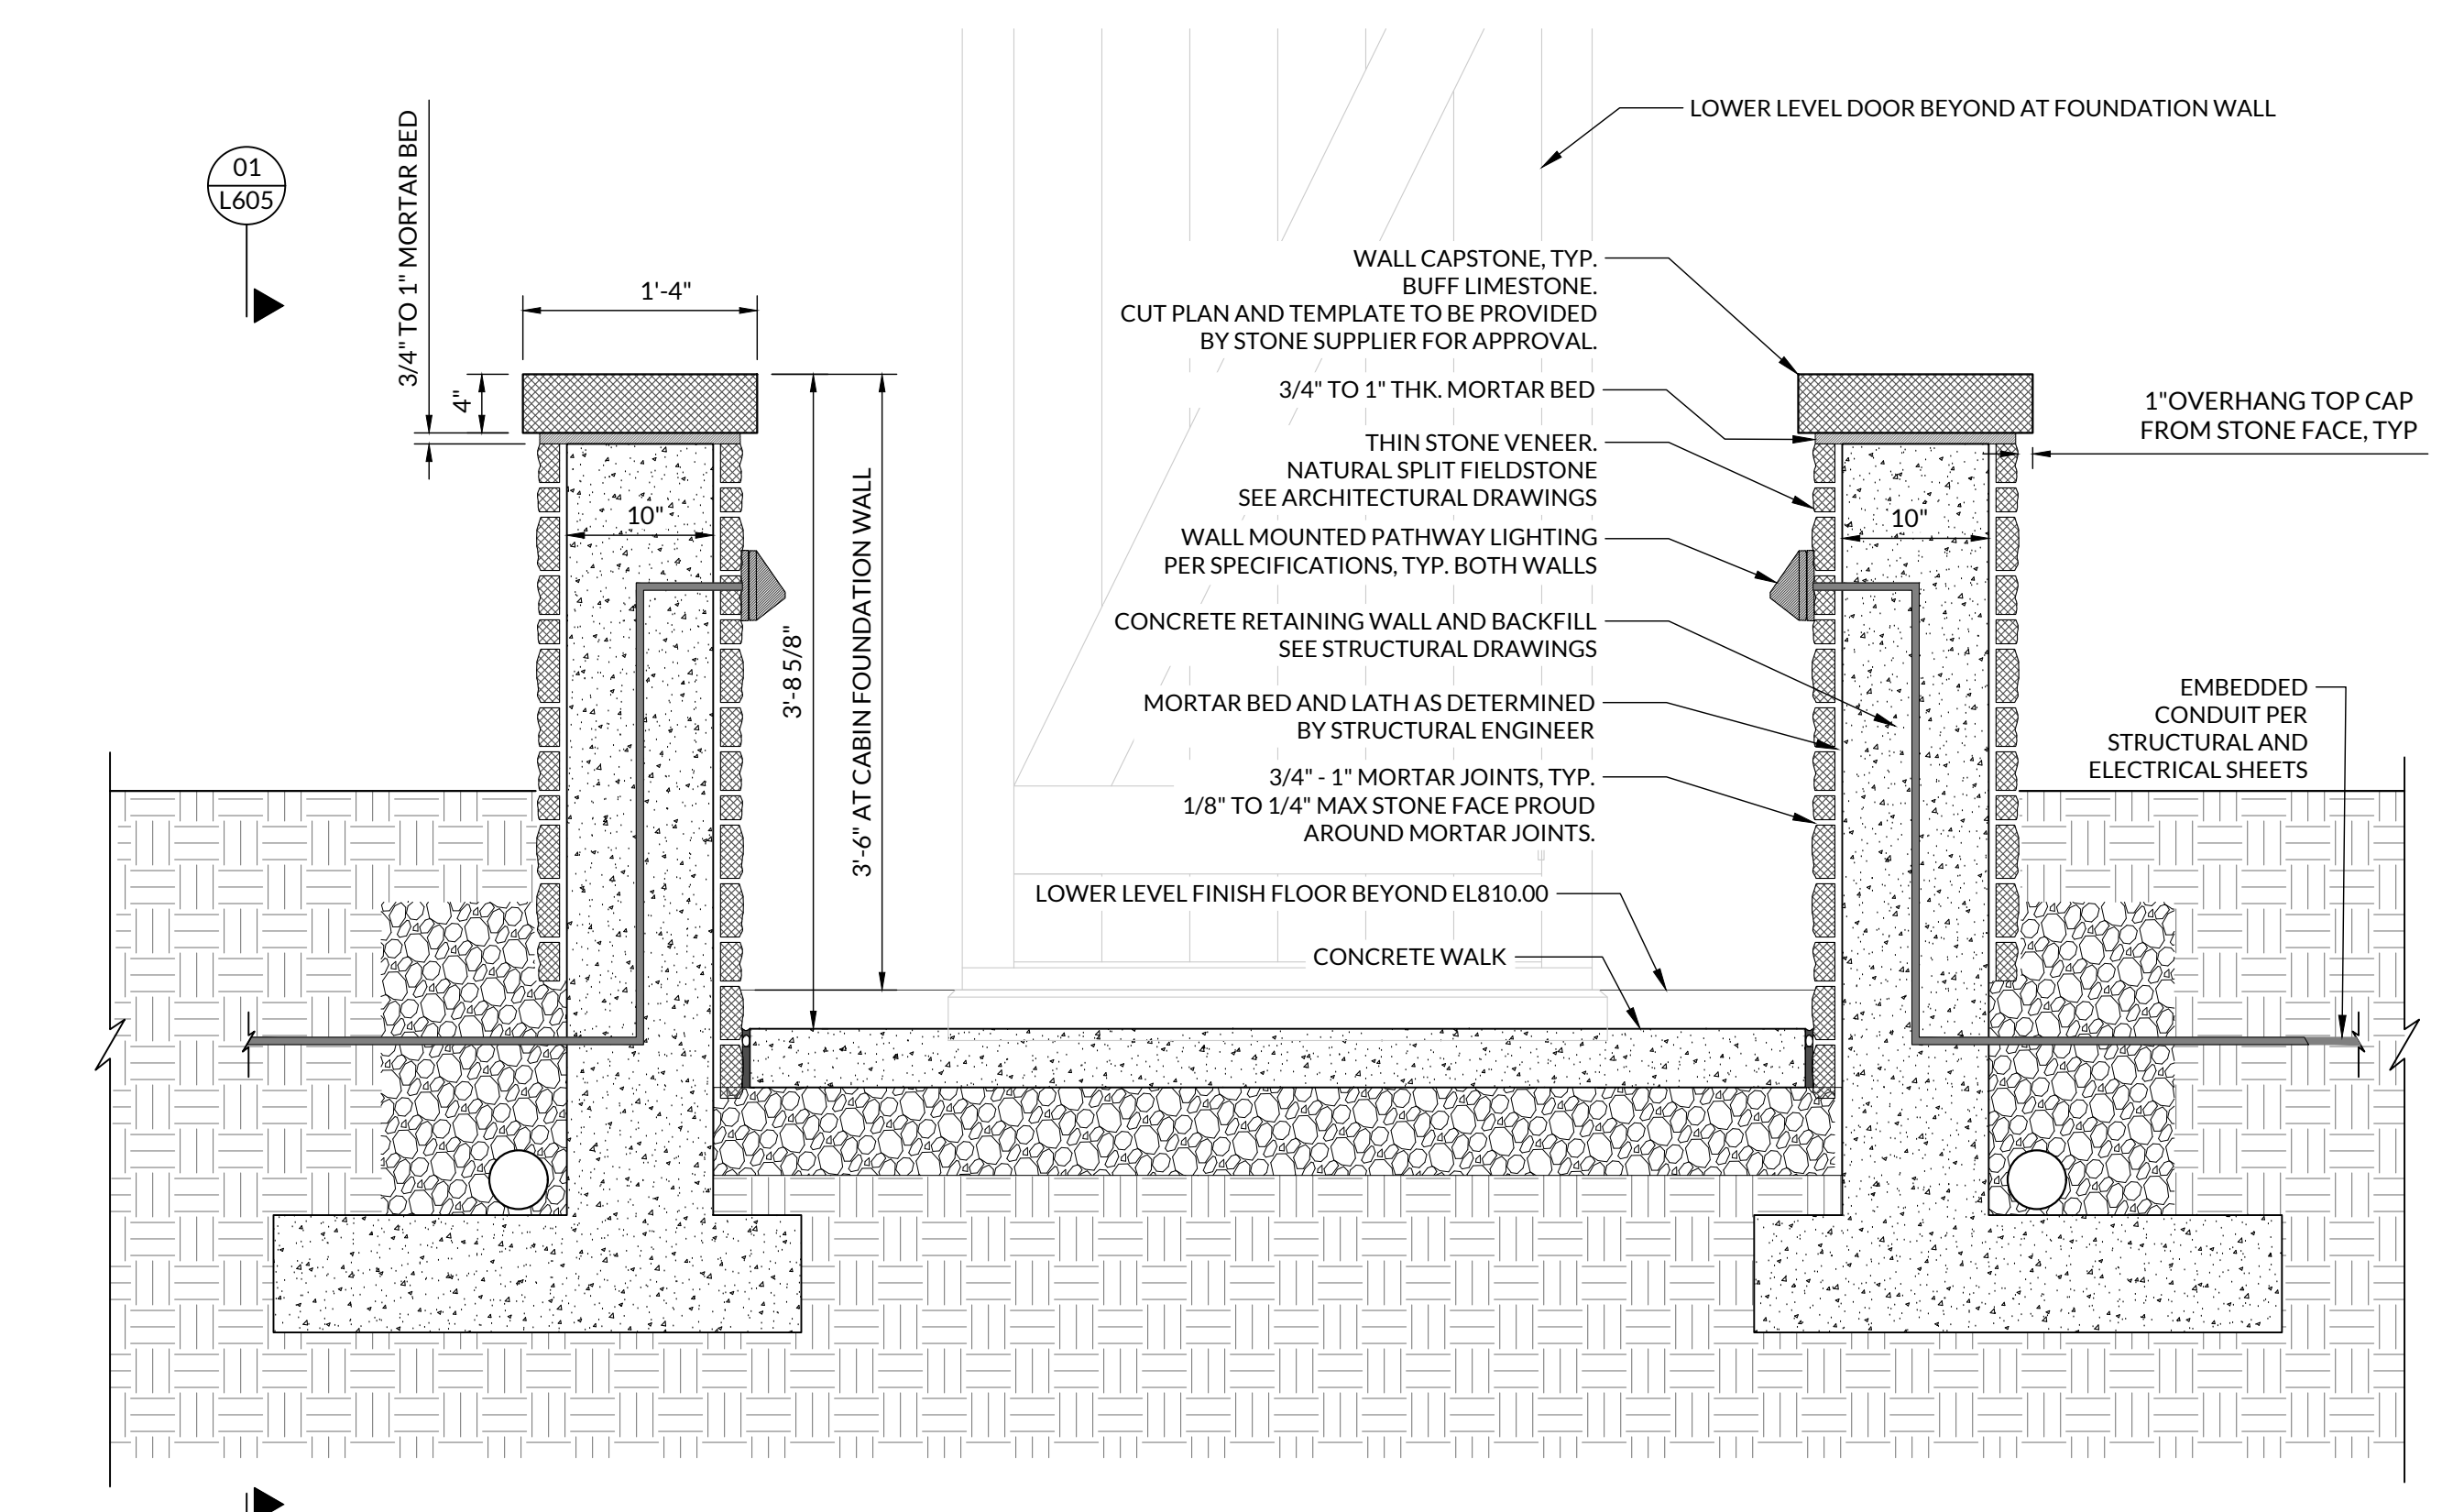



03 CABIN DECORATIVE STONE RETAINING WALL - SECTION
SCALE: 1" = 1'-0"

SECTION

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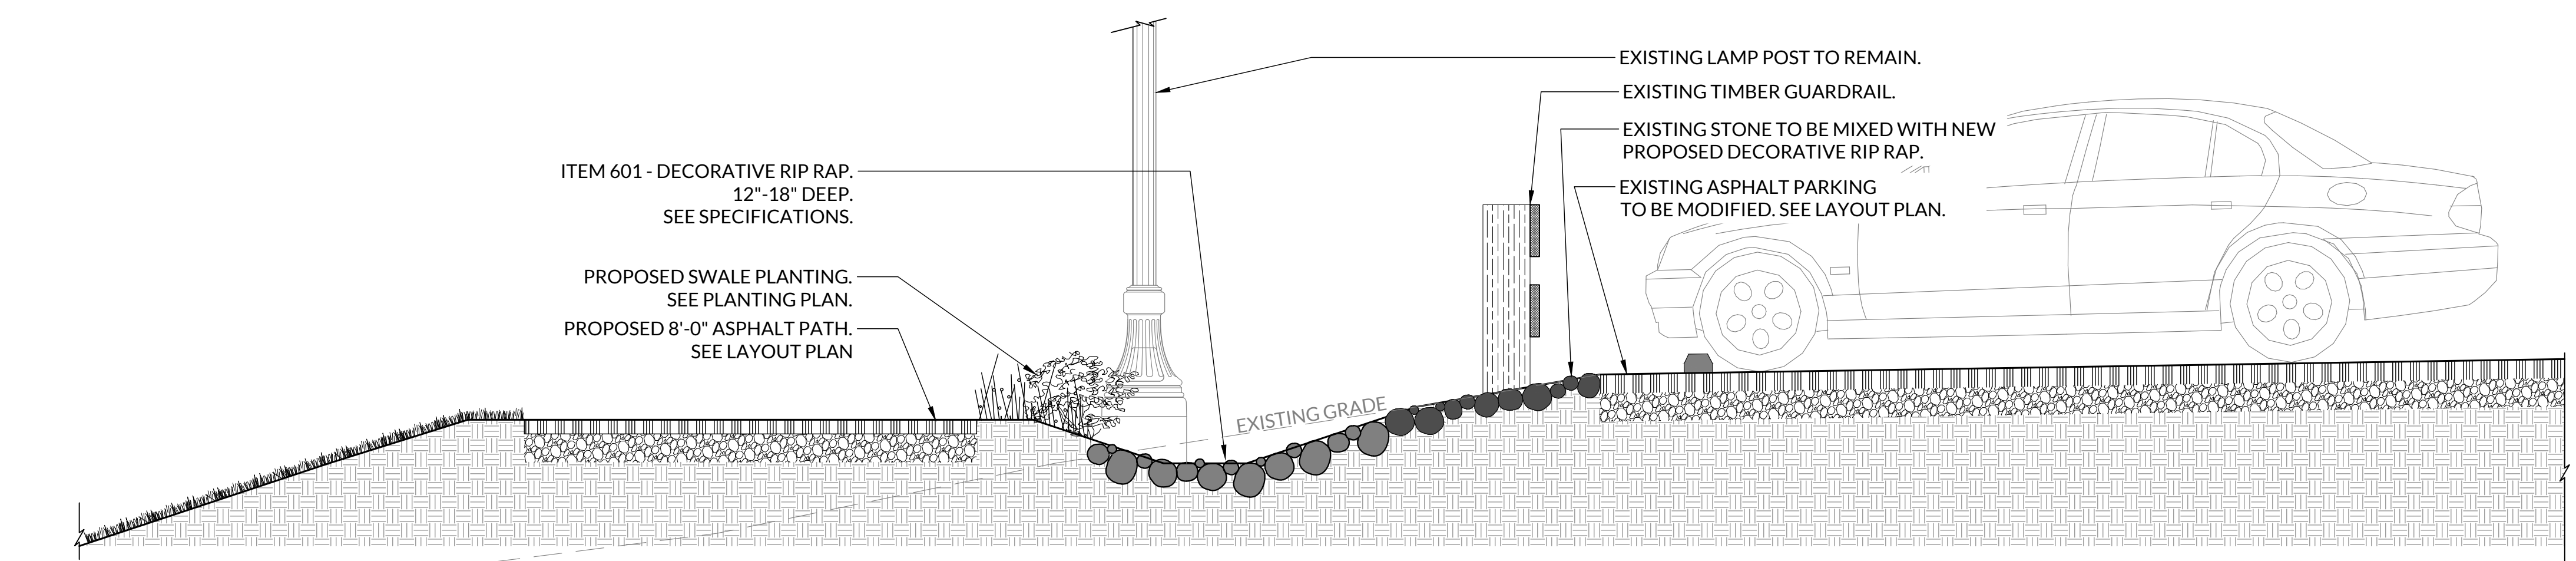

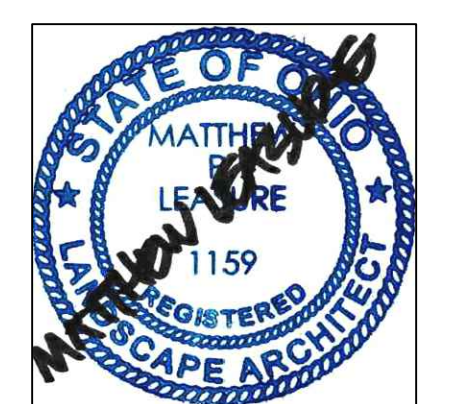
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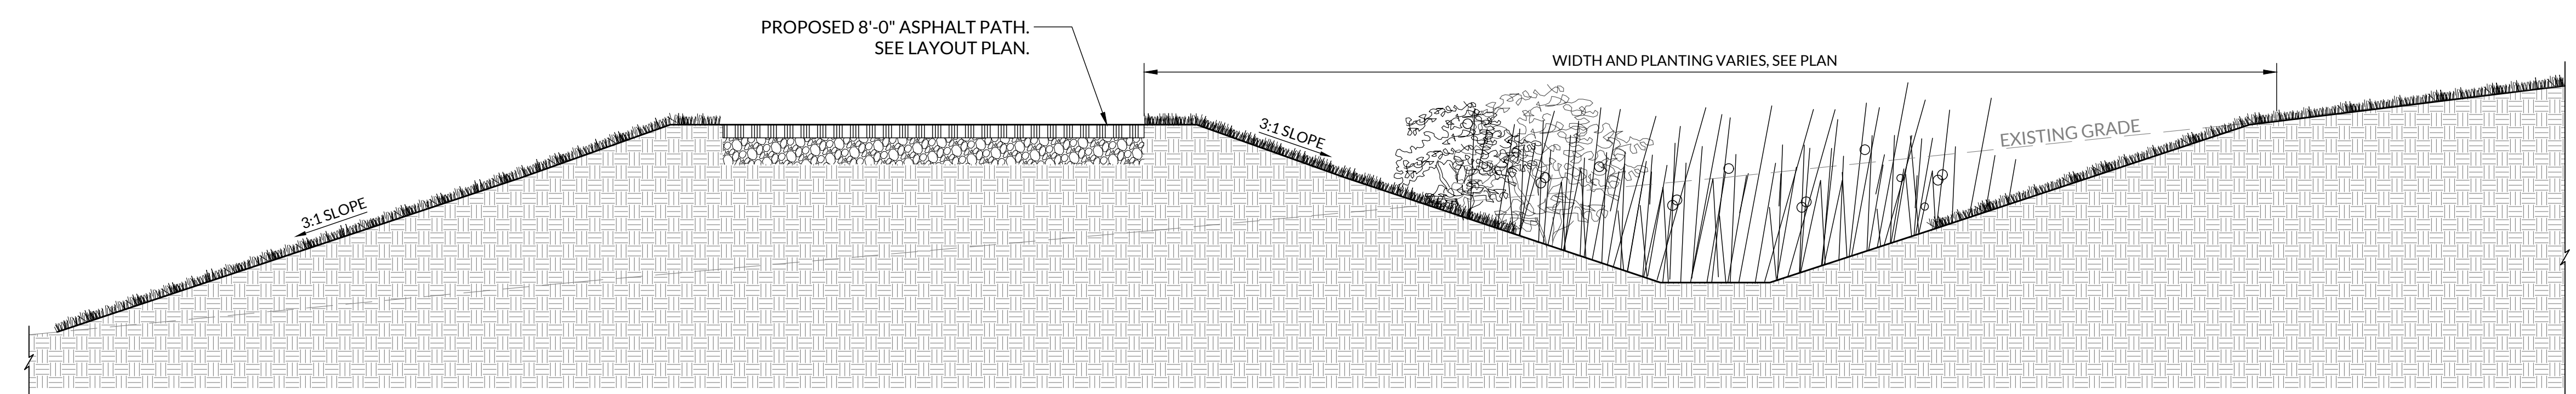
01 STORMWATER BASIN AT PARKING LOT
SCALE: 1" = 2'-0"

SECTION

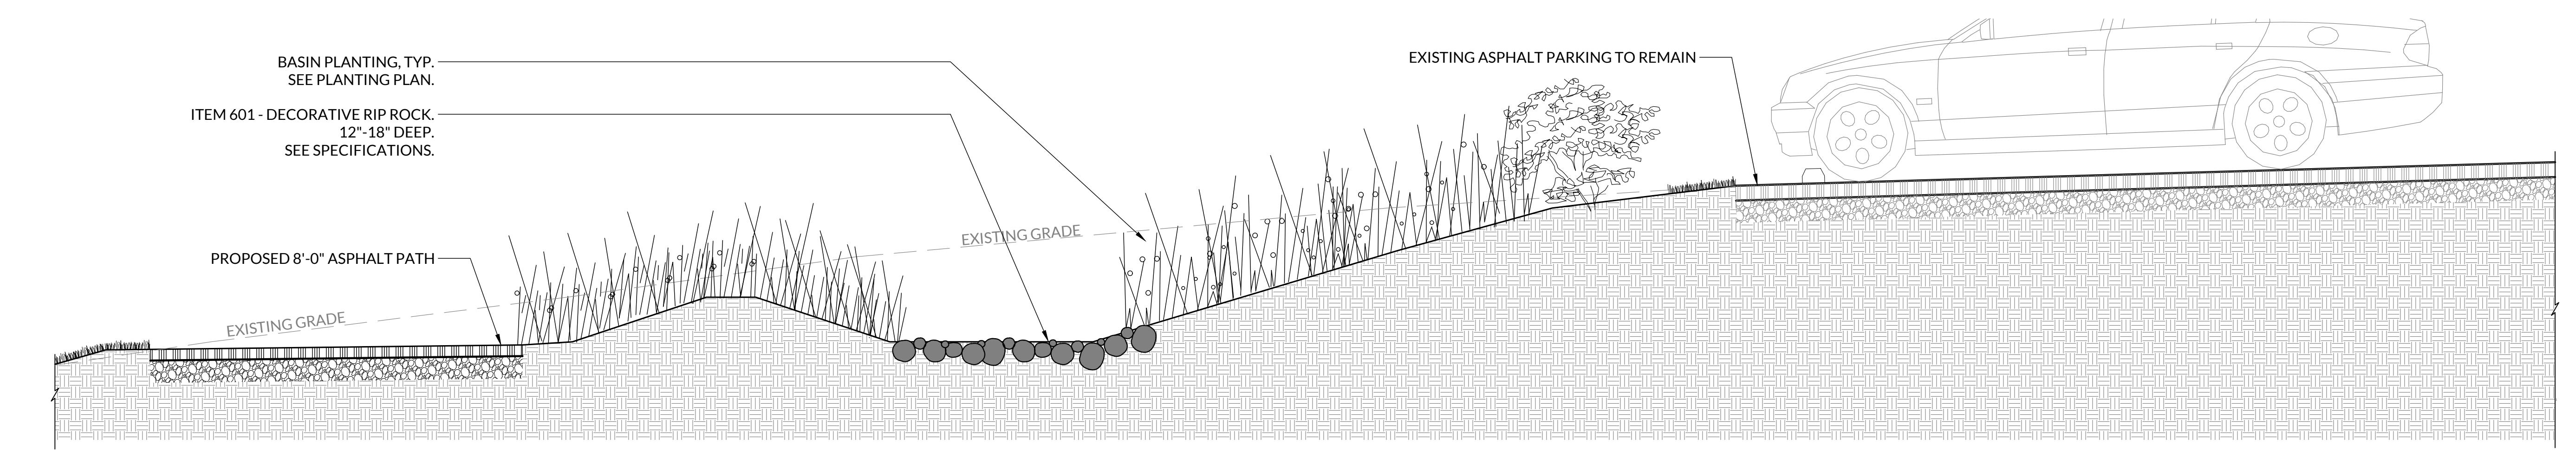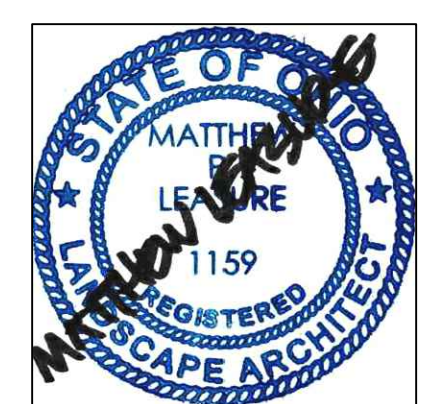

02 ROCK CHANNEL SWALE AT PARKING LOT
SCALE: 1" = 2'-0"


SECTION



03 STORMWATER BASIN, TYP.
SCALE: 1" = 2'-0"


SECTION

- NOTES:
1. CONTRACTOR SHALL ASSURE PERCOLATION OF ALL PLANTING PITS PRIOR TO INSTALLATION.
 2. THE TRUNK FLARE MUST BE VISIBLE. TREES WHERE THE TRUNK FLARE IS NOT VISIBLE SHALL BE REJECTED. DO NOT COVER THE TOP OF THE ROOT BALL WITH SOIL.
 3. FINAL TREE STAKING PLACEMENT TO BE APPROVED BY OWNER.

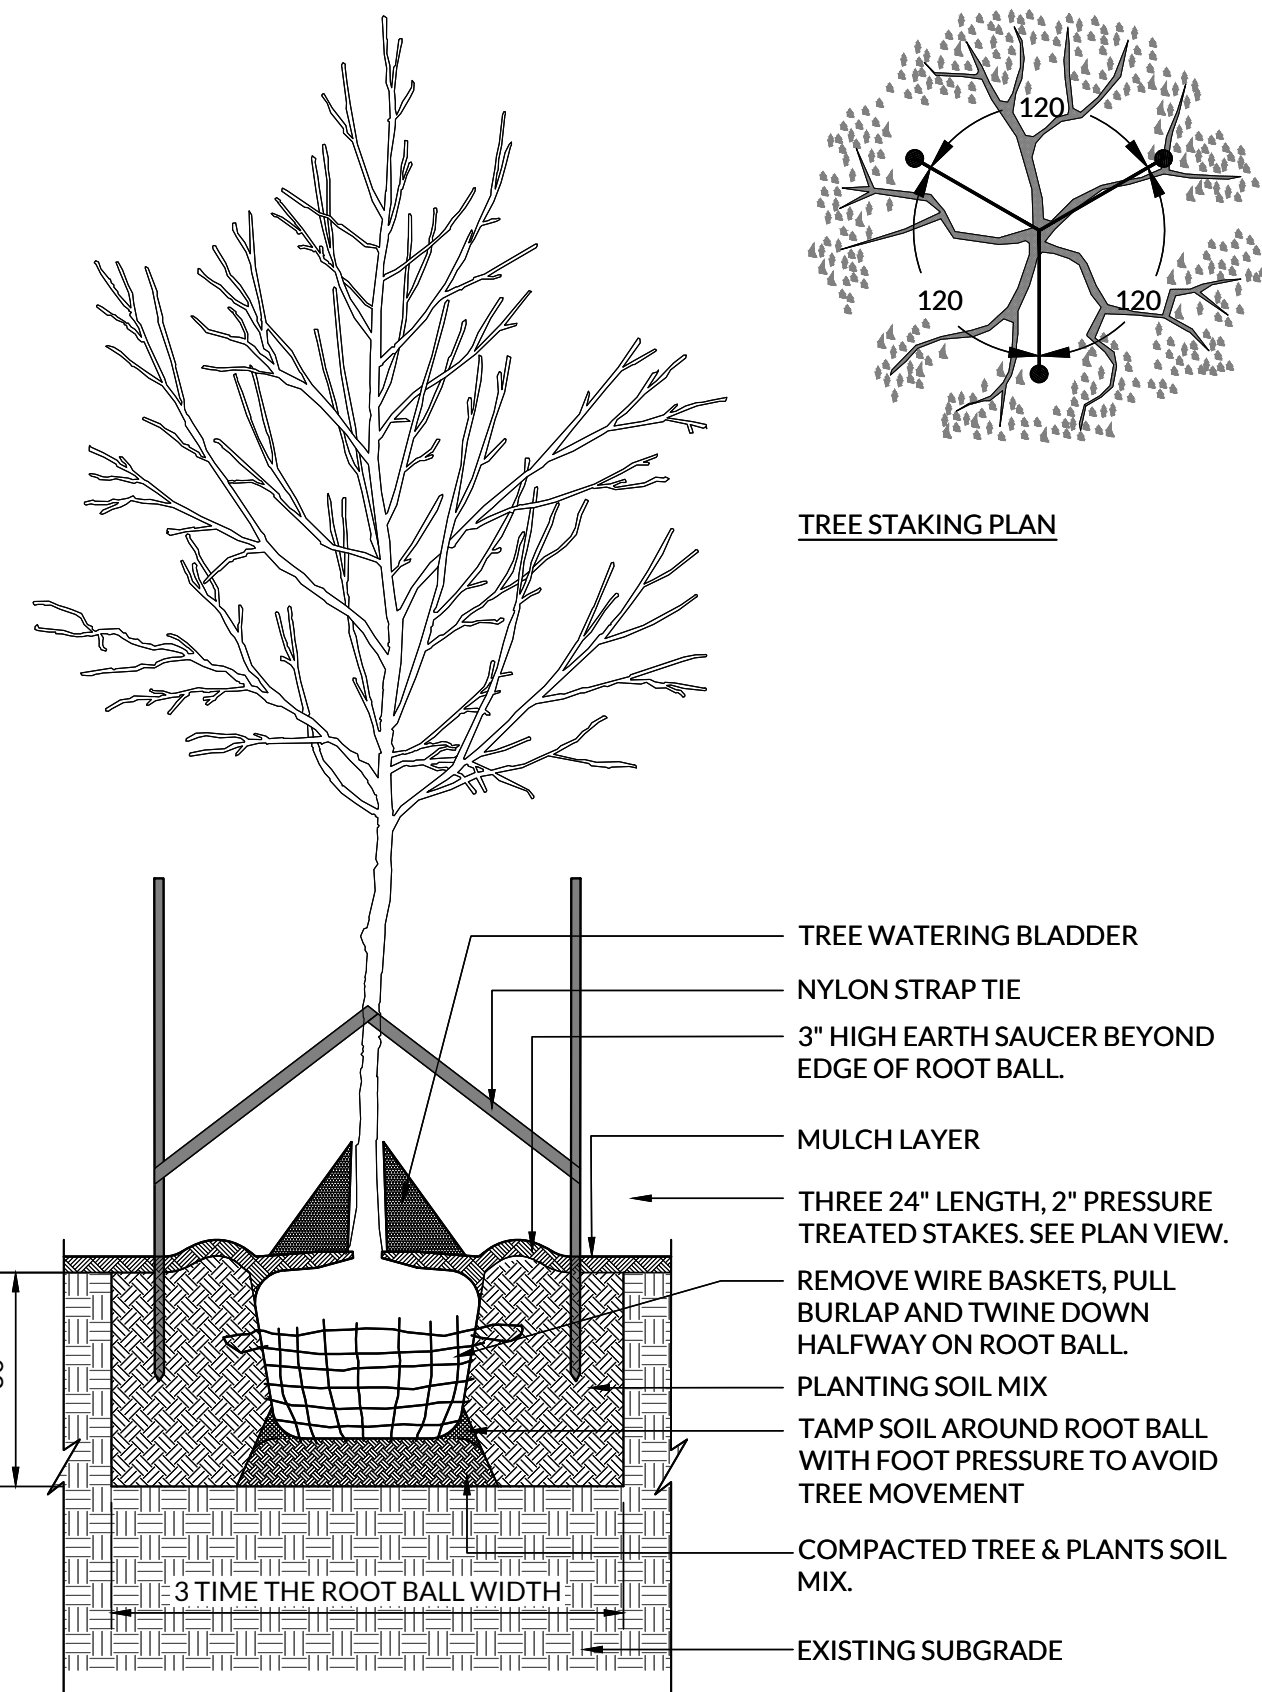


01 TREE PLANTING
NOT TO SCALE

- NOTES:
1. CONTRACTOR SHALL ASSURE PERCOLATION OF ALL PLANTING PITS PRIOR TO INSTALLATION.
 2. THE TRUNK FLARE MUST BE VISIBLE. TREES WHERE THE TRUNK FLARE IS NOT VISIBLE SHALL BE REJECTED. DO NOT COVER THE TOP OF THE ROOT BALL WITH SOIL.
 3. FINAL TREE STAKING PLACEMENT TO BE APPROVED BY OWNER.

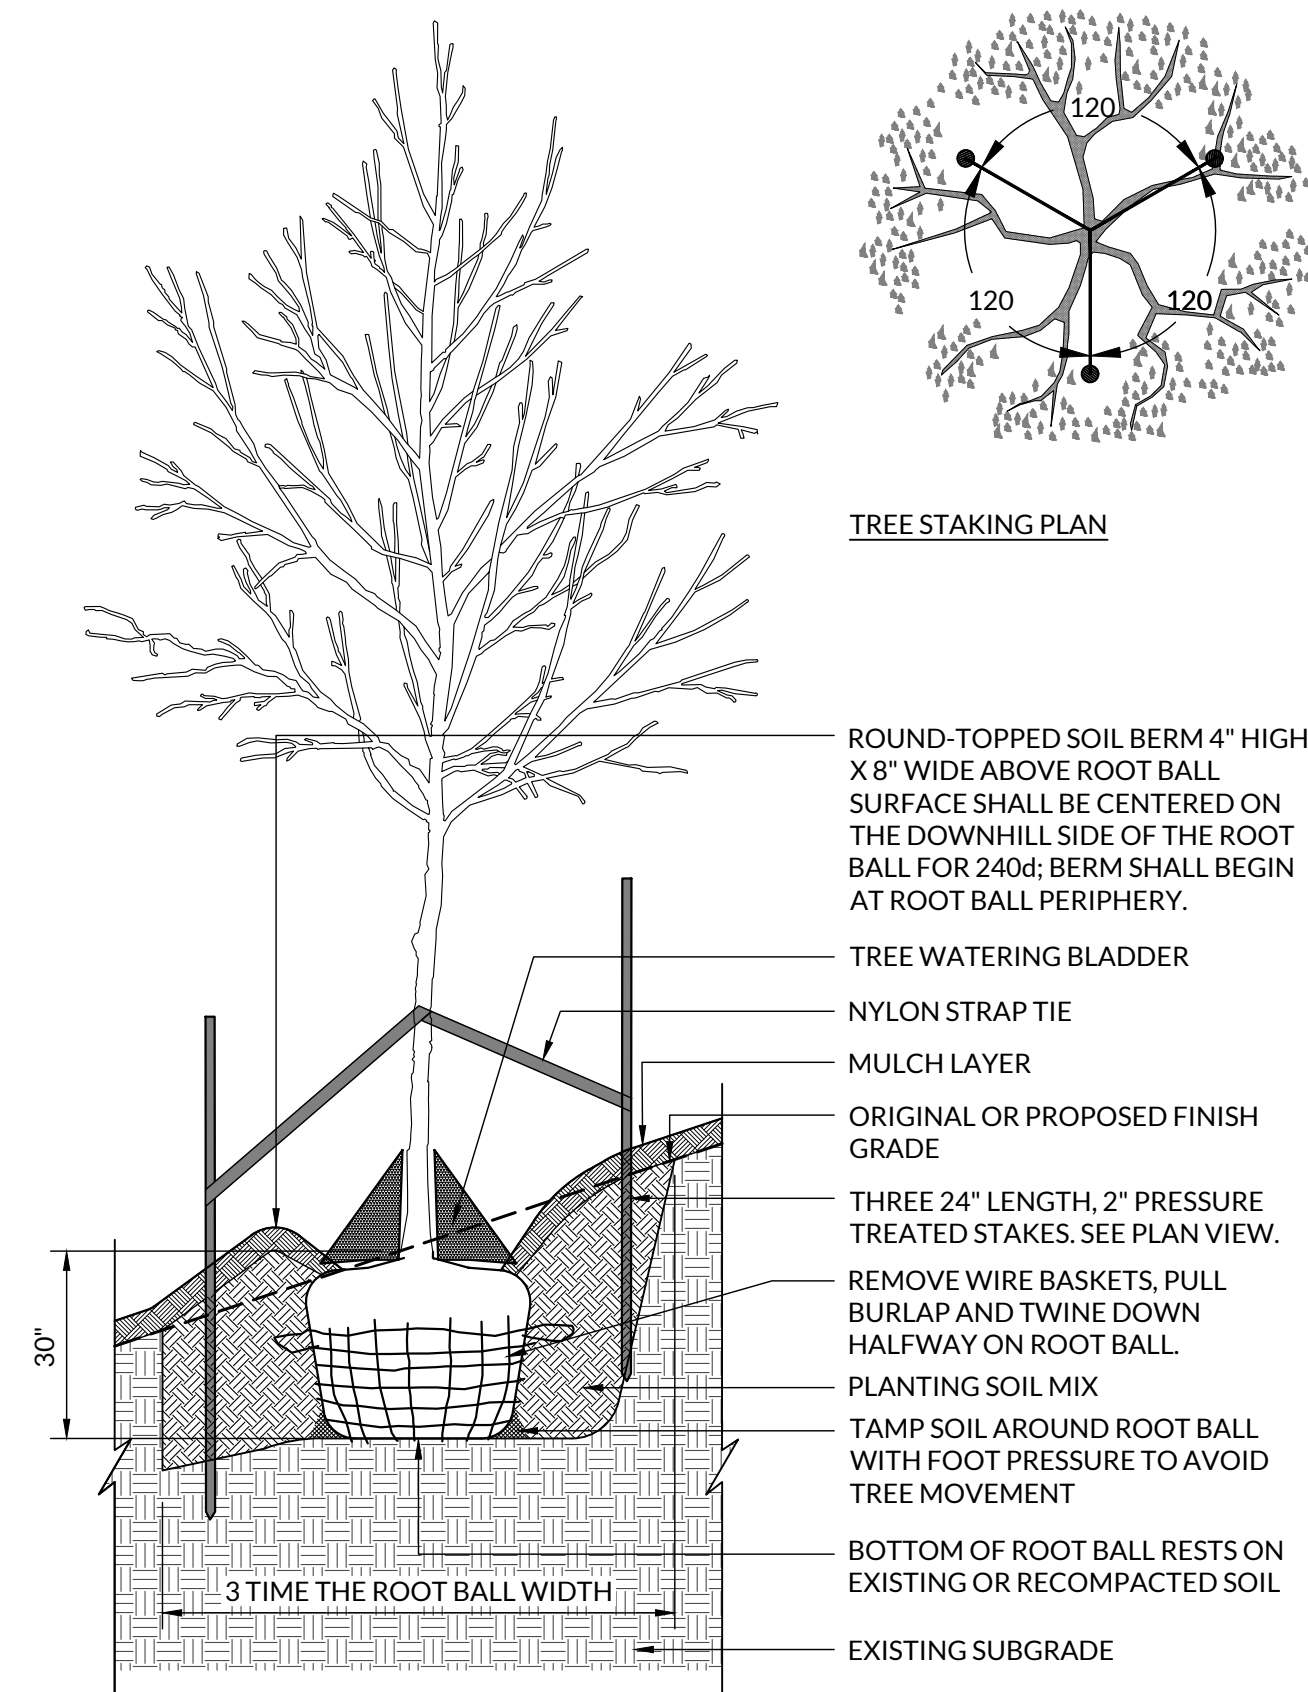


02 TREE PLANTING ON SLOPE OF 5% (1:20) TO 50% (1:2)
NOT TO SCALE

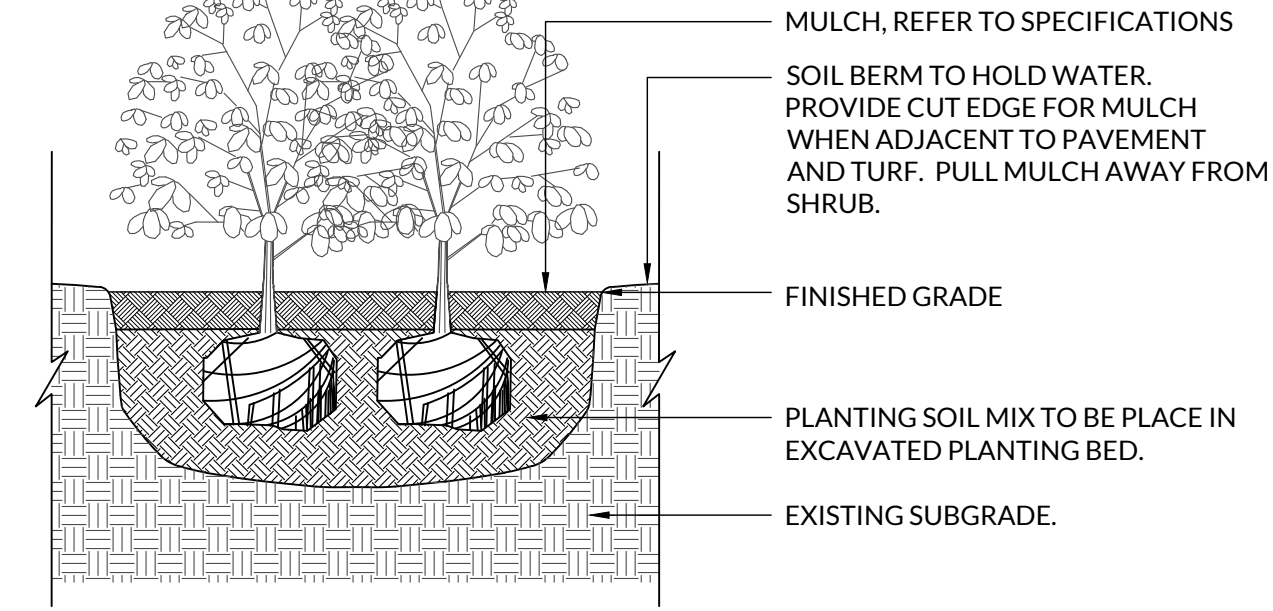


03 SHRUB AND PERENNIAL PLANTING
NOT TO SCALE

- NOTES:
1. ALL ORNAMENTAL GRASS, PERENNIAL, AND GROUNDCOVER MASSES TO USE TRIANGULAR SPACING EXCEPT WHERE NOTED ON PLANS.
 2. TO CREATE THE APPEARANCE OF A CONSISTENT PLANTED EDGE, PLACE PLANTS ALONG BED EDGES FIRST, PARALLEL TO AND UNIFORMLY OFFSET FROM EDGE OF BED.
 3. FILL OUT INTERIOR OF BED ON UNIFORM TRIANGULAR GRID AS SHOWN.

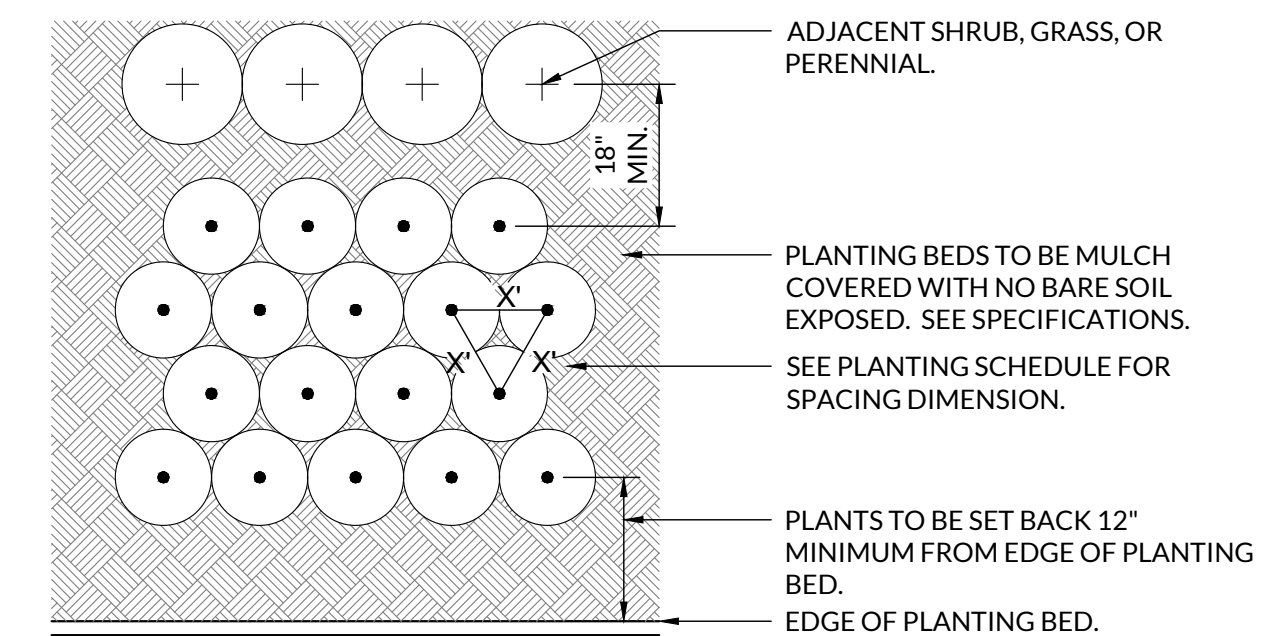


05 PERENNIAL, GRASS, AND GROUNDCOVER SPACING
NOT TO SCALE

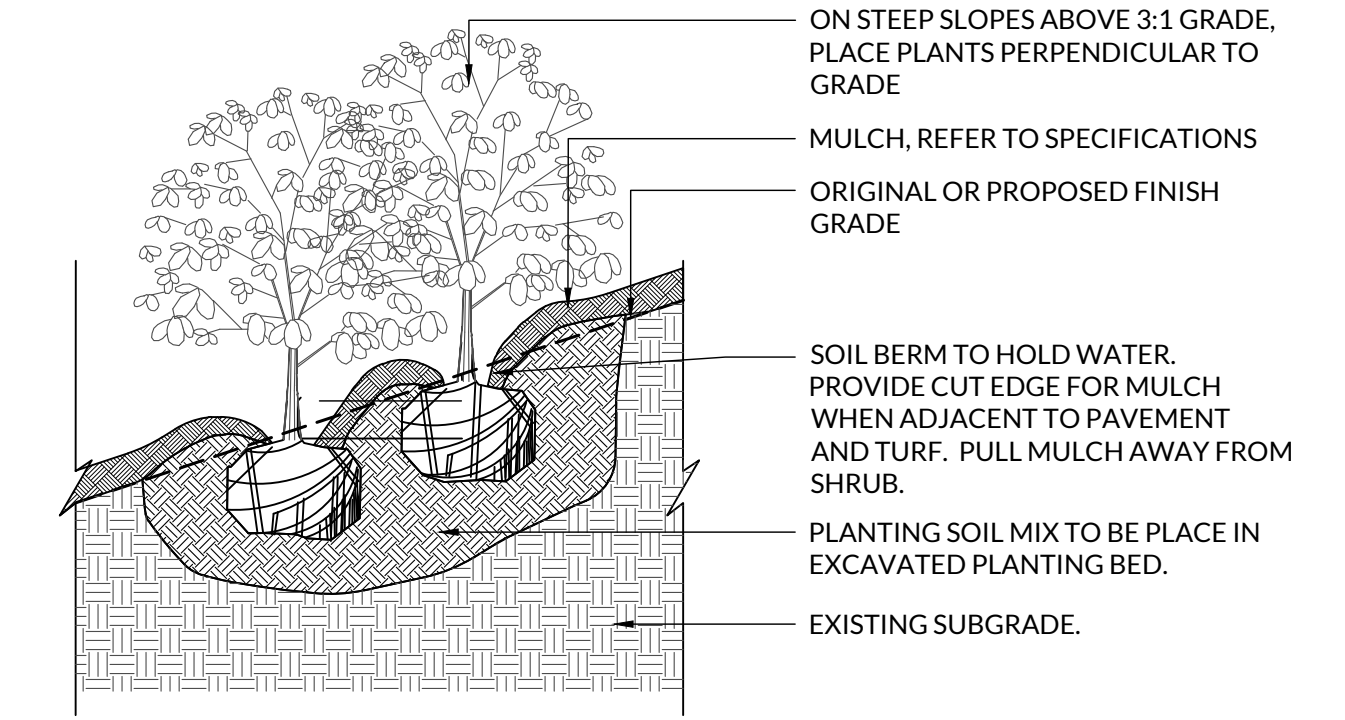


04 SHRUB PLANTING ON SLOPE OF 5% (1:20) TO 50% (1:2)
NOT TO SCALE

- NOTES:
1. ALL ORNAMENTAL GRASS, PERENNIAL, AND GROUNDCOVER MASSES TO USE TRIANGULAR SPACING EXCEPT WHERE NOTED ON PLANS.
 2. TO CREATE THE APPEARANCE OF A CONSISTENT PLANTED EDGE, PLACE PLANTS ALONG BED EDGES FIRST, PARALLEL TO AND UNIFORMLY OFFSET FROM EDGE OF BED.
 3. FILL OUT INTERIOR OF BED ON UNIFORM TRIANGULAR GRID AS SHOWN.

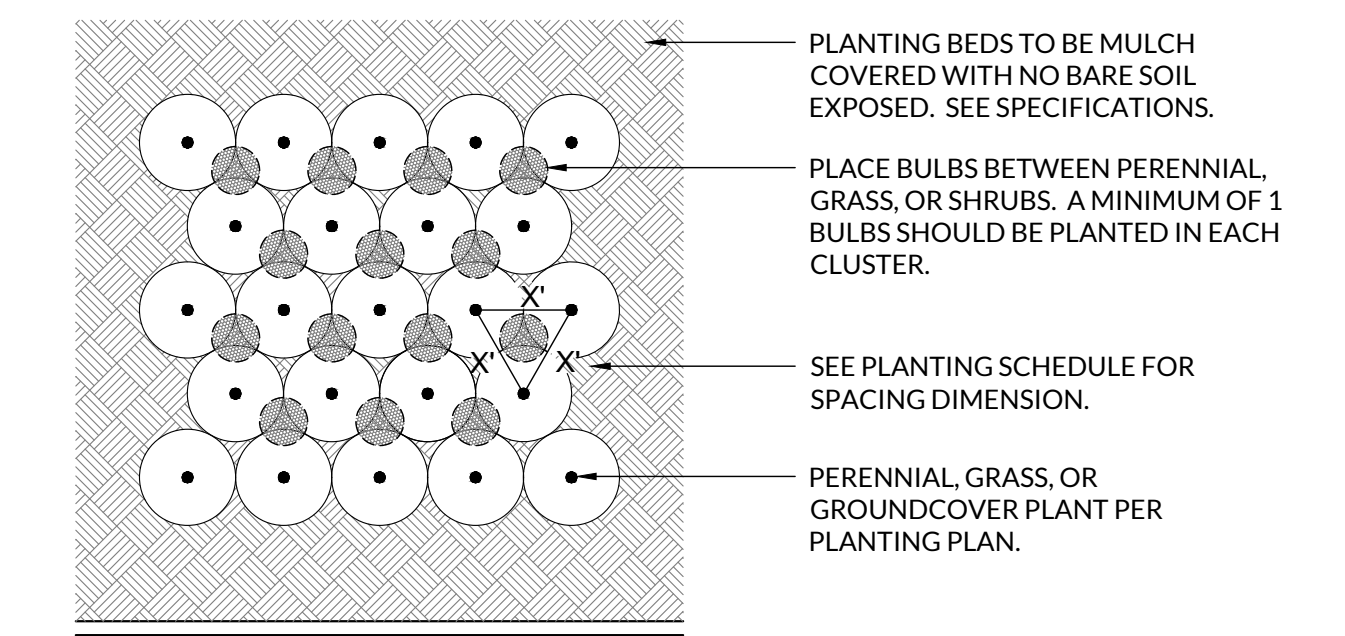


06 INTEGRATED BULB SPACING
NOT TO SCALE

- NOTES:
1. SHAVING ONLY NECESSARY WHEN ROOTS ARE GROWING OUTSIDE THE ROOT BALL.
 2. SHAVING TO BE CONDUCTED USING A SHARP BLADE OR HAND SAW ELIMINATING NO MORE THAN NEEDED TO REMOVE ALL ROOTS ON THE PERIPHERY OF ROOT BALL.
 3. SHAVING CAN BE PERFORMED JUST PRIOR TO PLANTING OR AFTER PLACING IN THE HOLE.

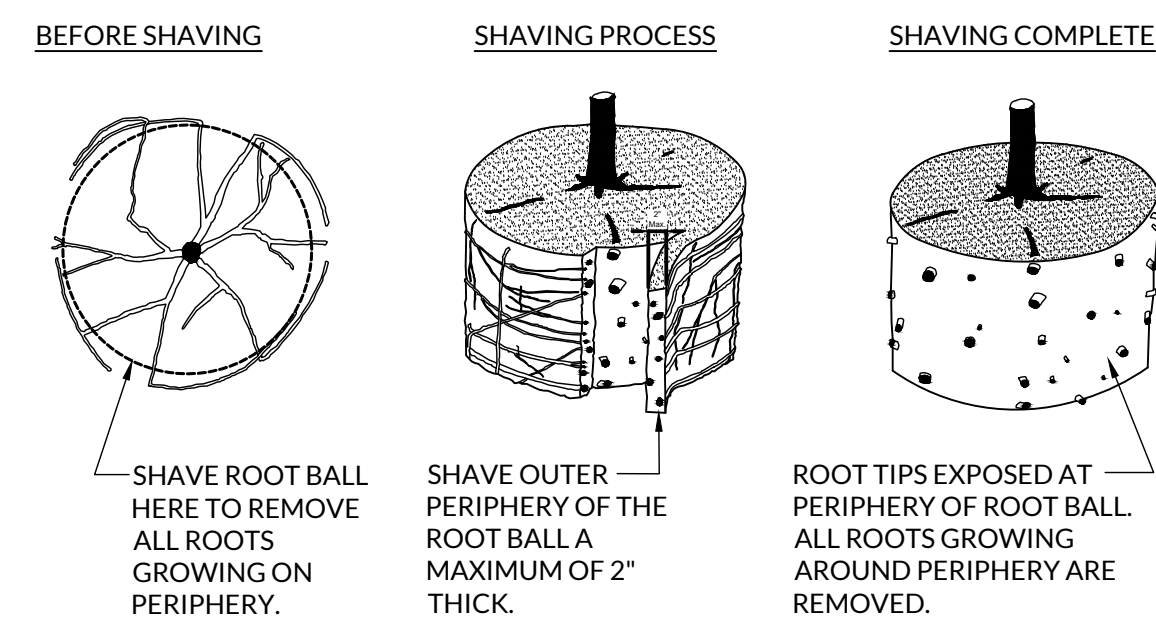

07 ROOT BALL SHAVING CONTAINER DETAIL
NOT TO SCALE

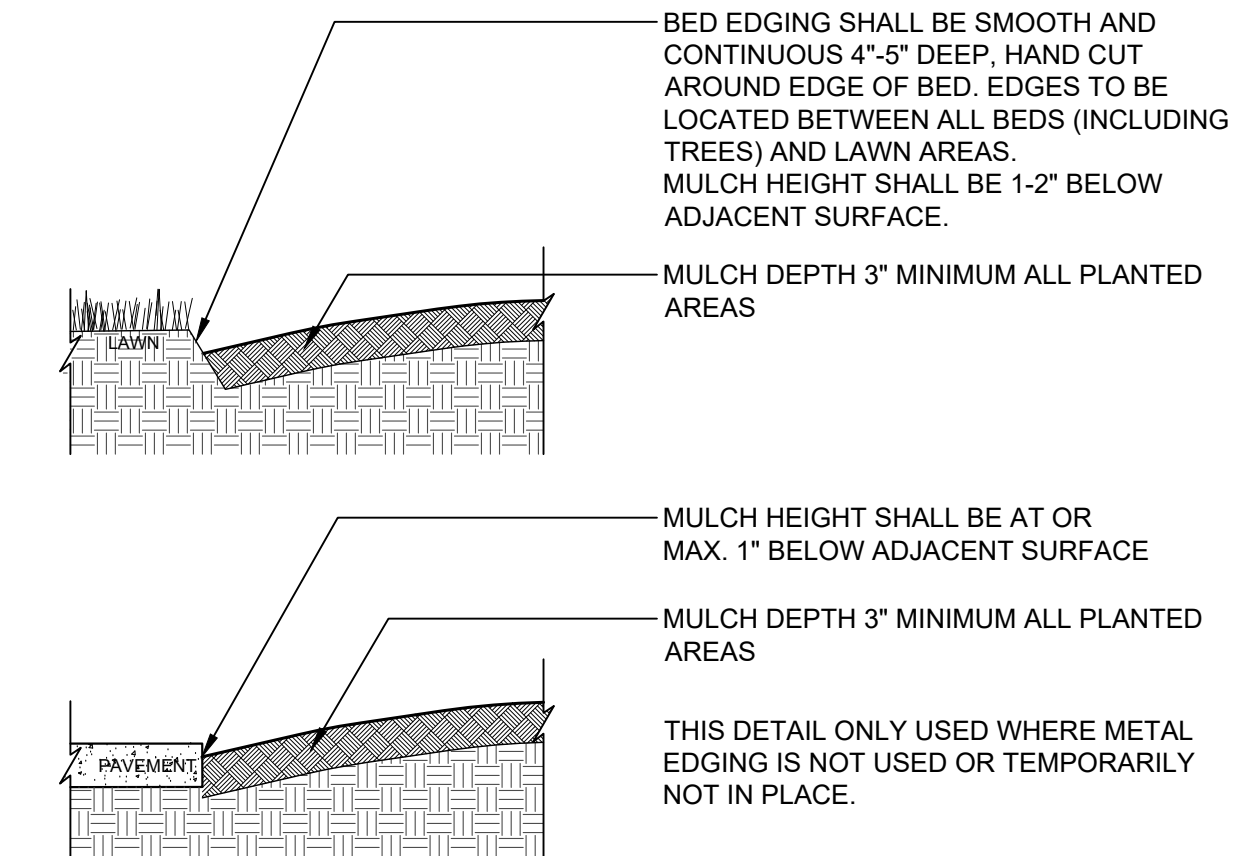

08 PLANTER BED EDGING
NOT TO SCALE


DECIDUOUS TREES



BRANDYWINE MAPLE



AUTUMN BRILLIANCE SERVICEBERRY

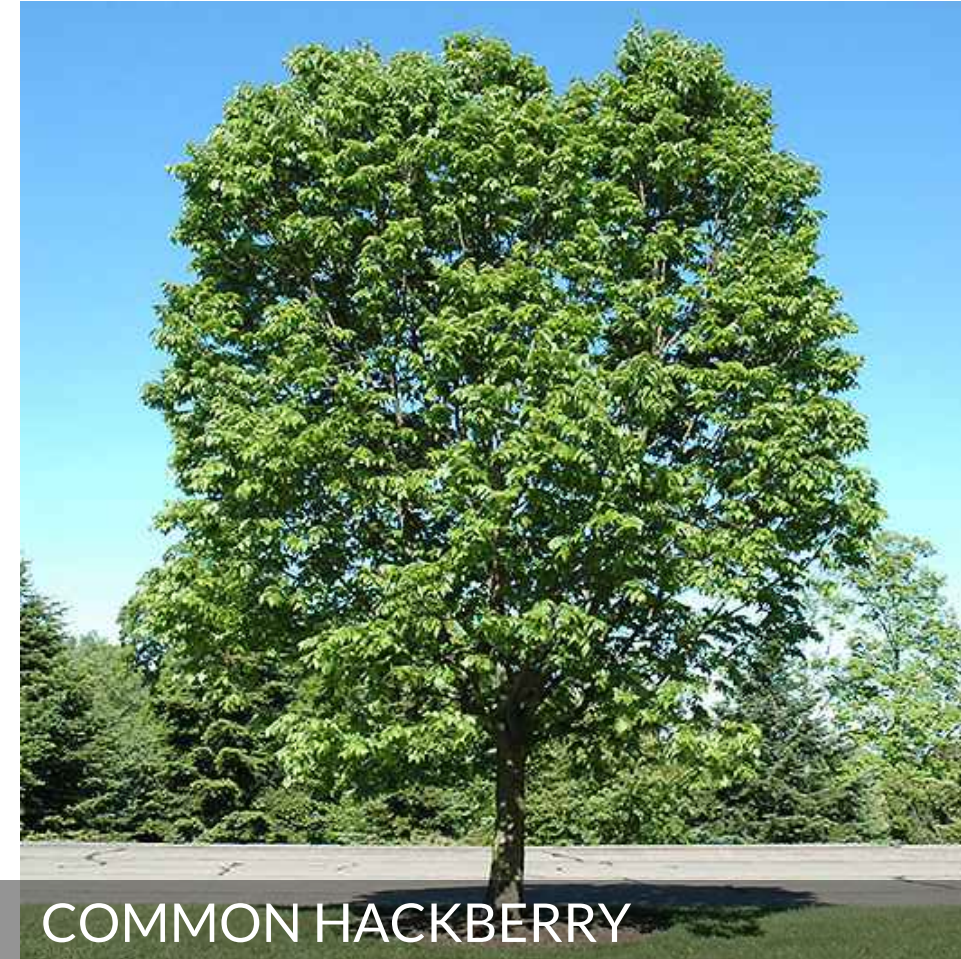

COMMON HACKBERRY



WILDFIRE BLACKGUM



SHUMARD OAK



SWAMP WHITE OAK

SHRUBS



HUMMINGBIRD SUMMERSWEET



GRO LOW FRAGRANT SUMAC

ORNAMENTAL GRASSES



OVERDAM FEATHER REED GRASS



PENNSYLVANIA SEDGE



PURPLE LOVEGRASS



INDIANGRASS



PRAIRIE DROPSEED

01 LANDSCAPE PLANTS

DESIGNING LOCAL
LANDSCAPE ARCHITECTURE


1223 EAST MAIN ST., SUITE 311
COLUMBUS, OH 43205
614.893.7178



SHEET NUMBER
L701

SHEET TITLE
**PHASE 1 CABIN CONSTRUCTION
MATERIALS SELECTION**


PROJECT ADDRESS
DUBLIN ARTS CENTER
700 East Main Street
Columbus, OH 43216

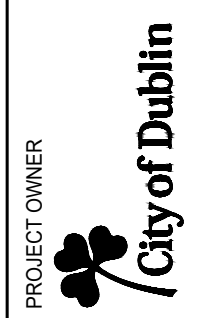


PROJECT OWNER
CITY OF DUBLIN
PARKS & RECREATION
5555 Penmar Drive
Dublin, Ohio 43017

**DUBLIN ARTS CENTER
GROUNDS IMPROVEMENTS**

ISSUE DATE
APRIL 6, 2022
CITY OF DUBLIN MINOR
PROJECT REVIEW

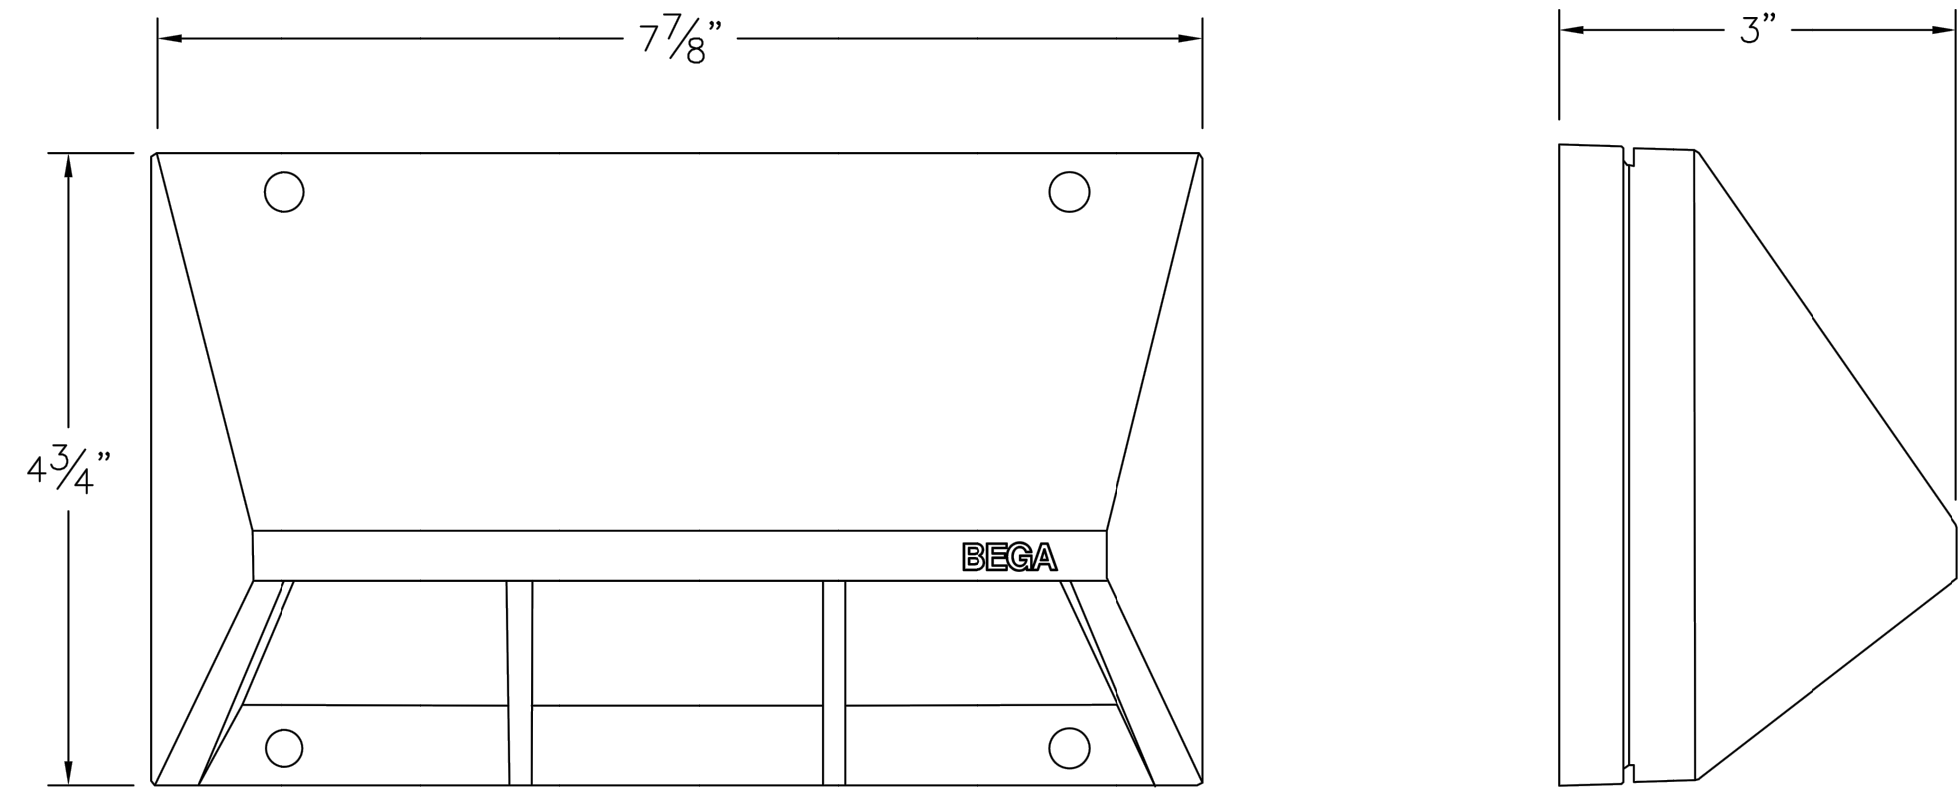

MOUNTING DETAIL

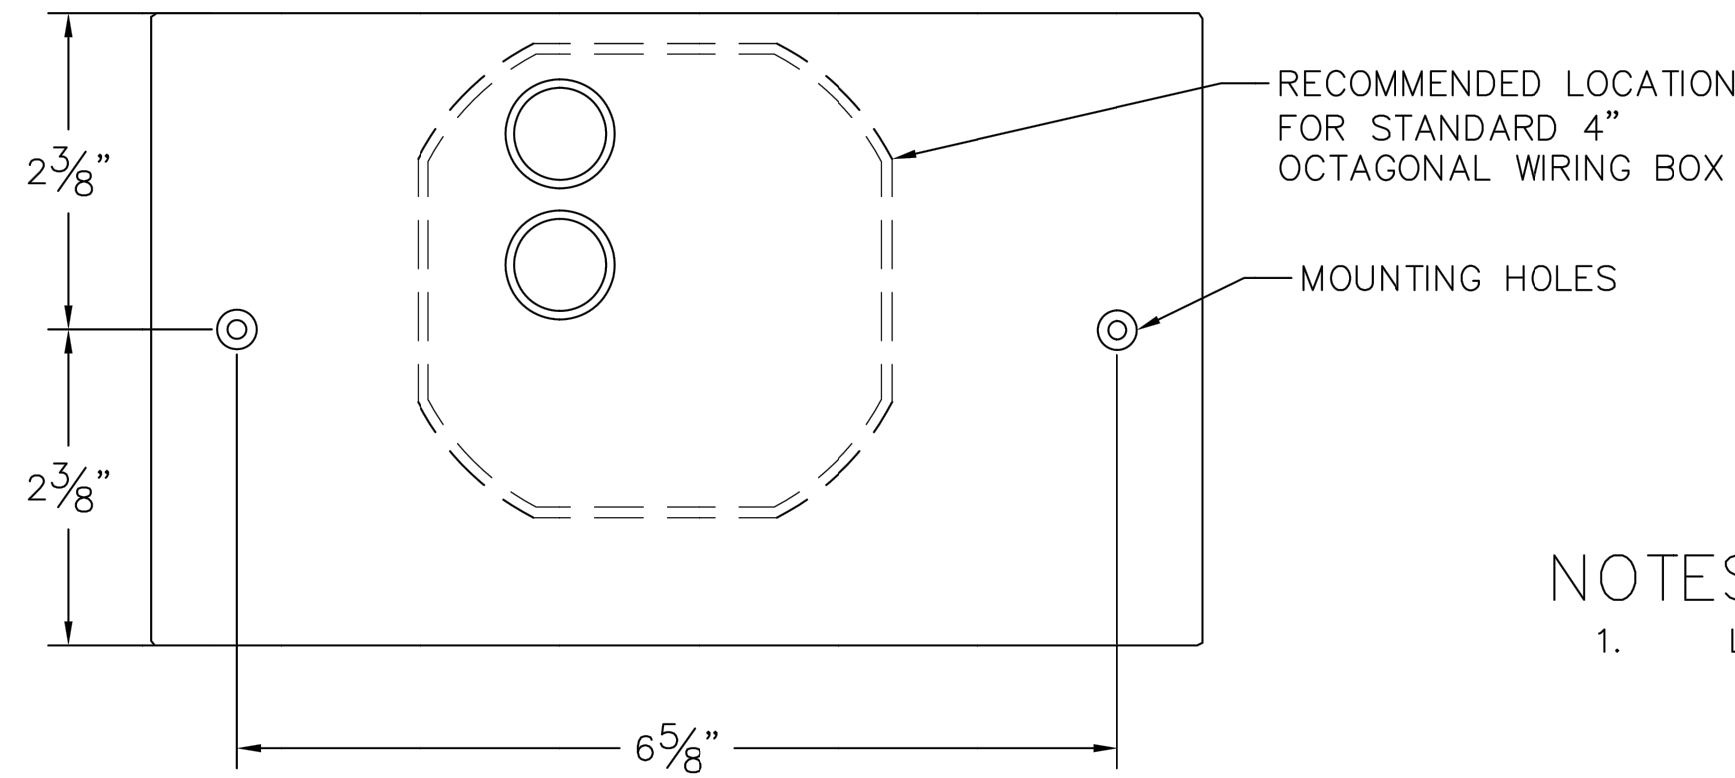

- NOTES:
- LUMINAIRE 22 172 – SEE SPECIFICATIONS



01 LIGHTING SPECIFICATION

TYPE:

SUBMITTAL APPROVAL

CAT NO: 22 172		PROJECT: -		DATE: -	
APPROVED BY: -		LOCATION: -		DRAWN: HA	
SIGNED: -		DATE: -		DATE: 3/22/2016	
REV.	DATE	DESCRIPTION	FILE NAME	22172.DXF	

1000 Bega Way
Carpinteria, Ca. 93013
(805) 684-0533

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BEGA

LED wall luminaire - location light

Application
This luminaire can be utilized at lower mounting heights to illuminate pathways for safety and egress purposes.

Materials
Luminaire housing and guard constructed of die-cast marine grade, copper free (≤0.3% copper content) A360.0 aluminum alloy
Matte safety glass
High temperature silicone gasket
Mechanically captive stainless steel fasteners

NRTL listed to North American Standards, suitable for wet locations
Protection class IP65
Weight: 2.1 lbs


Electrical
Operating voltage 120-277V AC
Minimum start temperature -30° C
LED module wattage 2.0W
System wattage 4.0W
Controllability 0-10V dimmable
Color rendering index Ra > 80
Luminaire lumens 160 lumens (3000K)
Lifetime at Ta = 15° C >500,000 h (L70)
Lifetime at Ta = 55° C 168,000 h (L70)

LED color temperature
 4000K - Product number + **K4**
 3500K - Product number + **K35**
 3000K - Product number + **K3**
 2700K - Product number + **K27**

BEGA can supply you with suitable LED replacement modules for up to 20 years after the purchase of LED luminaires - see website for details

Finish
All BEGA standard finishes are matte, textured polyester powder coat with minimum 3 mil thickness.

Available colors Black (BLK) White (WHT) RAL:
 Bronze (BRZ) Silver (SLV) CUS:

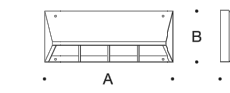

LED wall luminaire - location light		A	B	C
22 172	2.0W	7 7/8"	4 3/4"	3"

BEGA 1000 Bega Way, Carpinteria, CA 93013 (805) 684-0533 info@bega-us.com
Due to the dynamic nature of lighting products and the associated technologies, luminaire data on this sheet is subject to change at the discretion of BEGA North America. For the most current technical data, please refer to bega-us.com
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Type: WALL LIGHT
BEGA Product: 22 172
Project: DUBLIN ARTS CENTER
Modified:

BEGA

DESIGNING LOCAL
LANDSCAPE ARCHITECTURE

1223 EAST MAIN ST., SUITE 311
COLUMBUS, OH 43205
614.893.7178



SHEET NUMBER
L702

SHEET TITLE
PHASE 1 CABIN CONSTRUCTION
MATERIALS SELECTION

PROJECT ADDRESS
DUBLIN ARTS CENTER
700 East Main Street
Columbus, OH 43216

PROJECT OWNER
City of Dublin

CITY OF DUBLIN
PARKS & RECREATION
5555 Penmar Drive
Dublin, Ohio 43017


DUBLIN ARTS CENTER
GROUNDS IMPROVEMENTS

ISSUE DATE
APRIL 6, 2022
CITY OF DUBLIN MINOR
PROJECT REVIEW

BEGA

Photometric Filename: 22172.IES

TEST: BE_22172
 TEST LAB: BEGA
 DATE: 6/8/2016
 LUMINAIRE: 22 172
 LAMP: 2.0W LED

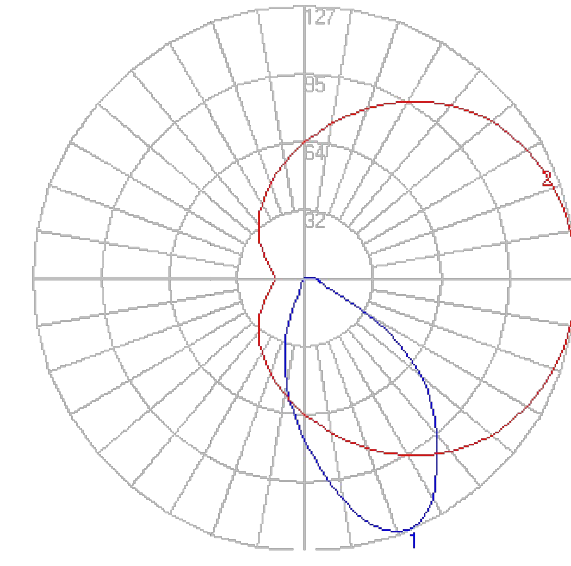


Characteristics

IES Classification	Type II
Longitudinal Classification	Very Short
Lumens Per Lamp	N.A. (absolute)
Total Lamp Lumens	N.A. (absolute)
Luminaire Lumens	160
Downward Total Efficiency	N.A.
Total Luminaire Efficiency	N.A.
Luminaire Efficacy Rating (LER)	40
Total Luminaire Watts	4
Ballast Factor	1.00
Upward Waste Light Ratio	0.01
Max. Cd.	127 (0H, 22.5V)
Max. Cd. (<90 Vert.)	127 (0H, 22.5V)
Max. Cd. (At 90 Deg. Vert.)	5.2 (3.3%Lum)
Max. Cd. (80 to <90 Deg. Vert.)	6.8 (4.3%Lum)
Cutoff Classification (deprecated)	N.A. (absolute)



Lum. Classification System (LCS)

LCS Zone	Lumens	%Lamp	%Lum
FL (0-30)	42.0	N.A.	26.2
FM (30-60)	74.5	N.A.	46.5
FH (60-80)	14.9	N.A.	9.3
FVH(80-90)	2.1	N.A.	1.3
BL (0-30)	16.1	N.A.	10.1
BM (30-60)	8.4	N.A.	5.2
BH (60-80)	0.4	N.A.	0.3
BVH(80-90)	< 0.05	N.A.	0.0
UL (90-100)	1.1	N.A.	0.7
UH (100-180)	0.5	N.A.	0.3
Total	160.0	N.A.	100.0

BUG Rating B0-U1-G0

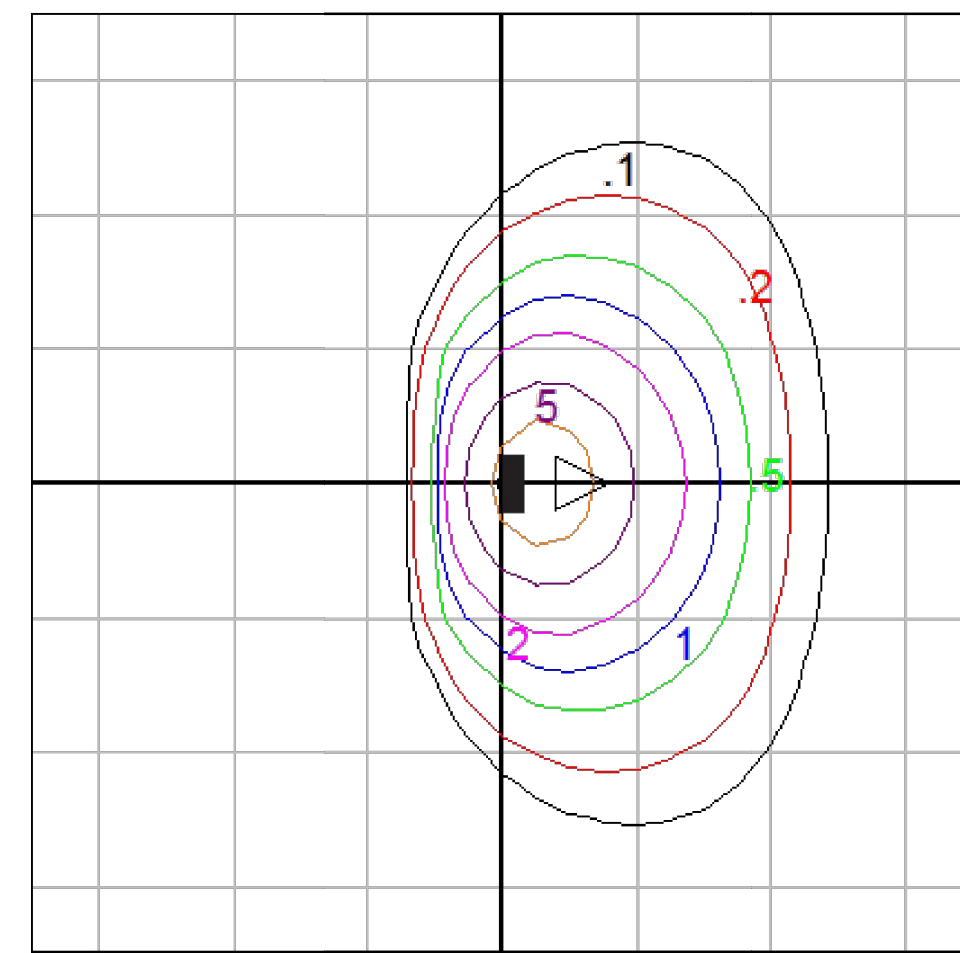

Mounting Height = 2.5 ft. Grid Spacing = 2.5 ft.

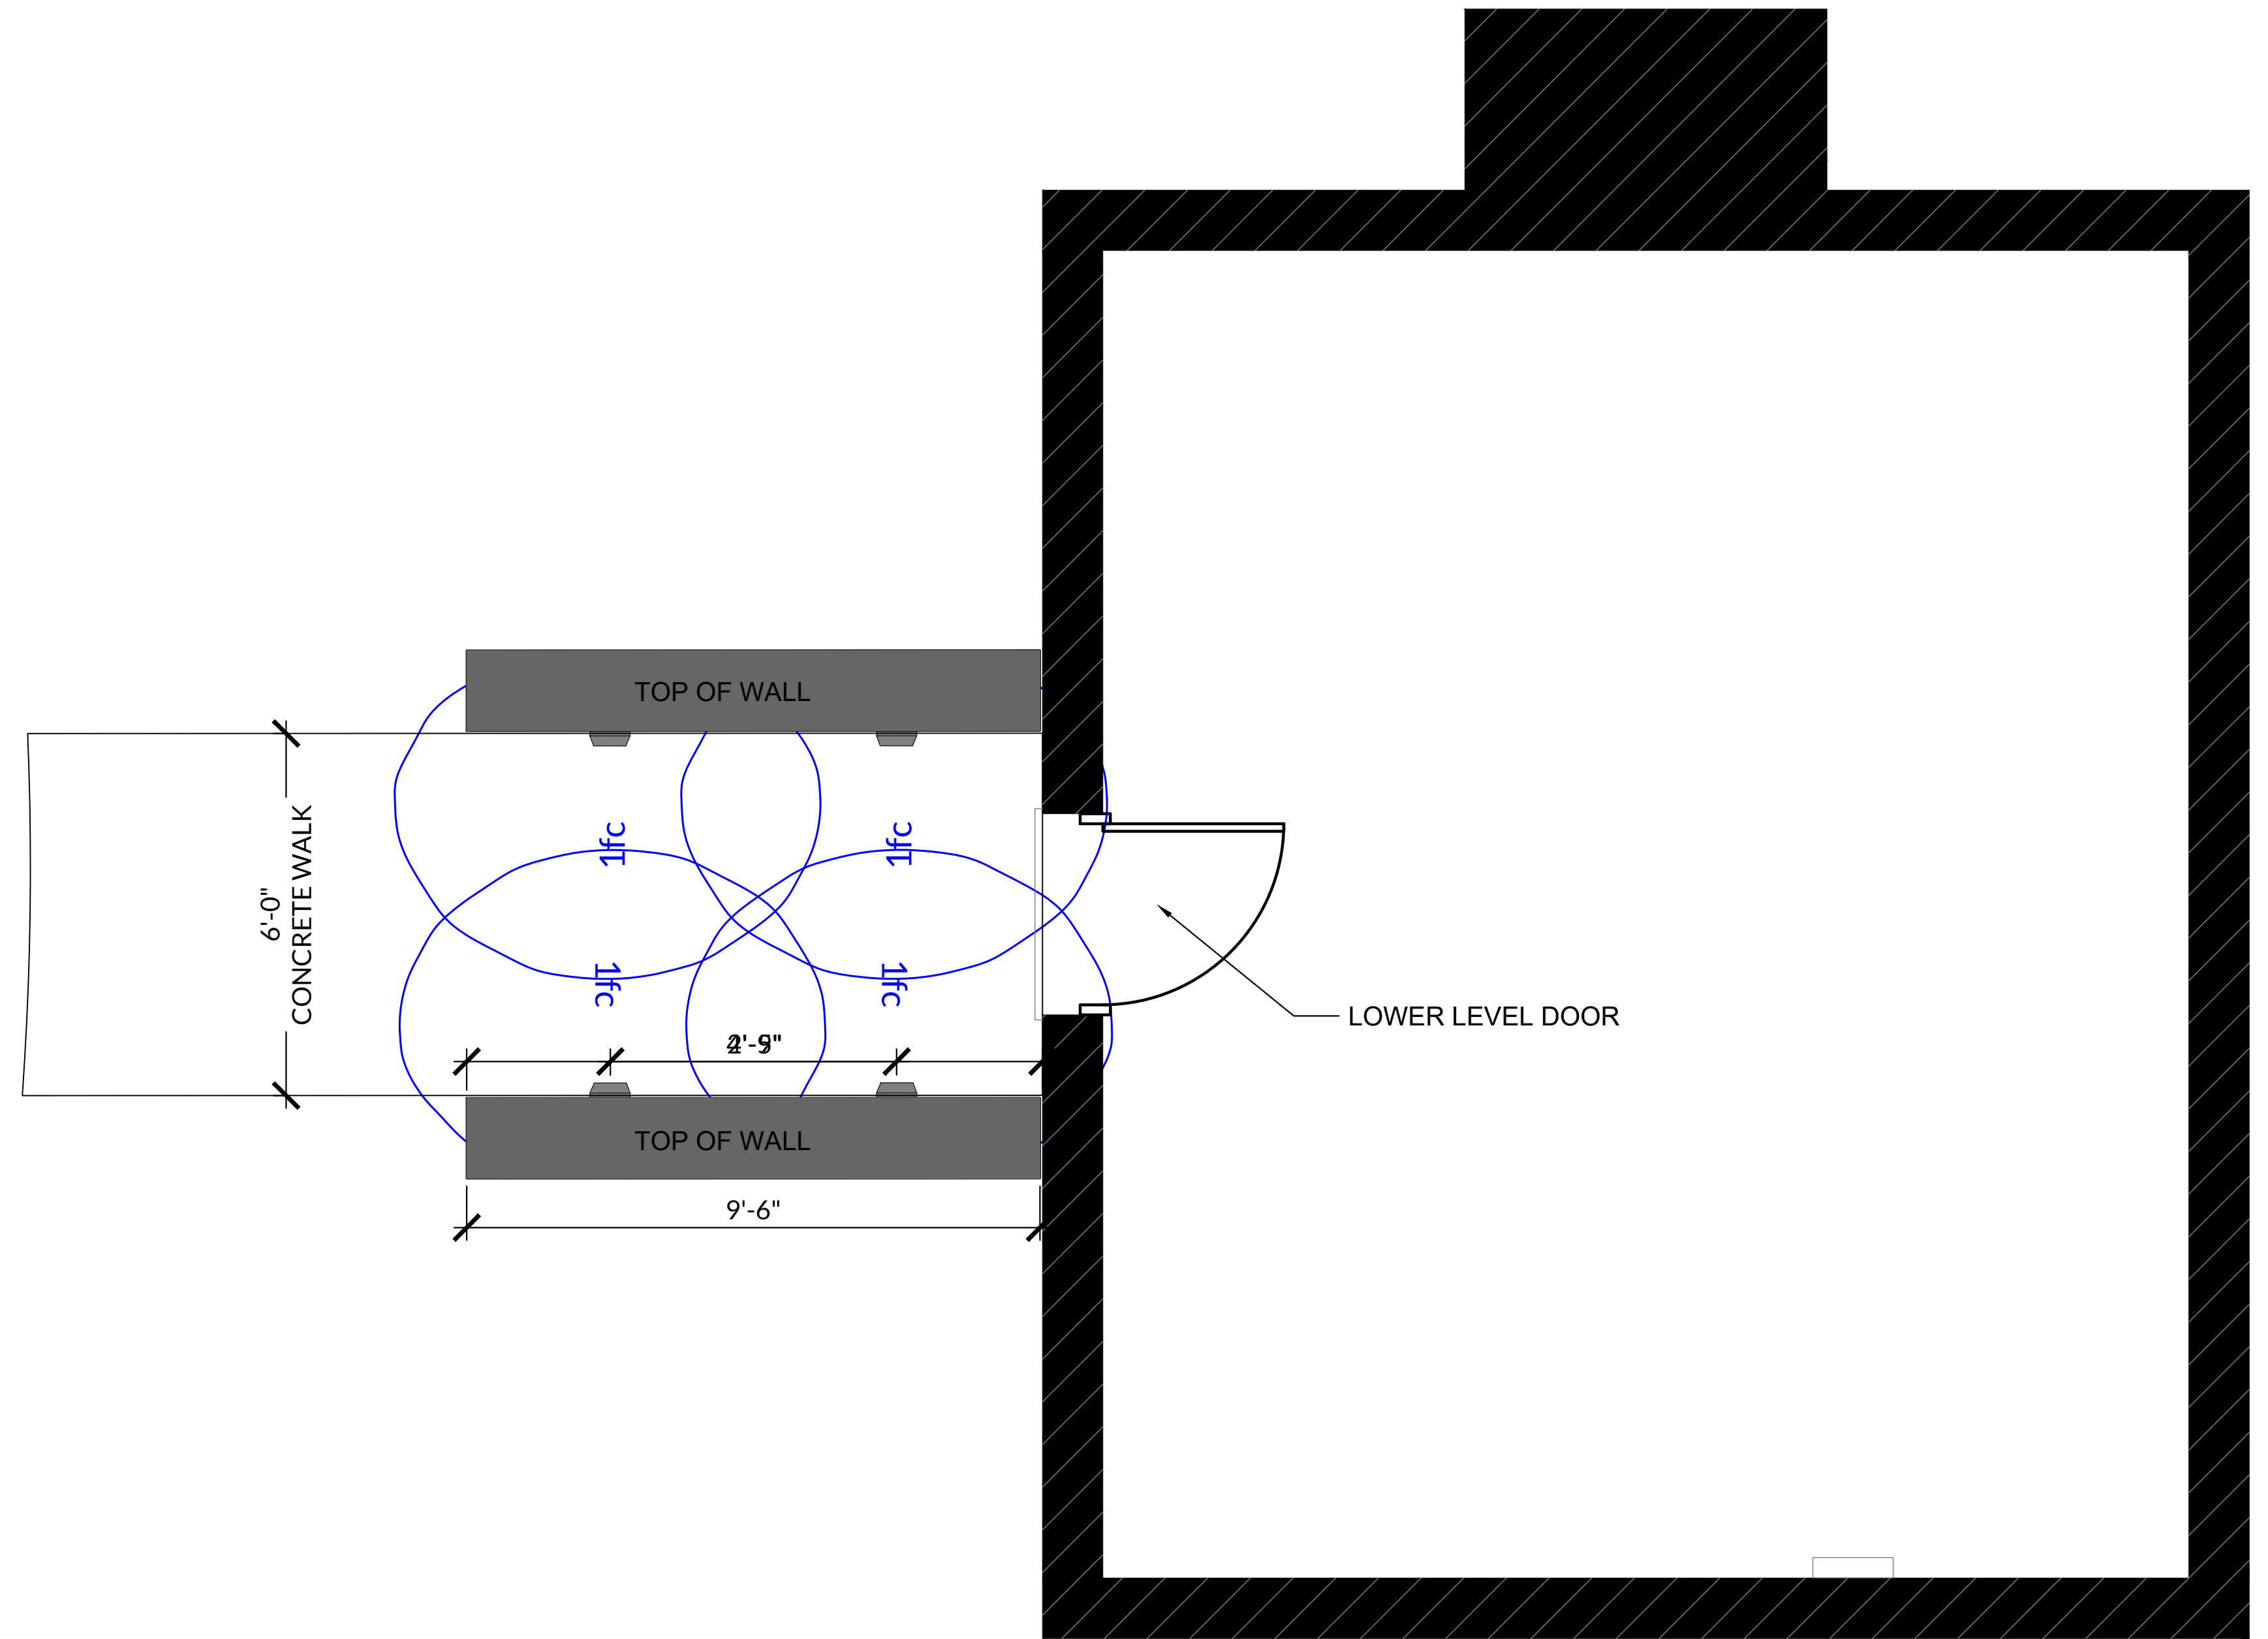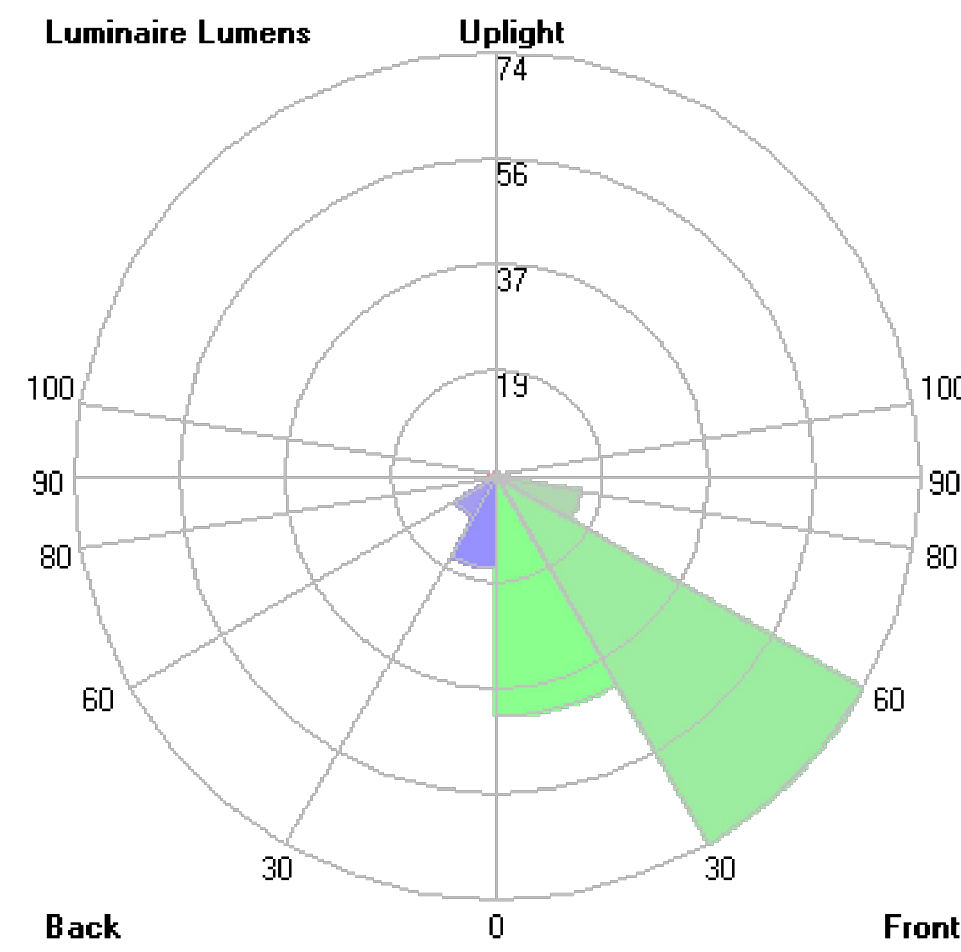

In the interest of product improvement, BEGA reserves the right to make technical changes without notice.
 BEGA 1000 Bega Way, Carpinteria, CA 93013 (805)684-0533 Fax (805)566-9474 www.bega-us.com © Copyright BEGA-US 2018 8/14/2018



STONE WALL VENEER



WING WALL AT CABIN LOWER LEVEL ENTRY TO MATCH STYLE AND PATTERN OF CABIN STONE. SEE ARCHITECTURAL PLANS.

STONE WALL CAP STONE



WING WALL CAP STONE TO MATCH EXISTING CAP STONE AS FOUND ON SITE. STONE SHALL BE BUFF LIMESTONE, SAWN ALL FACES. BASIS OF DESIGN LANG STONE INDIANA BUFF

DECORATIVE RIP RAP



DECORATIVE RIP RAP SHALL BE CLEAN WASHED, ROUNDED RIVER STONE 3"-6". BASIS OF DESIGN LANG STONE DARBY.

01 STONE

DESIGNING LOCAL
LANDSCAPE ARCHITECTURE

1223 EAST MAIN ST., SUITE 311
COLUMBUS, OH 43205
614.893.7178



SHEET NUMBER
L704

SHEET TITLE
**PHASE 1 CABIN CONSTRUCTION
MATERIALS SELECTION**

PROJECT ADDRESS
DUBLIN ARTS CENTER
7000 Main Street
Columbus, OH 43216



PROJECT OWNER
City of Dublin

CITY OF DUBLIN
PARKS & RECREATION
5555 Penmar Drive
Dublin, Ohio 43017

**DUBLIN ARTS CENTER
GROUNDS IMPROVEMENTS**

ISSUE DATE
APRIL 8, 2022
CITY OF DUBLIN MINOR
PROJECT REVIEW

Drawing name: K:\CIB_LIVE\19094000_Designing Local Dublin Arts Center\2_Design\CAD\Plan\Sheet\DRAINAGE & UTILITY PLAN.dwg Layout: Mar 10, 2022 4:25pm by: Anthony Wong
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No.	DATE	BY	APR DATE

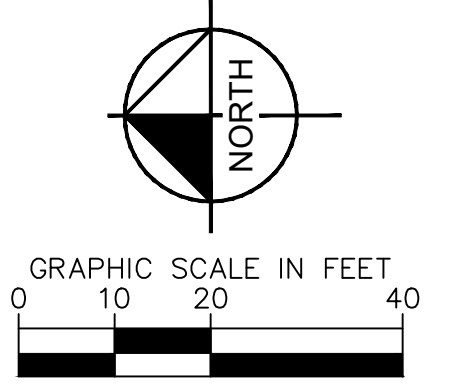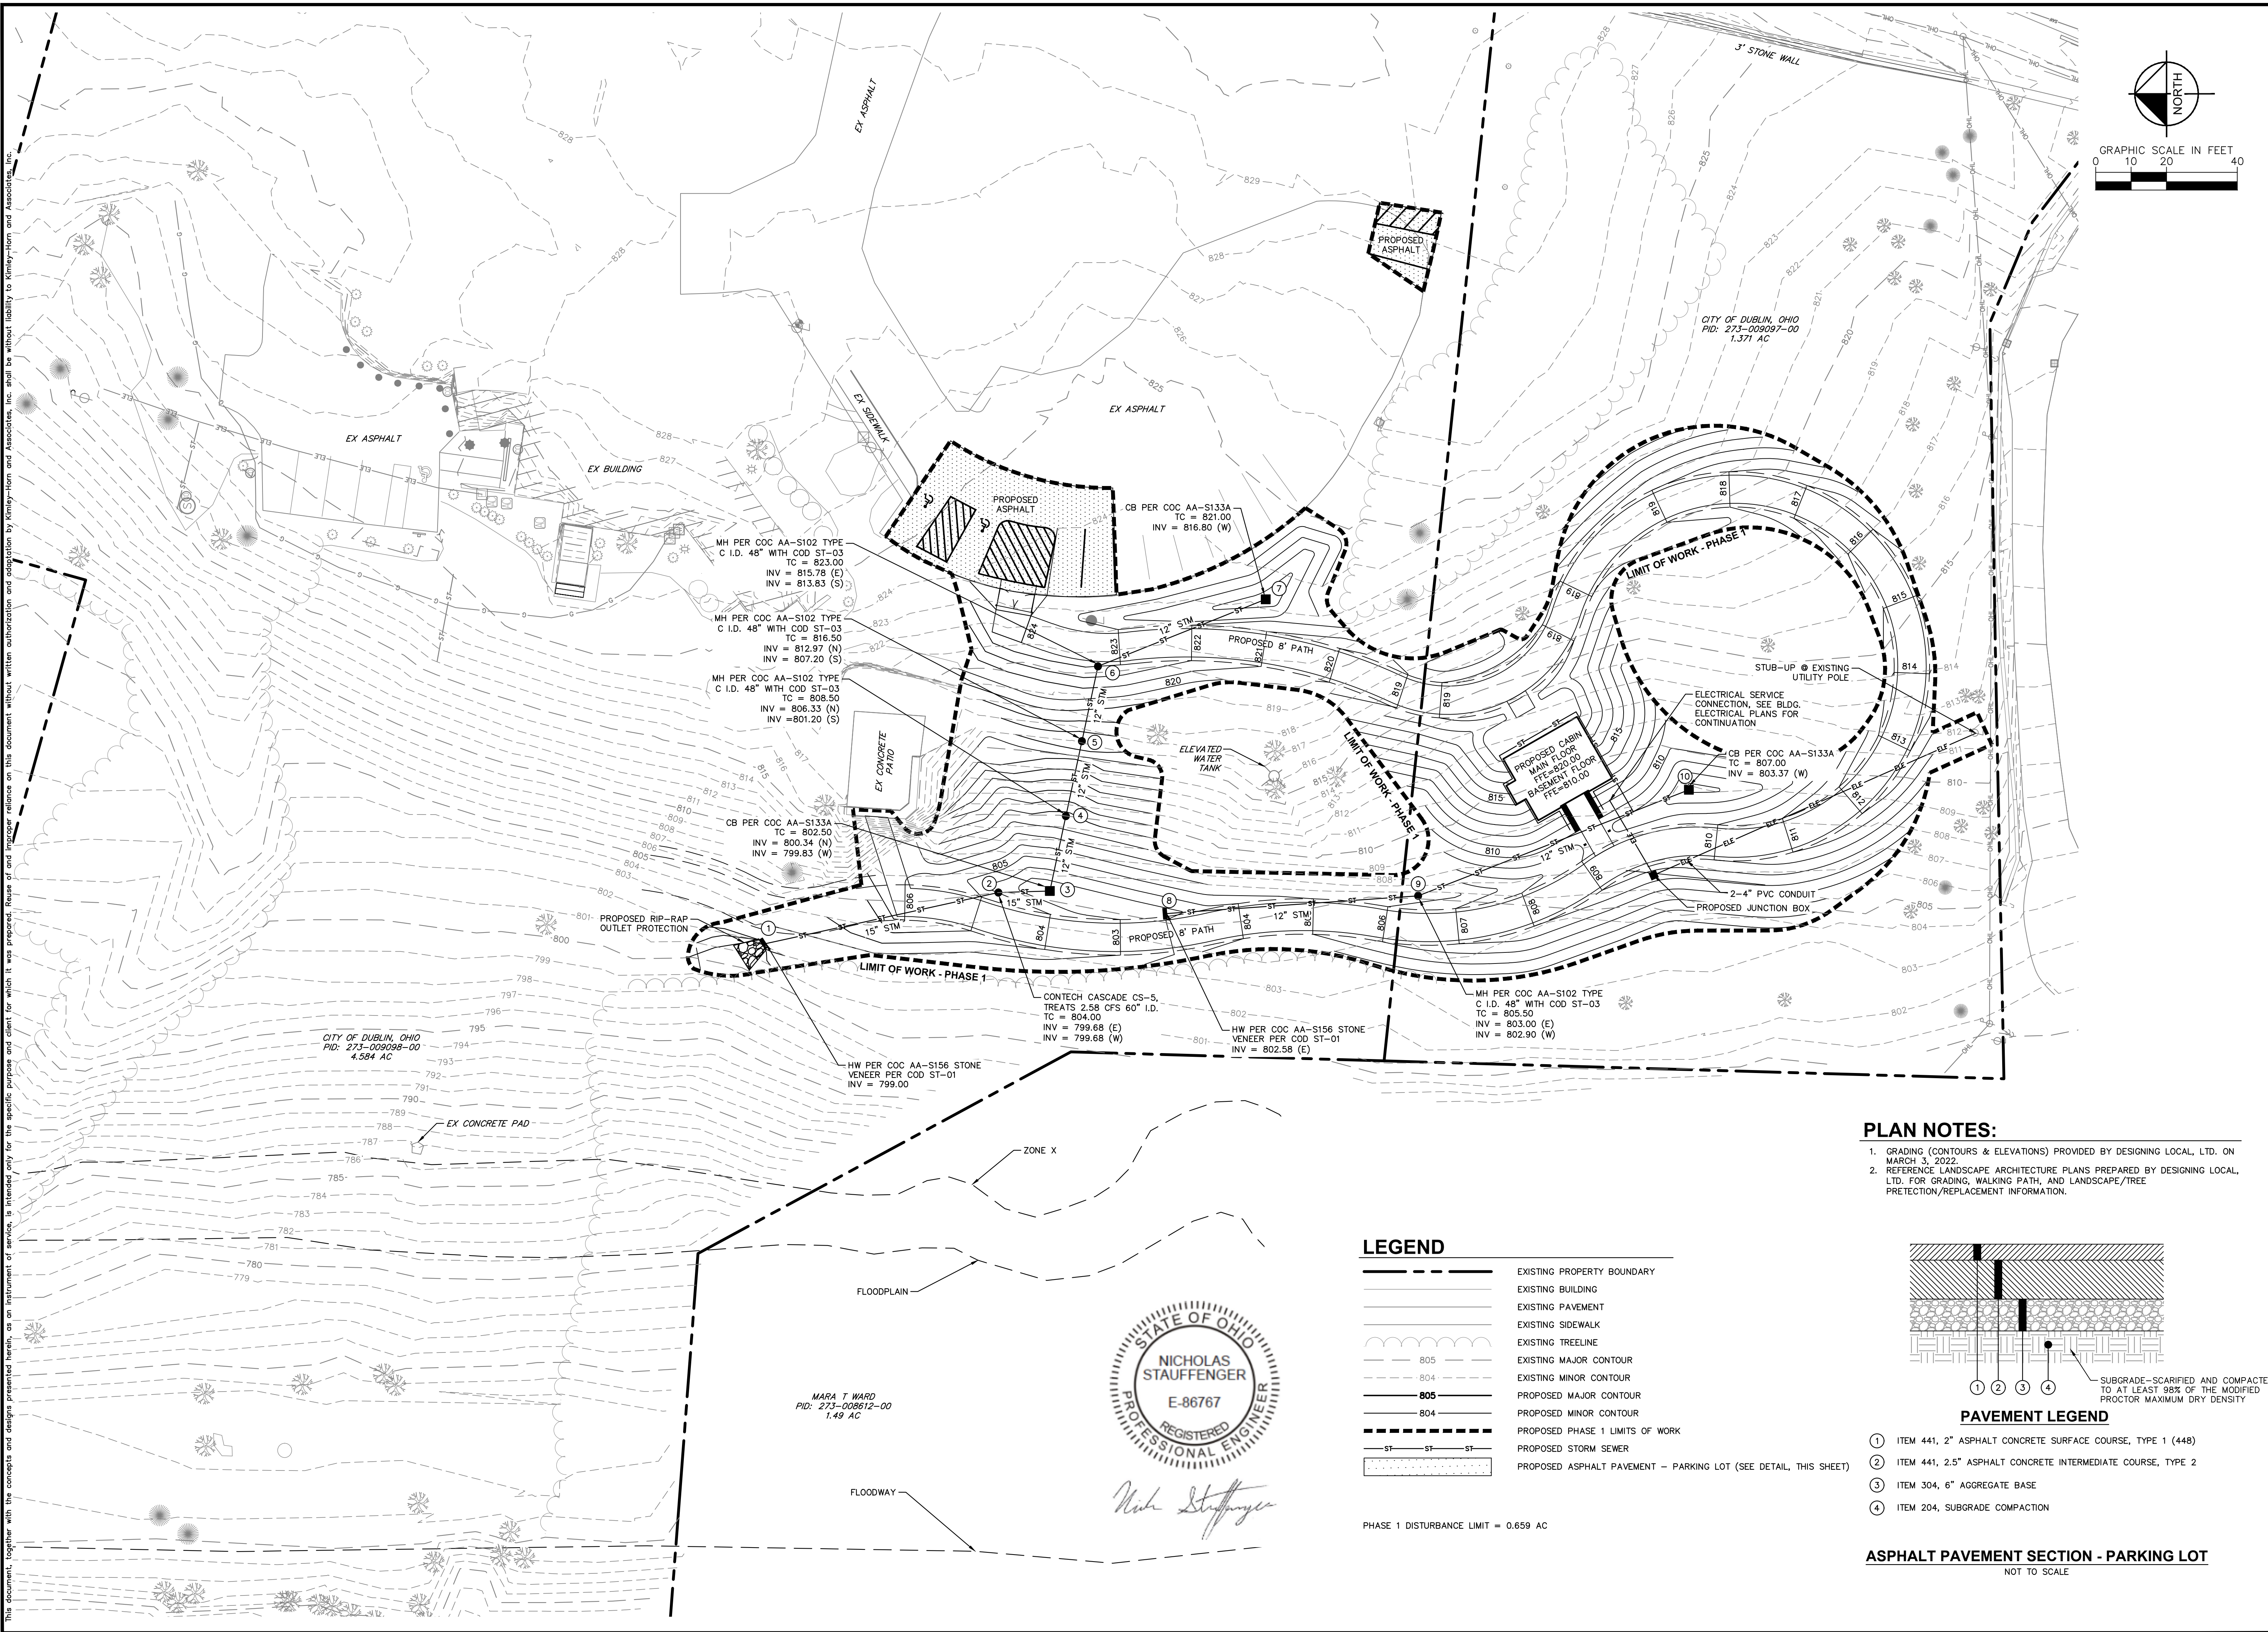Kimley»Horn
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 7985 N. HIGH STREET, SUITE 200
 DUBLIN, OHIO 43017
 PHONE: 614-444-6699
 WWW.KIMLEY-HORN.COM

SCALE: 1"=20'
 DESIGNED BY: NSS
 DRAWN BY: ACW
 CHECKED BY: AJS

**PHASE 1
 DRAINAGE & UTILITY
 PLAN**

DUBLIN ARTS CENTER
 7125 RIVERSIDE DRIVE
 DUBLIN, OH 43016


ORIGINAL ISSUE:
 03/11/2022
 KHA PROJECT NO.
 190094000
 SHEET NUMBER

- PLAN NOTES:**
1. GRADING (CONTOURS & ELEVATIONS) PROVIDED BY DESIGNING LOCAL, LTD. ON MARCH 3, 2022.
 2. REFERENCE LANDSCAPE ARCHITECTURE PLANS PREPARED BY DESIGNING LOCAL, LTD. FOR GRADING, WALKING PATH, AND LANDSCAPE/TREE PROTECTION/REPLACEMENT INFORMATION.

LEGEND

	EXISTING PROPERTY BOUNDARY
	EXISTING BUILDING
	EXISTING PAVEMENT
	EXISTING SIDEWALK
	EXISTING TREELINE
	EXISTING MAJOR CONTOUR
	EXISTING MINOR CONTOUR
	PROPOSED MAJOR CONTOUR
	PROPOSED MINOR CONTOUR
	PROPOSED PHASE 1 LIMITS OF WORK
	PROPOSED STORM SEWER
	PROPOSED ASPHALT PAVEMENT - PARKING LOT (SEE DETAIL, THIS SHEET)

PHASE 1 DISTURBANCE LIMIT = 0.659 AC

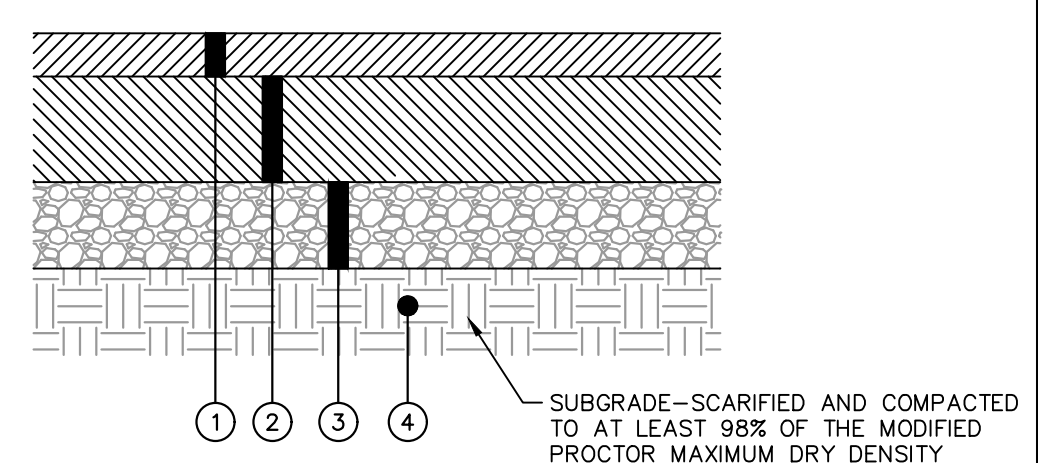

- PAVEMENT LEGEND**
1. ITEM 441, 2" ASPHALT CONCRETE SURFACE COURSE, TYPE 1 (448)
 2. ITEM 441, 2.5" ASPHALT CONCRETE INTERMEDIATE COURSE, TYPE 2
 3. ITEM 304, 6" AGGREGATE BASE
 4. ITEM 204, SUBGRADE COMPACTION



ASPHALT PAVEMENT SECTION - PARKING LOT
 NOT TO SCALE



MARA T WARD
 PID: 273-008612-00
 1.49 AC

NICHOLAS STAUFFENGER
 E-86767
 REGISTERED PROFESSIONAL ENGINEER

Drawing name: K:\CIB_LIVE\19094000_Designing Local Dublin Arts Center\2_Design\CAD\PlanSheets\GRADING & UTILITY PLAN - PH2.dwg Layout: Mar 14, 2022 8:02am by: Nick Staffinger
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PLAN NOTES:
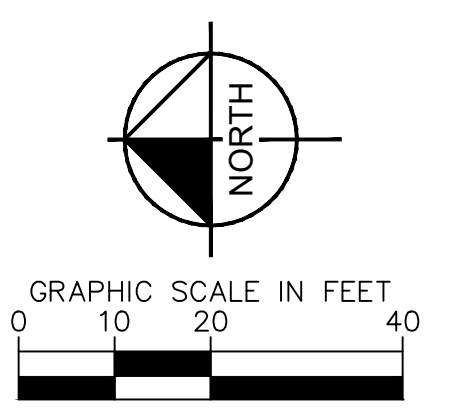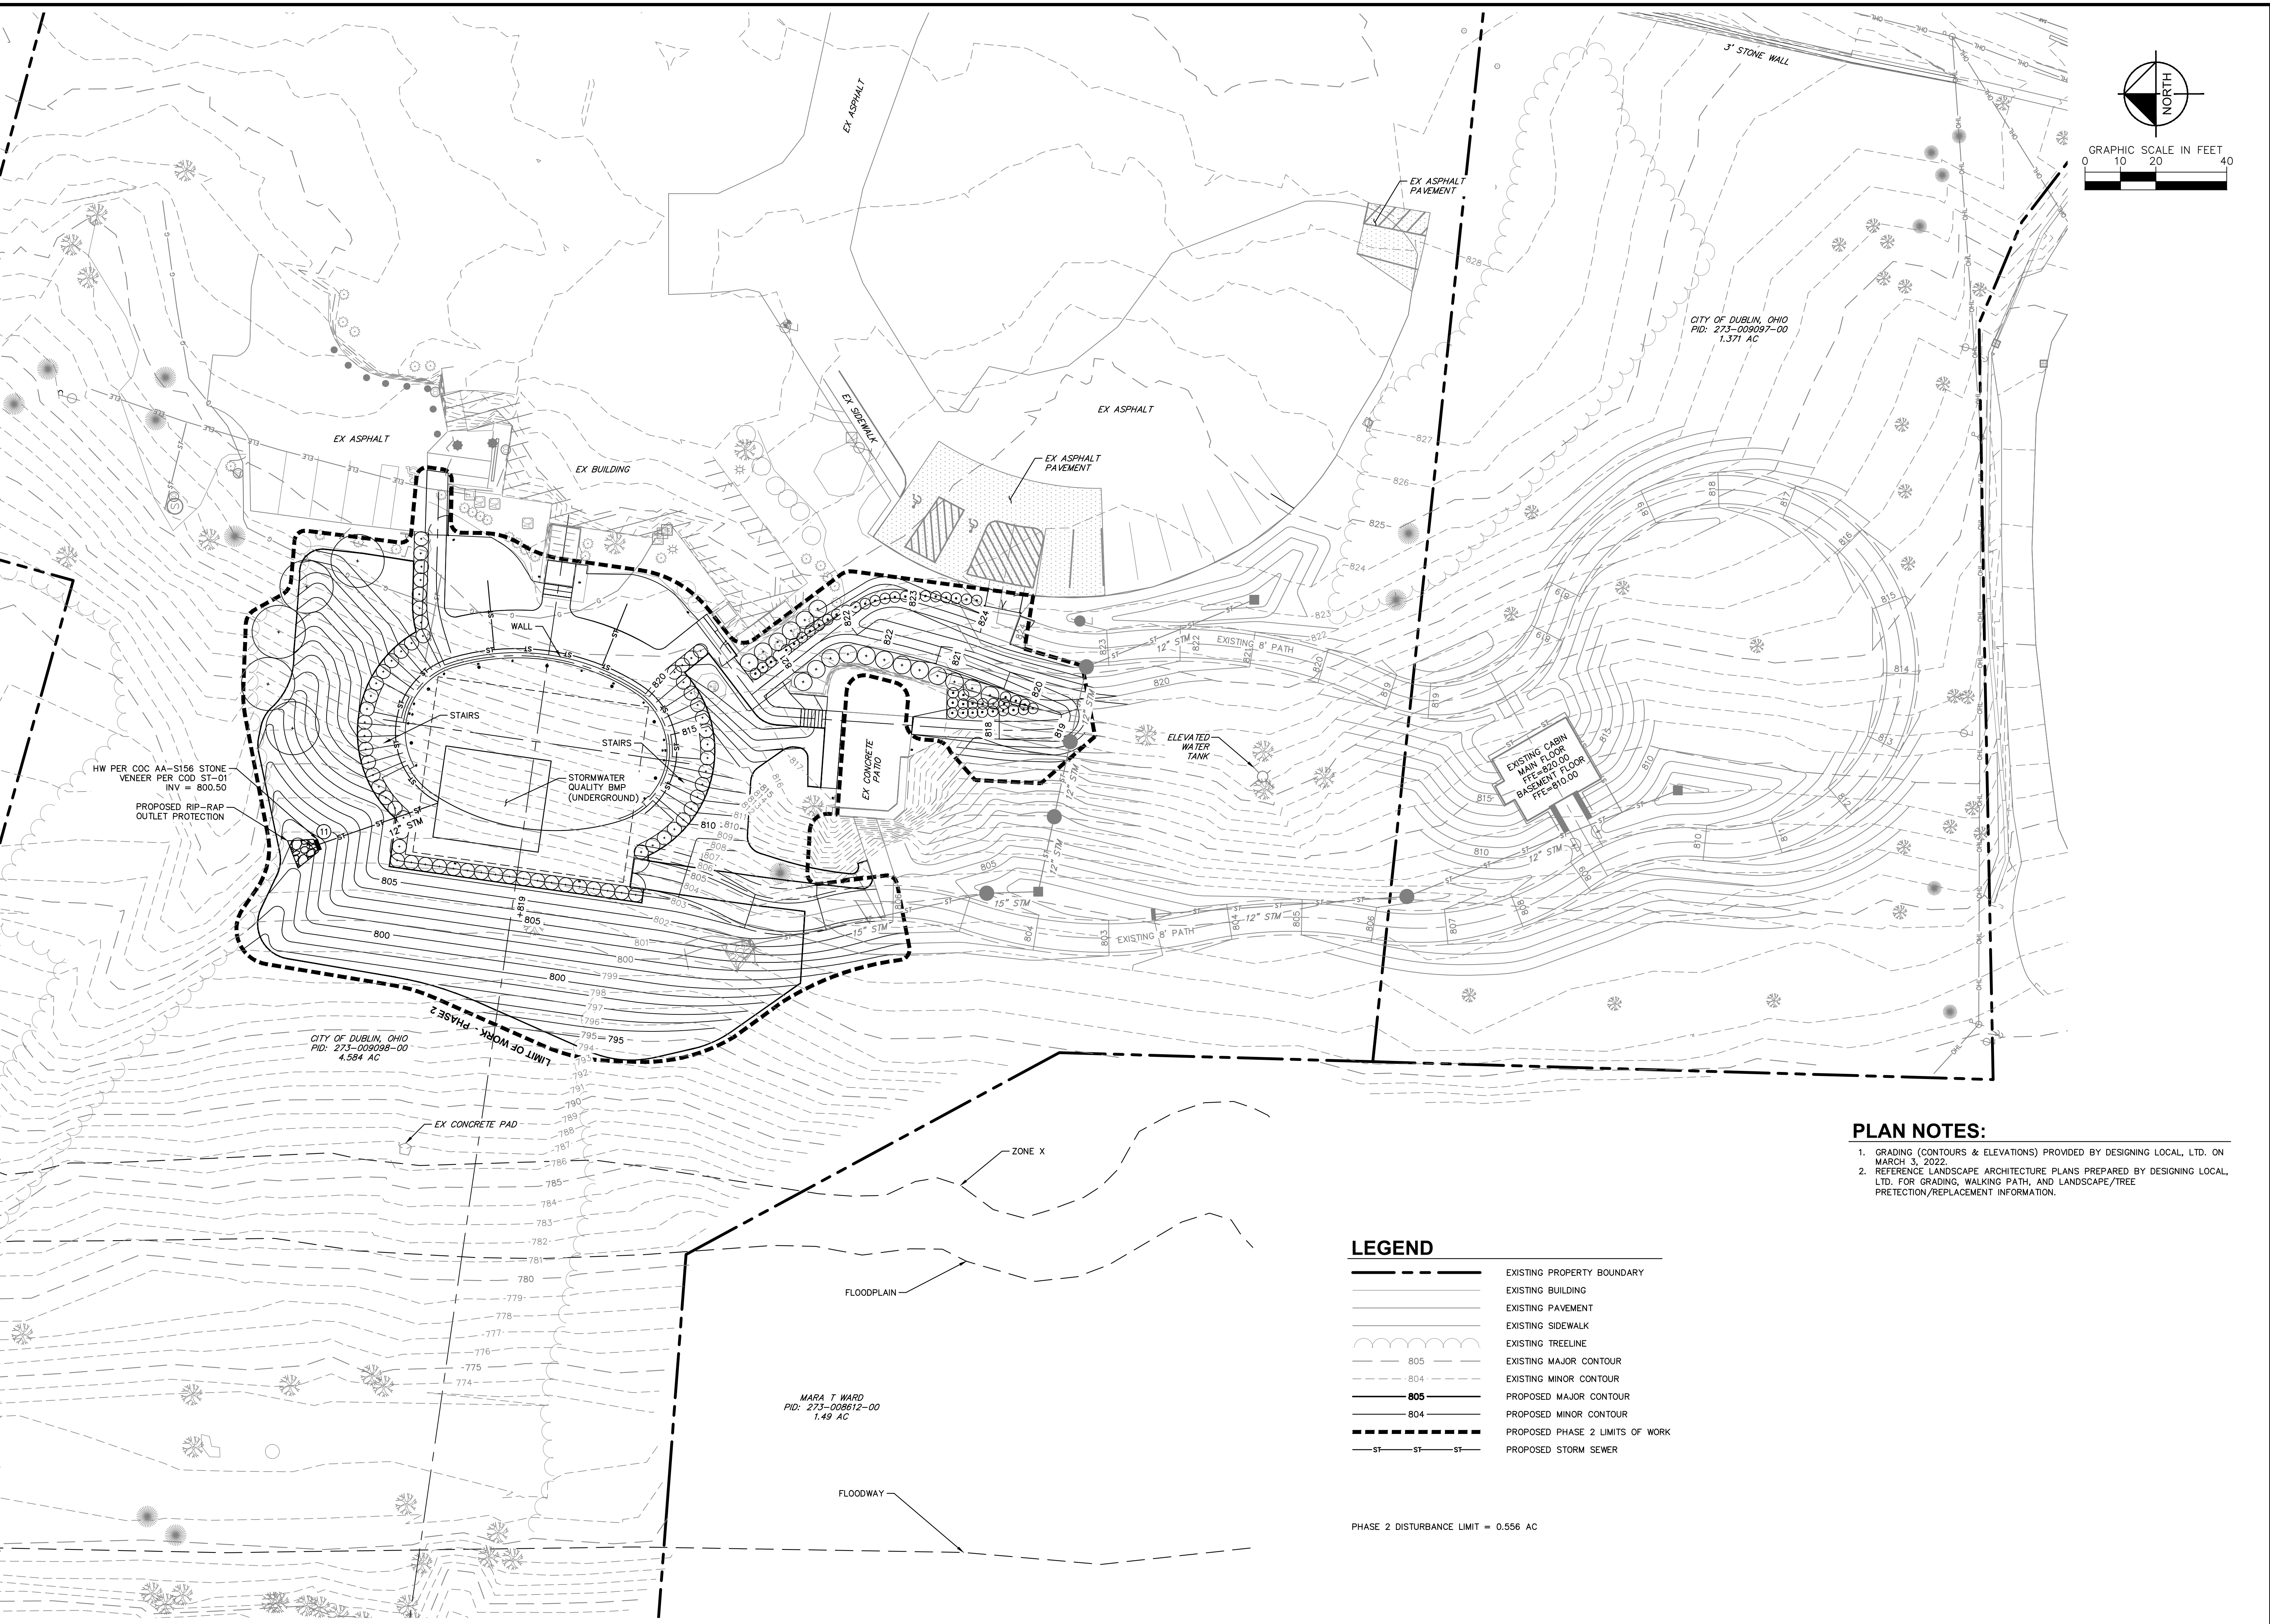
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2. REFERENCE LANDSCAPE ARCHITECTURE PLANS PREPARED BY DESIGNING LOCAL, LTD. FOR GRADING, WALKING PATH, AND LANDSCAPE/TREE PRETECTION/REPLACEMENT INFORMATION.

LEGEND

	EXISTING PROPERTY BOUNDARY
	EXISTING BUILDING
	EXISTING PAVEMENT
	EXISTING SIDEWALK
	EXISTING TREELINE
	EXISTING MAJOR CONTOUR
	EXISTING MINOR CONTOUR
	PROPOSED MAJOR CONTOUR
	PROPOSED MINOR CONTOUR
	PROPOSED PHASE 2 LIMITS OF WORK
	PROPOSED STORM SEWER

PHASE 2 DISTURBANCE LIMIT = 0.556 AC


Kimley»Horn	© 2022 KIMLEY-HORN AND ASSOCIATES, INC. 7985 N. HIGH STREET, SUITE 200 PLOUNGETON, OHIO 43152 WWW.KIMLEY-HORN.COM				
DESIGNED BY: NSS	DRAWN BY: ACW	CHECKED BY: AJS	DATE:	BY:	APR DATE: APR BY:
FUTURE PHASE 2 GRADING & UTILITY PLAN					
DUBLIN ARTS CENTER 7125 RIVERSIDE DRIVE DUBLIN, OH 43016					
ORIGINAL ISSUE: 03/11/2022					
KHA PROJECT NO. 190094000					
SHEET NUMBER					
2					

The City of Dublin Historic Log Cabin Relocation & Reconstruction

7125 Riverside Drive
Dublin, OH 43016

ABBREVIATIONS	GENERAL NOTES	INDEX OF DRAWINGS	BUILDING CODE DATA																																																																																																																																																																																																																																																																																																																																																																																																																																																																																																																																								
<table border="0"> <tr><td>A.B.</td><td>ANCHOR BOLT</td><td>CRS</td><td>COURSE</td><td>FDN</td><td>FOUNDATION</td><td>MTL</td><td>METAL</td><td>SH</td><td>SHELL</td></tr> <tr><td>A.P.</td><td>ACCESS PANEL</td><td>DEM</td><td>DEMOLITION OR DEMOSH</td><td>FRM</td><td>FRAME</td><td>MIN</td><td>MINIMUM</td><td>SIM</td><td>SIMILAR</td></tr> <tr><td>ACOUS</td><td>ACOUSTICAL</td><td>DET</td><td>DETAIL</td><td>FRMG</td><td>FRAMING</td><td>MISC</td><td>MISCELLANEOUS</td><td>S.C.</td><td>SOLID CORE</td></tr> <tr><td>A.F.F.</td><td>ABOVE FINISH FLOOR</td><td>DA</td><td>DIAMETER</td><td>F.R.T.</td><td>FIRE RETARDANT TREATED</td><td>MTD</td><td>MOUNTED</td><td>S</td><td>SOUTH</td></tr> <tr><td>ADJ</td><td>ADJACENT</td><td>DMA</td><td>DIMENSION</td><td>F.S.</td><td>FULL SIZE</td><td>MIL</td><td>MILLION</td><td>S.F.</td><td>SQUARE FEET or FOOT OF CONSTRUCTION</td></tr> <tr><td>AGGR</td><td>AGGREGATE</td><td>DR</td><td>DOOR</td><td>F.S.W.</td><td>FIRE SEPARATION WALL</td><td>NOM</td><td>NOMINAL</td><td>SPEC</td><td>SPECIFICATIONS</td></tr> <tr><td>A.C.</td><td>AIR CONDITIONING</td><td>D.O.</td><td>DOOR OPENING</td><td>FURR</td><td>FURRING</td><td>N</td><td>NORTH</td><td>SQ</td><td>SQUARE</td></tr> <tr><td>ALT</td><td>ALTERNATE</td><td>DBL</td><td>DOUBLE</td><td>GA</td><td>GAUGE</td><td>N.L.C.</td><td>NOT IN CONTRACT</td><td>SST</td><td>STAINLESS STEEL</td></tr> <tr><td>ALUM</td><td>ALUMINUM</td><td>DWG</td><td>DRAWING</td><td>GALV</td><td>GALVANIZED</td><td>N.T.S.</td><td>NOT TO SCALE</td><td>STD</td><td>STANDARD</td></tr> <tr><td>L</td><td>ANGLE</td><td>D.F.</td><td>DRINKING FOUNTAIN</td><td>G.C.</td><td>GENERAL TRADES CONTRACTOR</td><td>NO or #</td><td>NUMBER</td><td>STL</td><td>STEEL</td></tr> <tr><td>APPD</td><td>APPROVED</td><td>E</td><td>EAST</td><td>GL</td><td>GLASS or GLAZING</td><td>O.C.</td><td>ON CENTER</td><td>STRUCT</td><td>STRUCTURAL</td></tr> <tr><td>APPROX</td><td>APPROXIMATE</td><td>EA</td><td>EACH</td><td>GO</td><td>GRADE or GRADING</td><td>OPNG</td><td>OPENING</td><td>SYM</td><td>SYMMETRICAL</td></tr> <tr><td>ARCH</td><td>ARCHITECTURAL</td><td>ELEC</td><td>ELECTRICAL</td><td>GND</td><td>GROUND</td><td>OPF</td><td>OPPOSITE</td><td>TEL</td><td>TELEPHONE</td></tr> <tr><td>A.D.</td><td>AREA DRAIN</td><td>E.W.C.</td><td>ELECTRIC WATER COOLER</td><td>GYP</td><td>GYPSUM</td><td>OA</td><td>OVERALL</td><td>THK</td><td>THICK</td></tr> <tr><td>ASPH</td><td>ASPHALT</td><td>E.P.</td><td>ELECTRICAL PANEL BOARD</td><td>HDW</td><td>HARDWARE</td><td>O.D.</td><td>OUTSIDE DIMENSION</td><td>T.C.</td><td>TOP OF CURB</td></tr> <tr><td>@</td><td>AT</td><td>EL</td><td>ELEVATION</td><td>HDR</td><td>HEADER</td><td>PR</td><td>PAIR</td><td>T/O</td><td>TOP OF</td></tr> <tr><td>BRG</td><td>BEARING</td><td>EV</td><td>ELEVATOR</td><td>HTG</td><td>HEATING</td><td>PNL</td><td>PANEL</td><td>T.O.P.</td><td>TOP OF PAVEMENT</td></tr> <tr><td>BM</td><td>BEAM</td><td>EMER</td><td>EMERGENCY</td><td>HYAC</td><td>HEATING, VENTILATION, AIR CONDITIONING</td><td>PL</td><td>PLATE</td><td>T.O.W.</td><td>TOP OF WALL</td></tr> <tr><td>BTUM</td><td>BITUMINOUS</td><td>EQ</td><td>EQUAL</td><td>INSUL</td><td>INSULATION</td><td>PLAM</td><td>PLASTIC LAMINATE</td><td>T&G</td><td>TONGUE AND GROOVE</td></tr> <tr><td>BK</td><td>BLOCK</td><td>EQT</td><td>EQUIPMENT</td><td>HGT</td><td>HEIGHT</td><td>PLY</td><td>PLYWOOD</td><td>TYP</td><td>TYPICAL</td></tr> <tr><td>BKLG</td><td>BLOCKING</td><td>ENST</td><td>EXISTING</td><td>H.C.</td><td>HOLLOW CORE</td><td>PT</td><td>POINT</td><td>UNF</td><td>UNFINISHED</td></tr> <tr><td>BD</td><td>BOARD</td><td>EXP</td><td>EXPANSION</td><td>H.M.</td><td>HOLLOW METAL</td><td>P.S.A.</td><td>POUNDS PER SQUARE INCH</td><td>UN.O.</td><td>UNLESS NOTED OTHERWISE</td></tr> <tr><td>B/O</td><td>BOTTOM OF</td><td>E.J.</td><td>EXPANSION JOINT</td><td>HR</td><td>HOUR</td><td>P.C.</td><td>PRECAST CONCRETE or PORTLAND CEMENT</td><td>V.B.</td><td>VAPOR BARRIER</td></tr> <tr><td>BOT</td><td>BOTTOM</td><td>EXPO</td><td>EXPOSED</td><td>INCL</td><td>INCLUDE</td><td>V.C.T.</td><td>VINYL COMPOSITION TILE</td><td>V.C.T.</td><td>VERTICAL</td></tr> <tr><td>BLDG</td><td>BUILDING</td><td>EXT</td><td>EXTERIOR</td><td>ID.</td><td>INSIDE DIAMETER</td><td>R</td><td>RADIUS</td><td>VERT</td><td>VERTICAL</td></tr> <tr><td>C.B.</td><td>CATCH BASIN</td><td>F.O.U.</td><td>FACE OF CONCRETE</td><td>INSUL</td><td>INSULATION</td><td>REF</td><td>REFERENCE</td><td>WP</td><td>WATERPROOF</td></tr> <tr><td>CDM</td><td>CEMENT</td><td>F.O.F.</td><td>FACE OF FINISH</td><td>INT</td><td>INTERIOR</td><td>REIN</td><td>REINFORCED</td><td>WT</td><td>WEIGHT</td></tr> <tr><td>CONJ</td><td>CONTROL JOINT</td><td>F.O.S.</td><td>FACE OF STUD</td><td>JT</td><td>JOINT</td><td>REQD</td><td>REQUIRED</td><td>W</td><td>WEST or WIDTH</td></tr> <tr><td>CLG</td><td>CAULKING</td><td>FIN</td><td>FINISH</td><td>L.H.</td><td>LEFT HAND</td><td>RES</td><td>RESILIENT</td><td>WJ</td><td>WITH</td></tr> <tr><td>CLG</td><td>CEILING</td><td>F.A.</td><td>FIRE ALARM</td><td>LGTH</td><td>LENGTH</td><td>R.A.</td><td>RETURN AIR</td><td>W/O</td><td>WITHOUT</td></tr> <tr><td>CLR</td><td>CLEAR</td><td>F.E.</td><td>FIRE EXTINGUISHER</td><td>LTL</td><td>LENGTH</td><td>R.H.</td><td>RIGHT HAND</td><td>WD</td><td>WOOD</td></tr> <tr><td>C.M.U.</td><td>CONCRETE MASONRY UNIT</td><td>F.E.C.</td><td>FIRE EXTINGUISHER CABINET</td><td>M/E/P</td><td>MECHANICAL, ELECTRICAL & PLUMBING</td><td>R.O.W.</td><td>RIGHT OF WAY</td><td></td><td></td></tr> <tr><td>C.O.</td><td>CLEAN OUT</td><td>FRFF</td><td>FIREPROOF</td><td>MFR</td><td>MANUFACTURER</td><td>R</td><td>RISER</td><td></td><td></td></tr> <tr><td>CTR</td><td>CENTER</td><td>FLG</td><td>FLASHING</td><td>MAS</td><td>MASONRY</td><td>R.D.</td><td>ROOF DRAIN</td><td></td><td></td></tr> <tr><td>CJ</td><td>CENTERLINE</td><td>F.B.</td><td>FLAT BAR</td><td>MAS</td><td>MASONRY</td><td>R.M.</td><td>ROOM</td><td></td><td></td></tr> <tr><td>COL</td><td>COLUMN</td><td>FL</td><td>FLOOR</td><td>M.O.</td><td>MASONRY OPENING</td><td>R.O.</td><td>ROUGH OPENING</td><td></td><td></td></tr> <tr><td>CONC</td><td>CONCRETE</td><td>F.D.</td><td>FLOOR DRAIN</td><td>MTL</td><td>MATERIAL</td><td>SECT</td><td>SECTION</td><td></td><td></td></tr> <tr><td>CONN</td><td>CONNECTION</td><td>FLOR</td><td>FLOOR</td><td>MAX</td><td>MAXIMUM</td><td>SCHED</td><td>SCHEDULE</td><td></td><td></td></tr> <tr><td>CONSTR</td><td>CONSTRUCTION</td><td>FT</td><td>FOOT or FEET</td><td>MECH</td><td>MECHANICAL</td><td>SHGT</td><td>SHEATHING</td><td></td><td></td></tr> <tr><td>CONTR</td><td>CONTRACTOR</td><td>FTG</td><td>FOOTING</td><td>MEMB</td><td>MEMBRANE</td><td>SHT</td><td>SHEET</td><td></td><td></td></tr> </table>	A.B.	ANCHOR BOLT	CRS	COURSE	FDN	FOUNDATION	MTL	METAL	SH	SHELL	A.P.	ACCESS PANEL	DEM	DEMOLITION OR DEMOSH	FRM	FRAME	MIN	MINIMUM	SIM	SIMILAR	ACOUS	ACOUSTICAL	DET	DETAIL	FRMG	FRAMING	MISC	MISCELLANEOUS	S.C.	SOLID CORE	A.F.F.	ABOVE FINISH FLOOR	DA	DIAMETER	F.R.T.	FIRE RETARDANT TREATED	MTD	MOUNTED	S	SOUTH	ADJ	ADJACENT	DMA	DIMENSION	F.S.	FULL SIZE	MIL	MILLION	S.F.	SQUARE FEET or FOOT OF CONSTRUCTION	AGGR	AGGREGATE	DR	DOOR	F.S.W.	FIRE SEPARATION WALL	NOM	NOMINAL	SPEC	SPECIFICATIONS	A.C.	AIR CONDITIONING	D.O.	DOOR OPENING	FURR	FURRING	N	NORTH	SQ	SQUARE	ALT	ALTERNATE	DBL	DOUBLE	GA	GAUGE	N.L.C.	NOT IN CONTRACT	SST	STAINLESS STEEL	ALUM	ALUMINUM	DWG	DRAWING	GALV	GALVANIZED	N.T.S.	NOT TO SCALE	STD	STANDARD	L	ANGLE	D.F.	DRINKING FOUNTAIN	G.C.	GENERAL TRADES CONTRACTOR	NO or #	NUMBER	STL	STEEL	APPD	APPROVED	E	EAST	GL	GLASS or GLAZING	O.C.	ON CENTER	STRUCT	STRUCTURAL	APPROX	APPROXIMATE	EA	EACH	GO	GRADE or GRADING	OPNG	OPENING	SYM	SYMMETRICAL	ARCH	ARCHITECTURAL	ELEC	ELECTRICAL	GND	GROUND	OPF	OPPOSITE	TEL	TELEPHONE	A.D.	AREA DRAIN	E.W.C.	ELECTRIC WATER COOLER	GYP	GYPSUM	OA	OVERALL	THK	THICK	ASPH	ASPHALT	E.P.	ELECTRICAL PANEL BOARD	HDW	HARDWARE	O.D.	OUTSIDE DIMENSION	T.C.	TOP OF CURB	@	AT	EL	ELEVATION	HDR	HEADER	PR	PAIR	T/O	TOP OF	BRG	BEARING	EV	ELEVATOR	HTG	HEATING	PNL	PANEL	T.O.P.	TOP OF PAVEMENT	BM	BEAM	EMER	EMERGENCY	HYAC	HEATING, VENTILATION, AIR CONDITIONING	PL	PLATE	T.O.W.	TOP OF WALL	BTUM	BITUMINOUS	EQ	EQUAL	INSUL	INSULATION	PLAM	PLASTIC LAMINATE	T&G	TONGUE AND GROOVE	BK	BLOCK	EQT	EQUIPMENT	HGT	HEIGHT	PLY	PLYWOOD	TYP	TYPICAL	BKLG	BLOCKING	ENST	EXISTING	H.C.	HOLLOW CORE	PT	POINT	UNF	UNFINISHED	BD	BOARD	EXP	EXPANSION	H.M.	HOLLOW METAL	P.S.A.	POUNDS PER SQUARE INCH	UN.O.	UNLESS NOTED OTHERWISE	B/O	BOTTOM OF	E.J.	EXPANSION JOINT	HR	HOUR	P.C.	PRECAST CONCRETE or PORTLAND CEMENT	V.B.	VAPOR BARRIER	BOT	BOTTOM	EXPO	EXPOSED	INCL	INCLUDE	V.C.T.	VINYL COMPOSITION TILE	V.C.T.	VERTICAL	BLDG	BUILDING	EXT	EXTERIOR	ID.	INSIDE DIAMETER	R	RADIUS	VERT	VERTICAL	C.B.	CATCH BASIN	F.O.U.	FACE OF CONCRETE	INSUL	INSULATION	REF	REFERENCE	WP	WATERPROOF	CDM	CEMENT	F.O.F.	FACE OF FINISH	INT	INTERIOR	REIN	REINFORCED	WT	WEIGHT	CONJ	CONTROL JOINT	F.O.S.	FACE OF STUD	JT	JOINT	REQD	REQUIRED	W	WEST or WIDTH	CLG	CAULKING	FIN	FINISH	L.H.	LEFT HAND	RES	RESILIENT	WJ	WITH	CLG	CEILING	F.A.	FIRE ALARM	LGTH	LENGTH	R.A.	RETURN AIR	W/O	WITHOUT	CLR	CLEAR	F.E.	FIRE EXTINGUISHER	LTL	LENGTH	R.H.	RIGHT HAND	WD	WOOD	C.M.U.	CONCRETE MASONRY UNIT	F.E.C.	FIRE EXTINGUISHER CABINET	M/E/P	MECHANICAL, ELECTRICAL & PLUMBING	R.O.W.	RIGHT OF WAY			C.O.	CLEAN OUT	FRFF	FIREPROOF	MFR	MANUFACTURER	R	RISER			CTR	CENTER	FLG	FLASHING	MAS	MASONRY	R.D.	ROOF DRAIN			CJ	CENTERLINE	F.B.	FLAT BAR	MAS	MASONRY	R.M.	ROOM			COL	COLUMN	FL	FLOOR	M.O.	MASONRY OPENING	R.O.	ROUGH OPENING			CONC	CONCRETE	F.D.	FLOOR DRAIN	MTL	MATERIAL	SECT	SECTION			CONN	CONNECTION	FLOR	FLOOR	MAX	MAXIMUM	SCHED	SCHEDULE			CONSTR	CONSTRUCTION	FT	FOOT or FEET	MECH	MECHANICAL	SHGT	SHEATHING			CONTR	CONTRACTOR	FTG	FOOTING	MEMB	MEMBRANE	SHT	SHEET			<ol style="list-style-type: none"> THE ARCHITECT'S RESPONSIBILITY IS LIMITED TO THE ITEMS SHOWN ON THE ARCHITECTURAL DRAWINGS. OBTAIN ARCHITECTS SPECIFIC APPROVAL PRIOR TO DEVIATING FROM THE DRAWINGS. FOLLOW THE BEST TRADE PRACTICES AND ENGINEERING FOR THE ITEMS NOT SPECIFICALLY DETAILED AND INDICATED. IT IS THE CONTRACTOR'S SOLE RESPONSIBILITY TO FOLLOW ALL APPLICABLE SAFETY CODES AND REGULATIONS DURING ALL PHASES OF CONSTRUCTION. PROVIDE ADEQUATE TEMPORARY SUPPORT FOR WORK BEING CUT AND PATCHED TO PREVENT FAILURE. DO NOT ENDANGER OTHER WORK. PROVIDE ADEQUATE PROTECTION OF OTHER WORK DURING CUTTING AND PATCHING TO PREVENT DAMAGE. CUT WORK BY METHODS LEAST LIKELY TO DAMAGE WORK TO BE RETAINED AND WORK ADJOINING. ALL DIMENSIONS SHALL BE VERIFIED AT THE JOB BY THE GENERAL CONTRACTOR AND EACH SUB-CONTRACTOR. THE ARCHITECT MUST BE NOTIFIED OF ANY DISCREPANCIES BEFORE PROCEEDING WITH THE WORK. DIMENSIONS ARE WITNESSED TO FACE OF MASONRY OR TO FACE OF STUD UNLESS OTHERWISE NOTED. DETAILS SHOWN ON THE ARCHITECTURAL DRAWINGS ARE PART OF THE STRUCTURAL REQUIREMENTS. CONSTRUCTION JOINTS PERMITTED ONLY WHERE SHOWN OR AS APPROVED BY THE ARCHITECT. ALL CONNECTIONS ARE TO DEVELOP THE FULL STRENGTH OF THE FRAMING MEMBERS UNLESS OTHERWISE APPROVED. PROVIDE UNITS OF ADEQUATE SIZE FOR ANY OPENINGS NOT SPECIFICALLY INDICATED. FOR DUCTWORK, PIPES, LOUVERS, GRILLES, DAMPERS, ETC. IN GENERAL, NEW MATERIALS AND MATERIALS FOR REPAIR CONDITIONS, SHALL MATCH SIMILAR ITEMS IN QUALITY, DETAIL, PROFILE, AND FINISH, AS THOSE ALREADY BUILT INTO THE WORK. COORDINATE LOCATIONS AND/OR ELEVATIONS OF FLOOR DRAINS, REGISTERS, ACCESS PANELS, GRILLES, LOUVERS, CONVECTORS, CABINET HEATERS, PANELS, ETC., WITH MECHANICAL AND ELECTRICAL CONTRACTORS. SIZE AND LOCATION OF ALL FLOOR, WALL OR ROOF OPENINGS TO BE VERIFIED WITH TRADE AFFECTED BEFORE PROCEEDING WITH WORK. THE GENERAL CONTRACTOR SHALL COMPLY WITH ALL BUILDING CODE REQUIREMENTS OF THE LOCAL GOVERNING AUTHORITY, AND SHALL OBTAIN AND PAY FOR ALL REQUIRED PERMITS, FEES, AND INSPECTIONS, WITH THE EXCEPTION OF FEES REQUIRED FOR THE PLUMBING, H.V.A.C., AND ELECTRICAL PORTIONS OF THE WORK, WHICH ARE THE RESPONSIBILITY OF THE RESPECTIVE SUBCONTRACTORS. G.C. RESPONSIBLE FOR COORDINATING SMOKE DETECTION SYSTEM ACCEPTANCE TESTS WITH THE BUILDING DEPARTMENT. G.C. SHALL PROVIDE A SET OF CONSTRUCTION DOCUMENTS AT THE SITE OF THE WORK AND SHALL BE OPEN FOR INSPECTION BY THE BUILDING OFFICIAL AT ALL TIMES WHILE SUCH WORK IS IN PROGRESS PER OBC 106.3.1 SPACE SHALL NOT BE OCCUPIED UNTIL THE BUILDING OFFICIAL HAS ISSUED THE CERTIFICATE OF OCCUPANCY. ALL MEANS OF EGRESS DOORS SHALL BE READILY OPENABLE FROM SIDE WHICH EGRESS IS TO BE MADE WITHOUT THE USE OF A KEY OR SPECIAL KNOWLEDGE. PRIOR TO ANY EXCAVATION, CONTACT THE OHIO UTILITIES PROTECTION SERVICE (OUPS) AT (800) 362-2764 OR WWW.OUPS.ORG. TEMPORARY FACILITIES USED IN CONJUNCTION WITH WORK SHALL BE REMOVED UPON COMPLETION OF PROJECT. G.C. TO COORDINATE PERMITS/REQUIREMENTS WITH BUILDING DEPARTMENT. CONTRACTOR SHALL PROVIDE ONE (1) SET OF AS-BUILT DRAWINGS TO THE OWNER AFTER SUBSTANTIAL COMPLETION OF THE PROJECT AND WALK THE OWNER THROUGH NOTES MADE ON THE DRAWINGS THAT DESCRIBE FIELD CHANGES TO THE CONTRACT DOCUMENTS. IN THE ABSENCE OF LOCAL, STATE OR FEDERAL LAWS OR ORDINANCES REGULATING CONSTRUCTION SAFETY, THE PROVISIONS OF OBC CHAPTER 33 SHALL GOVERN SAFETY DURING CONSTRUCTION AS WELL AS THE PROTECTION OF ADJACENT PUBLIC AND PRIVATE PROPERTIES. 	<table border="0"> <tr><td colspan="2">ARCHITECTURAL</td><td colspan="2">STRUCTURAL</td></tr> <tr><td>T.01</td><td>TITLE SHEET</td><td>S0.01</td><td>STRUCTURAL GENERAL NOTES</td></tr> <tr><td>T.02</td><td>ACCESSIBILITY REQUIREMENTS</td><td>S1.01</td><td>FRAMING PLANS</td></tr> <tr><td></td><td></td><td>S5.01</td><td>STRUCTURAL DETAILS</td></tr> <tr><td colspan="2">ELECTRICAL</td><td colspan="2">POWER & LIGHTING PLANS</td></tr> <tr><td>A1.00</td><td>LOWER LEVEL FLOOR PLAN</td><td>E0.01</td><td>ELECTRICAL COVER SHEET</td></tr> <tr><td>A1.01</td><td>FIRST FLOOR PLAN</td><td>E2.01</td><td>POWER & LIGHTING PLANS</td></tr> <tr><td>A1.02</td><td>SECOND FLOOR PLAN</td><td>E5.01</td><td>ELECTRIC DETAILS</td></tr> <tr><td>A1.03</td><td>ROOF PLAN</td><td>E7.01</td><td>ELECTRIC SCHEDULES & RISER DIAGRAM</td></tr> <tr><td>A2.00</td><td>LOWER LEVEL REFLECTED CEILING PLAN</td><td></td><td></td></tr> <tr><td>A2.01</td><td>FIRST FLOOR REFLECTED CEILING PLAN</td><td></td><td></td></tr> <tr><td>A2.02</td><td>SECOND FLOOR REFLECTED CEILING PLAN</td><td></td><td></td></tr> <tr><td>A3.01</td><td>EXTERIOR ELEVATIONS</td><td></td><td></td></tr> <tr><td>A3.02</td><td>EXTERIOR ELEVATIONS</td><td></td><td></td></tr> <tr><td>A4.01</td><td>WALL SECTIONS & DETAILS</td><td></td><td></td></tr> <tr><td>A4.02</td><td>WALL SECTIONS & DETAILS</td><td></td><td></td></tr> <tr><td>A5.01</td><td>DOOR & WINDOW ELEVATIONS/SCHEDULE</td><td></td><td></td></tr> <tr><td>A5.02</td><td>INTERIOR ELEVATIONS</td><td></td><td></td></tr> <tr><td>A7.01</td><td>SPECIFICATIONS</td><td></td><td></td></tr> <tr><td>A7.02</td><td>SPECIFICATIONS</td><td></td><td></td></tr> </table>	ARCHITECTURAL		STRUCTURAL		T.01	TITLE SHEET	S0.01	STRUCTURAL GENERAL NOTES	T.02	ACCESSIBILITY REQUIREMENTS	S1.01	FRAMING PLANS			S5.01	STRUCTURAL DETAILS	ELECTRICAL		POWER & LIGHTING PLANS		A1.00	LOWER LEVEL FLOOR PLAN	E0.01	ELECTRICAL COVER SHEET	A1.01	FIRST FLOOR PLAN	E2.01	POWER & LIGHTING PLANS	A1.02	SECOND FLOOR PLAN	E5.01	ELECTRIC DETAILS	A1.03	ROOF PLAN	E7.01	ELECTRIC SCHEDULES & RISER DIAGRAM	A2.00	LOWER LEVEL REFLECTED CEILING PLAN			A2.01	FIRST FLOOR REFLECTED CEILING PLAN			A2.02	SECOND FLOOR REFLECTED CEILING PLAN			A3.01	EXTERIOR ELEVATIONS			A3.02	EXTERIOR ELEVATIONS			A4.01	WALL SECTIONS & DETAILS			A4.02	WALL SECTIONS & DETAILS			A5.01	DOOR & WINDOW ELEVATIONS/SCHEDULE			A5.02	INTERIOR ELEVATIONS			A7.01	SPECIFICATIONS			A7.02	SPECIFICATIONS			<p>PROJECT SCOPE: THE PROJECT DETAILS THE REBUILDING OF A HISTORIC DUBLIN LOG CABIN. THE GROUND FLOOR WILL BE MULTI-USE ASSEMBLY SPACE ACCESSIBLE TO THE PUBLIC. THE LOWER LEVEL WILL CONTAIN MECHANICAL AND UTILITIES. THE SECOND FLOOR LOFT WILL NOT BE ACCESSIBLE TO THE PUBLIC AND SHALL BE USED FOR STORAGE. THE BUILDING IS 1,440 SQ. FT. (480 ON EACH FLOOR). THE BUILDING INCLUDES THE FOLLOWING: <ul style="list-style-type: none"> NO BATHROOMS/BATHROOMS WILL BE PROVIDED IN AN ADJACENT FACILITY. A FALSE, NON-OPERATIONAL REPLACEMENT. ACCESSIBLE ROUTE PROVIDED TO GROUND FLOOR PER ADA GUIDELINES. ELECTRICAL SERVICES THROUGHOUT; NO PLUMBING, OR HVAC SHALL BE PROVIDED. </p> <p>APPLICABLE CODES: OHC BUILDING CODE (O.B.C.) 2017 EDITION OHIO MECHANICAL CODE (O.M.C.) 2017 EDITION OHIO PLUMBING CODE (O.P.C.) 2017 EDITION OHIO FIRE CODE (O.F.C.) 2017 EDITION NATIONAL ELECTRIC CODE 2017 EDITION OHIO ENERGY CODE 2017 EDITION ANSI A117.1 - ACCESSIBLE BUILDINGS 2009 EDITION </p> <p>USE GROUP (302) PER THE SECTION 303, THE BUILDING IS CLASSIFIED AS USE WITH AN ASSEMBLY SPACE USED AS EXHIBIT GALLERY OR MUSEUM WITH AN OCCUPANT LOAD LESS THAN 50 PERSONS.</p> <p>CONSTRUCTION TYPE: SB NON-SPRINKLERED.</p> <p>AREA OF WORK: 1,440 S.F.</p> <p>OCCUPANT LOAD (TABLE 1004.1.2)</p> <table border="0"> <tr><td>BY AREA</td><td>480 S.F. GROSS S.F. = 2 OCCUPANTS</td></tr> <tr><td>UTILITY AREAS:</td><td>480 S.F. GROSS S.F. = 2 OCCUPANTS</td></tr> <tr><td>STORAGE AREAS:</td><td>480 S.F. NET S.F. = 16 OCCUPANTS</td></tr> <tr><td>ASSEMBLY AREAS:</td><td>480 S.F. NET S.F. = 16 OCCUPANTS</td></tr> <tr><td>TOTAL</td><td>20 OCCUPANTS</td></tr> </table> <p>POSTING OF OCCUPANT LOAD (1004.3): PROVIDE OCCUPANT LOAD PLACARD IN CONSPICUOUS LOCATION NEAR MAIN EXIT INCLUDING ALL ASSEMBLY SPACES (16 OCCUPANTS). POSTED SHALL SIGN SHALL BE OF AN APPROVED, LEGIBLE, PERMANENT DESIGN AND SHALL BE MAINTAINED BY THE OWNER.</p> <p>FIRE RATINGS (TABLE 601)</p> <table border="0"> <tr><td>STRUCTURAL FRAME</td><td>0 HR</td></tr> <tr><td>BEARING WALLS</td><td>0 HR</td></tr> <tr><td>INTERIOR</td><td>0 HR</td></tr> <tr><td>EXTERIOR</td><td>0 HR</td></tr> <tr><td>NON-BEARING WALLS & PARTITIONS</td><td>0 HR</td></tr> <tr><td>INTERIOR</td><td>0 HR</td></tr> <tr><td>EXTERIOR</td><td>0 HR</td></tr> <tr><td>FLOOR CONSTRUCTION</td><td>0 HR</td></tr> <tr><td>ROOF CONSTRUCTION</td><td>0 HR</td></tr> </table> <p>INTERIOR FINISHES (TABLE 803.1.1)</p> <p>A2 USE (SPACE D03): EXIT ENCLOSURES & EXIT PASSAGEWAYS: CLASS B CORRIDORS: CLASS B ROOMS & ENCLOSED SPACES: CLASS C </p> <p>FIRE PROTECTION REQUIREMENTS</p> <table border="0"> <tr><td>AUTOMATIC SPRINKLER SYSTEM (SEC. 903)</td><td>NOT REQUIRED.</td></tr> <tr><td>FIRE ALARM SYSTEM (SEC. 907)</td><td>A MANUAL FIRE ALARM SYSTEM IS NOT REQUIRED. A SMOKE DETECTION SYSTEM WILL BE PROVIDED.</td></tr> </table> <p>MEANS OF EGRESS</p> <table border="0"> <tr><td>COMMON PATH OF TRAVEL (TABLE 1004.2.1)</td><td>100' (WITH CL < 30)</td></tr> <tr><td>EXIT ACCESS TRAVEL DISTANCE (TABLE 1017.2)</td><td>200' (WITHOUT SPRINKLER SYSTEM)</td></tr> <tr><td>REQUIRED NO. OF EXITS (TABLE 1006.3.1)</td><td>1 PER STORY</td></tr> <tr><td>NO. OF EXITS PROVIDED:</td><td>1 AT FIRST FLOOR & 1 AT LOWER LEVEL</td></tr> </table> <p>PLUMBING FIXTURES (TABLE 2902.1) N.A.</p>	BY AREA	480 S.F. GROSS S.F. = 2 OCCUPANTS	UTILITY AREAS:	480 S.F. GROSS S.F. = 2 OCCUPANTS	STORAGE AREAS:	480 S.F. NET S.F. = 16 OCCUPANTS	ASSEMBLY AREAS:	480 S.F. NET S.F. = 16 OCCUPANTS	TOTAL	20 OCCUPANTS	STRUCTURAL FRAME	0 HR	BEARING WALLS	0 HR	INTERIOR	0 HR	EXTERIOR	0 HR	NON-BEARING WALLS & PARTITIONS	0 HR	INTERIOR	0 HR	EXTERIOR	0 HR	FLOOR CONSTRUCTION	0 HR	ROOF CONSTRUCTION	0 HR	AUTOMATIC SPRINKLER SYSTEM (SEC. 903)	NOT REQUIRED.	FIRE ALARM SYSTEM (SEC. 907)	A MANUAL FIRE ALARM SYSTEM IS NOT REQUIRED. A SMOKE DETECTION SYSTEM WILL BE PROVIDED.	COMMON PATH OF TRAVEL (TABLE 1004.2.1)	100' (WITH CL < 30)	EXIT ACCESS TRAVEL DISTANCE (TABLE 1017.2)	200' (WITHOUT SPRINKLER SYSTEM)	REQUIRED NO. OF EXITS (TABLE 1006.3.1)	1 PER STORY	NO. OF EXITS PROVIDED:	1 AT FIRST FLOOR & 1 AT LOWER LEVEL
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PROJECT:
Relocation & Reconstruction to:
The City of Dublin
Historic Log Cabin
7125 Riverside Drive
Dublin, Ohio 43016

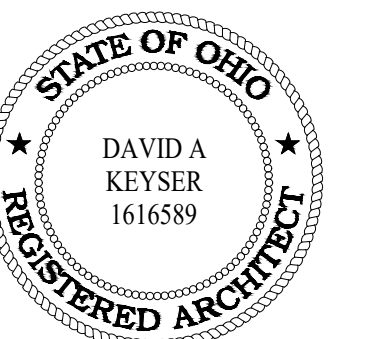

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SHEET INFORMATION

Project #: 2021-003
Issued For: Progress
Date: 3/9/22
Revisions:

SHEET TITLE

Title Sheet

SHEET NUMBER

T.01

GENERAL NOTES

- G.C. TO VERIFY QUANTITY & LOCATION OF FIRE EXTINGUISHERS W/ FIRE DEPARTMENT.
- DIMENSIONS INDICATED AS +/- ARE TO BE FIELD VERIFIED BY THE GENERAL CONTRACTOR PRIOR TO COMMENCEMENT OF WORK.
- G.C. TO FILL/SEAL ANY GAPS AT PENETRATIONS AND/OR OPENINGS THRU EXTERIOR WALL.
- INDICATED DIMENSIONS ARE TO FINISH SURFACE OF WOOD LOGS OR C.M.U. UNLESS NOTED OTHERWISE.
- REFER TO SHEETS T1.02 FOR REQUIRED ACCESSIBLE CLEARANCES AT DOORWAYS.

CODED FLOOR PLAN NOTES

- 3'-0"x7'-0" CONC. MATT FOOTING WITH #5 RE-BARS (SEE FOUNDATION PLAN).
- 12"x24" CONC. FOOTING WITH (2) #5 RE-BARS (SEE FOUNDATION PLAN).
- STEP FOOTING AS NEEDED TO STAY 36" BELOW FROST LINE.
- 12" C.M.U. FOUNDATION WALL (SEE FOUNDATION PLAN).
- 8" C.M.U. FOUNDATION WALL WITH 4" STONE VENEER STEPPED TO REMAIN BELOW GRADE 12" C.M.U. BELOW.
- 16" DIA. CONC. FIR. FOR PORCH POST ABOVE. TYP. FOR 4 (SEE FOUNDATION PLAN).
- 4" GALVANIZED DOWNSPOUT CONNECT TO DRAIN TILE.
- UNPAINTED C.M.U. FOUNDATION WALL. TYP.
- ELECTRIC PANEL (SEE ELECTRICAL DRAWINGS).
- RECYCLED WOOD HEWN-LOG WALL CONSTRUCTION WITH NOTCHED CORNERS AND MODERN CHINKING.
- 6x6 ROUGH-CUT WOOD POSTS ON CONC. FIR. TYP. FOR 4 (SEE FOUNDATION PLAN).
- 5/4 x6 ROUGH-CUT WD. PORCH ON TREATED 2X FRAMING (SEE FIRST FLOOR FRAMING PLAN).
- FLUSH STONE HEARTH (SEE INTERIOR ELEVATION).
- FAUX FIREPLACE & CORBELLED STONE MANTLE (SEE INTERIOR ELEVATION).
- ROUGH-CUT WD. STAIR AND FRAMING (SEE INTERIOR ELEVATION).
- WD. WINDOW (SEE OPENING SCHEDULE).
- FLUSH THRESHOLD FOR ACCESSIBLE ENTRY.
- ROUGH-CUT WD. FLOORING.
- 4x4 ROUGH-CUT WD. POSTS RAILING (SEE INTERIOR ELEVATION).
- CEDAR ROOF SHINGLES BELOW.
- FALSE CHIMNEY WITH STONE VENEER.
- ROUGH-CUT WD. CEILING BEAMS ABOVE (SEE REFLECTED CEILING PLANS)



PROJECT:
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SHEET INFORMATION


Project #:	2021-003
Issued For:	Progress
Date:	3/9/22
Revisions:	

SHEET TITLE

Lower Level Plan

SHEET NUMBER

A1.00

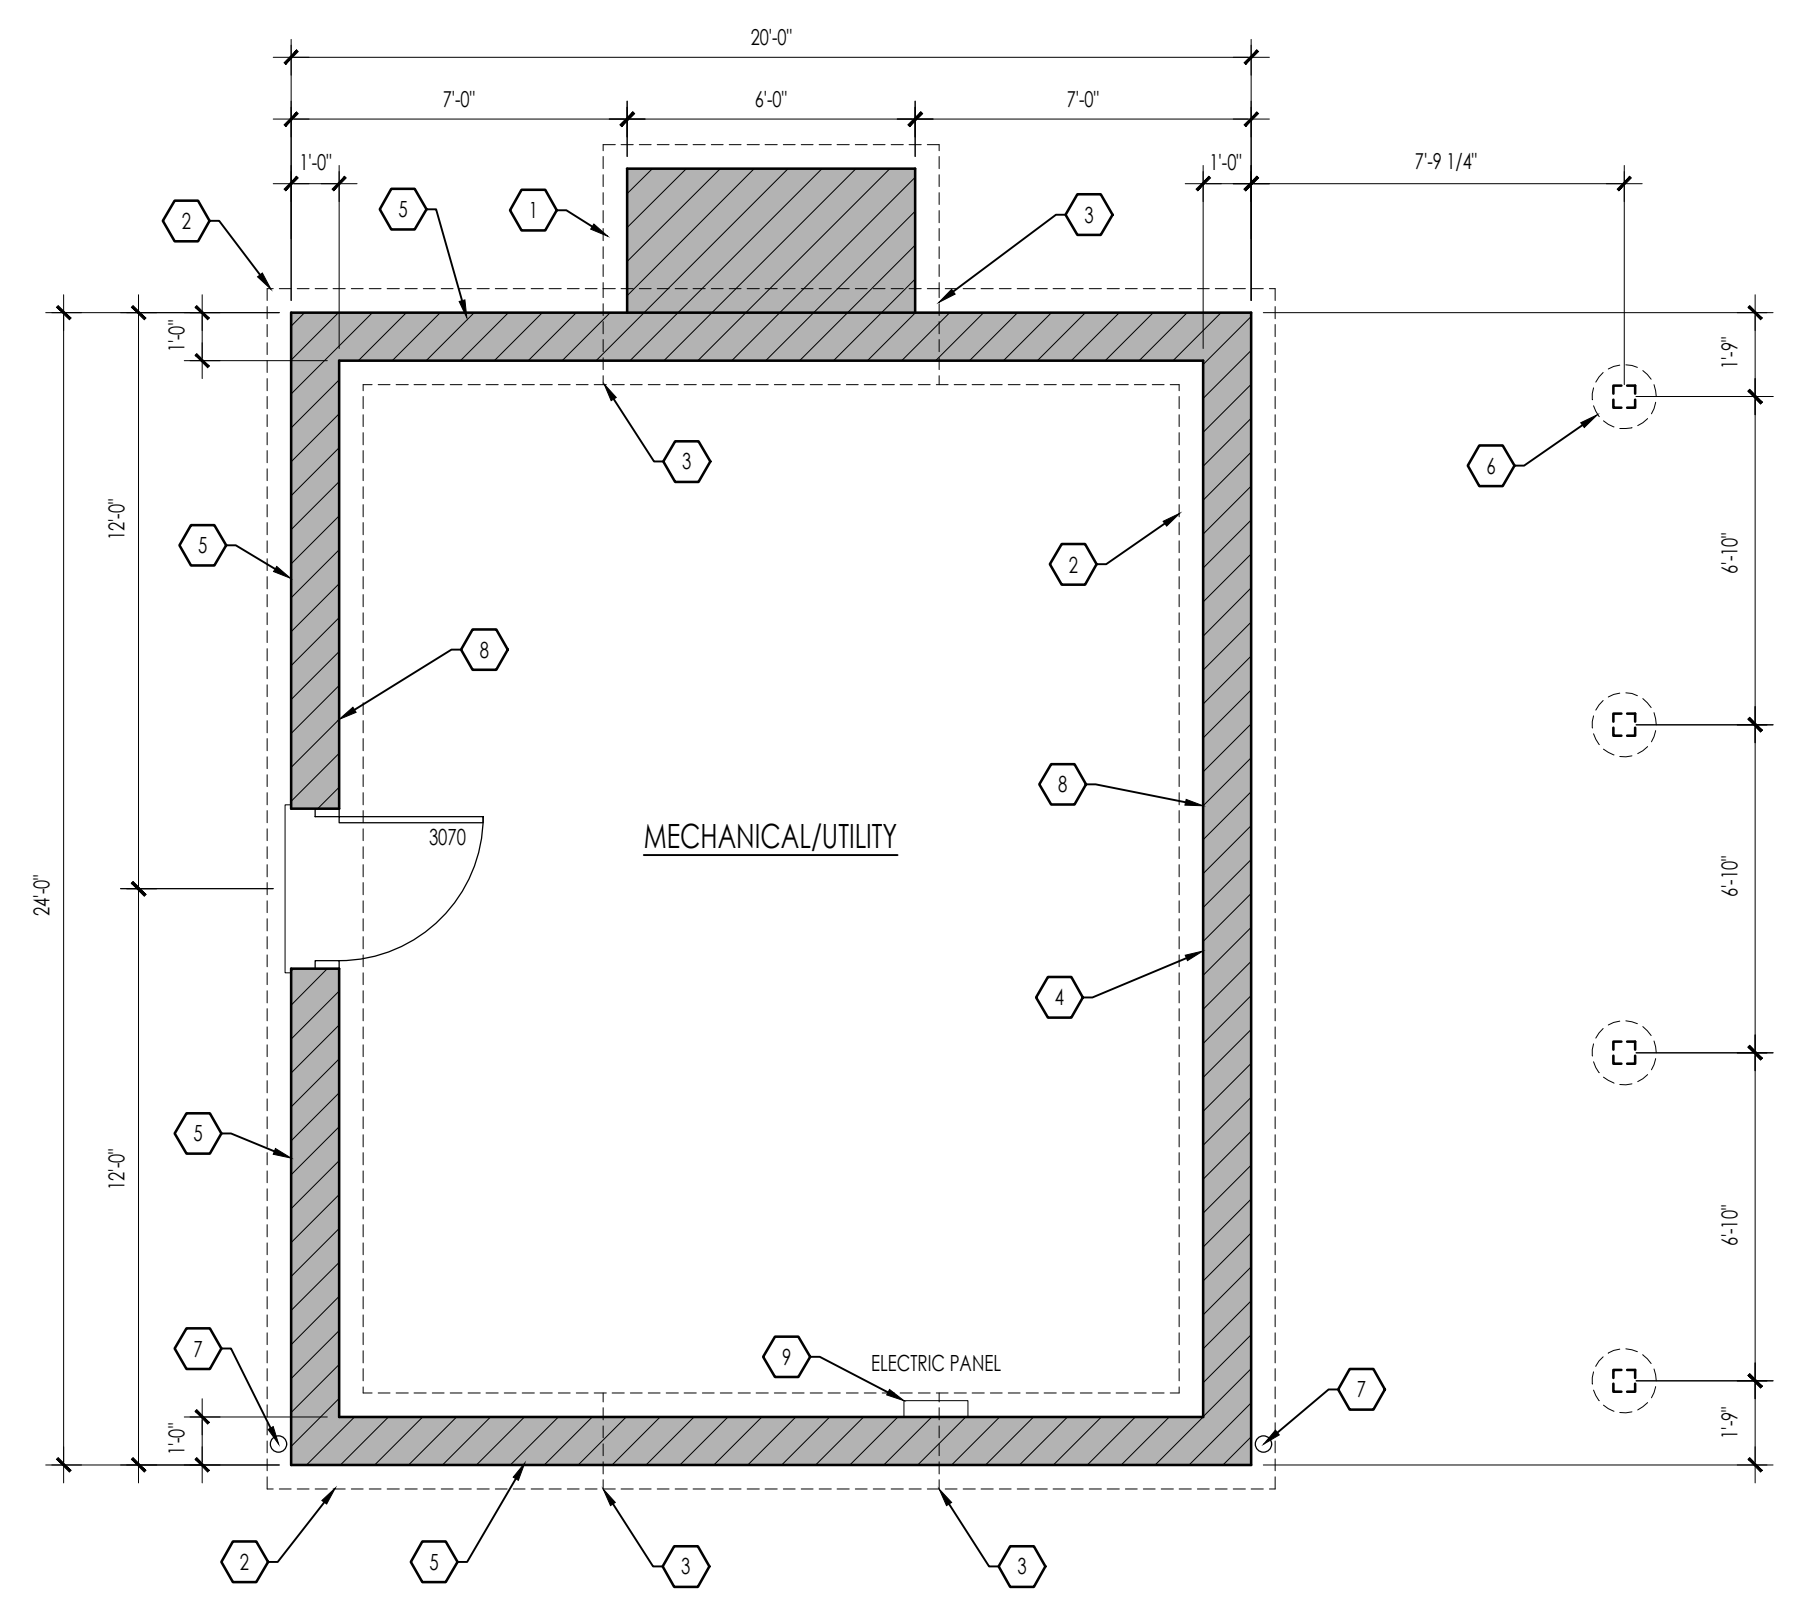


A LOWER LEVEL PLAN
 1/4" = 1'-0"

GENERAL NOTES

- G.C. TO VERIFY QUANTITY & LOCATION OF FIRE EXTINGUISHERS W/ FIRE DEPARTMENT.
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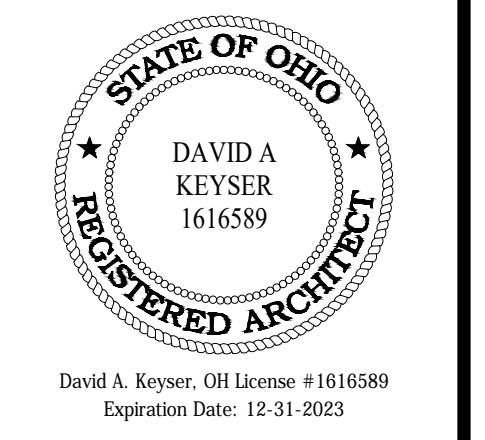
CODED FLOOR PLAN NOTES

- 3'-0"x7'-0" CONC. MATT FOOTING WITH #5 RE-BARS (SEE FOUNDATION PLAN).
- 12"x24" CONC. FOOTING WITH (2) #5 RE-BARS (SEE FOUNDATION PLAN).
- STEP FOOTING AS NEEDED TO STAY 36" BELOW FROST LINE.
- 12" C.M.U. FOUNDATION WALL (SEE FOUNDATION PLAN).
- 8" C.M.U. FOUNDATION WALL WITH 4" STONE VENEER STEPPED TO REMAIN BELOW GRADE 12" C.M.U. BELOW.
- 16" DIA. CONC. FIR. FOR PORCH POST ABOVE. TYP. FOR 4 (SEE FOUNDATION PLAN).
- 4" GALVANIZED DOWNSPOUT CONNECT TO DRAIN TILE.
- UNPAINTED C.M.U. FOUNDATION WALL, TYP.
- ELECTRIC PANEL (SEE ELECTRICAL DRAWINGS).
- RECYCLED WOOD HEWN-LOG WALL CONSTRUCTION WITH NOTCHED CORNERS AND MODERN CHINKING.
- 6x6 ROUGH-CUT WOOD POSTS ON CONC. FIR. TYP. FOR 4 (SEE FOUNDATION PLAN).
- 5/4 x6 ROUGH-CUT WD. PORCH ON TREATED 2X FRAMING (SEE FIRST FLOOR FRAMING PLAN).
- FLUSH STONE HEARTH (SEE INTERIOR ELEVATION).
- FAUX FIREPLACE & CORBELLED STONE MANTLE (SEE INTERIOR ELEVATION).
- ROUGH-CUT WD. STAIR AND FRAMING (SEE INTERIOR ELEVATION).
- WD. WINDOW (SEE OPENING SCHEDULE).
- FLUSH THRESHOLD FOR ACCESSIBLE ENTRY.
- ROUGH-CUT WD. FLOORING.
- 4x4 ROUGH-CUT WD. POSTS RAILING (SEE INTERIOR ELEVATION).
- CEDAR ROOF SHINGLES BELOW.
- FALSE CHIMNEY WITH STONE VENEER.
- ROUGH-CUT WD. CEILING BEAMS ABOVE (SEE REFLECTED CEILING PLANS)

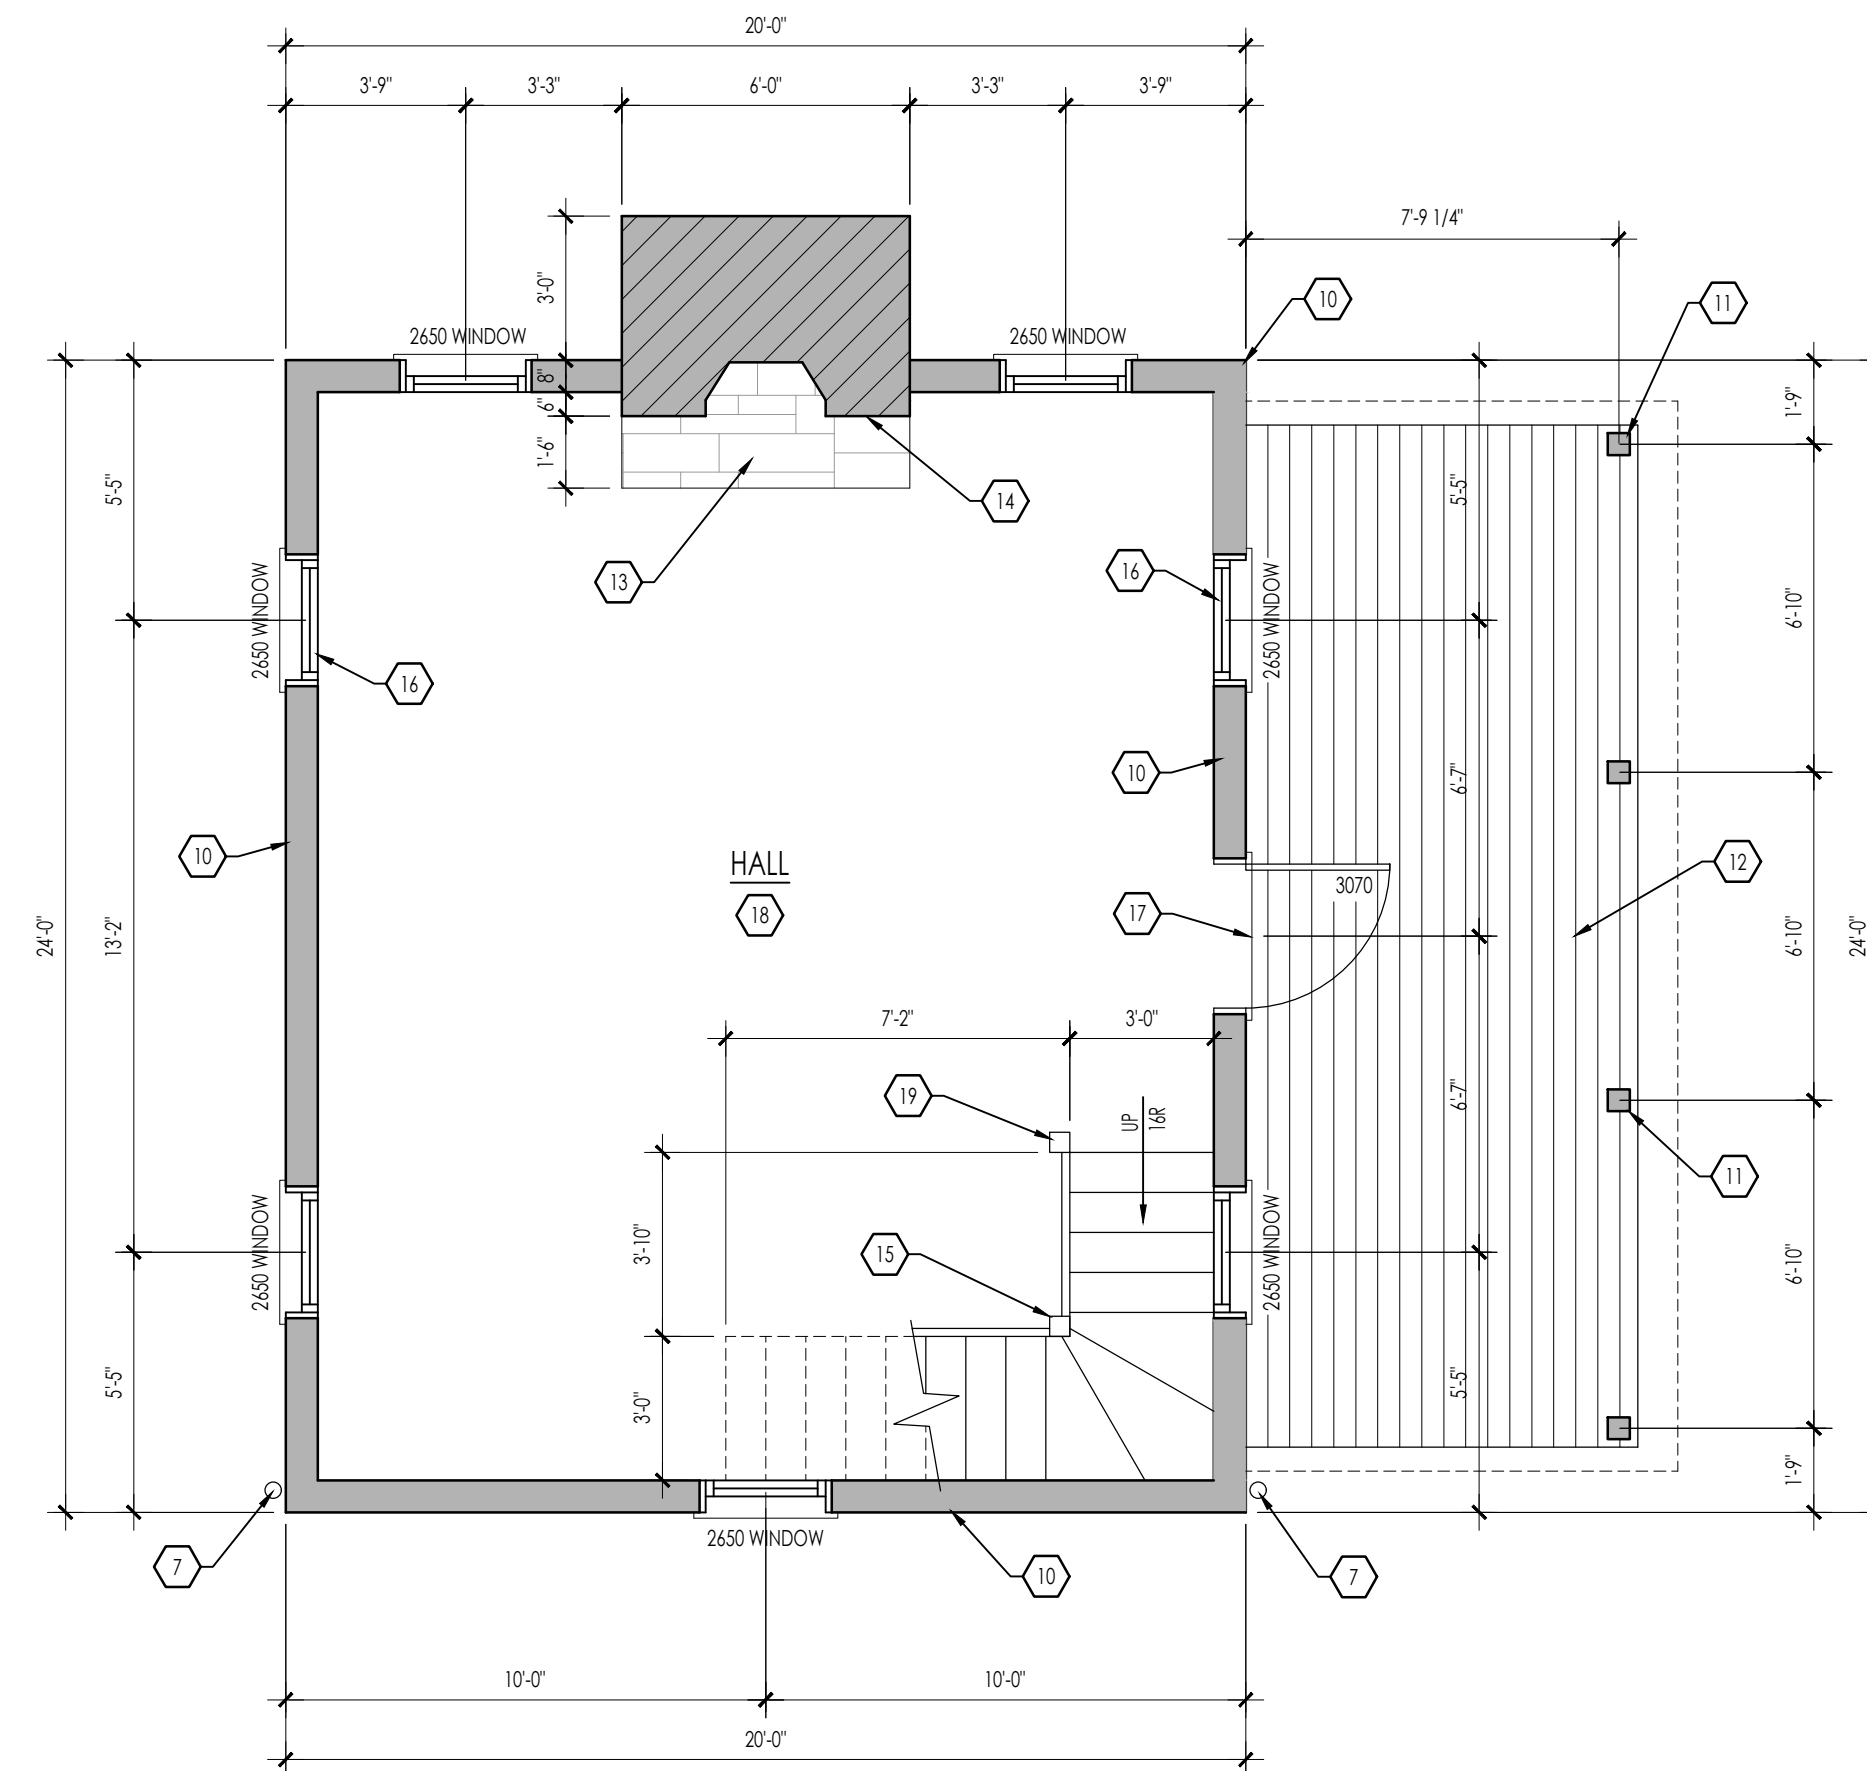

A FIRST FLOOR PLAN
1/4" = 1'-0"

PROJECT:
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SHEET INFORMATION

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Revisions:	

SHEET TITLE

First Floor Plan

SHEET NUMBER


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GENERAL NOTES

- A. G.C. TO VERIFY QUANTITY & LOCATION OF FIRE EXTINGUISHERS W/ FIRE DEPARTMENT.
- B. DIMENSIONS INDICATED AS +/- ARE TO BE FIELD VERIFIED BY THE GENERAL CONTRACTOR PRIOR TO COMMENCEMENT OF WORK.
- C. G.C. TO FILL/SEAL ANY GAPS AT PENETRATIONS AND/OR OPENINGS THRU EXTERIOR WALL.
- D. INDICATED DIMENSIONS ARE TO FINISH SURFACE OF WOOD LOGS OR C.M.U. UNLESS NOTED OTHERWISE.
- E. REFER TO SHEETS T1.02 FOR REQUIRED ACCESSIBLE CLEARANCES AT DOORWAYS.


CODED FLOOR PLAN NOTES

- 1. 3'-0"x7'-0" CONC. MATT FOOTING WITH #5 RE-BARS (SEE FOUNDATION PLAN).
- 2. 12"x4" CONC. FOOTING WITH (2) #5 RE-BARS (SEE FOUNDATION PLAN).
- 3. STEP FOOTING AS NEEDED TO STAY 36" BELOW FROST LINE.
- 4. 12" C.M.U. FOUNDATION WALL (SEE FOUNDATION PLAN).
- 5. 8" C.M.U. FOUNDATION WALL WITH 4" STONE VENEER STEPPED TO REMAIN BELOW GRADE 12" C.M.U. BELOW.
- 6. 1 1/2" DIA. CONC. FR. FOR PORCH POST ABOVE. TYP. FOR 4 (SEE FOUNDATION PLAN).
- 7. 4" GALVANIZED DOWNSPOUT CONNECT TO DRAIN TILE.
- 8. UNPAINTED C.M.U. FOUNDATION WALL. TYP.
- 9. ELECTRIC PANEL (SEE ELECTRICAL DRAWINGS).
- 10. RECYCLED WOOD HEWN-LOG WALL CONSTRUCTION WITH NOTCHED CORNERS AND MODERN CHIMNEY.
- 11. 6x6 ROUGH-CUT WOOD POSTS ON CONC. FR. TYP. FOR 4 (SEE FOUNDATION PLAN).
- 12. 5/4 x4 ROUGH-CUT WD. PORCH ON TREATED 2X FRAMING (SEE FIRST FLOOR FRAMING PLAN).
- 13. FLUSH STONE HEARTH (SEE INTERIOR ELEVATION).
- 14. FAUX FIREPLACE & CORBELLED STONE MANTLE (SEE INTERIOR ELEVATION).
- 15. ROUGH-CUT WD. STAIR AND FRAMING (SEE INTERIOR ELEVATION).
- 16. WD. WINDOW (SEE OPENING SCHEDULE).
- 17. FLUSH THRESHOLD FOR ACCESSIBLE ENTRY.
- 18. ROUGH-CUT WD. FLOORING.
- 19. 4x4 ROUGH-CUT WD. POSTS RAILING (SEE INTERIOR ELEVATION).
- 20. CEDAR ROOF SHINGLES BELOW.
- 21. FALSE CHIMNEY WITH STONE VENEER.
- 22. ROUGH-CUT WD. CEILING BEAMS ABOVE (SEE REFLECTED CEILING PLANS)

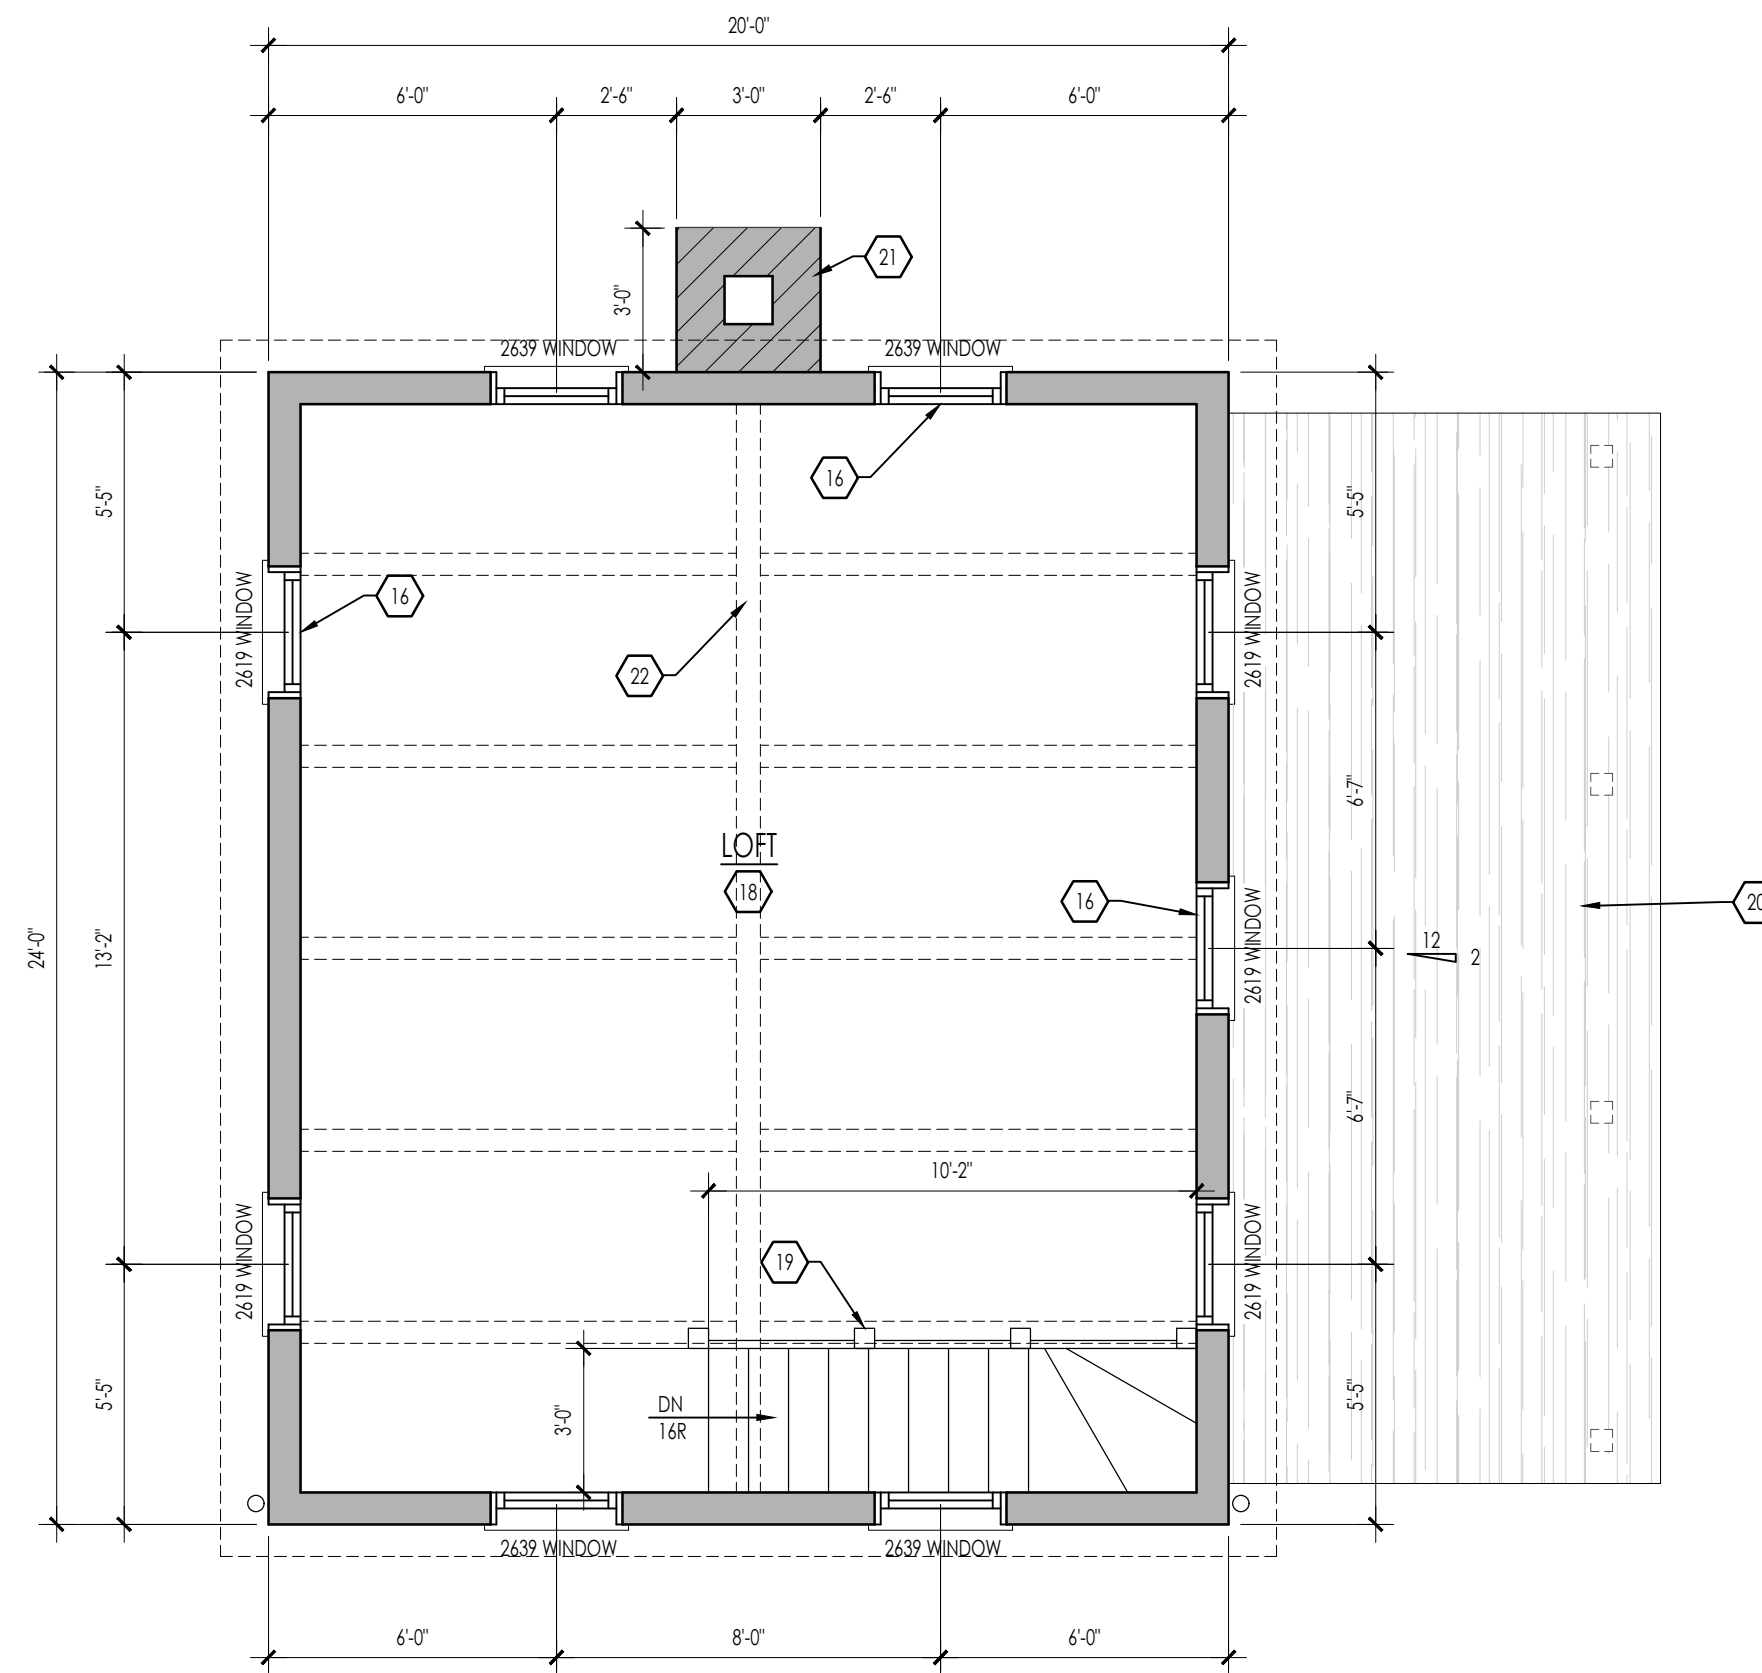

A SECOND FLOOR PLAN
1/4" = 1'-0"

PROJECT:
Relocation & Reconstruction to:
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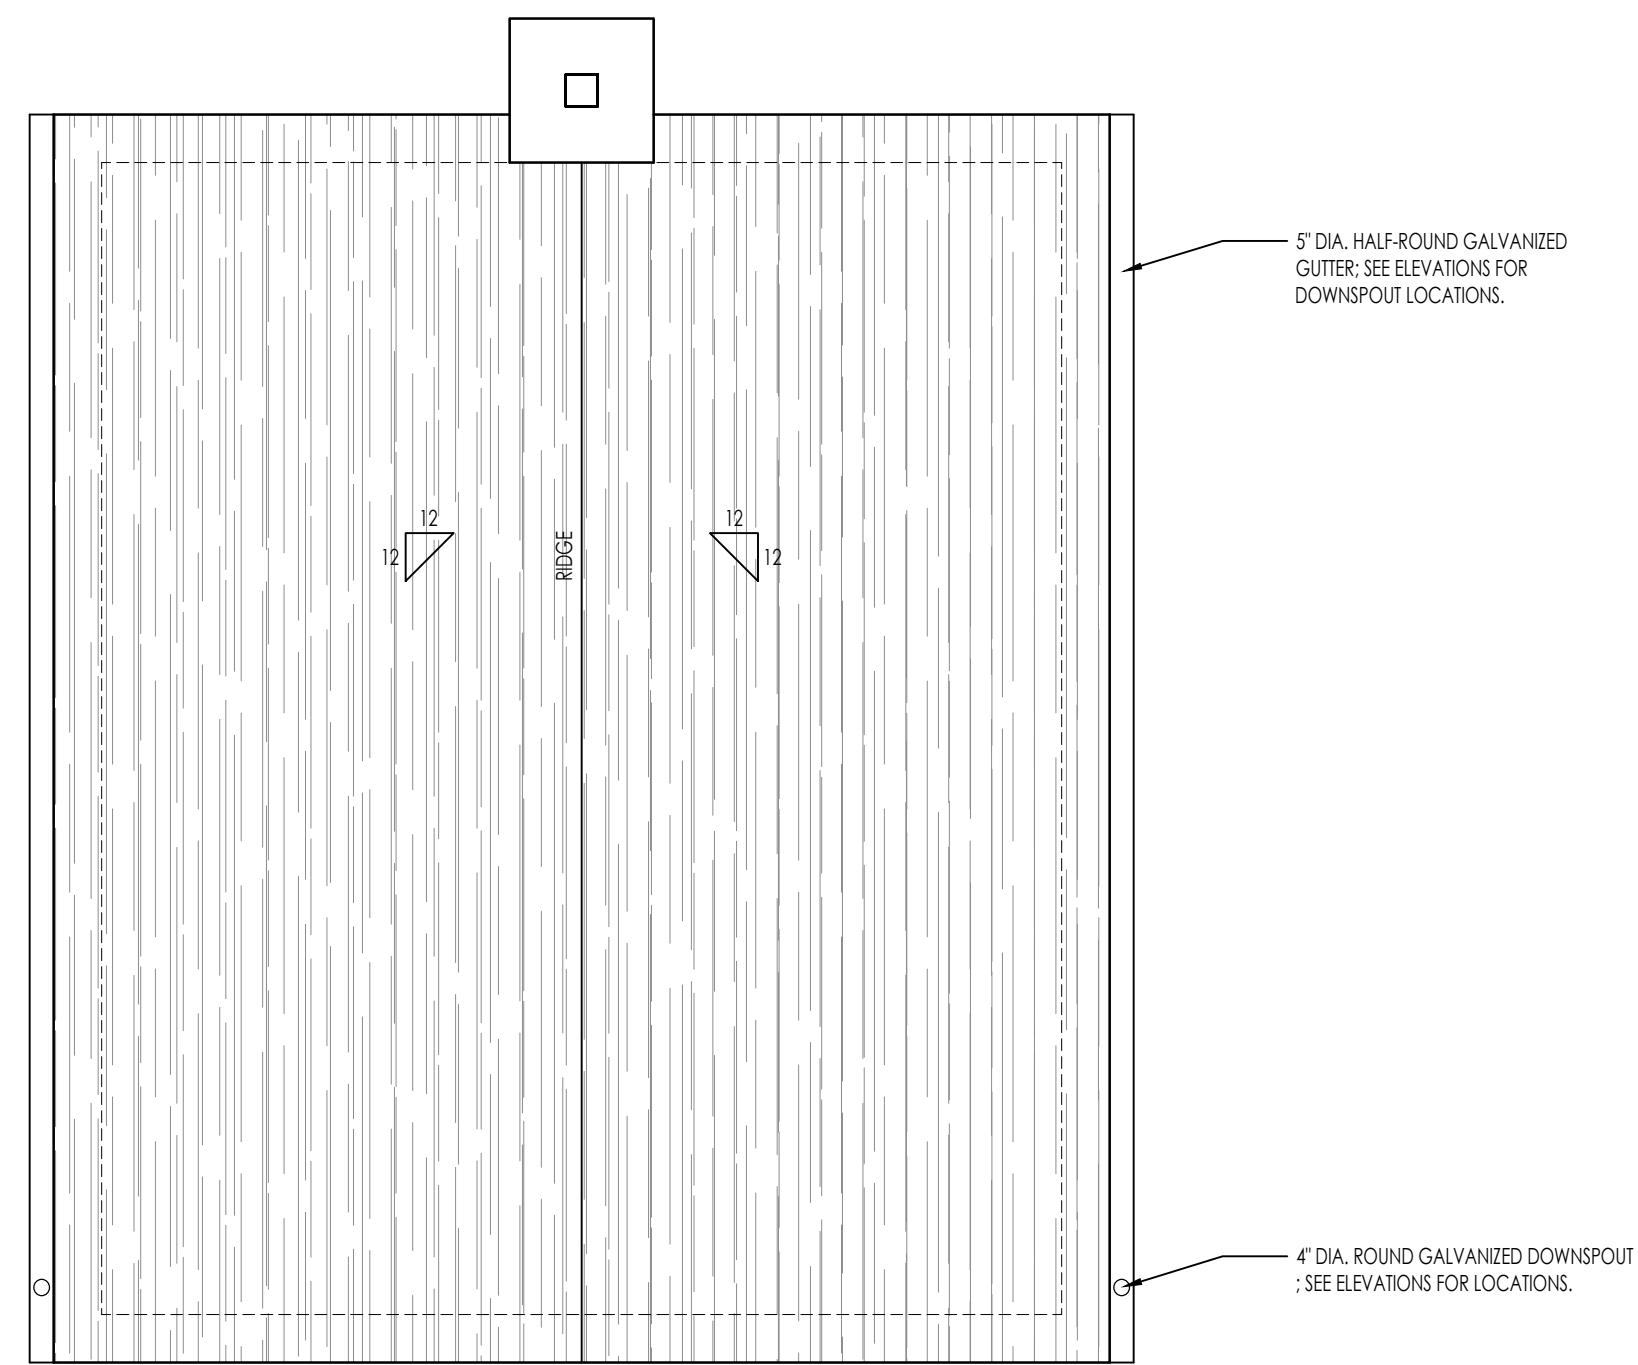
SHEET TITLE

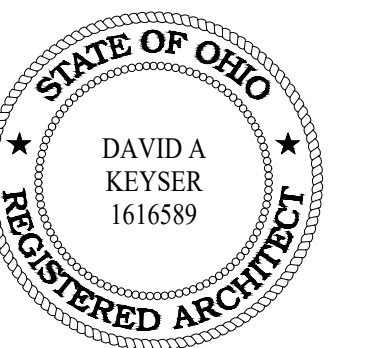Second Floor Plan

SHEET NUMBER

A1.02

dkd ARCHITECTS
52 EAST LYNN STREET, THIRD FLOOR
COLUMBUS, OHIO 43215
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A ROOF PLAN
1/4" = 1'-0"



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SHEET INFORMATION

Project #:	2021-003
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Date:	3/9/22
Revisions:	

SHEET TITLE

Roof Plan

SHEET NUMBER


A1.03

CODÉD CEILING NOTES 

1. UNPAINTED FLOOR FRAMING & DECK, FLOOR NOT RATED.
2. FLOOR FRAMING TO BE COVERED WITH 1x6 ROUGH-CUT BOARDS.
3. FAUX ROUGH-CUT BEAMS 4x8 ATTACHED TO FLOOR FRAMING ABOVE.
4. ROOF RAFTERS TO BE COVERED WITH 1x6 ROUGH-CUT BOARDS.
5. TRIM COLLAR TIES WITH ROUGH-CUT 1x TRIM BOARDS.
6. FAUX ROUGH-CUT BEAMS 4x8 ATTACHED TO ROOF FRAMING ABOVE.
7. LOCATE LIGHT FIXTURE IN CENTER OF SPACE BETWEEN BEAMS.
8. LOCATE LIGHT FIXTURE IN CENTER OF SPACE BETWEEN BEAMS.
9. SMOKE ALARM DEVICE. REFER TO ELECTRICAL DRAWINGS.

GENERAL CEILING NOTES

- a. ARCHITECTURAL REFLECTED CEILING PLAN INTENDED TO SHOW LOCATION OF LIGHT FIXTURES AND DEVICES. REFER TO ELECTRICAL DRAWINGS FOR FIXTURE DESIGNATIONS & SPECIFICATIONS.
- b. MOUNTING HEIGHTS LISTED ARE TO BOTTOM OF FIXTURE FOR CEILING MOUNTS, AND CENTER OF J-BOX FOR WALL MOUNTS.

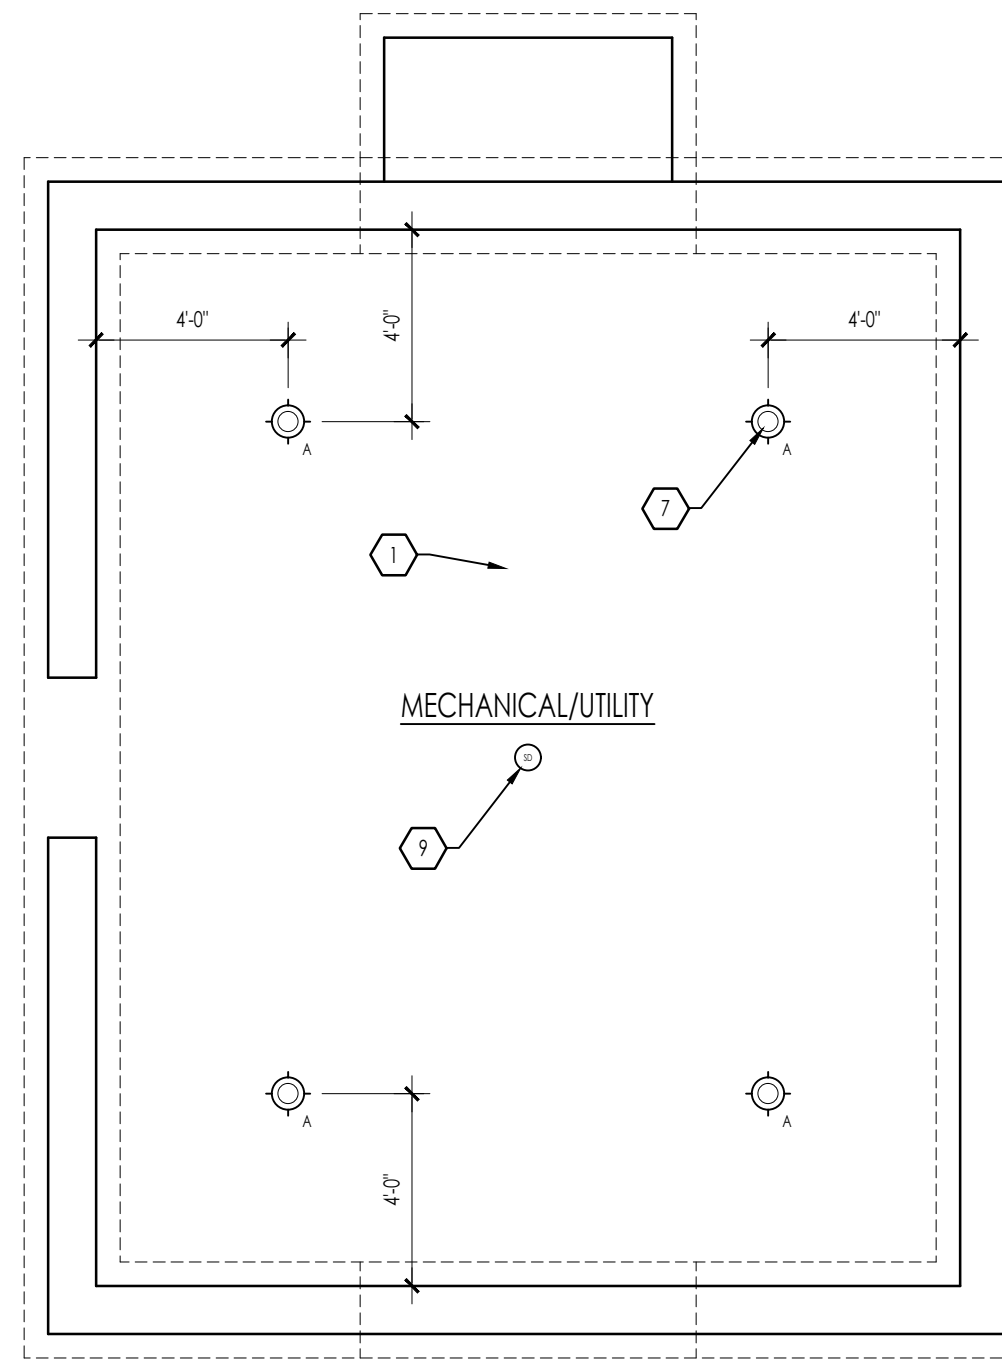

A LOWER LEVEL REFLECTED CEILING PLAN 1/4" = 1'-0"

PROJECT:
Relocation & Reconstruction to:
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Historic Log Cabin
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Dublin, Ohio 43016



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Revisions:


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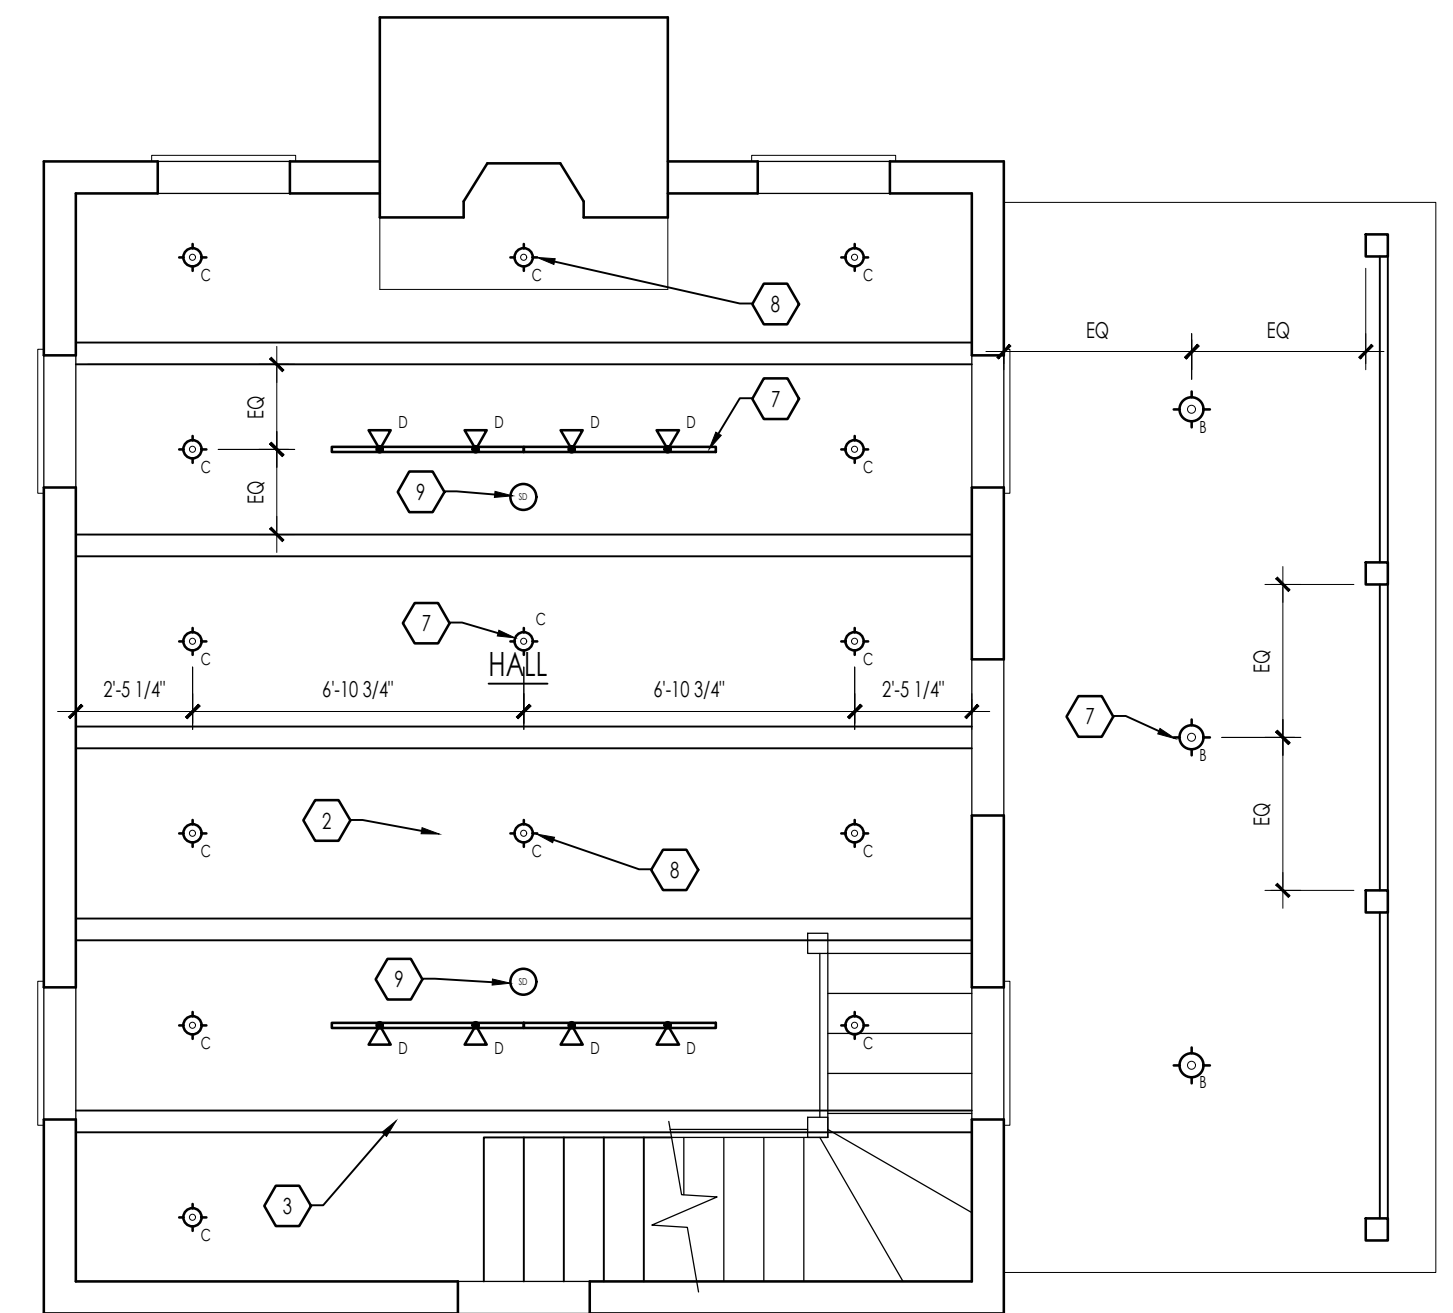
Lower Level
Reflected Ceiling
Plan

SHEET NUMBER

A2.00

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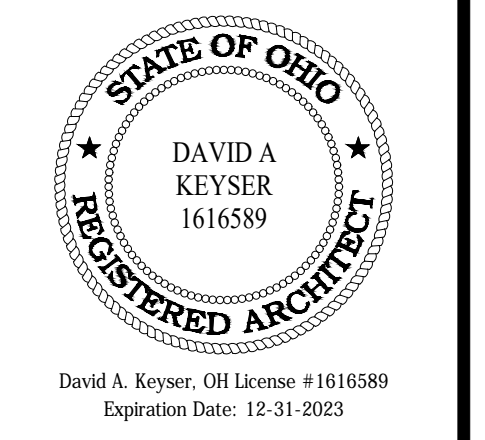
- CODED CEILING NOTES** 
1. UNPAINTED FLOOR FRAMING & DECK, FLOOR NOT RATED.
 2. FLOOR FRAMING TO BE COVERED WITH 1x6 ROUGH-CUT BOARDS.
 3. FAUX ROUGH-CUT BEAMS 4x8 ATTACHED TO FLOOR FRAMING ABOVE.
 4. ROOF RAFTERS TO BE COVERED WITH 1x6 ROUGH-CUT BOARDS.
 5. TRIM COLLAR TIES WITH ROUGH-CUT 1x TRIM BOARDS.
 6. FAUX ROUGH-CUT BEAMS 4x8 ATTACHED TO ROOF FRAMING ABOVE.
 7. LOCATE LIGHT FIXTURE AS DIMENSIONED.
 8. LOCATE LIGHT FIXTURE IN CENTER OF SPACE BETWEEN BEAMS.
 9. SMOKE ALARM DEVICE. REFER TO ELECTRICAL DRAWINGS.
- GENERAL CEILING NOTES**
- a. ARCHITECTURAL REFLECTED CEILING PLAN INTENDED TO SHOW LOCATION OF LIGHT FIXTURES AND DEVICES. REFER TO ELECTRICAL DRAWINGS FOR FIXTURE DESIGNATIONS & SPECIFICATIONS.
 - b. MOUNTING HEIGHTS LISTED ARE TO BOTTOM OF FIXTURE FOR CEILING MOUNTS, AND CENTER OF J-BOX FOR WALL MOUNTS.

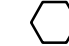

A FIRST FLOOR REFLECTED CEILING PLAN  $1/4" = 1'-0"$

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 CLEVELAND, OHIO 43215
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PROJECT:
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SHEET INFORMATION

Project #:	2021-003
Issued For:	Progress
Date:	3/9/22
Revisions:	

SHEET TITLE

First Floor
 Reflected Ceiling
 Plan

SHEET NUMBER

A2.01

CODED CEILING NOTES 

1. UNPAINTED FLOOR FRAMING & DECK, FLOOR NOT RATED.
2. FLOOR FRAMING TO BE COVERED WITH 1x6 ROUGH-CUT BOARDS.
3. FAUX ROUGH-CUT BEAMS 4x8 ATTACHED TO FLOOR FRAMING ABOVE.
4. ROOF RAFTERS TO BE COVERED WITH 1x6 ROUGH-CUT BOARDS.
5. TRIM COLLAR TIES WITH ROUGH-CUT 1x TRIM BOARDS.
6. FAUX ROUGH-CUT BEAMS 4x8 ATTACHED TO ROOF FRAMING ABOVE.
7. LOCATE LIGHT FIXTURE AS DIMENSIONED.
8. LOCATE LIGHT FIXTURE IN CENTER OF SPACE BETWEEN BEAMS.
9. SMOKE ALARM DEVICE. REFER TO ELECTRICAL DRAWINGS.

GENERAL CEILING NOTES

- a. ARCHITECTURAL REFLECTED CEILING PLAN INTENDED TO SHOW LOCATION OF LIGHT FIXTURES AND DEVICES. REFER TO ELECTRICAL DRAWINGS FOR FIXTURE DESIGNATIONS & SPECIFICATIONS.
- b. MOUNTING HEIGHTS LISTED ARE TO BOTTOM OF FIXTURE FOR CEILING MOUNTS, AND CENTER OF JBOX FOR WALL MOUNTS.

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PROJECT:
 Relocation & Reconstruction to:
 The City of Dublin
Historic Log Cabin
 7125 Riverside Drive
 Dublin, Ohio 43016



David A. Keyser, OH License # 1616589
 Expiration Date: 12-31-2023

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SHEET INFORMATION


Project #:	2021-003
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Date:	3/9/22
Revisions:	

SHEET TITLE


Second Floor
 Reflected Ceiling
 Plan

SHEET NUMBER


A2.02

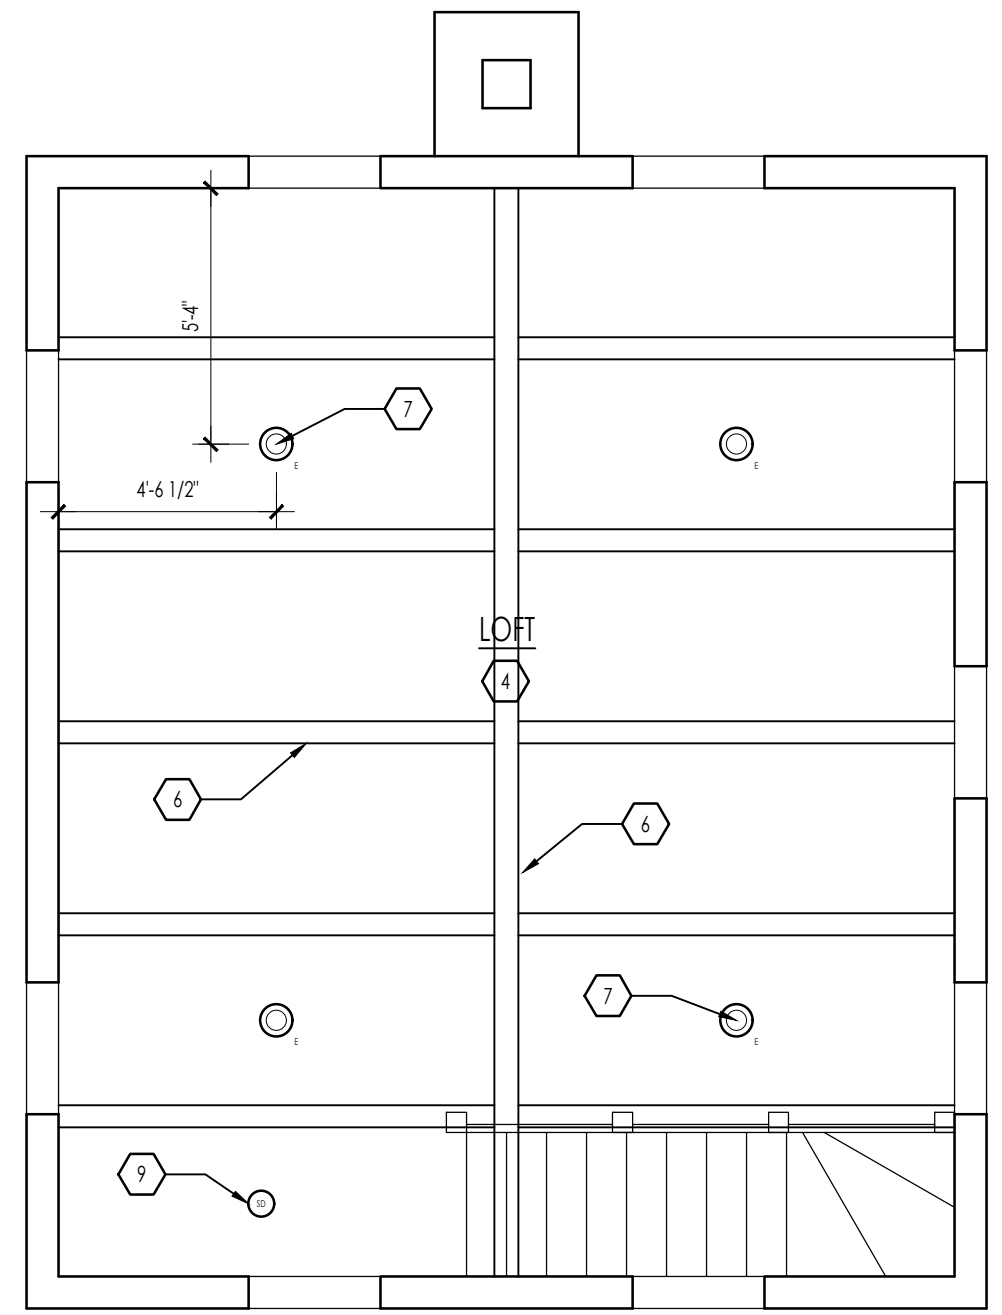

A SECOND FLOOR REFLECTED CEILING PLAN 
 1/4" = 1'-0"

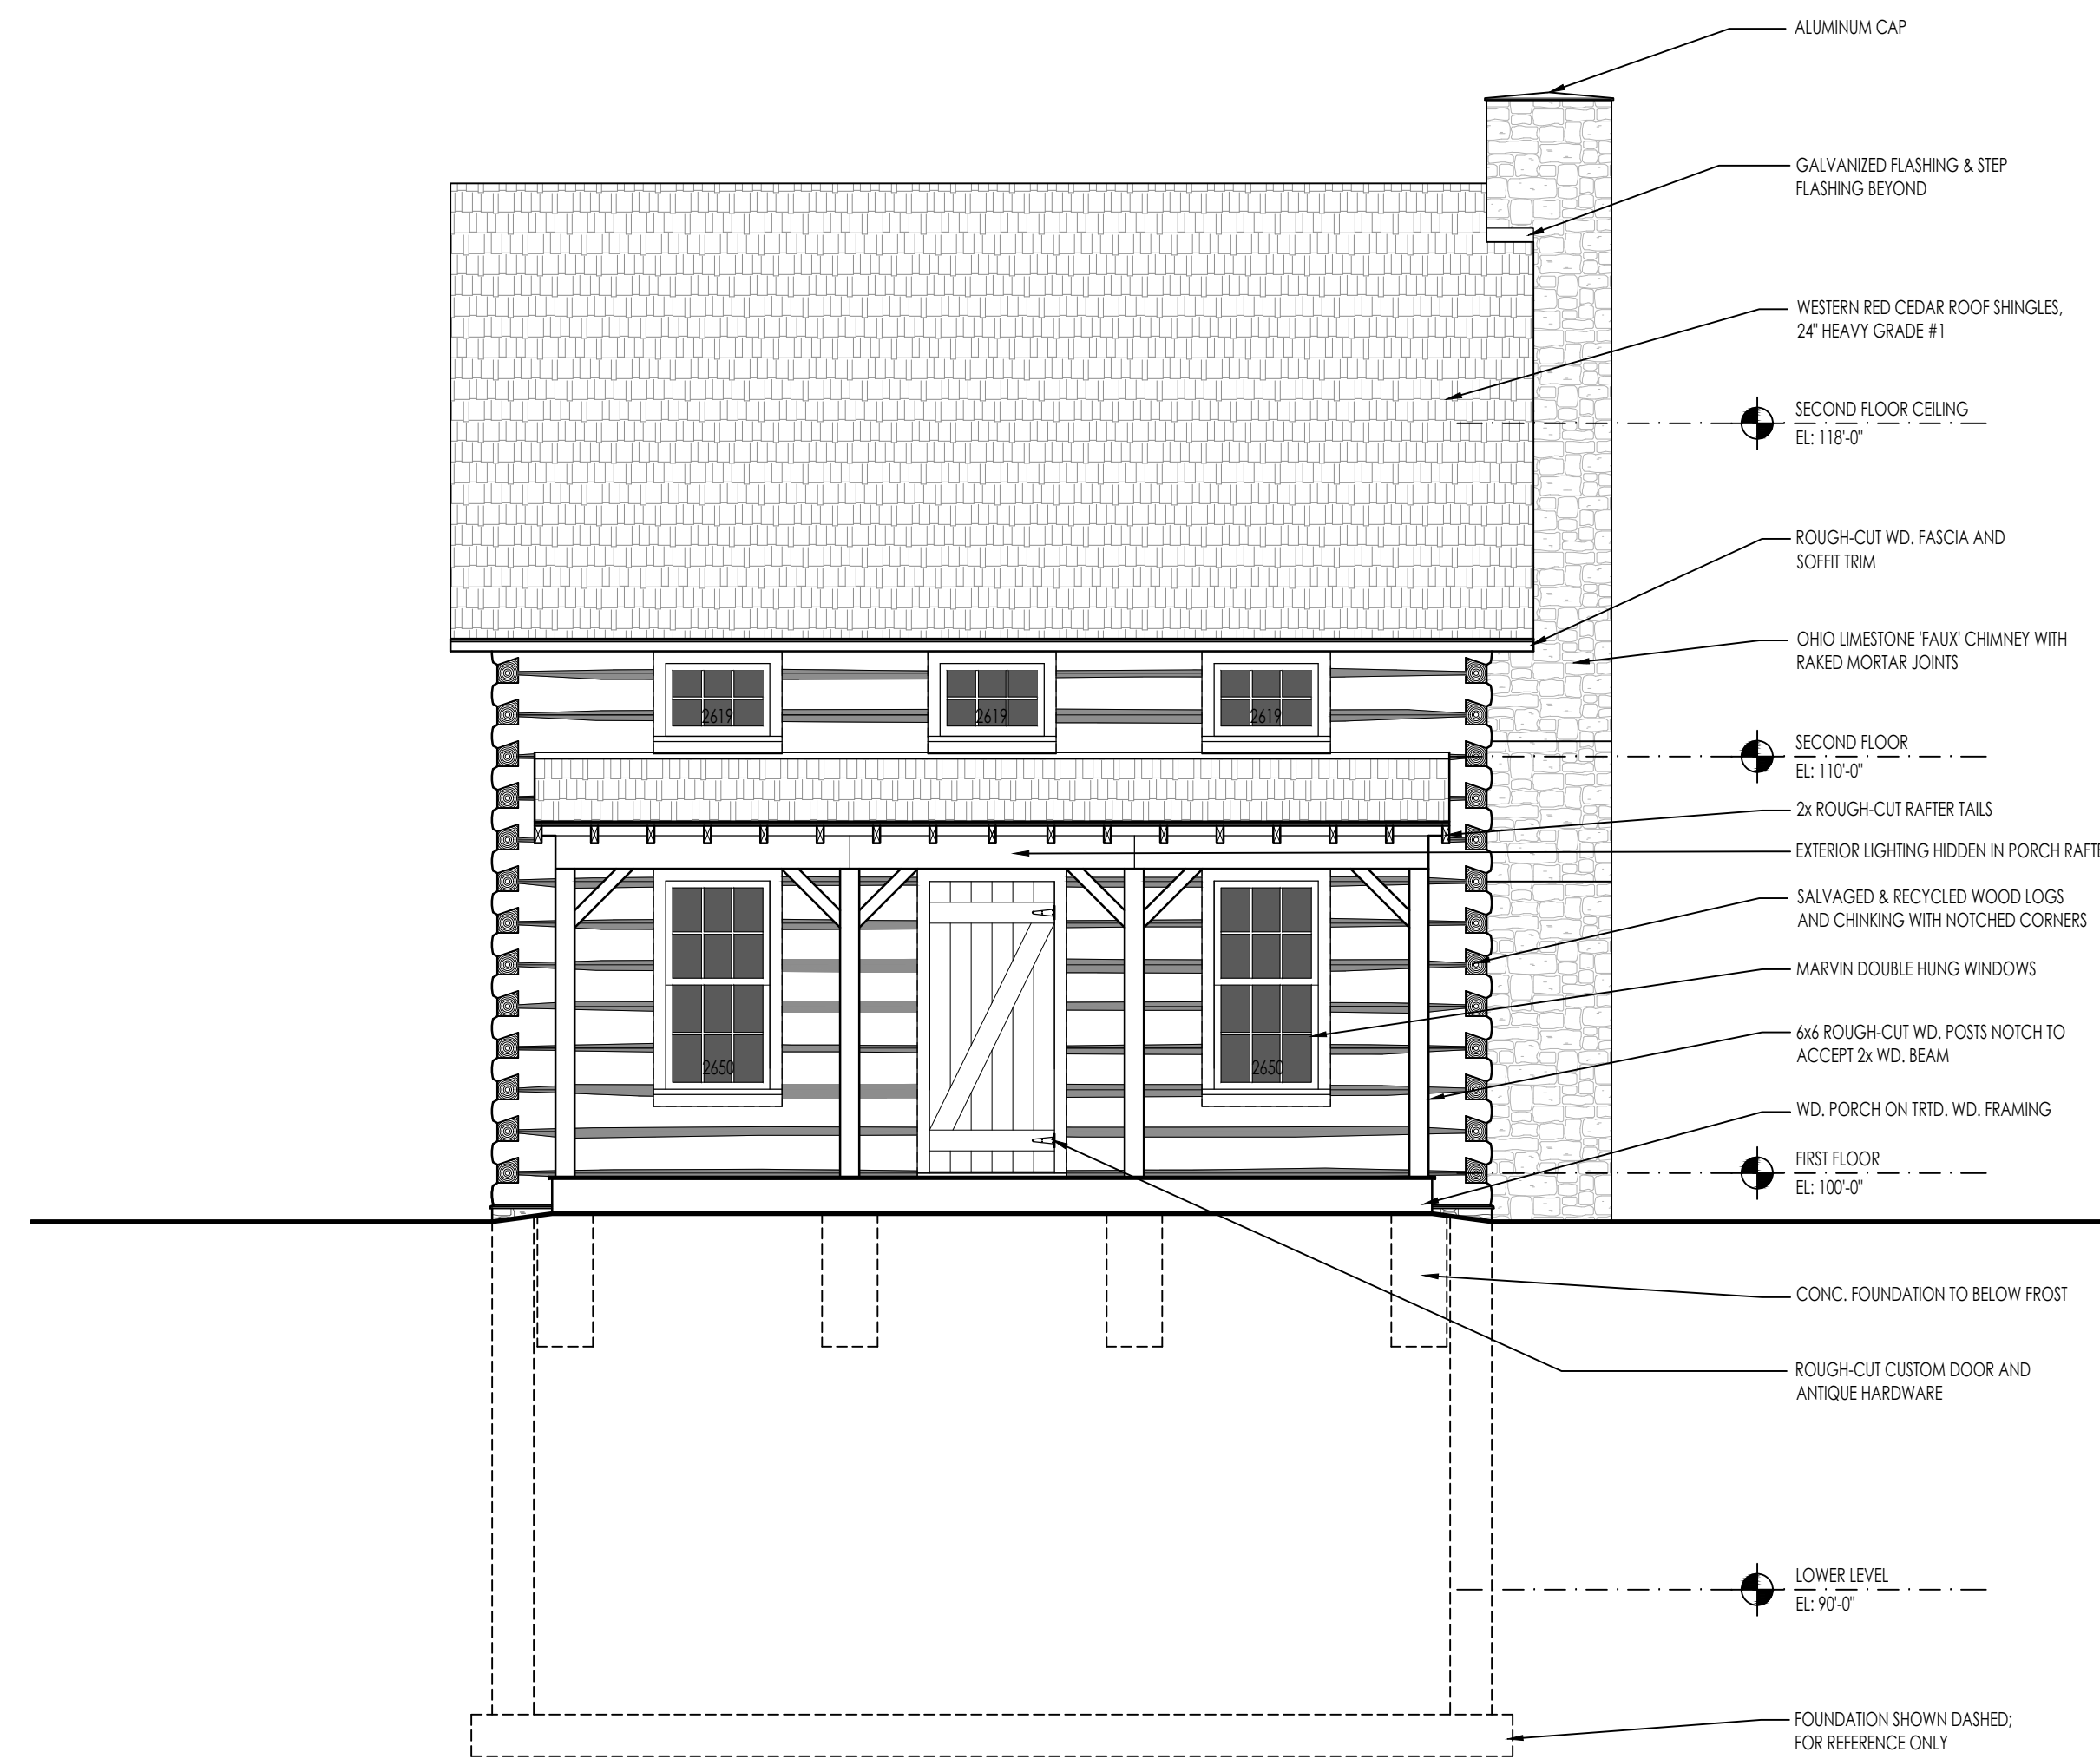


B EAST ELEVATION
 1/4" = 1'-0"

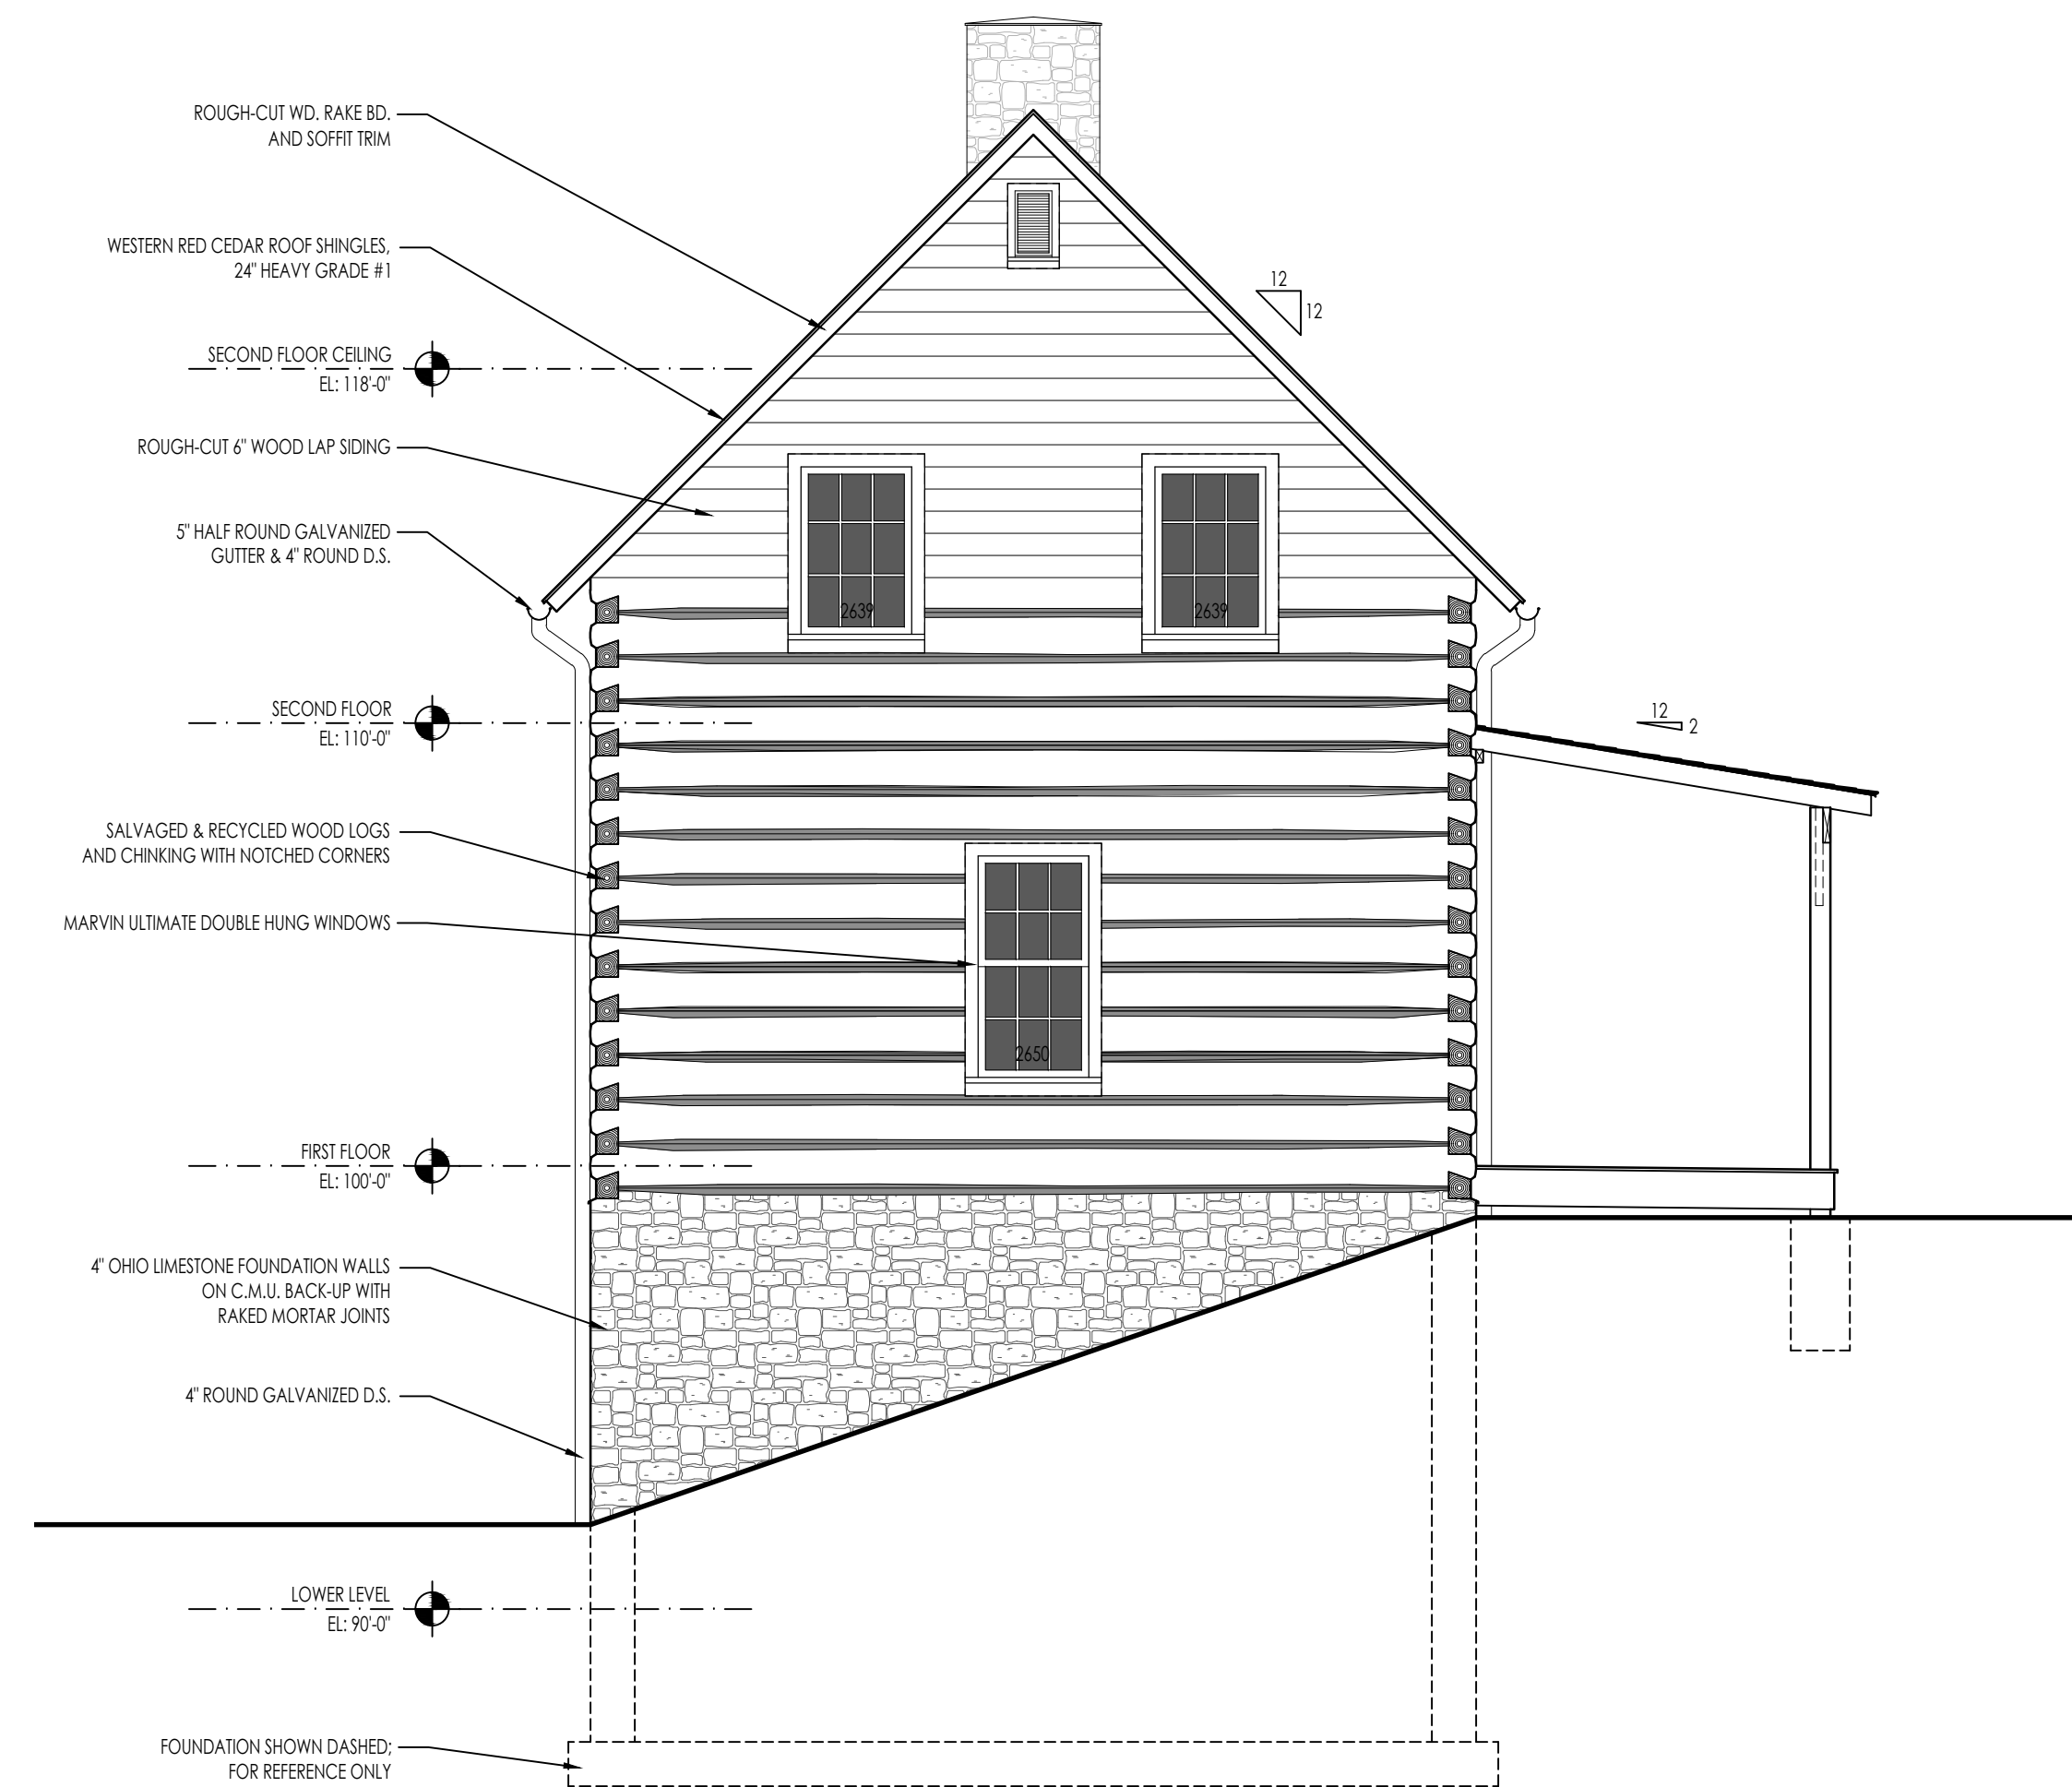

A SOUTH ELEVATION
 1/4" = 1'-0"

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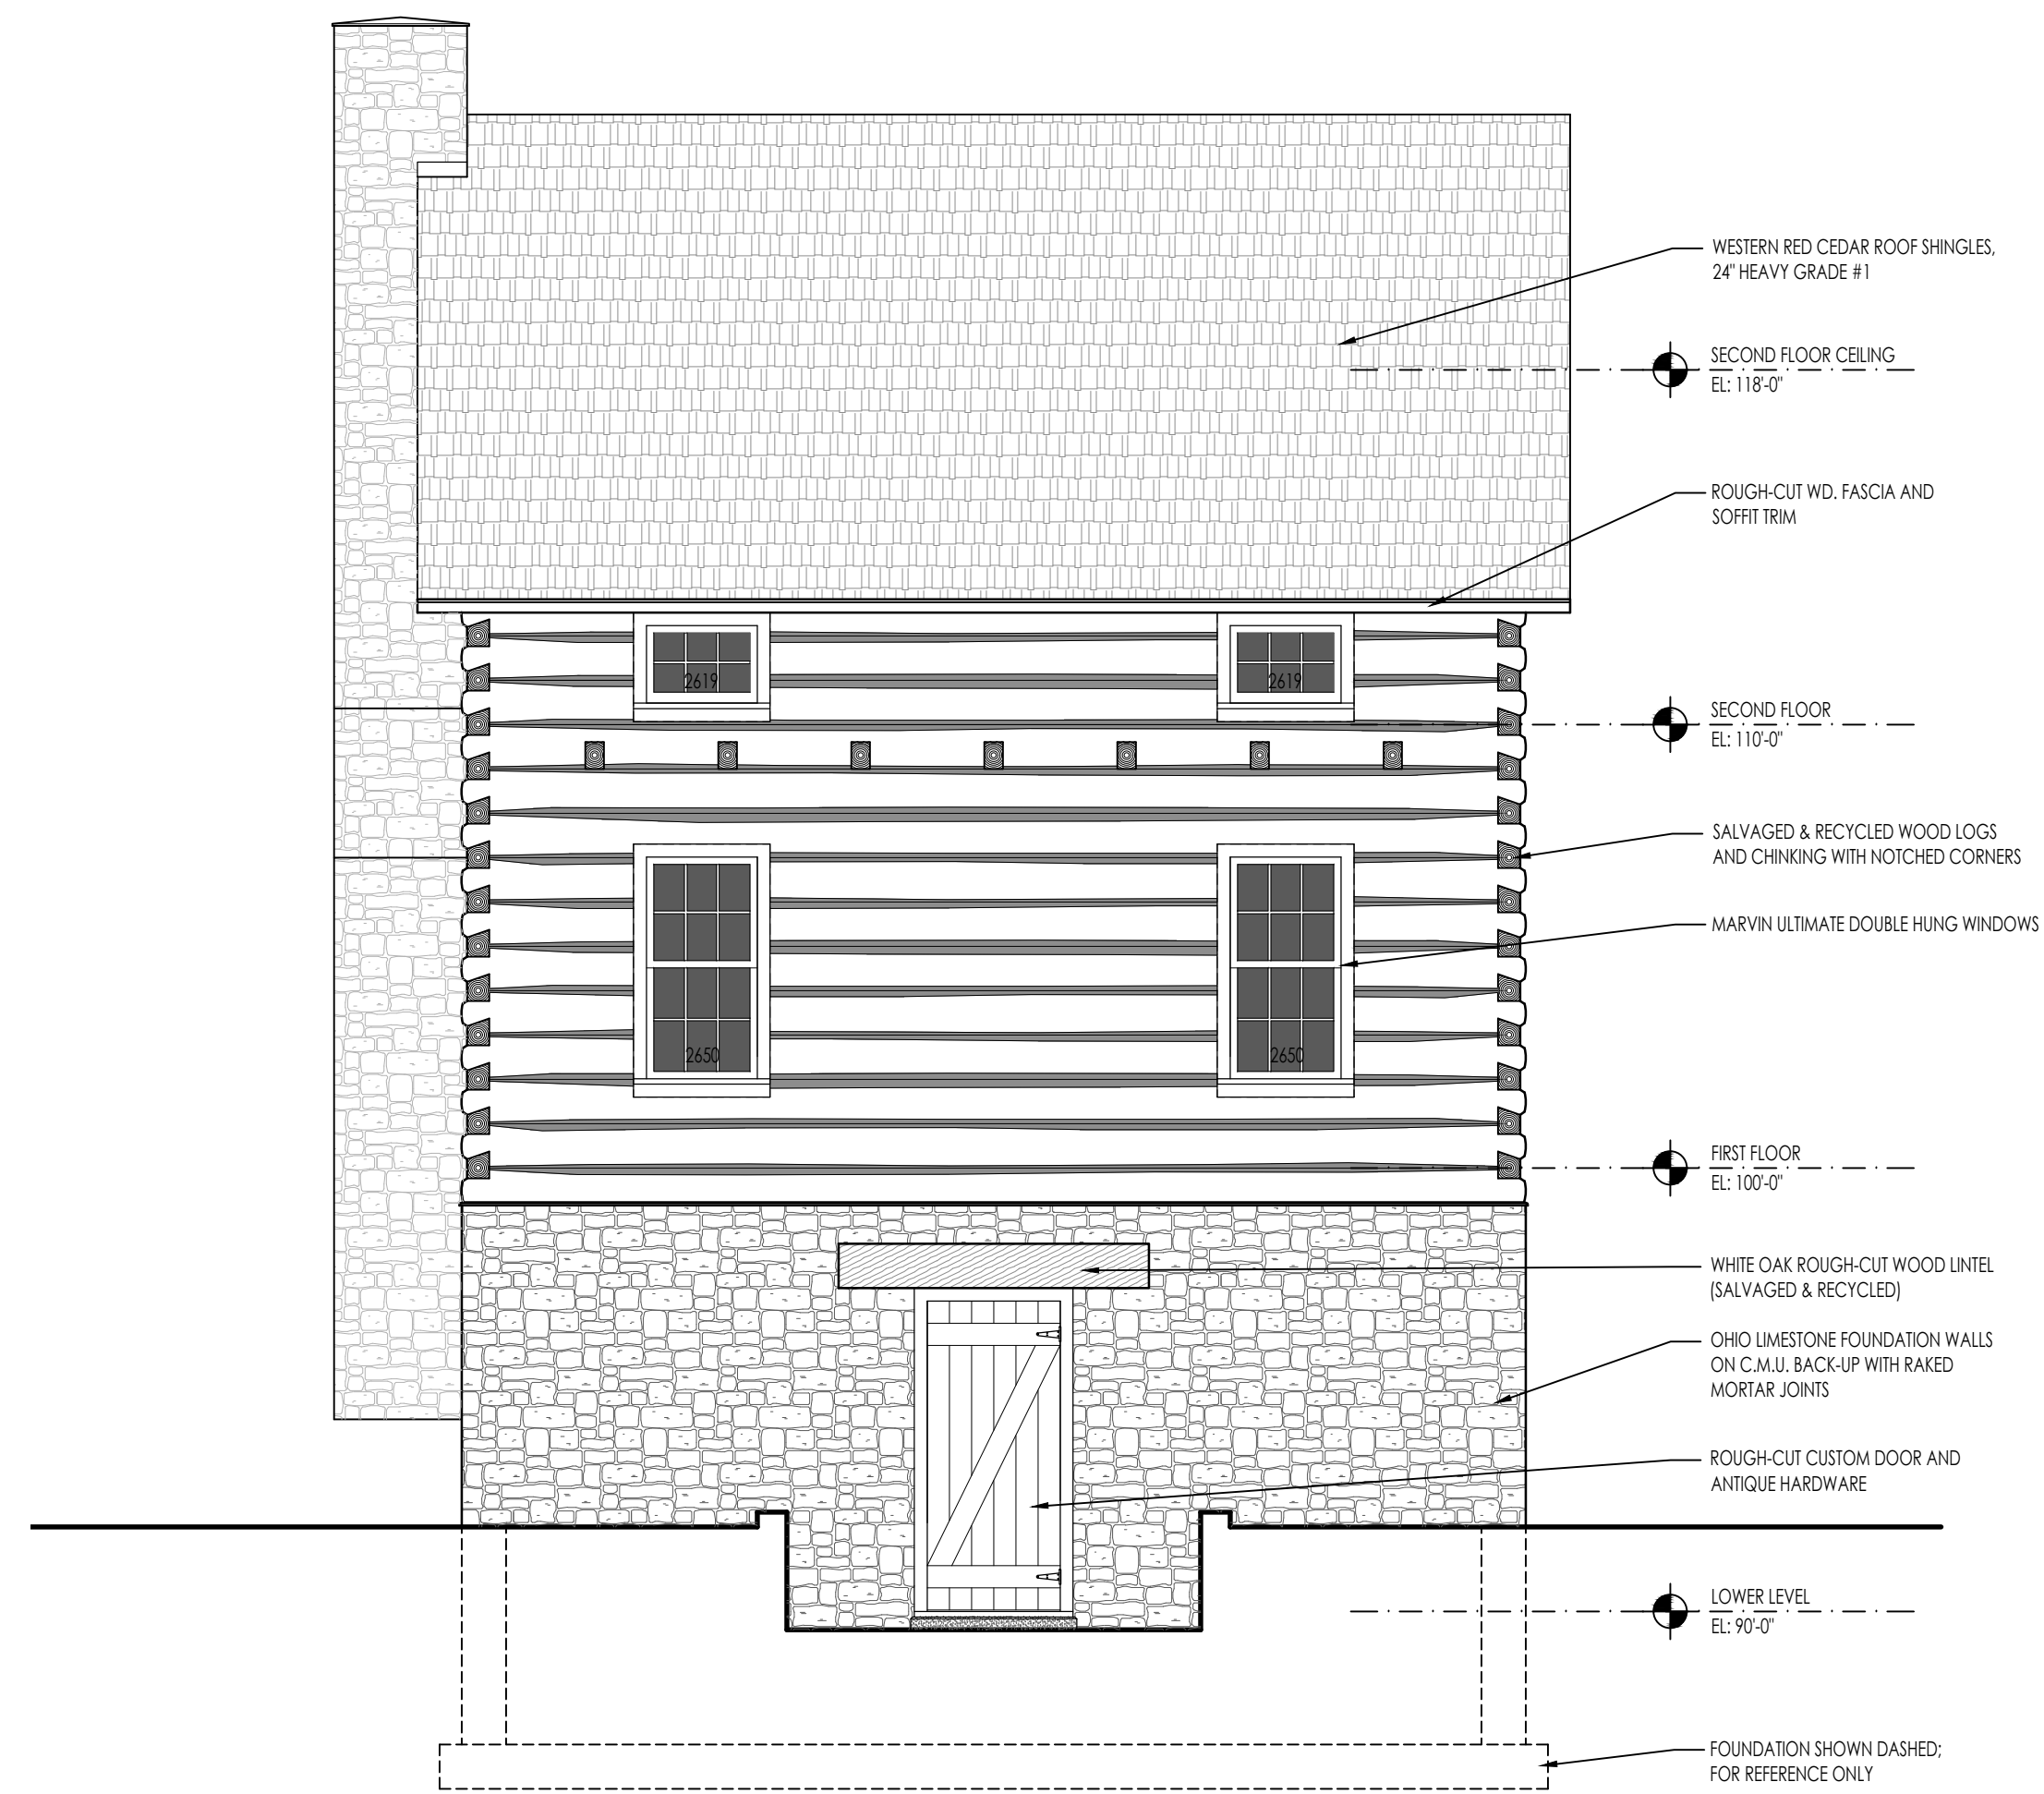
Project #:	2021-003
Issued For:	Permit
Date:	4/7/22
Revisions:	

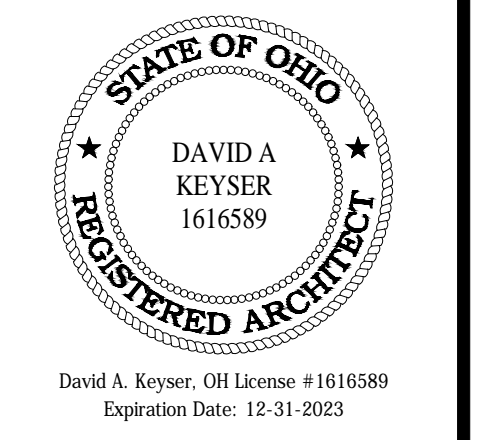SHEET TITLE


Exterior Elevations

SHEET NUMBER

A3.01




B WEST ELEVATION
1/4" = 1'-0"

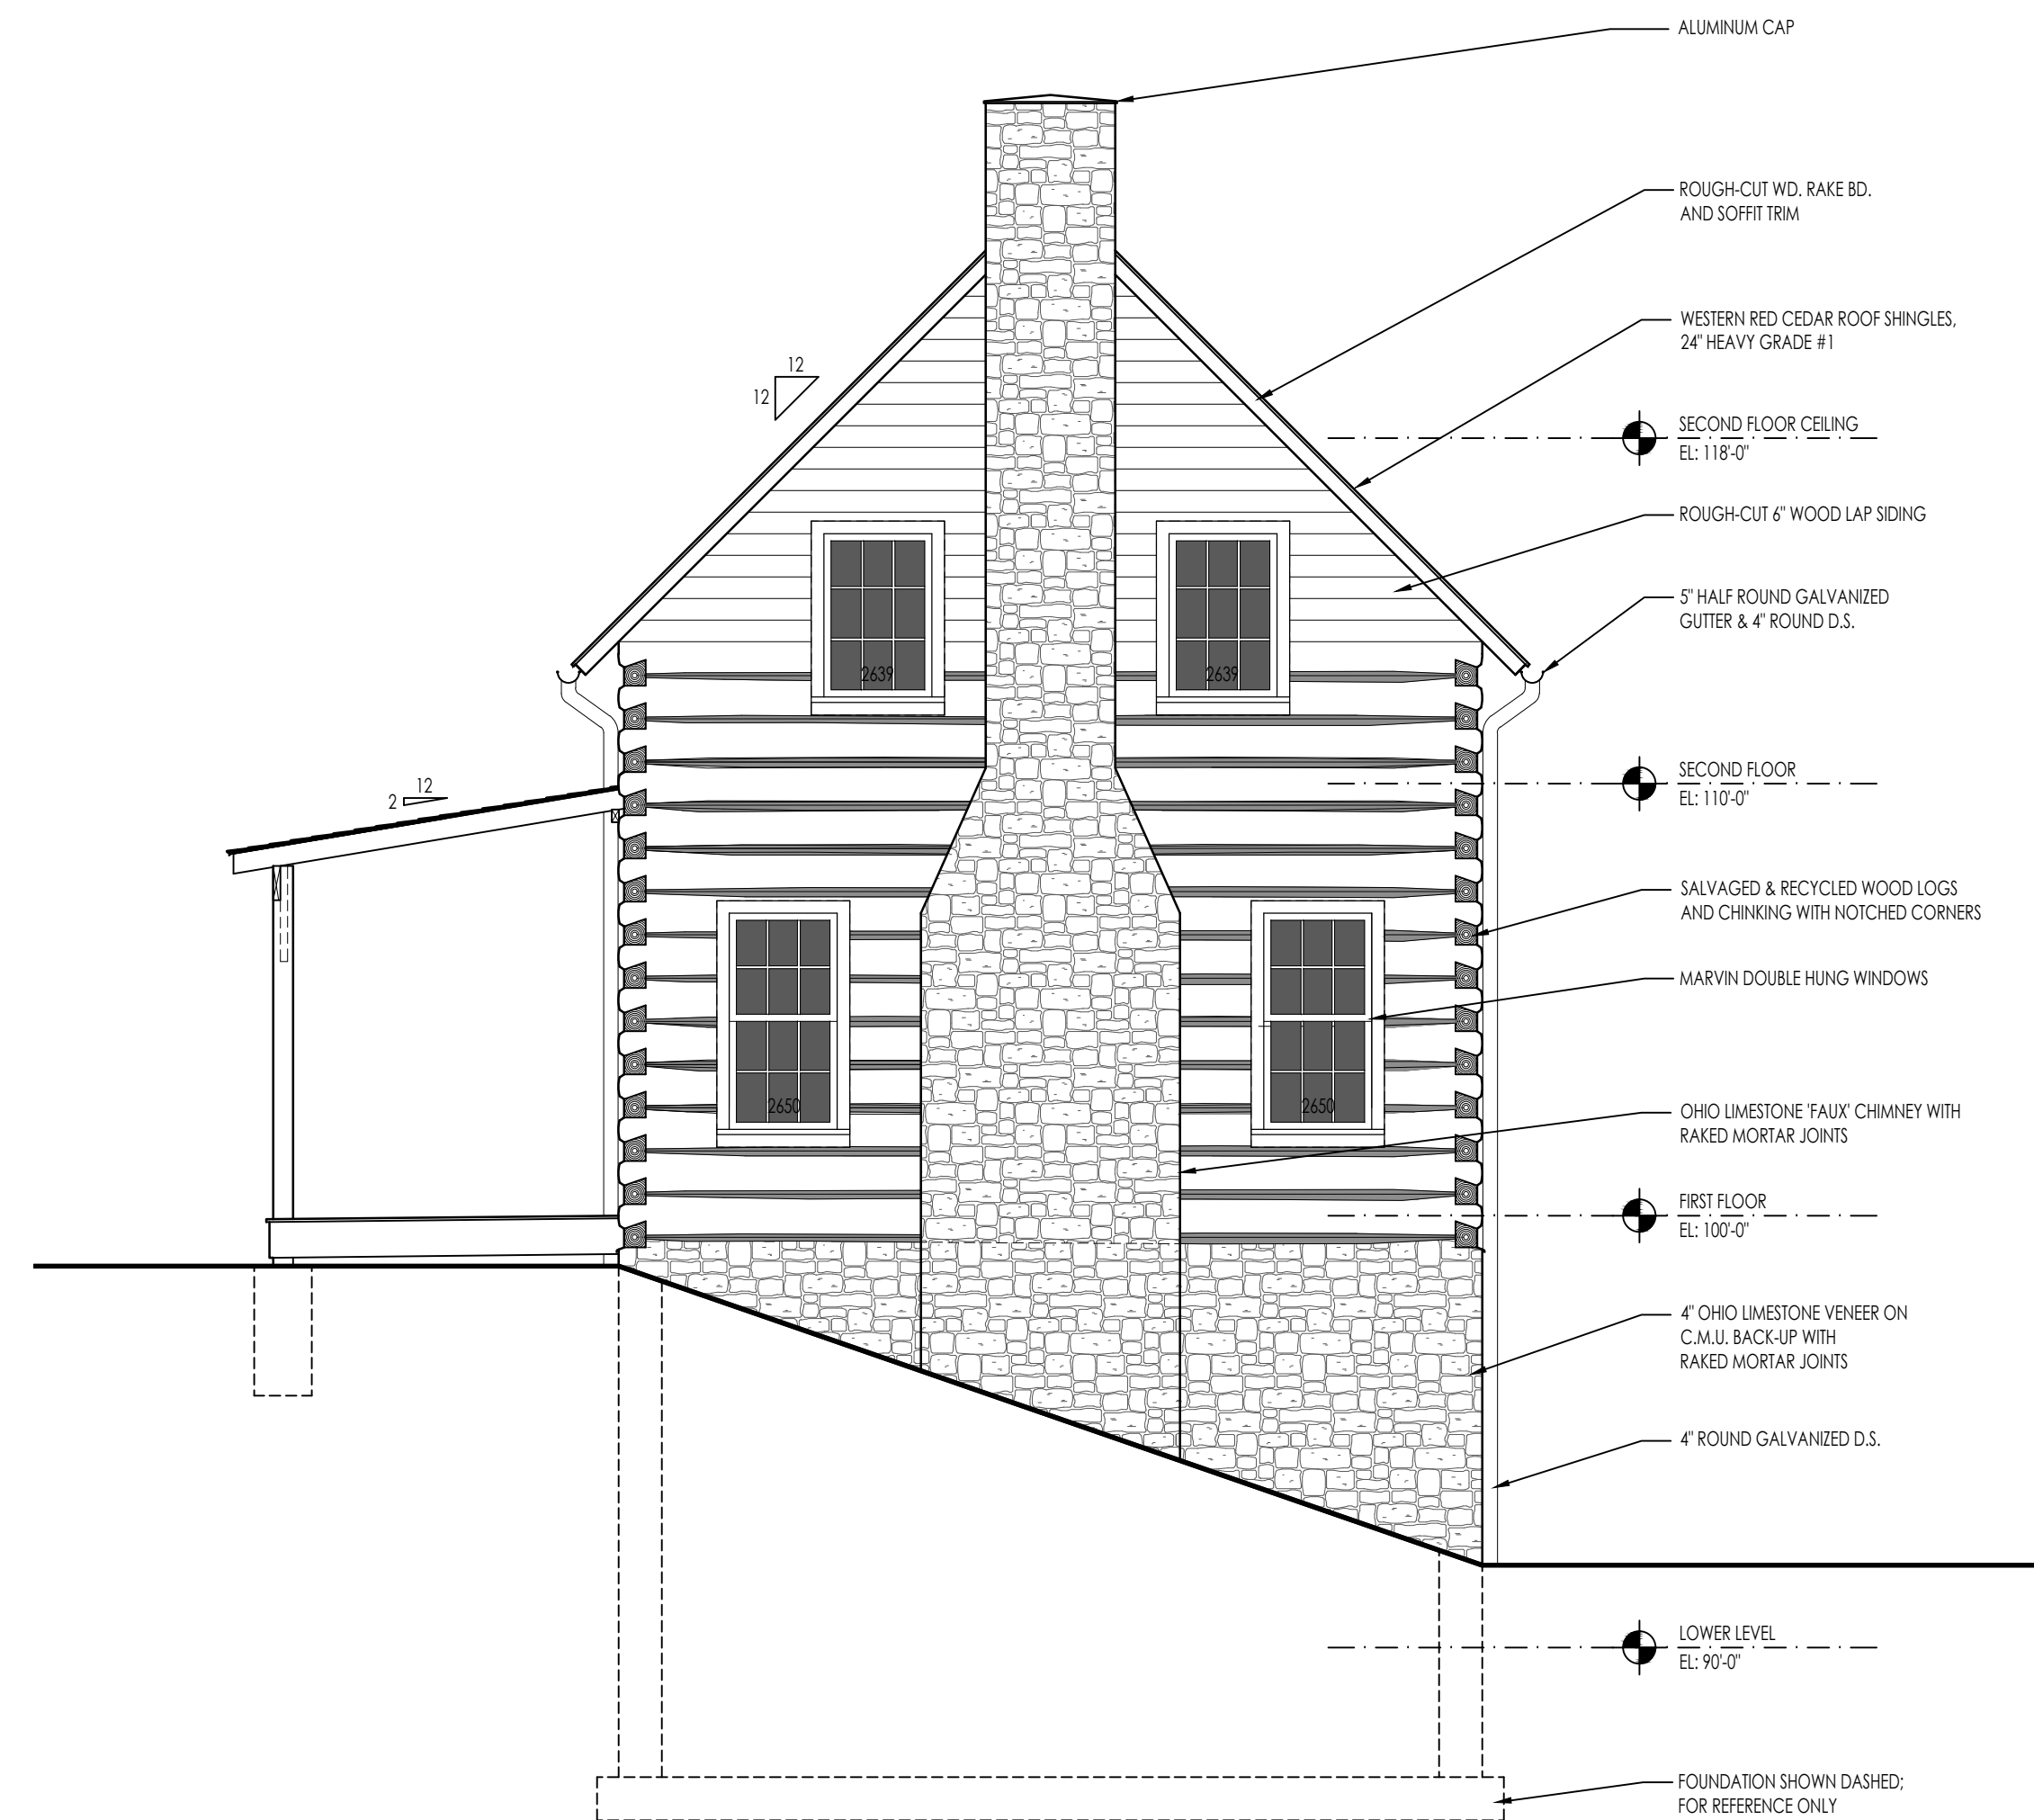

A NORTH ELEVATION
1/4" = 1'-0"

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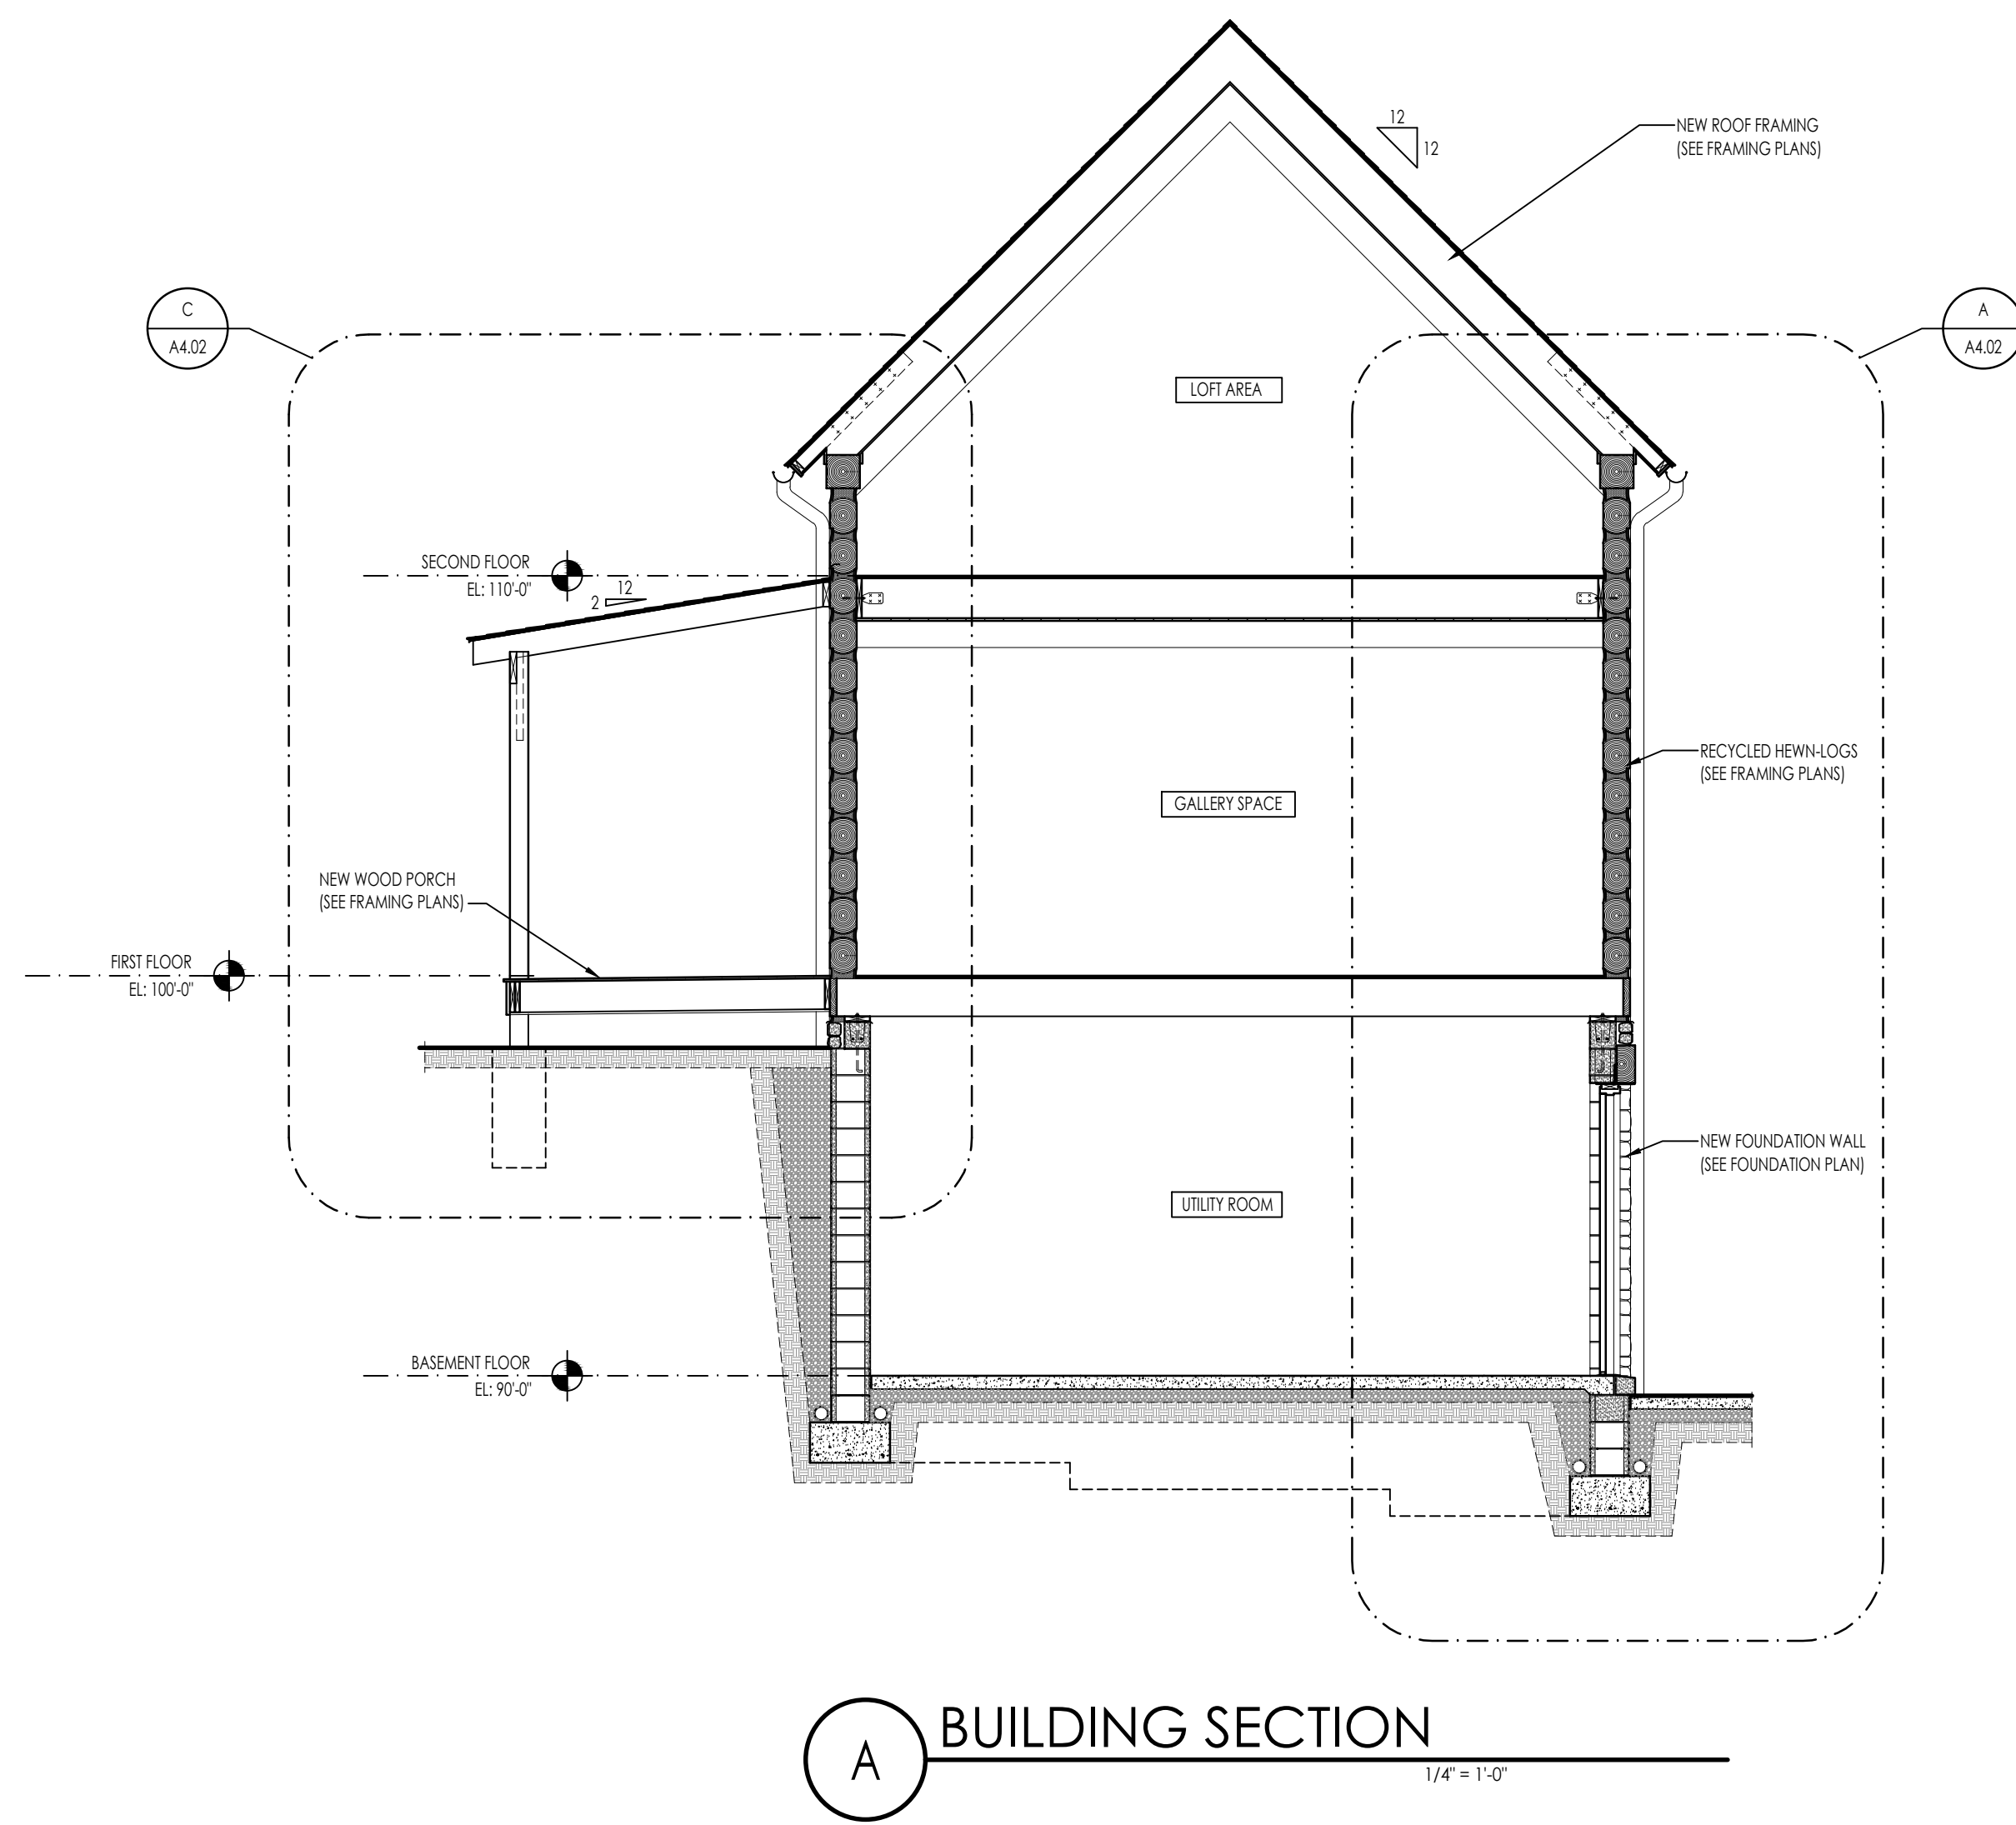
Project #:	2021-003
Issued For:	Permit
Date:	4/7/22
Revisions:	

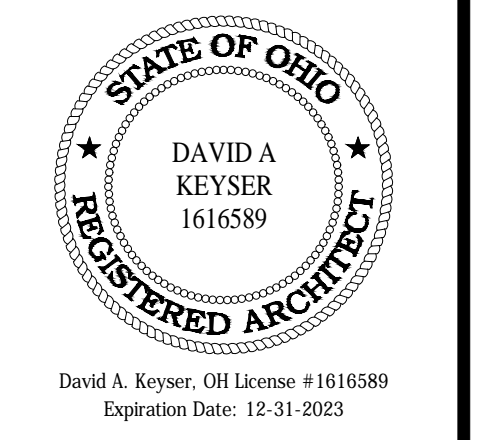SHEET TITLE

Exterior Elevations

SHEET NUMBER

A3.02



A BUILDING SECTION
1/4" = 1'-0"

SHEET INFORMATION


Project #:	2021-003
Issued For:	Permit
Date:	4/7/22
Revisions:	

SHEET TITLE


Building Sections

SHEET NUMBER


A4.01

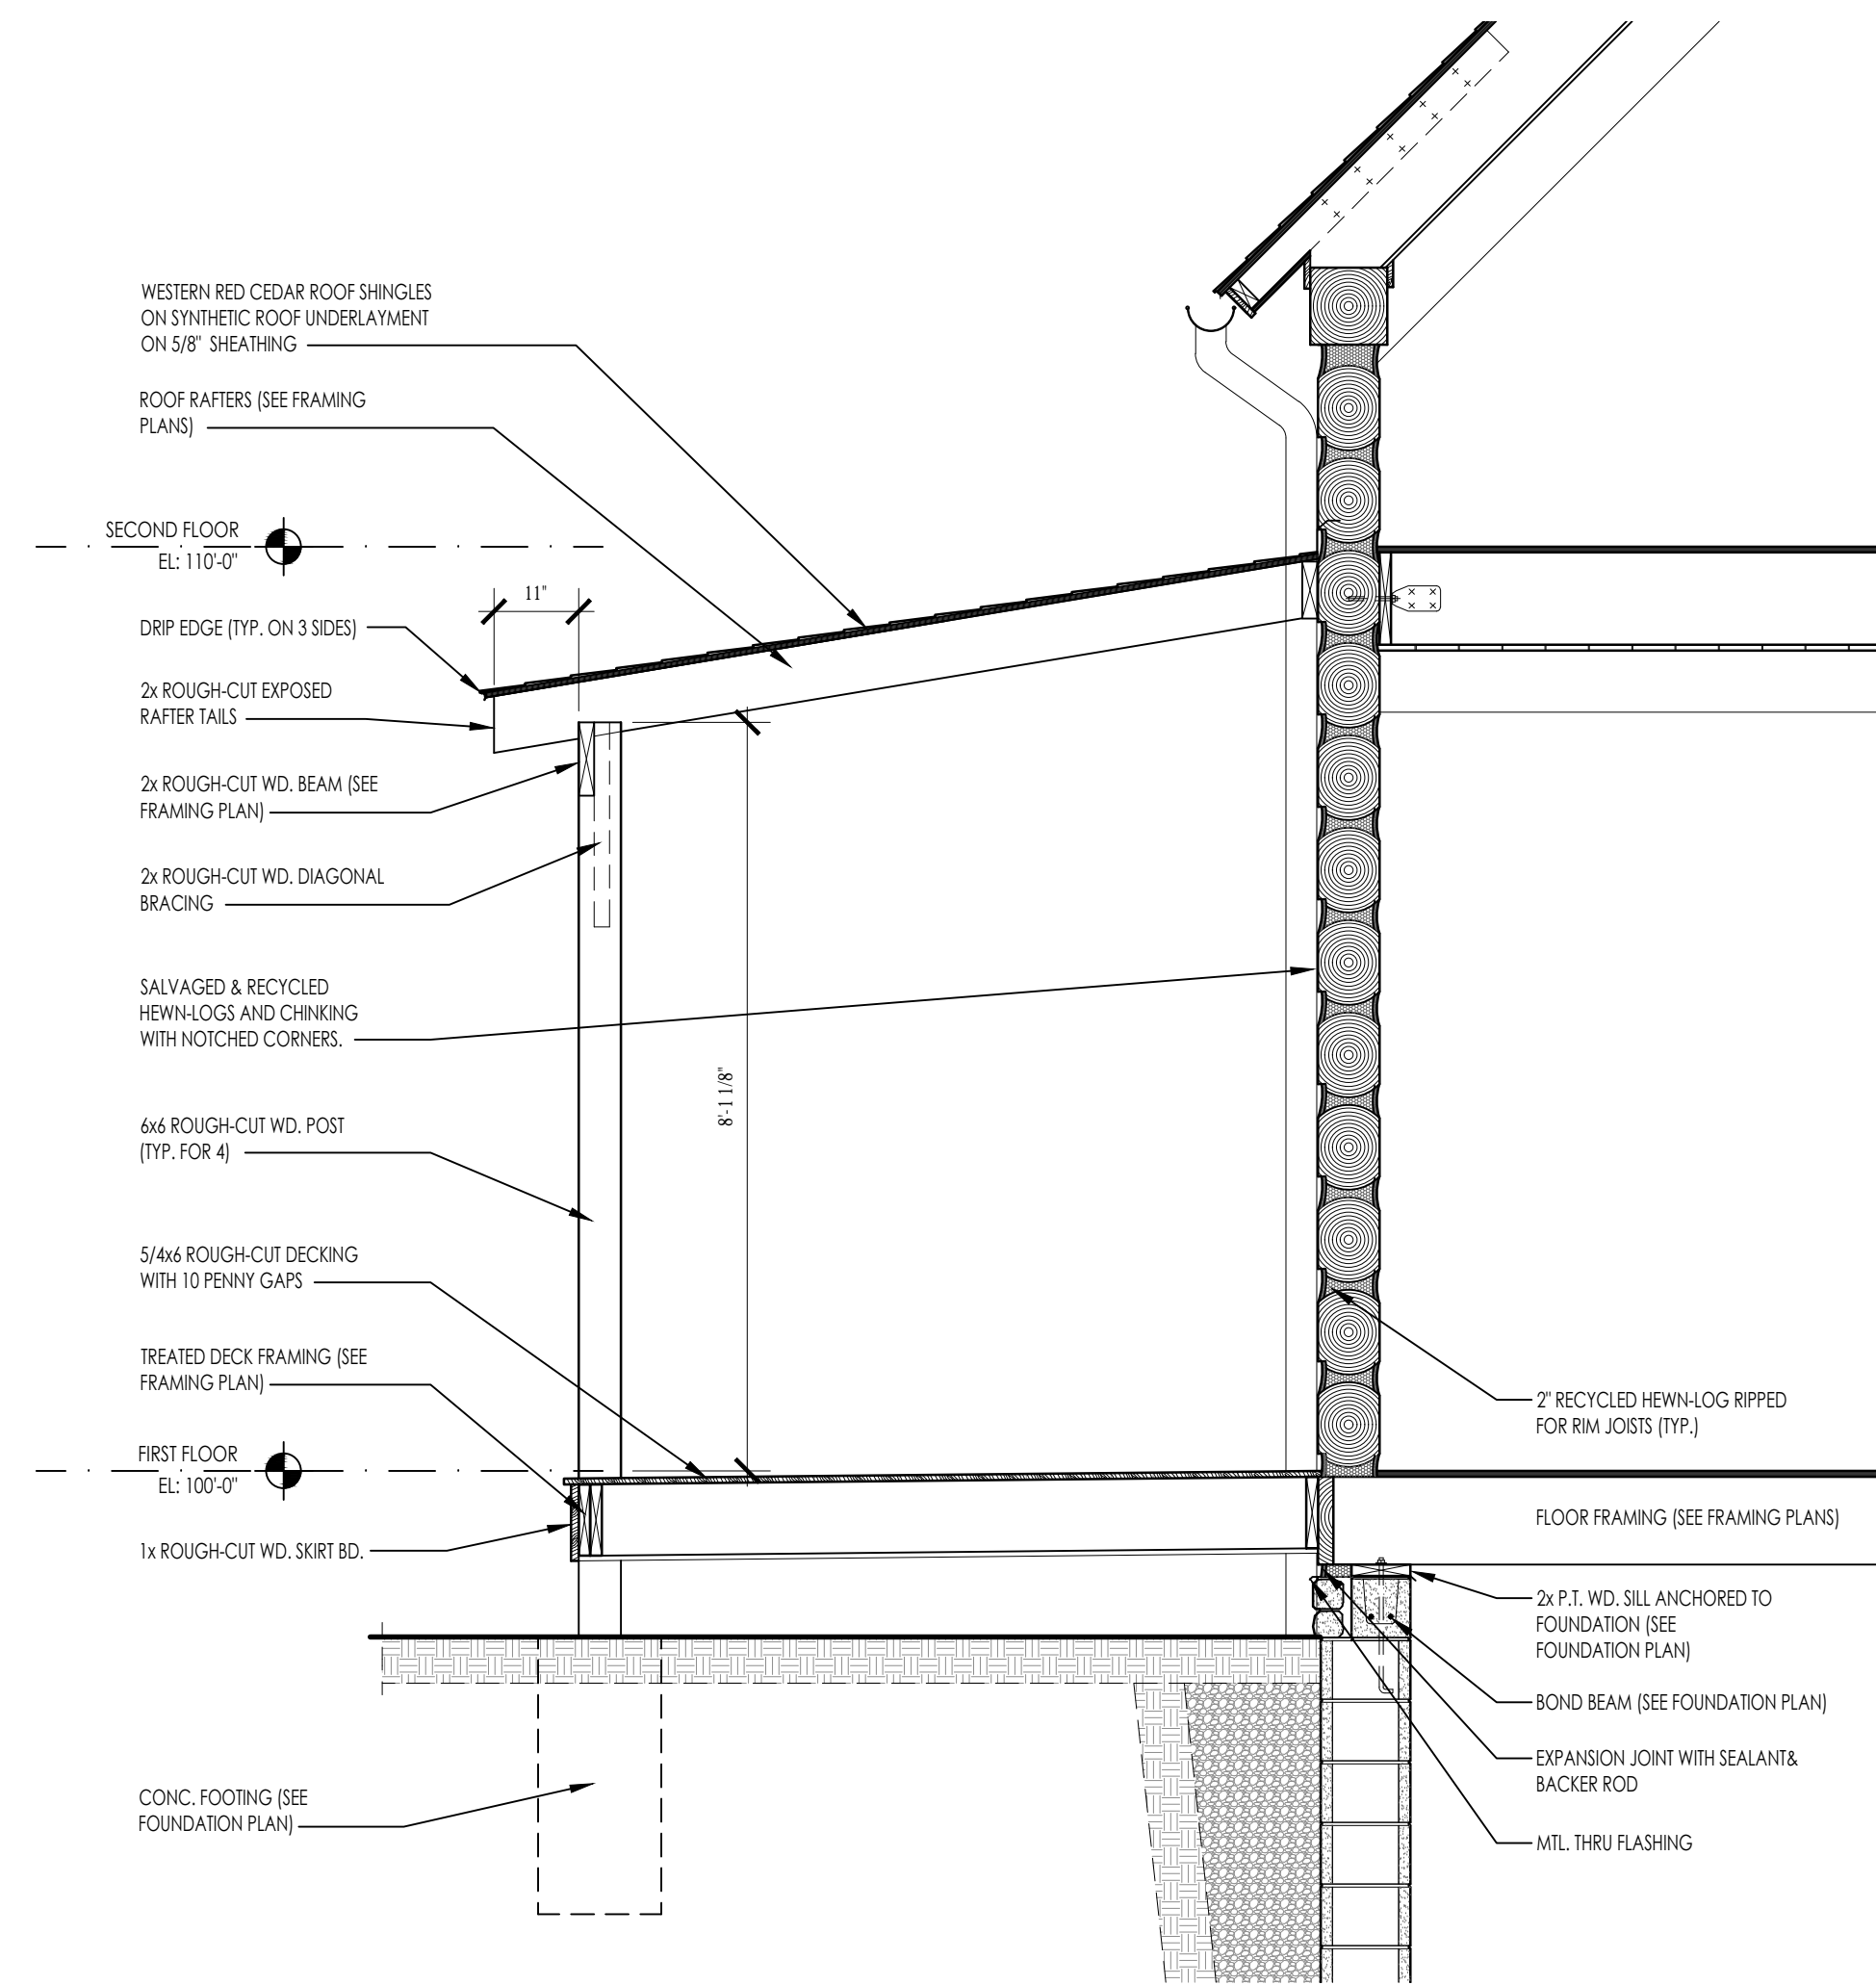

C WALL SECTION
1/2" = 1'-0"

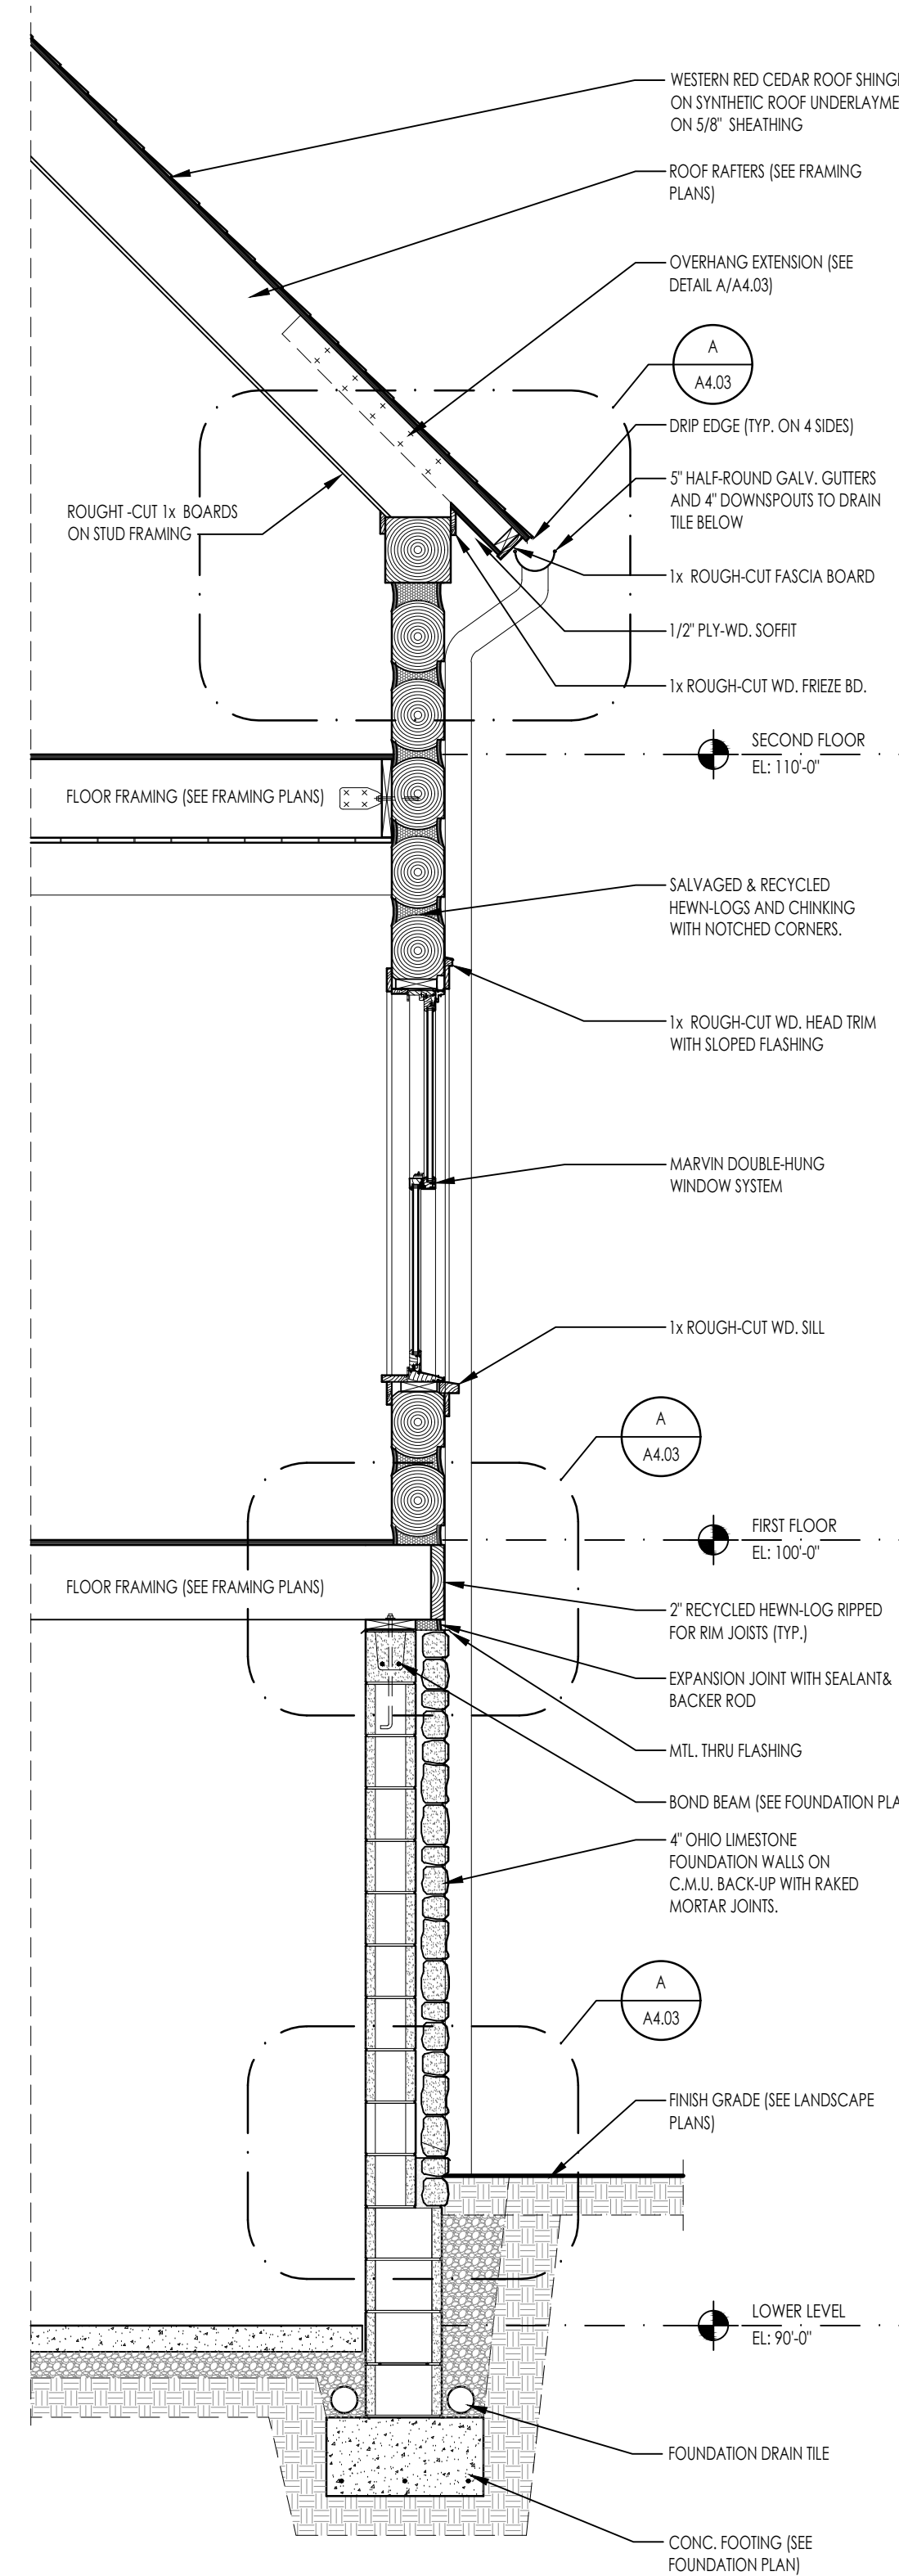

B WALL SECTION
1/2" = 1'-0"

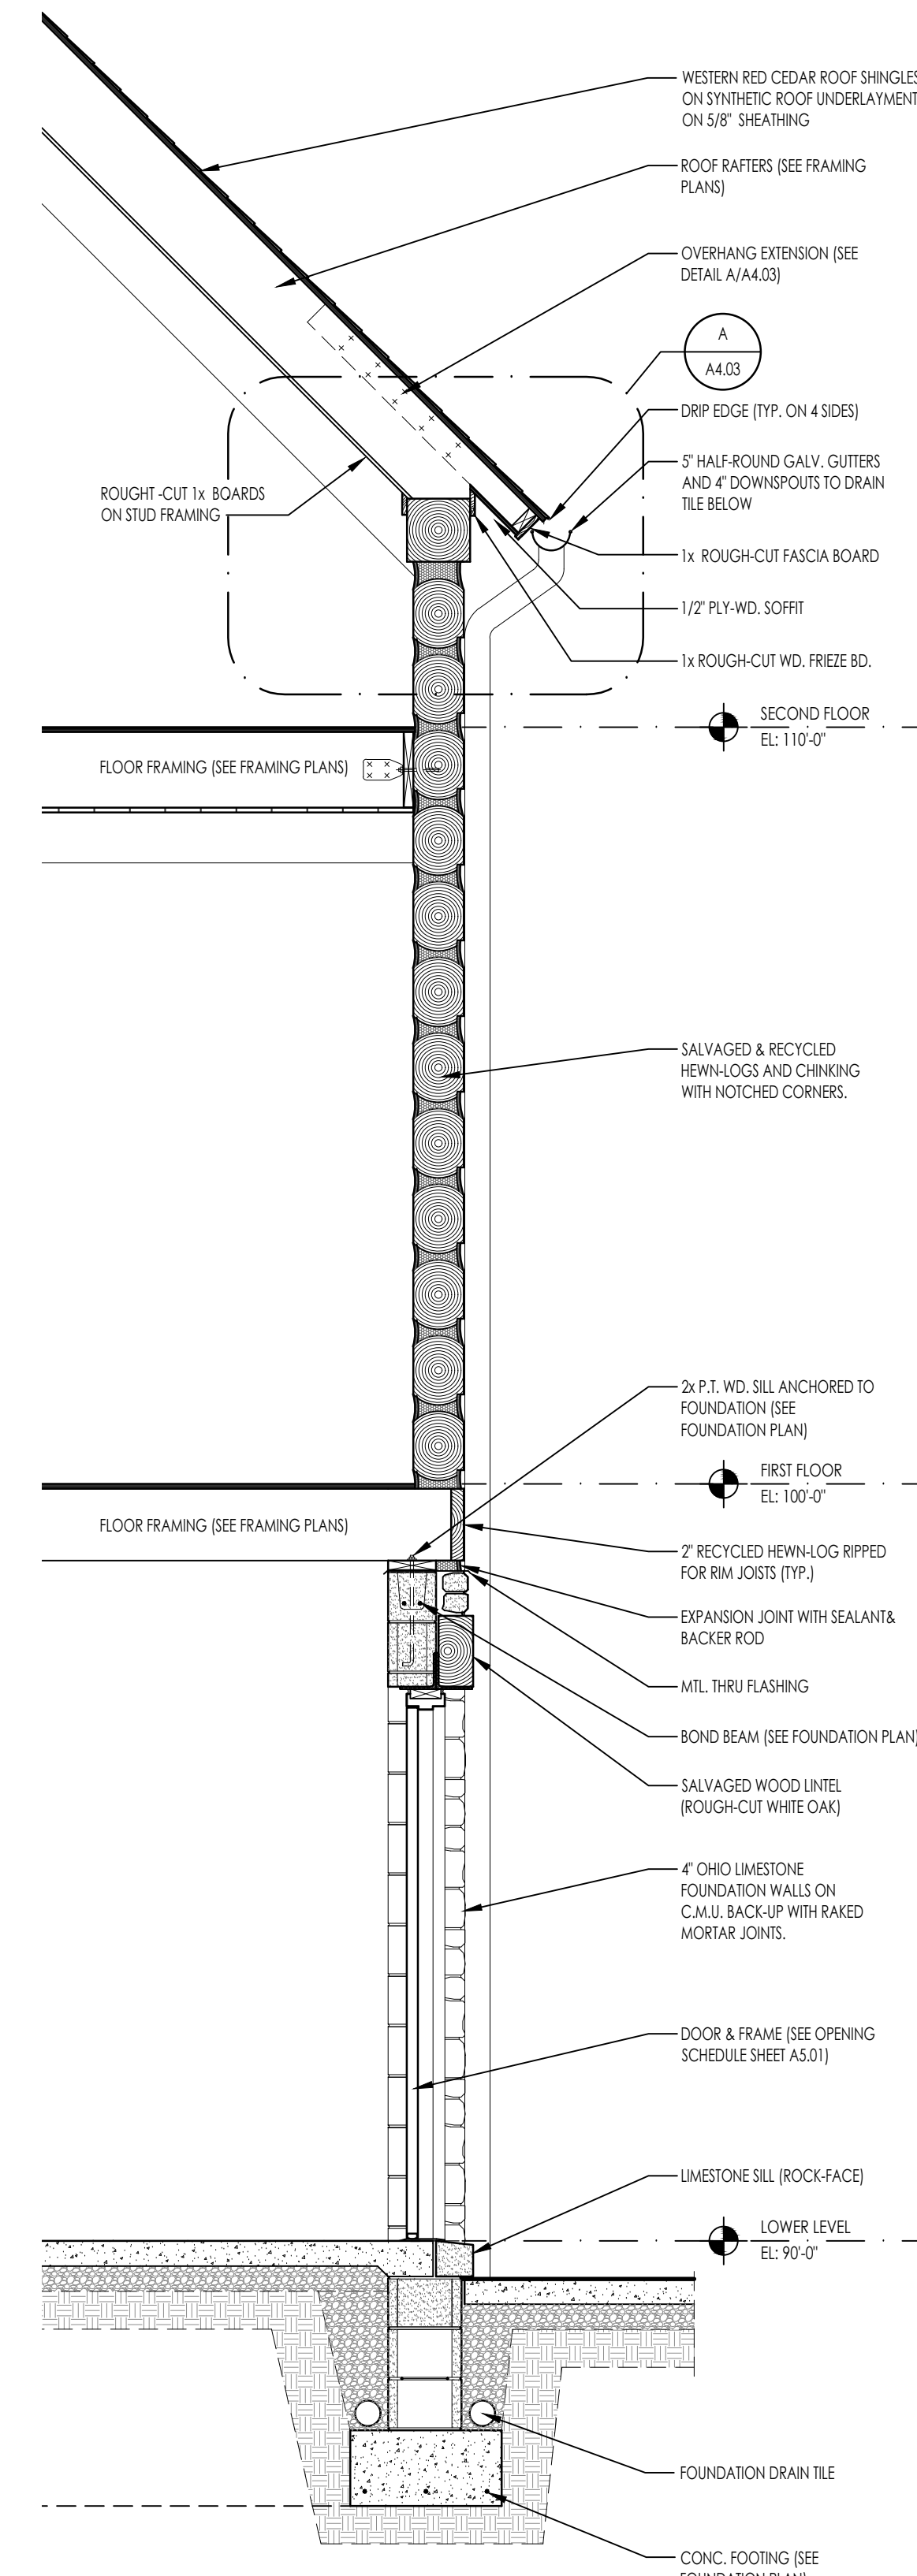

A WALL SECTION
1/2" = 1'-0"

SHEET INFORMATION

Project #:	2021-003
Issued For:	Permit
Date:	4/7/22
Revisions:	

SHEET TITLE
Wall Sections

SHEET NUMBER

A4.02


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Project #:	2021-003
Issued For:	Progress
Date:	3/9/22
Revisions:	


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Section Details

SHEET NUMBER


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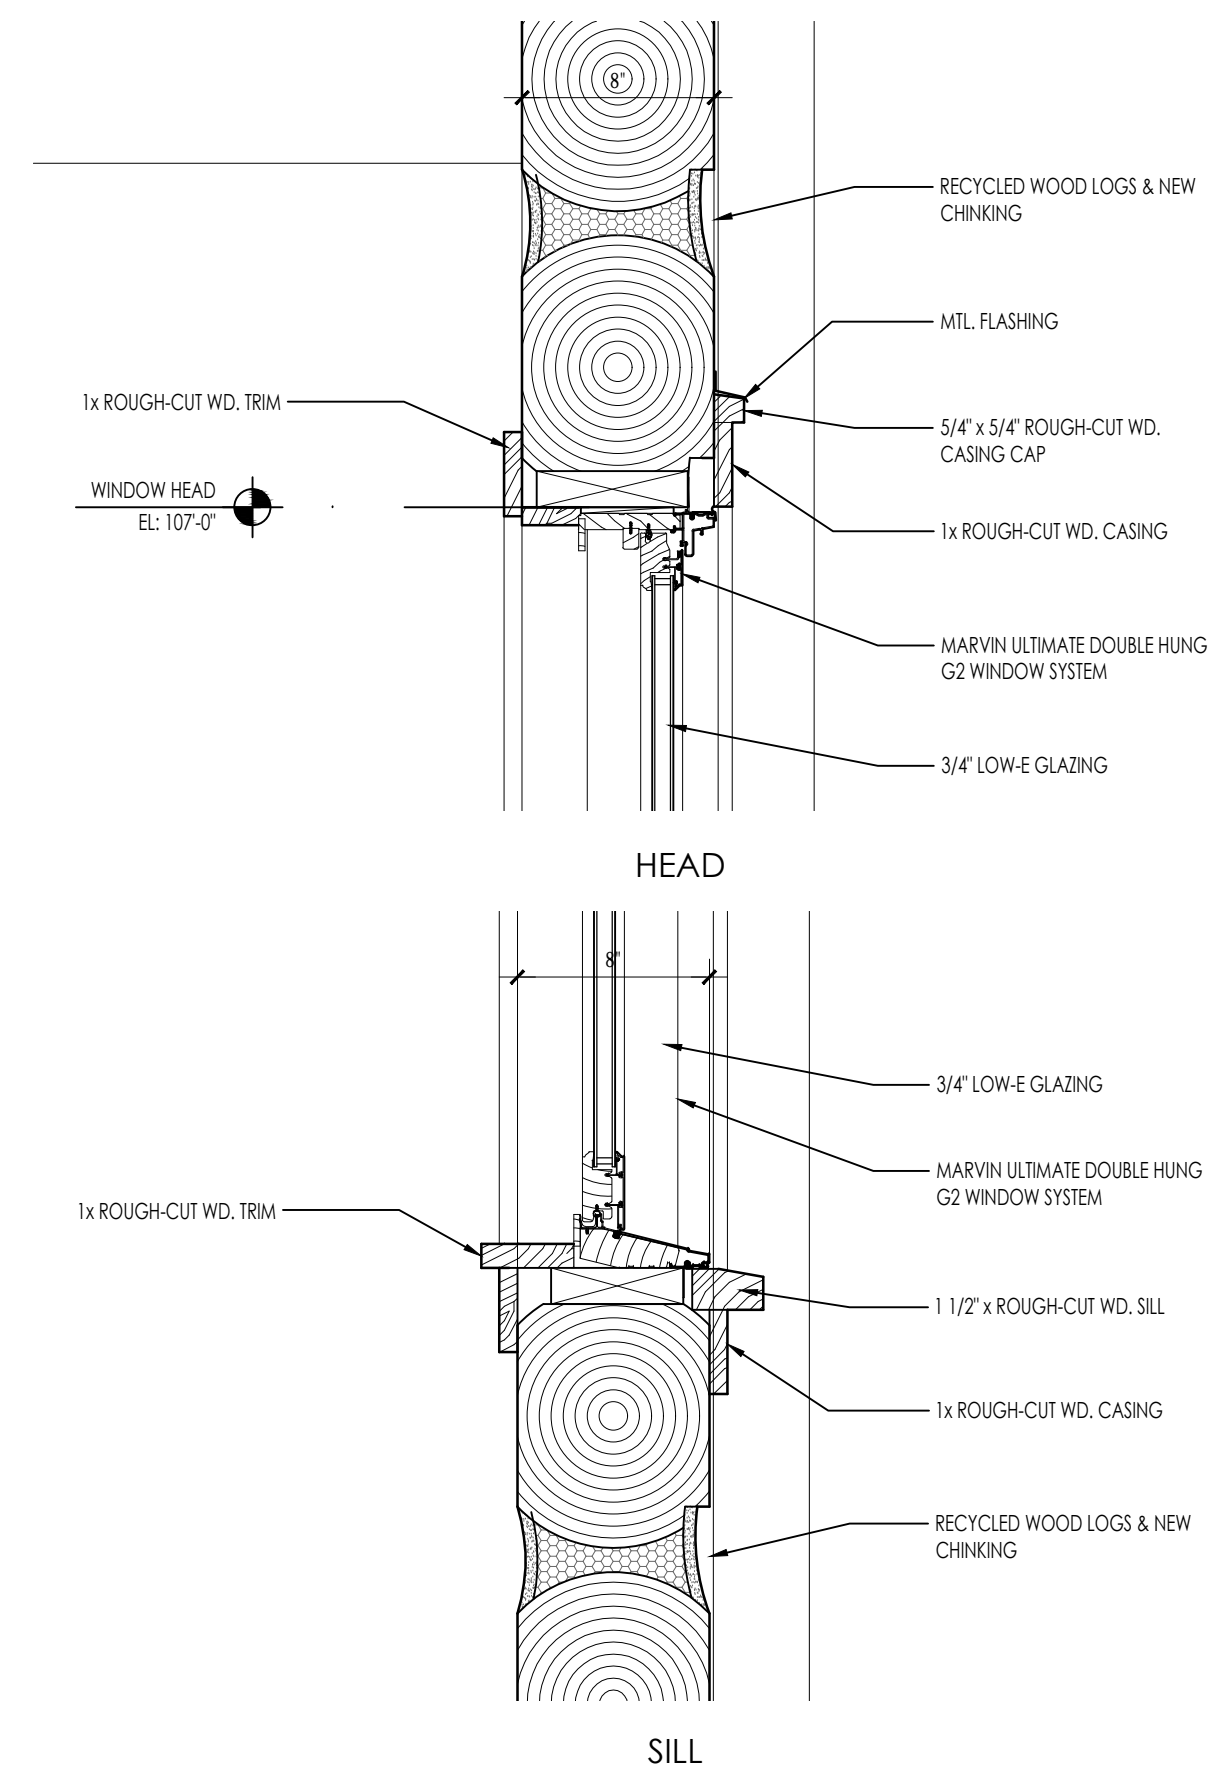
C INTERIOR ELEVATION
 1/2" = 1'-0"

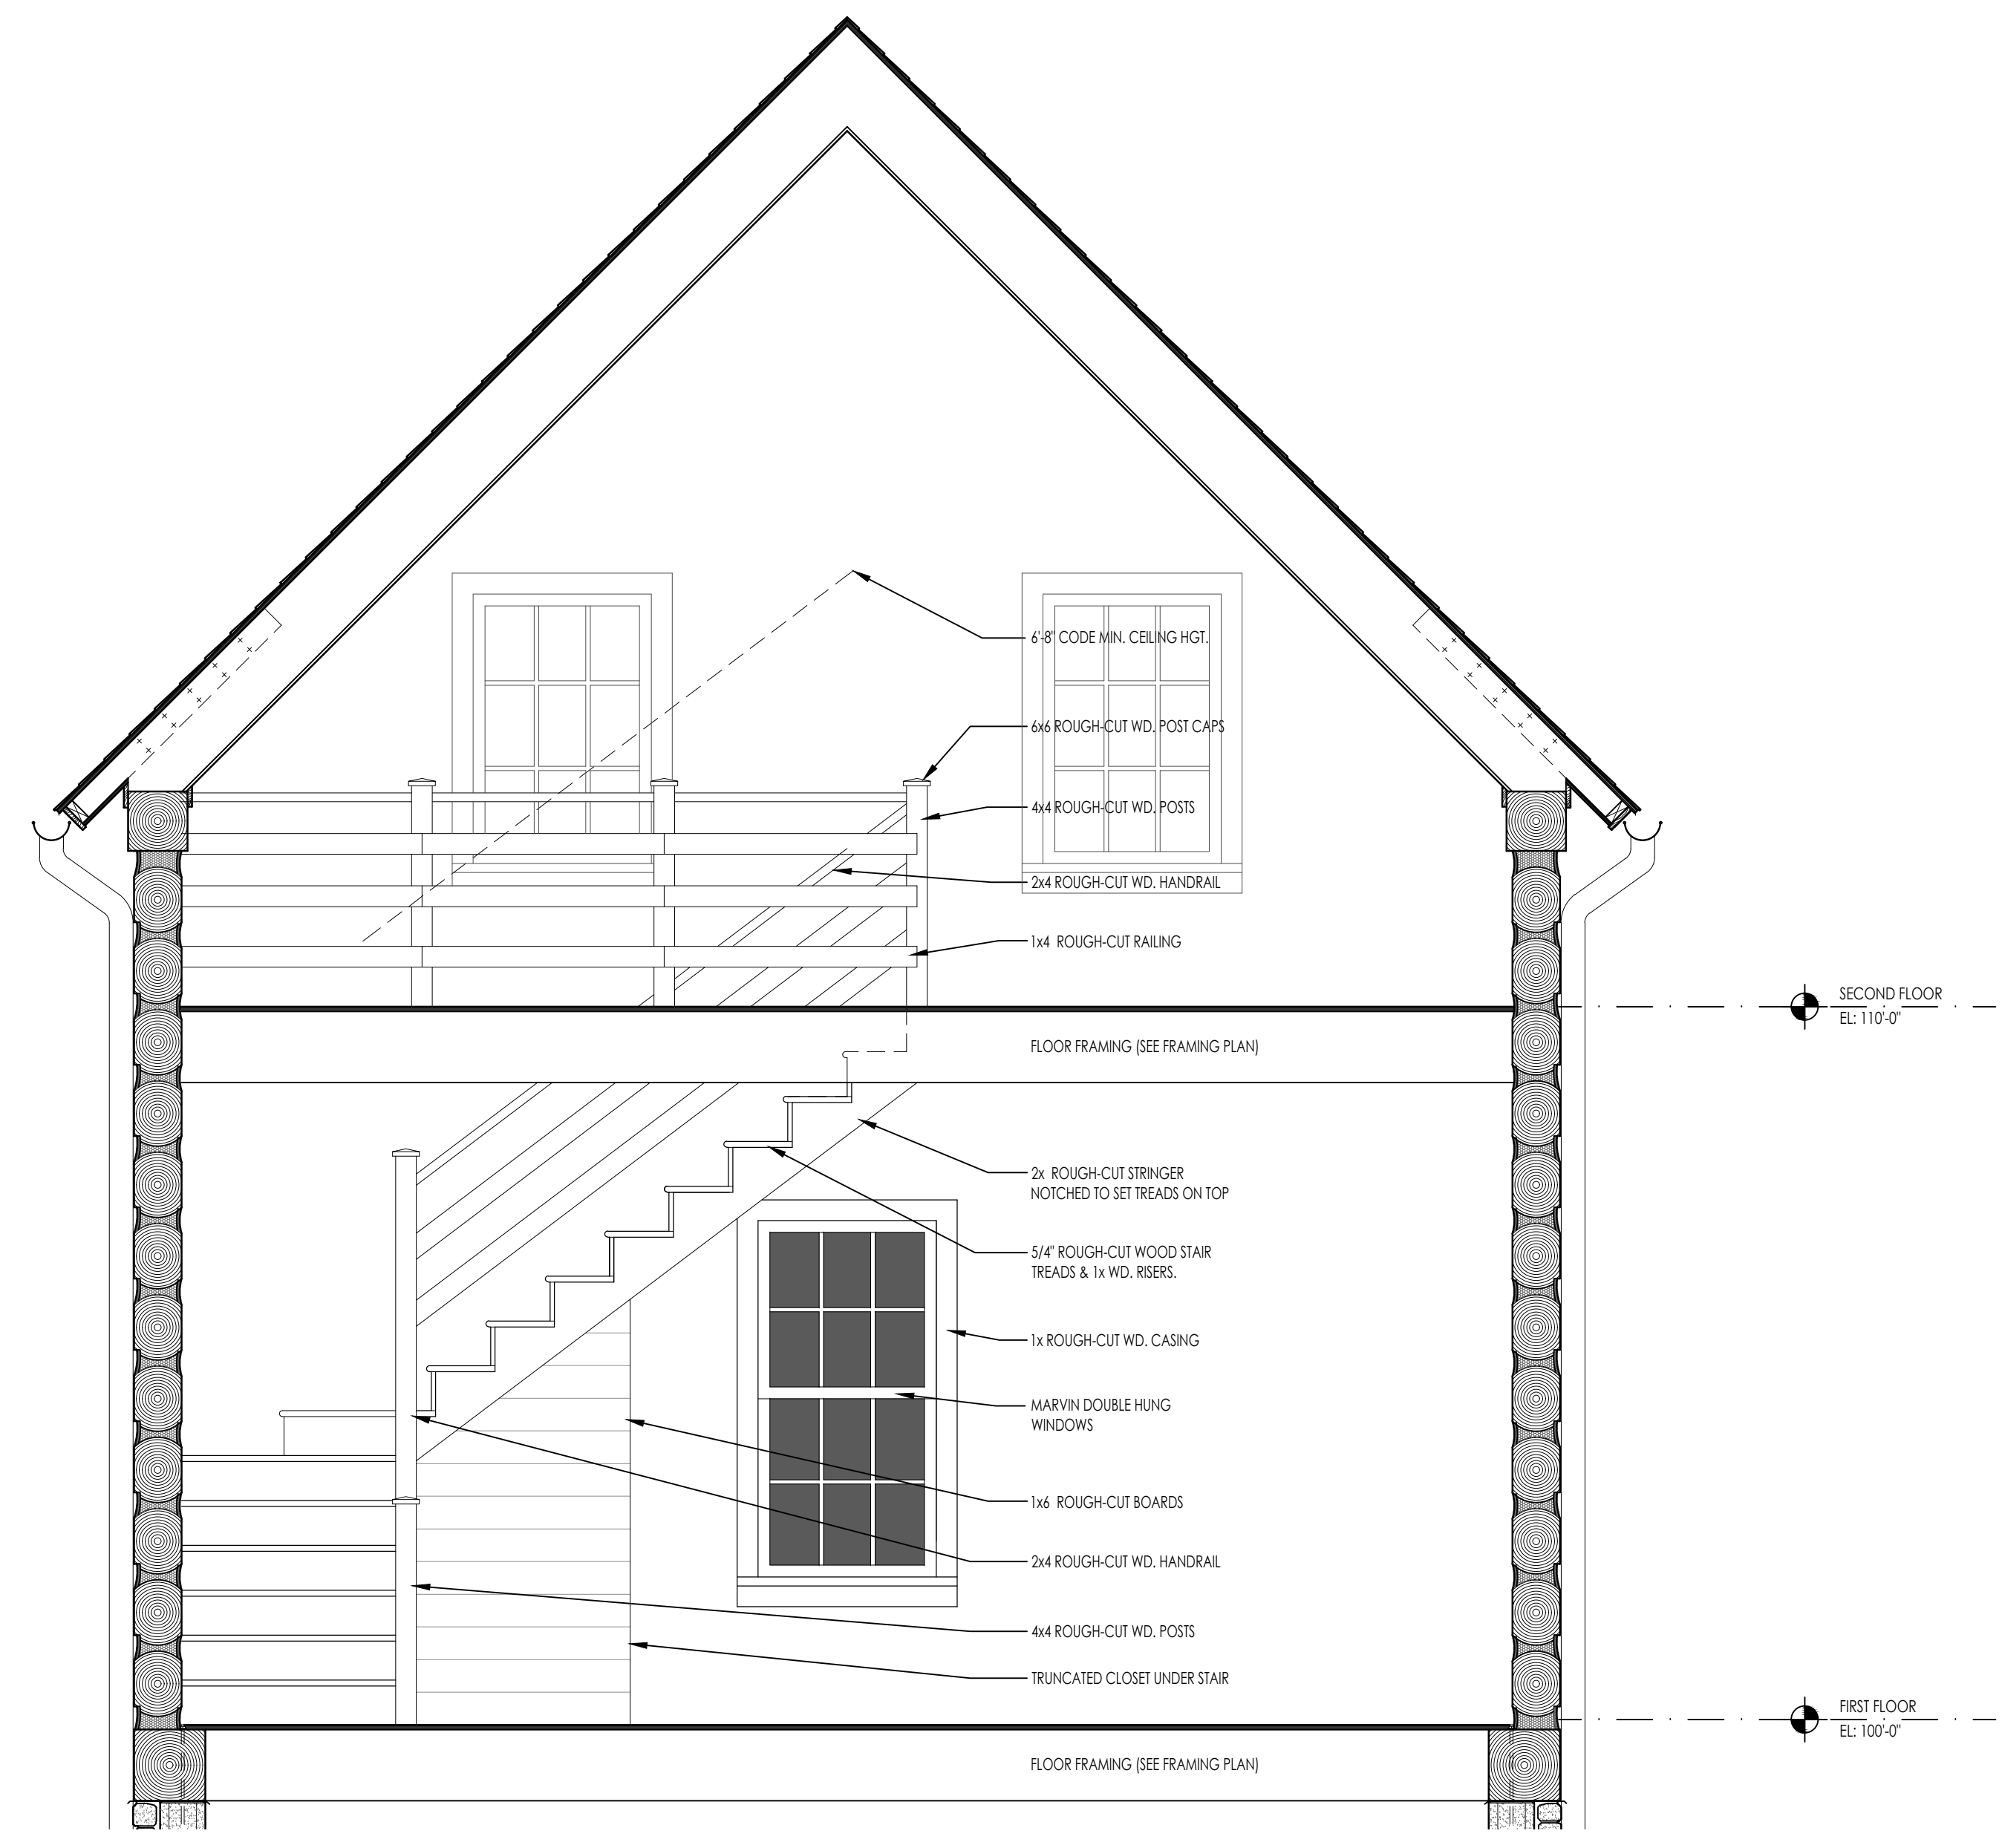

B INTERIOR ELEVATION
 1/2" = 1'-0"

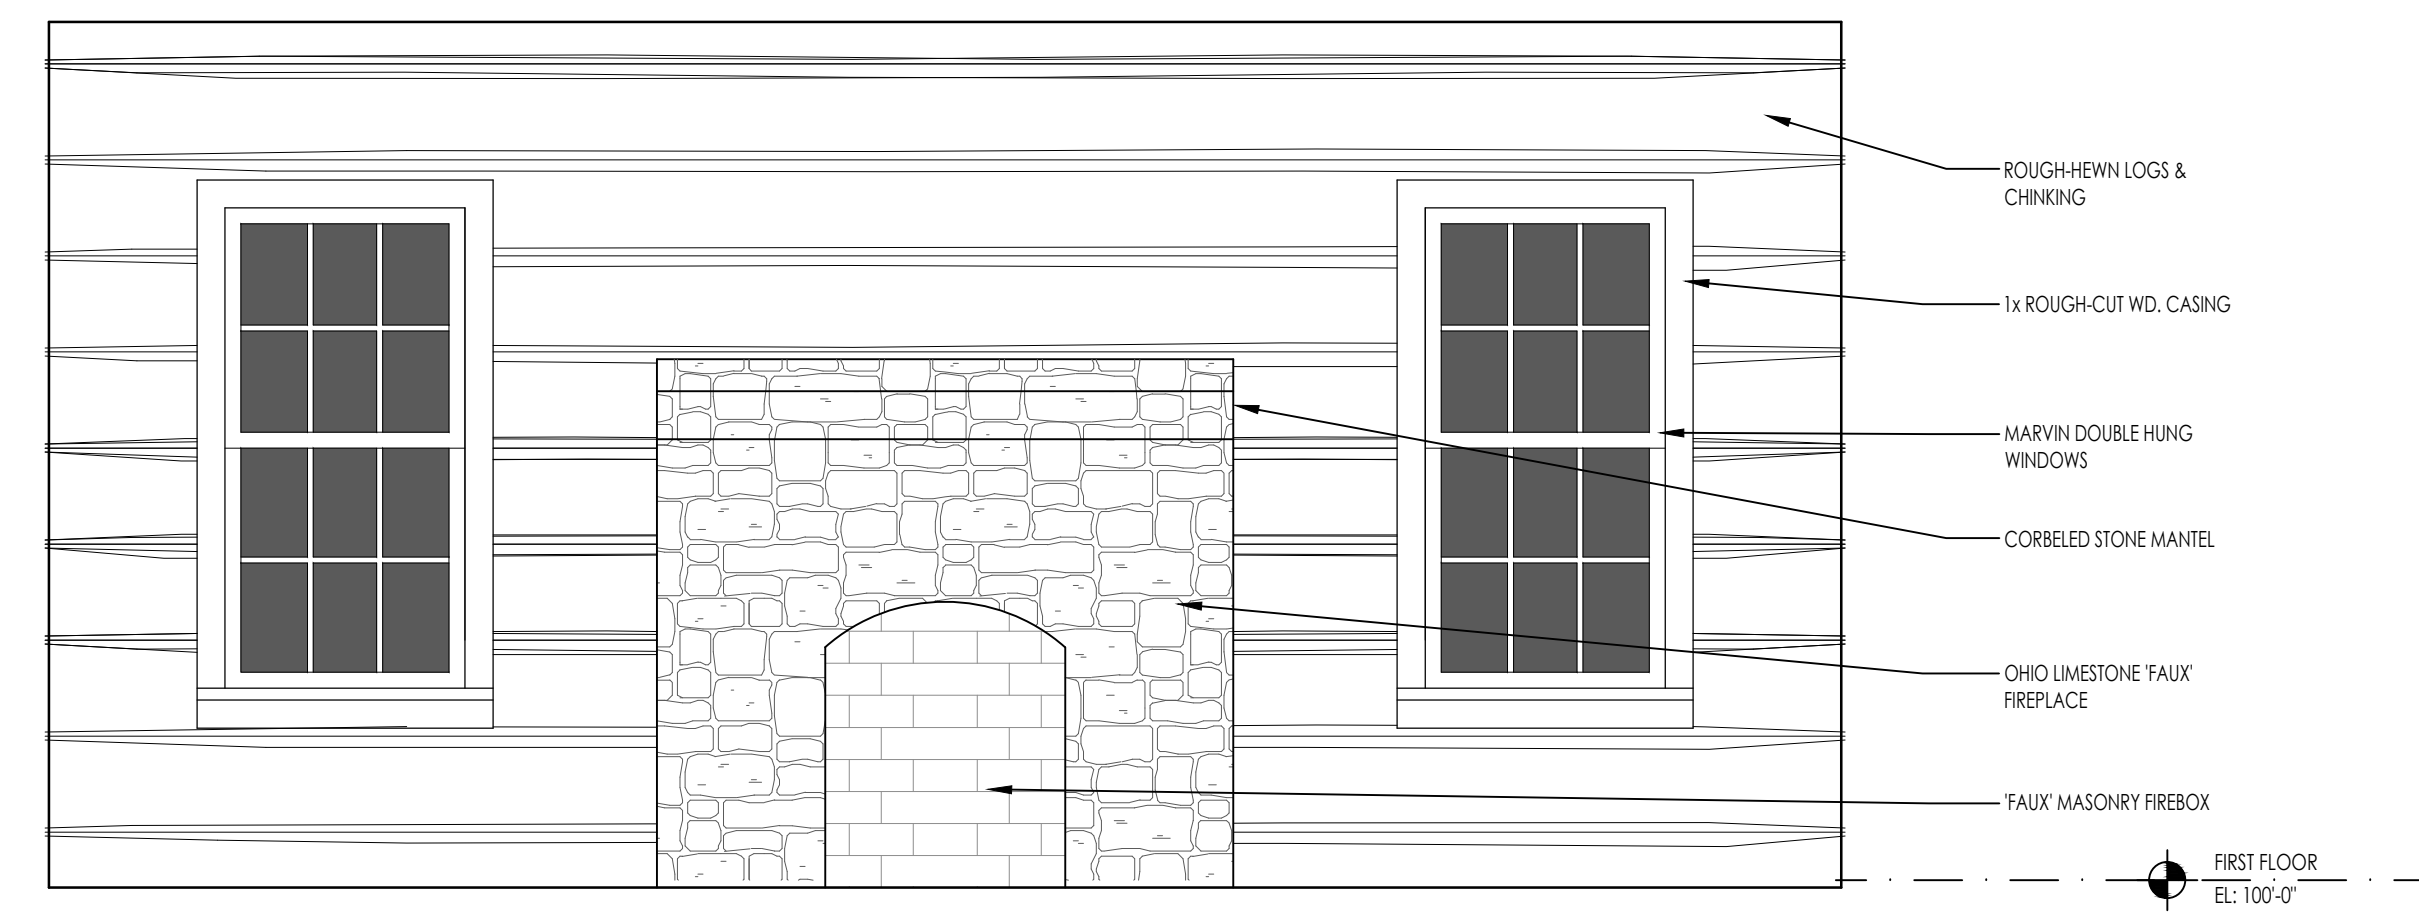

A SECTION DETAIL
 1 1/2" = 1'-0"


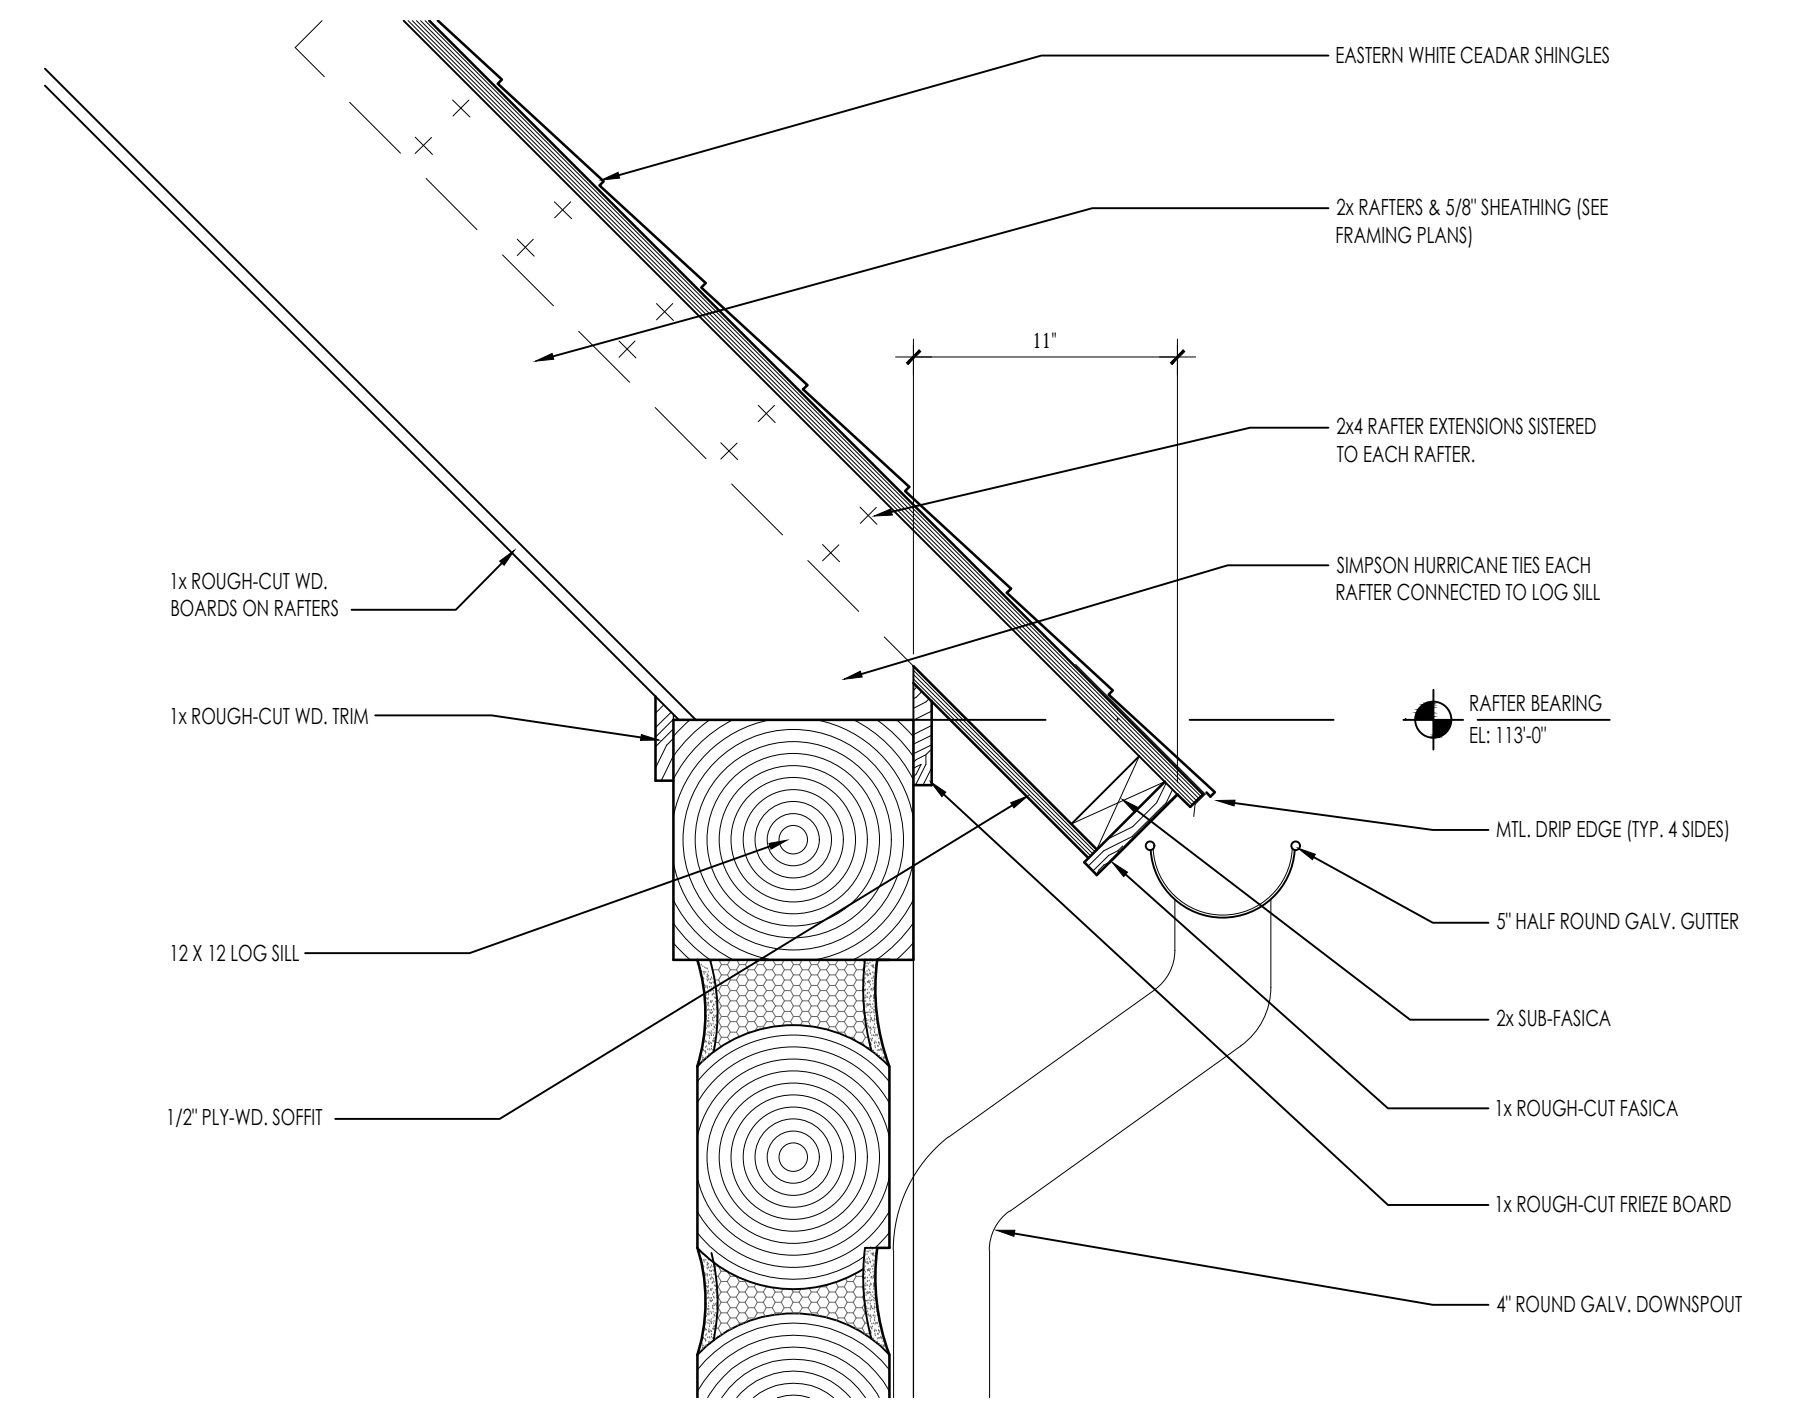


B WINDOW DETAILS
1/12" = 1'-0"

MARK	WINDOW DESCRIPTION		MATERIAL	SCREEN	HEAD HEIGHT	GLAZED AREA	VENT AREA	NOTE/REMARKS
	TYPE	SIZE [WxH]						
2650	DOUBLE HUNG	2'-6"x5'-0"	ALUM. CLAD	NO	7'-0"	9.75 SF.	6.25 SF.	-
2639	SINGLE HUNG	2'-4"x3'-9"	ALUM. CLAD	NO	7'-0"	7.05 SF.	0 SF.	-
2619	SINGLE HUNG	2'-4"x1'-9"	ALUM. CLAD	NO	7'-0"	2.70 SF.	0 SF.	-


GENERAL NOTES:

- THE CONTRACTOR SHALL COMPLY WITH ALL BUILDING CODE REQUIREMENTS OF THE LOCAL GOVERNING AUTHORITY.
- WINDOW SPECS ARE BASED ON MARVIN ULTIMATE ALUMINUM CLAD WOOD WINDOW SYSTEMS (NO EQUALS).
- TEMPERED AND/OR SAFETY GLAZING SHALL BE PROVIDED IN THE FOLLOWING LOCATIONS:
 - GLAZING IN ALL DOORS (SWINGING, SLIDING AND BIFOLD).
 - GLAZING IN A FIXED OR OPERABLE PANEL ADJACENT TO A DOOR TO WHICH THE NEAREST VERTICAL EDGE IS WITHIN A 24" ARC OF THE DOOR IN A CLOSED POSITION.
 - GLAZING IN DOORS AND ENCLOSURES FOR SHOWERS, BATHUBS, WHIRLPOOLS AND HOT TUBS.
 - ADDITIONAL LOCATIONS AS INDICATED.
 - GLAZING ADJACENT TO STAIRWAYS, LANDINGS AND RAMPS WITHIN 36" HORIZONTALLY OF A WALKING SURFACE WHEN THE EXPOSED SURFACE OF THE GLAZING IS LESS THAN 60" ABOVE THE PLANE OF THE ADJACENT WALKING SURFACE.
 - GLAZING ADJACENT TO STAIRWAYS WITHIN 48" HORIZONTALLY OF THE BOTTOM TREAD OF THE STAIRWAY IN ANY DIRECTION WHEN THE EXPOSED SURFACE OF THE GLAZING IS LESS THAN 60" ABOVE THE PLANE OF THE ADJACENT WALKING SURFACE.

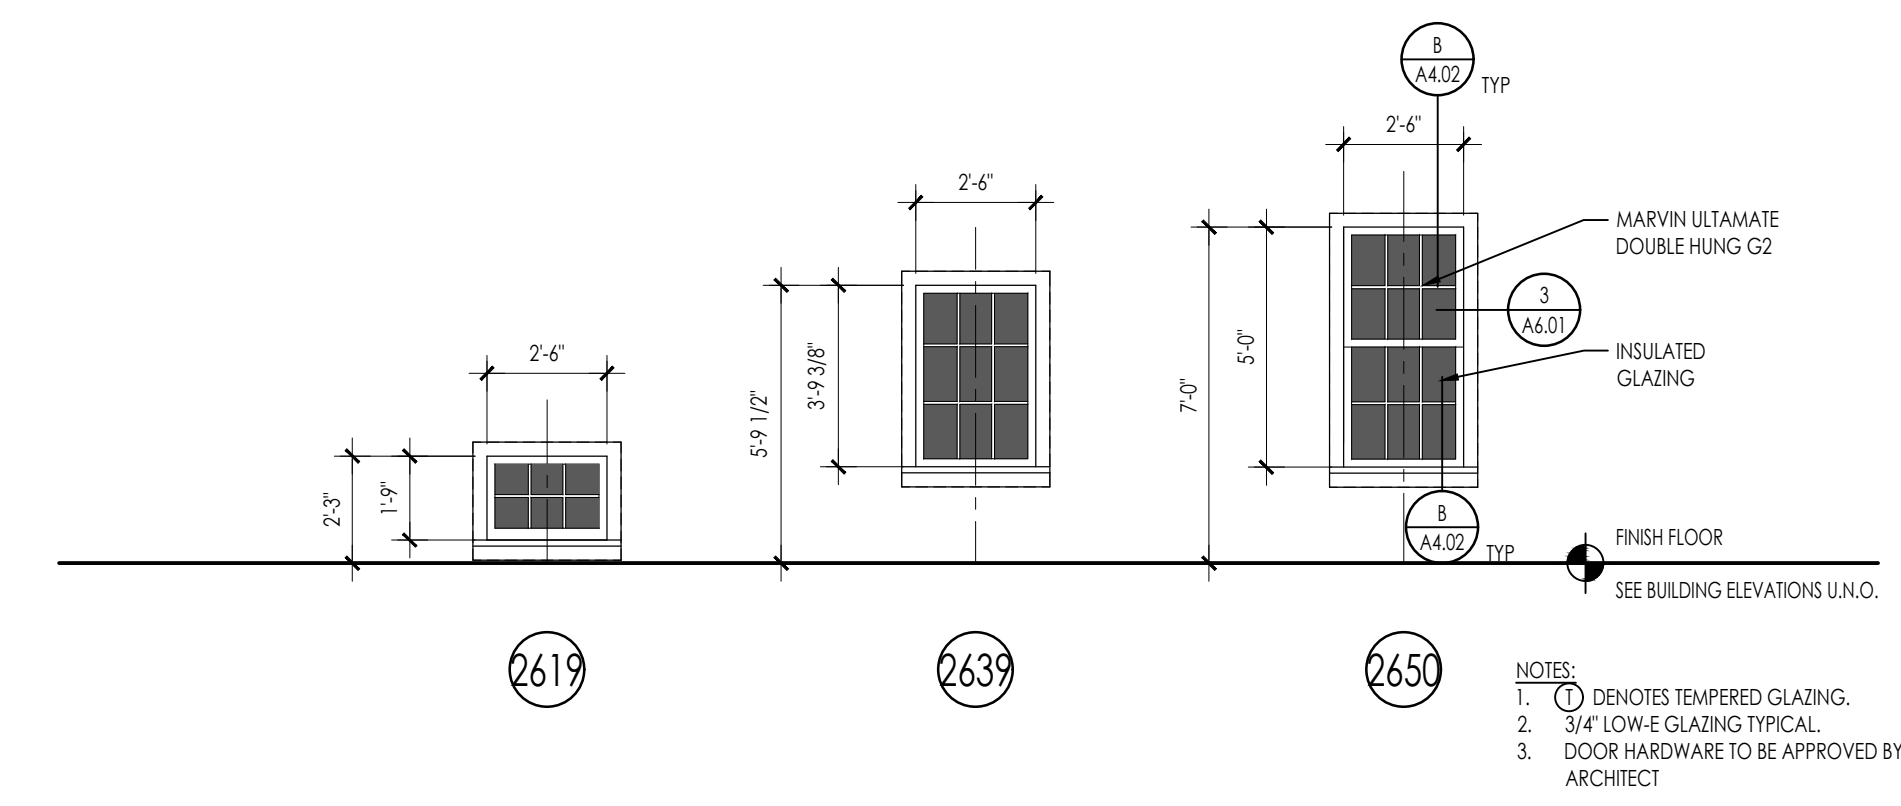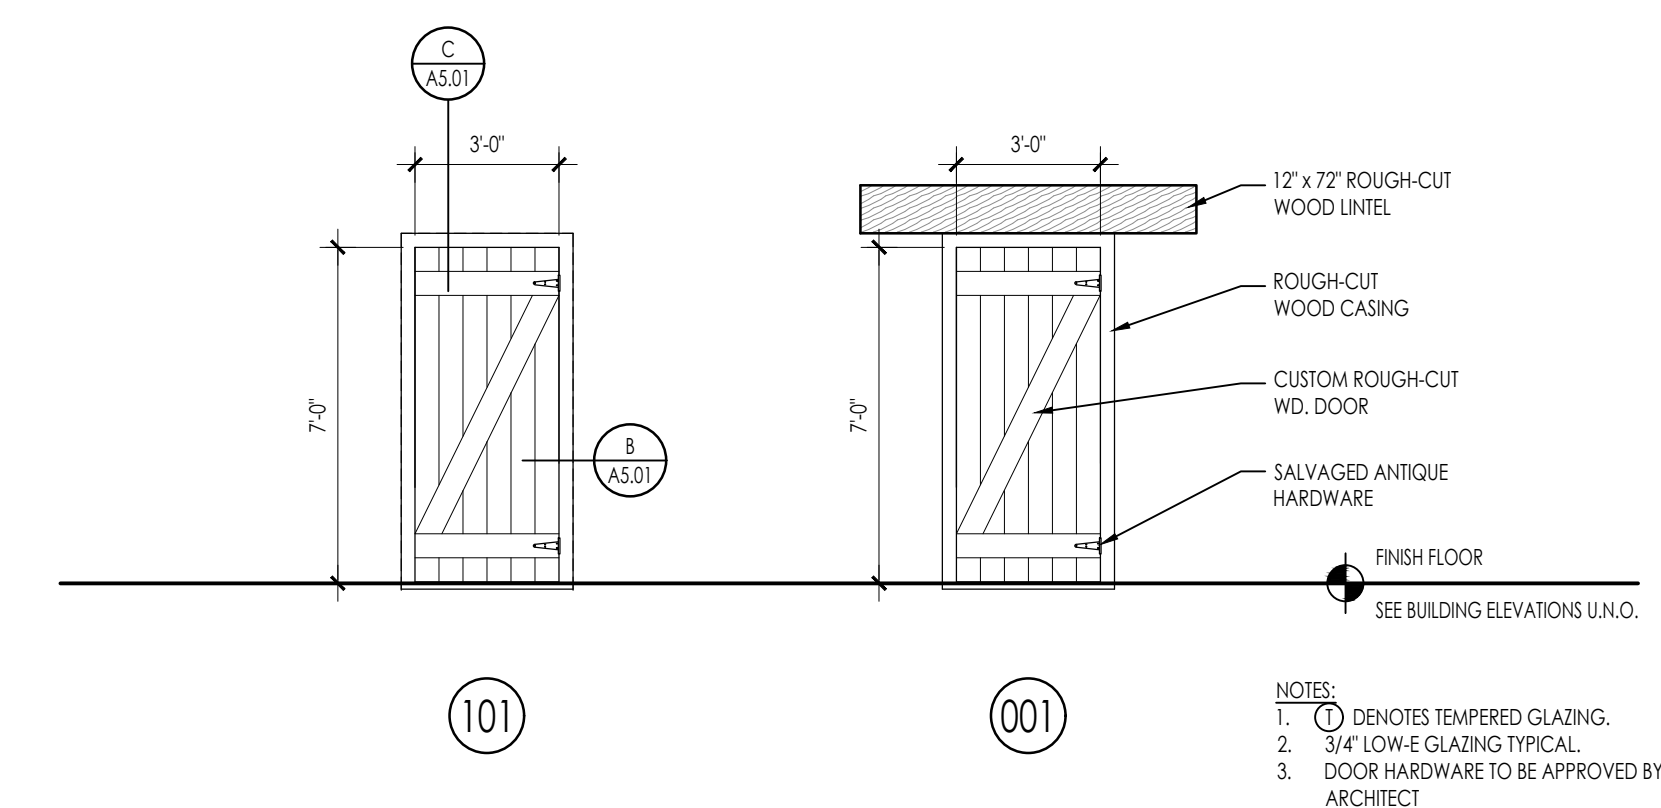

A DOOR DETAILS
1/12" = 1'-0"

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SHEET INFORMATION

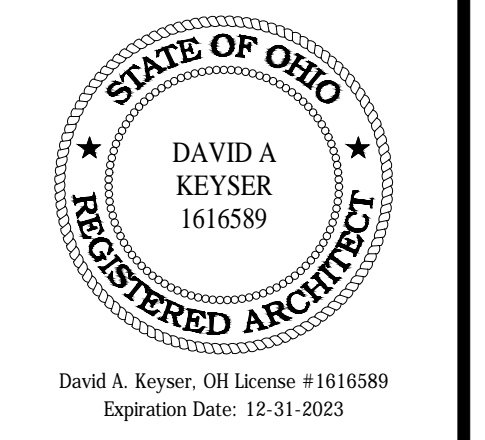Project #: 2021-003
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Date: 4/7/22
Revisions:

SHEET TITLE

Door & Window Schedules

SHEET NUMBER

A5.01

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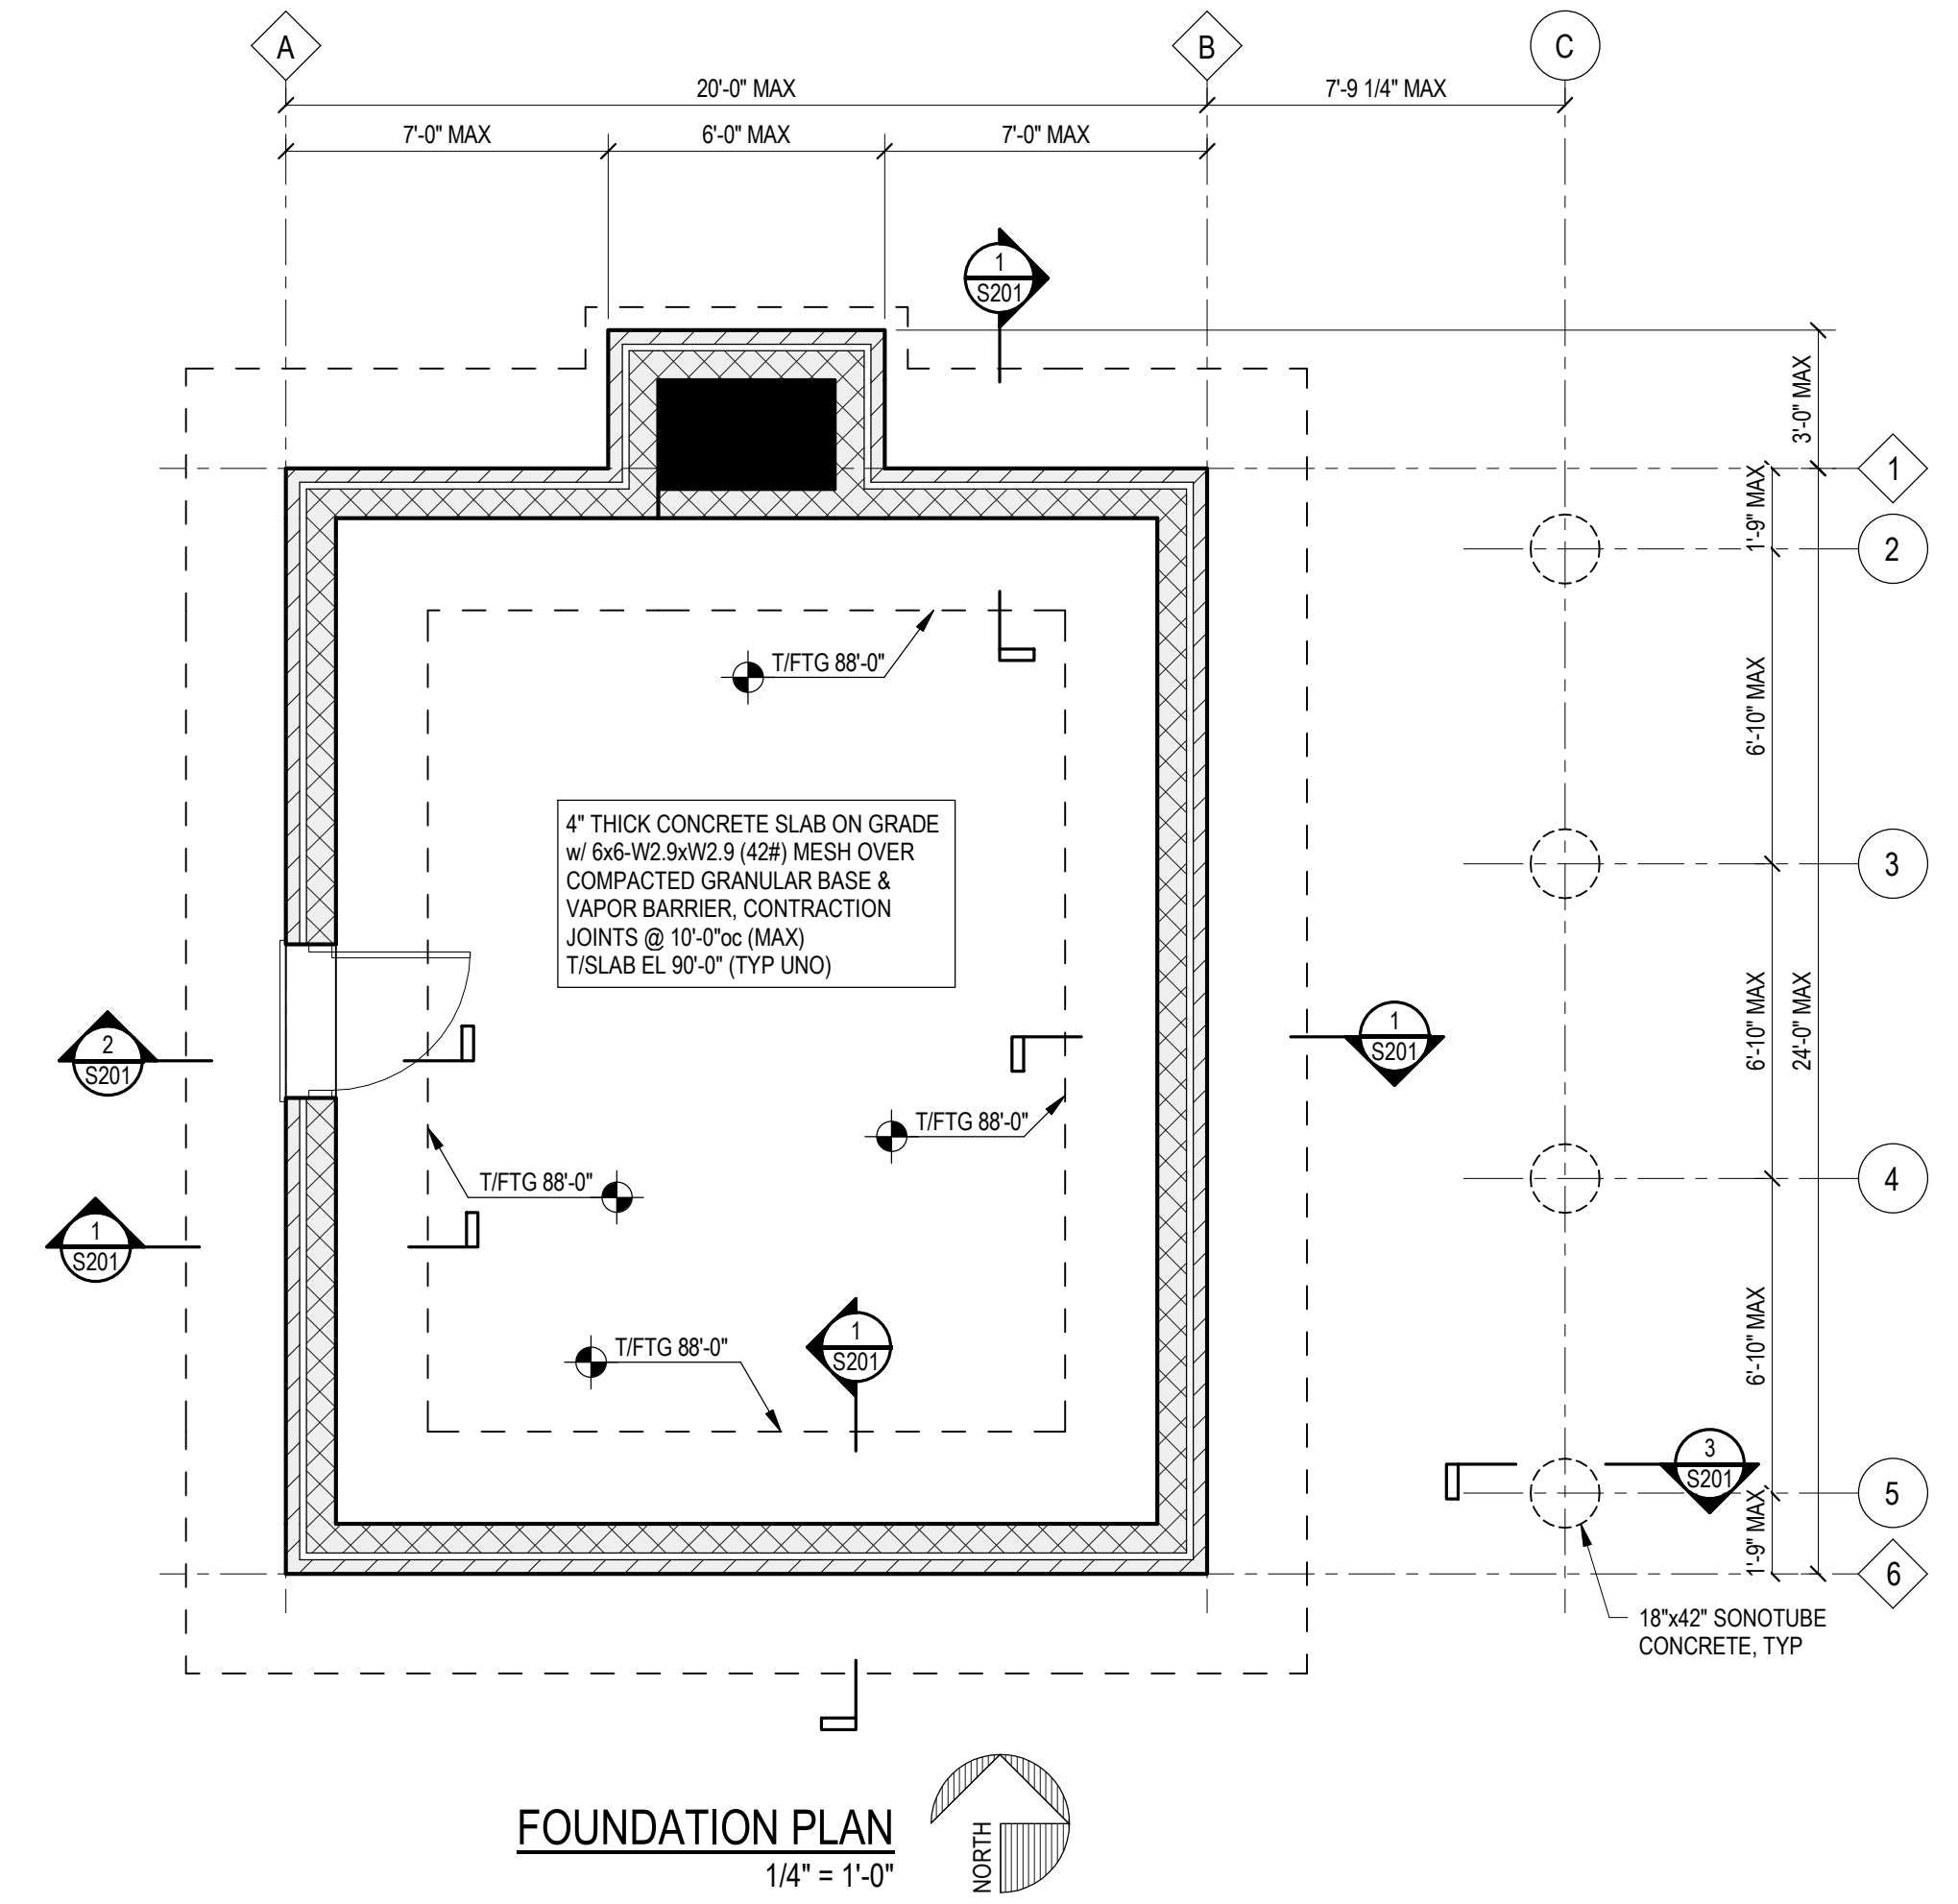
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Issued For: PROGRESS SET
Date: 03/09/2022
Revisions:

SHEET TITLE


FOUNDATION AND FRAMING PLAN

SHEET NUMBER


S101




FOUNDATION PLAN
1/4" = 1'-0"

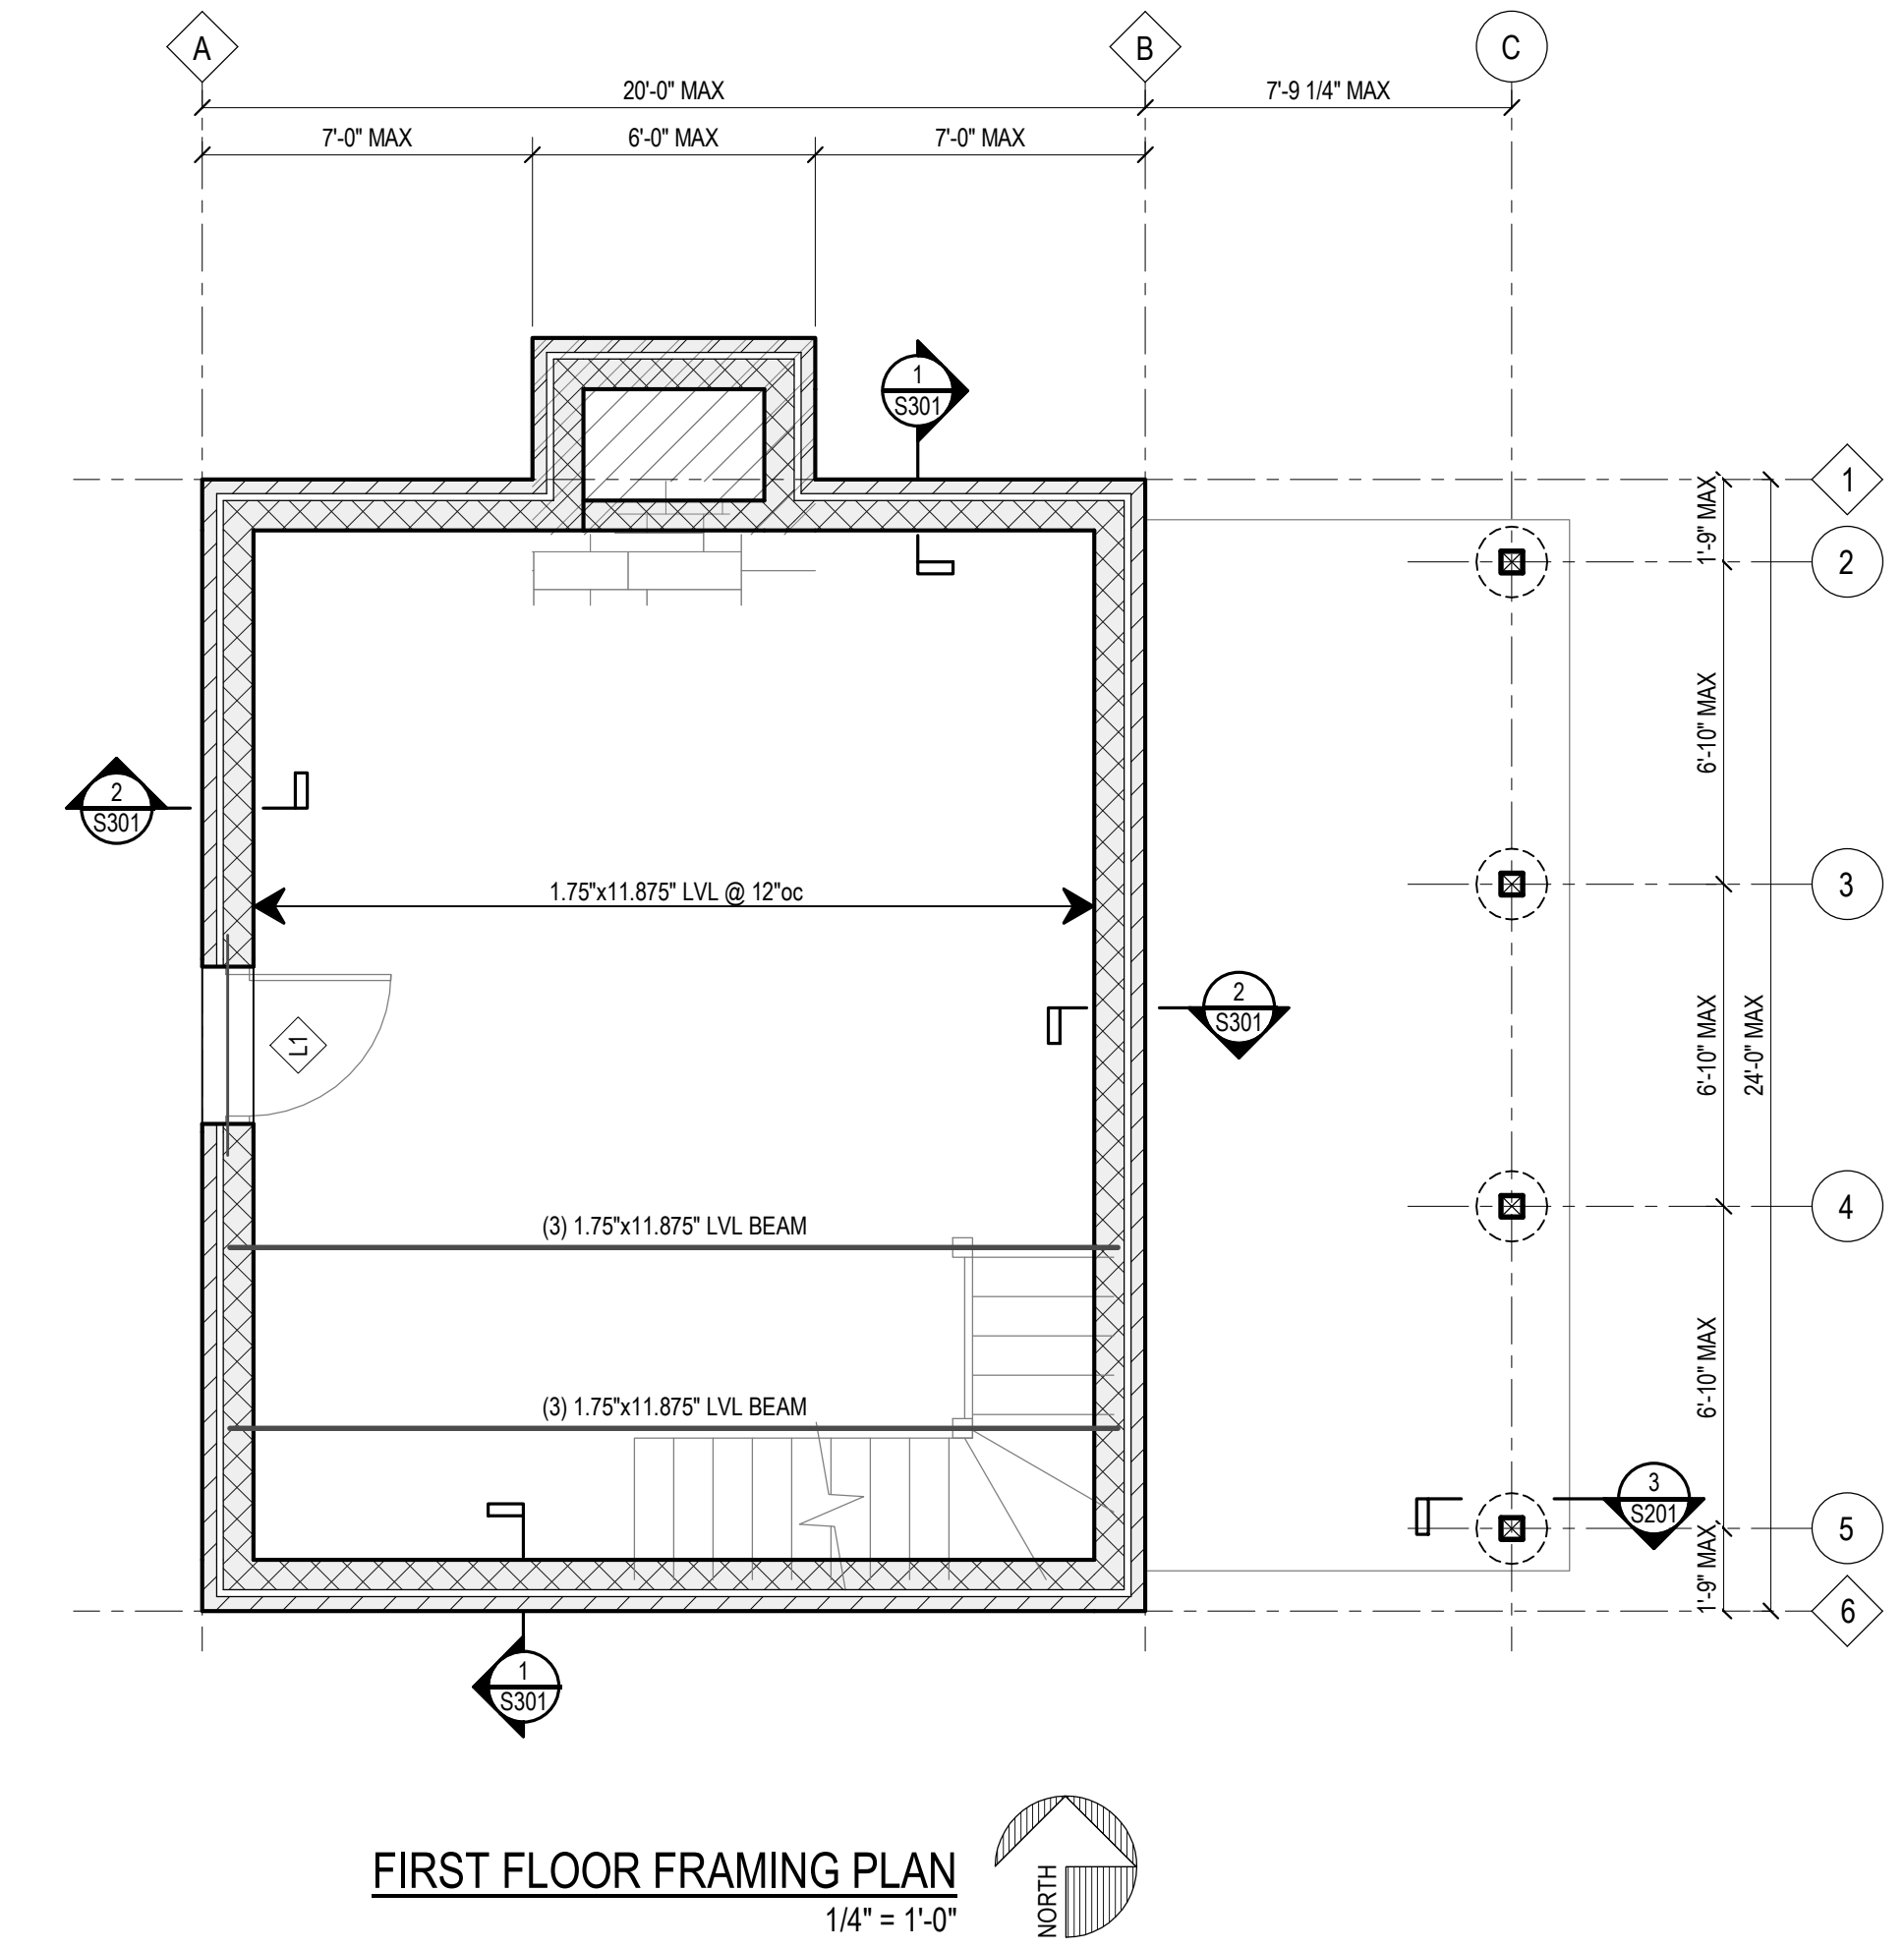

FIRST FLOOR FRAMING PLAN
1/4" = 1'-0"

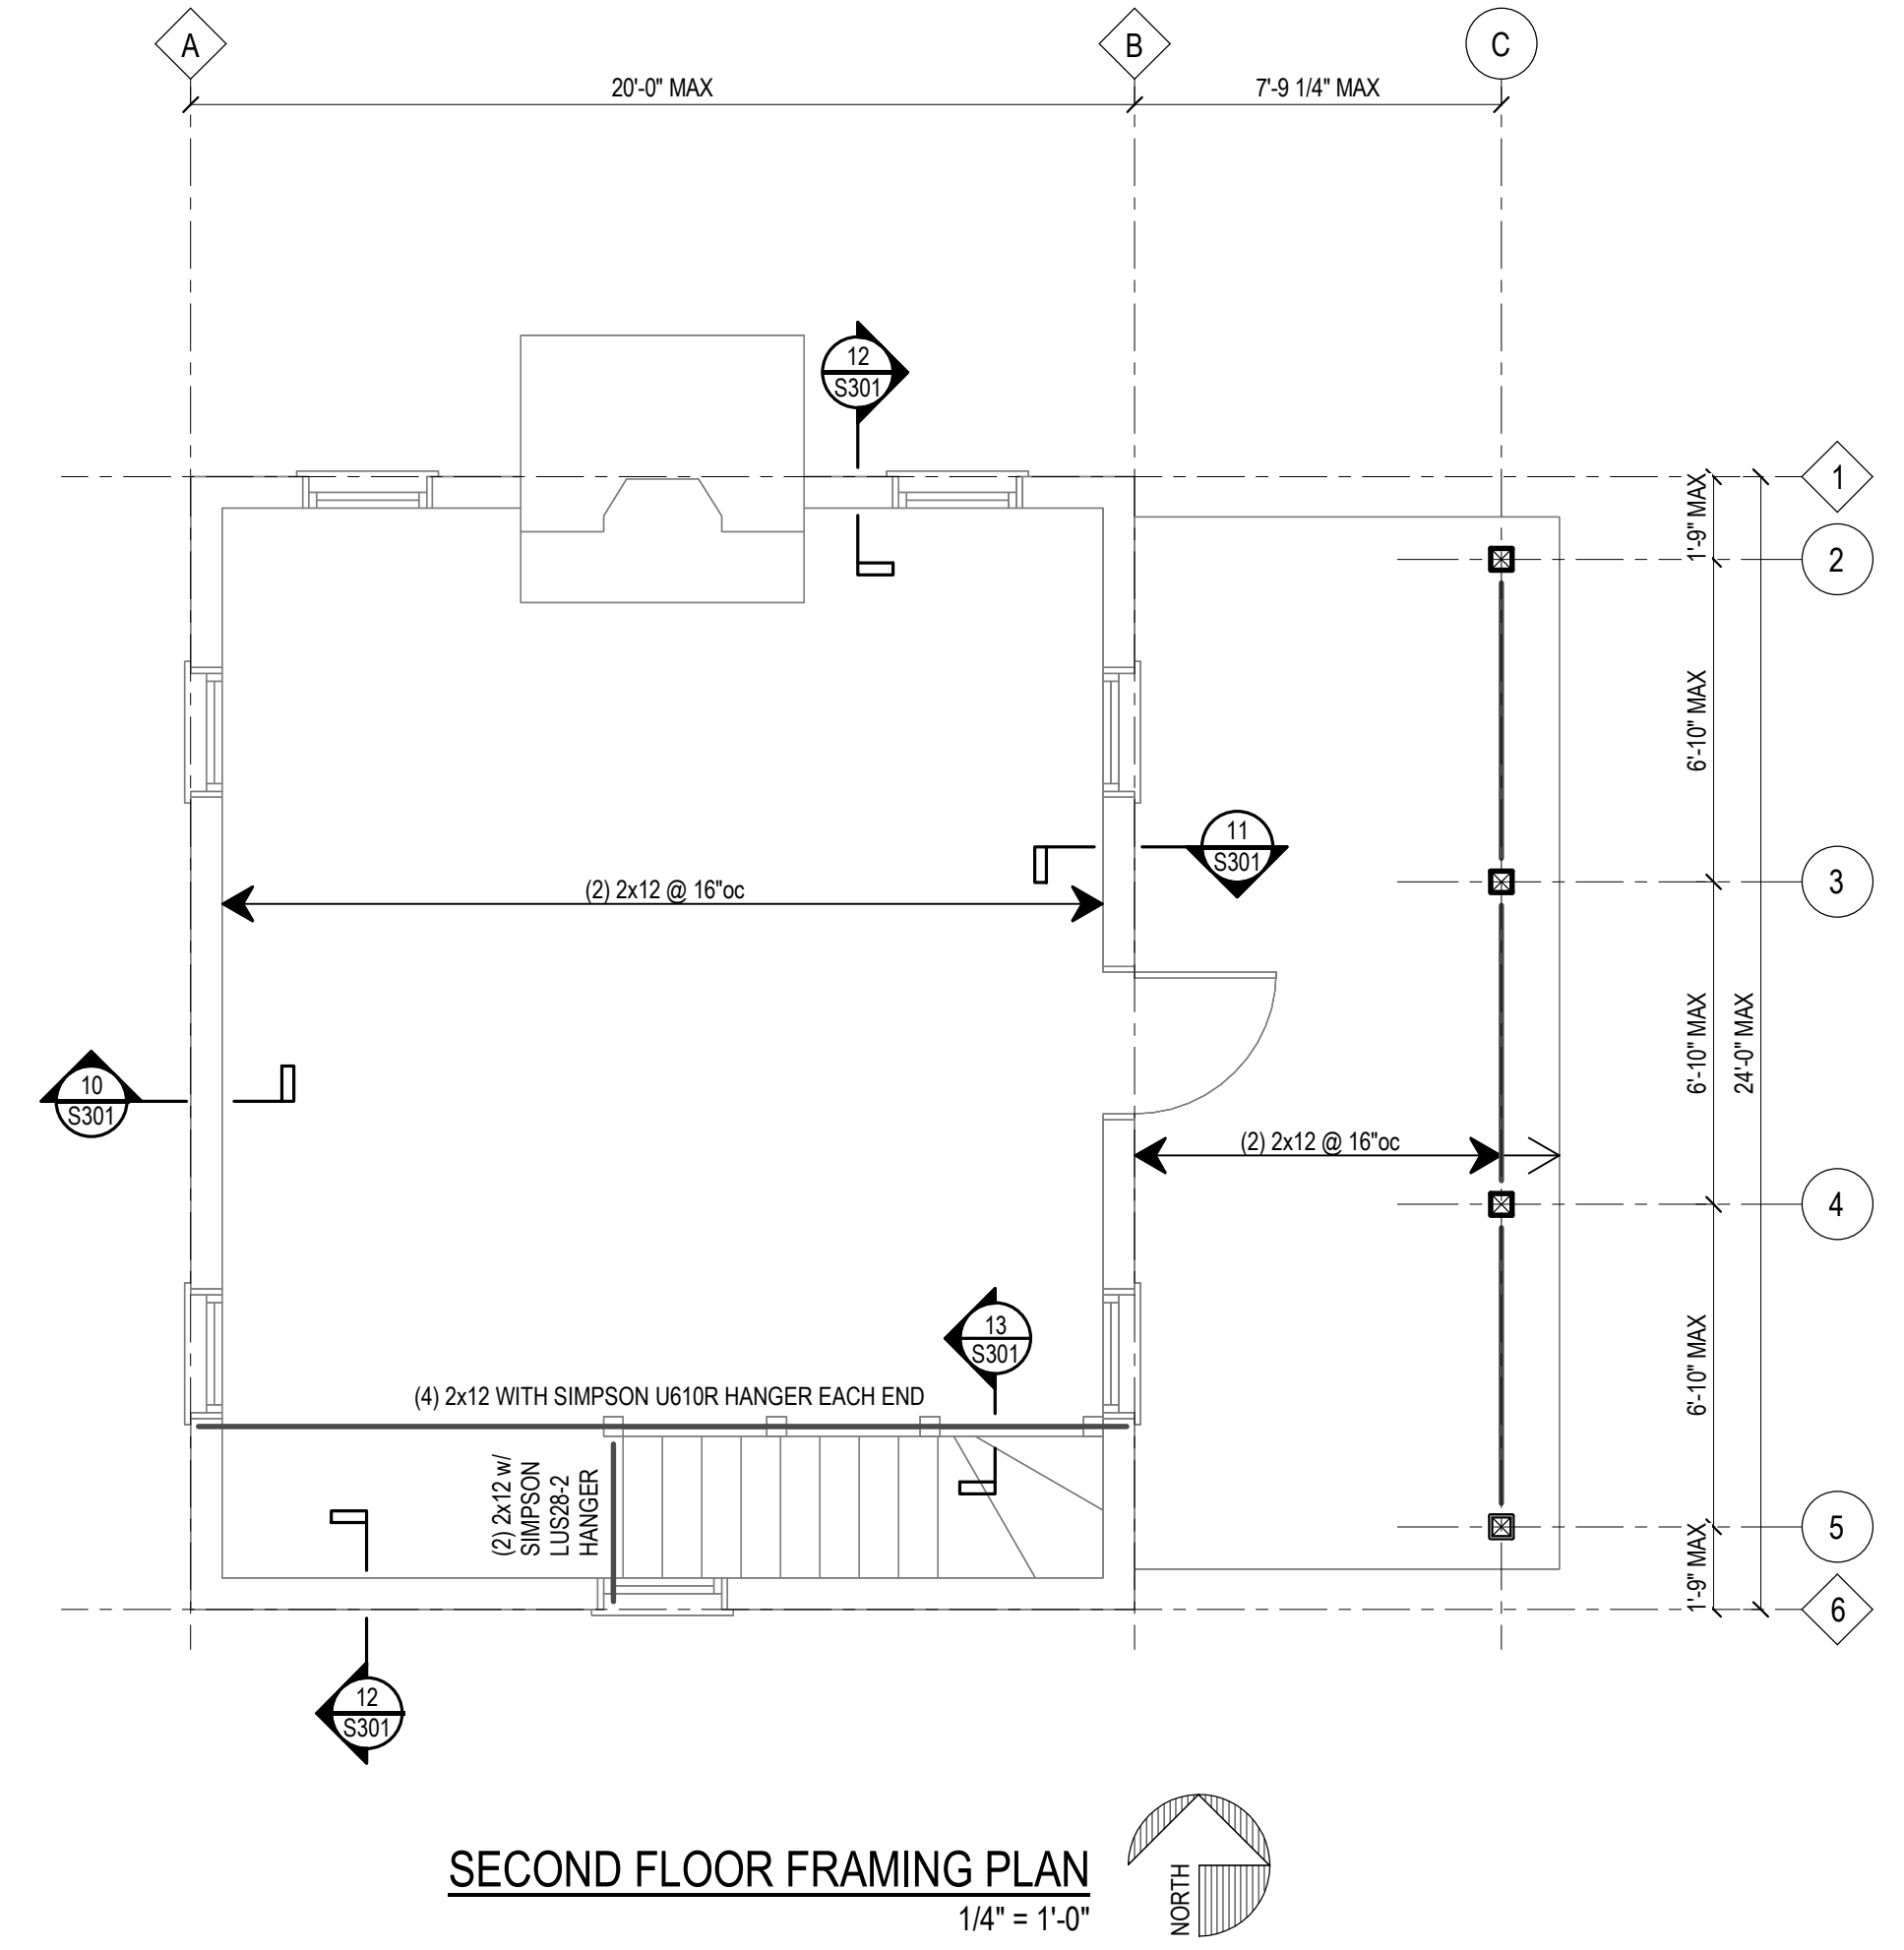


SECOND FLOOR FRAMING PLAN
1/4" = 1'-0"

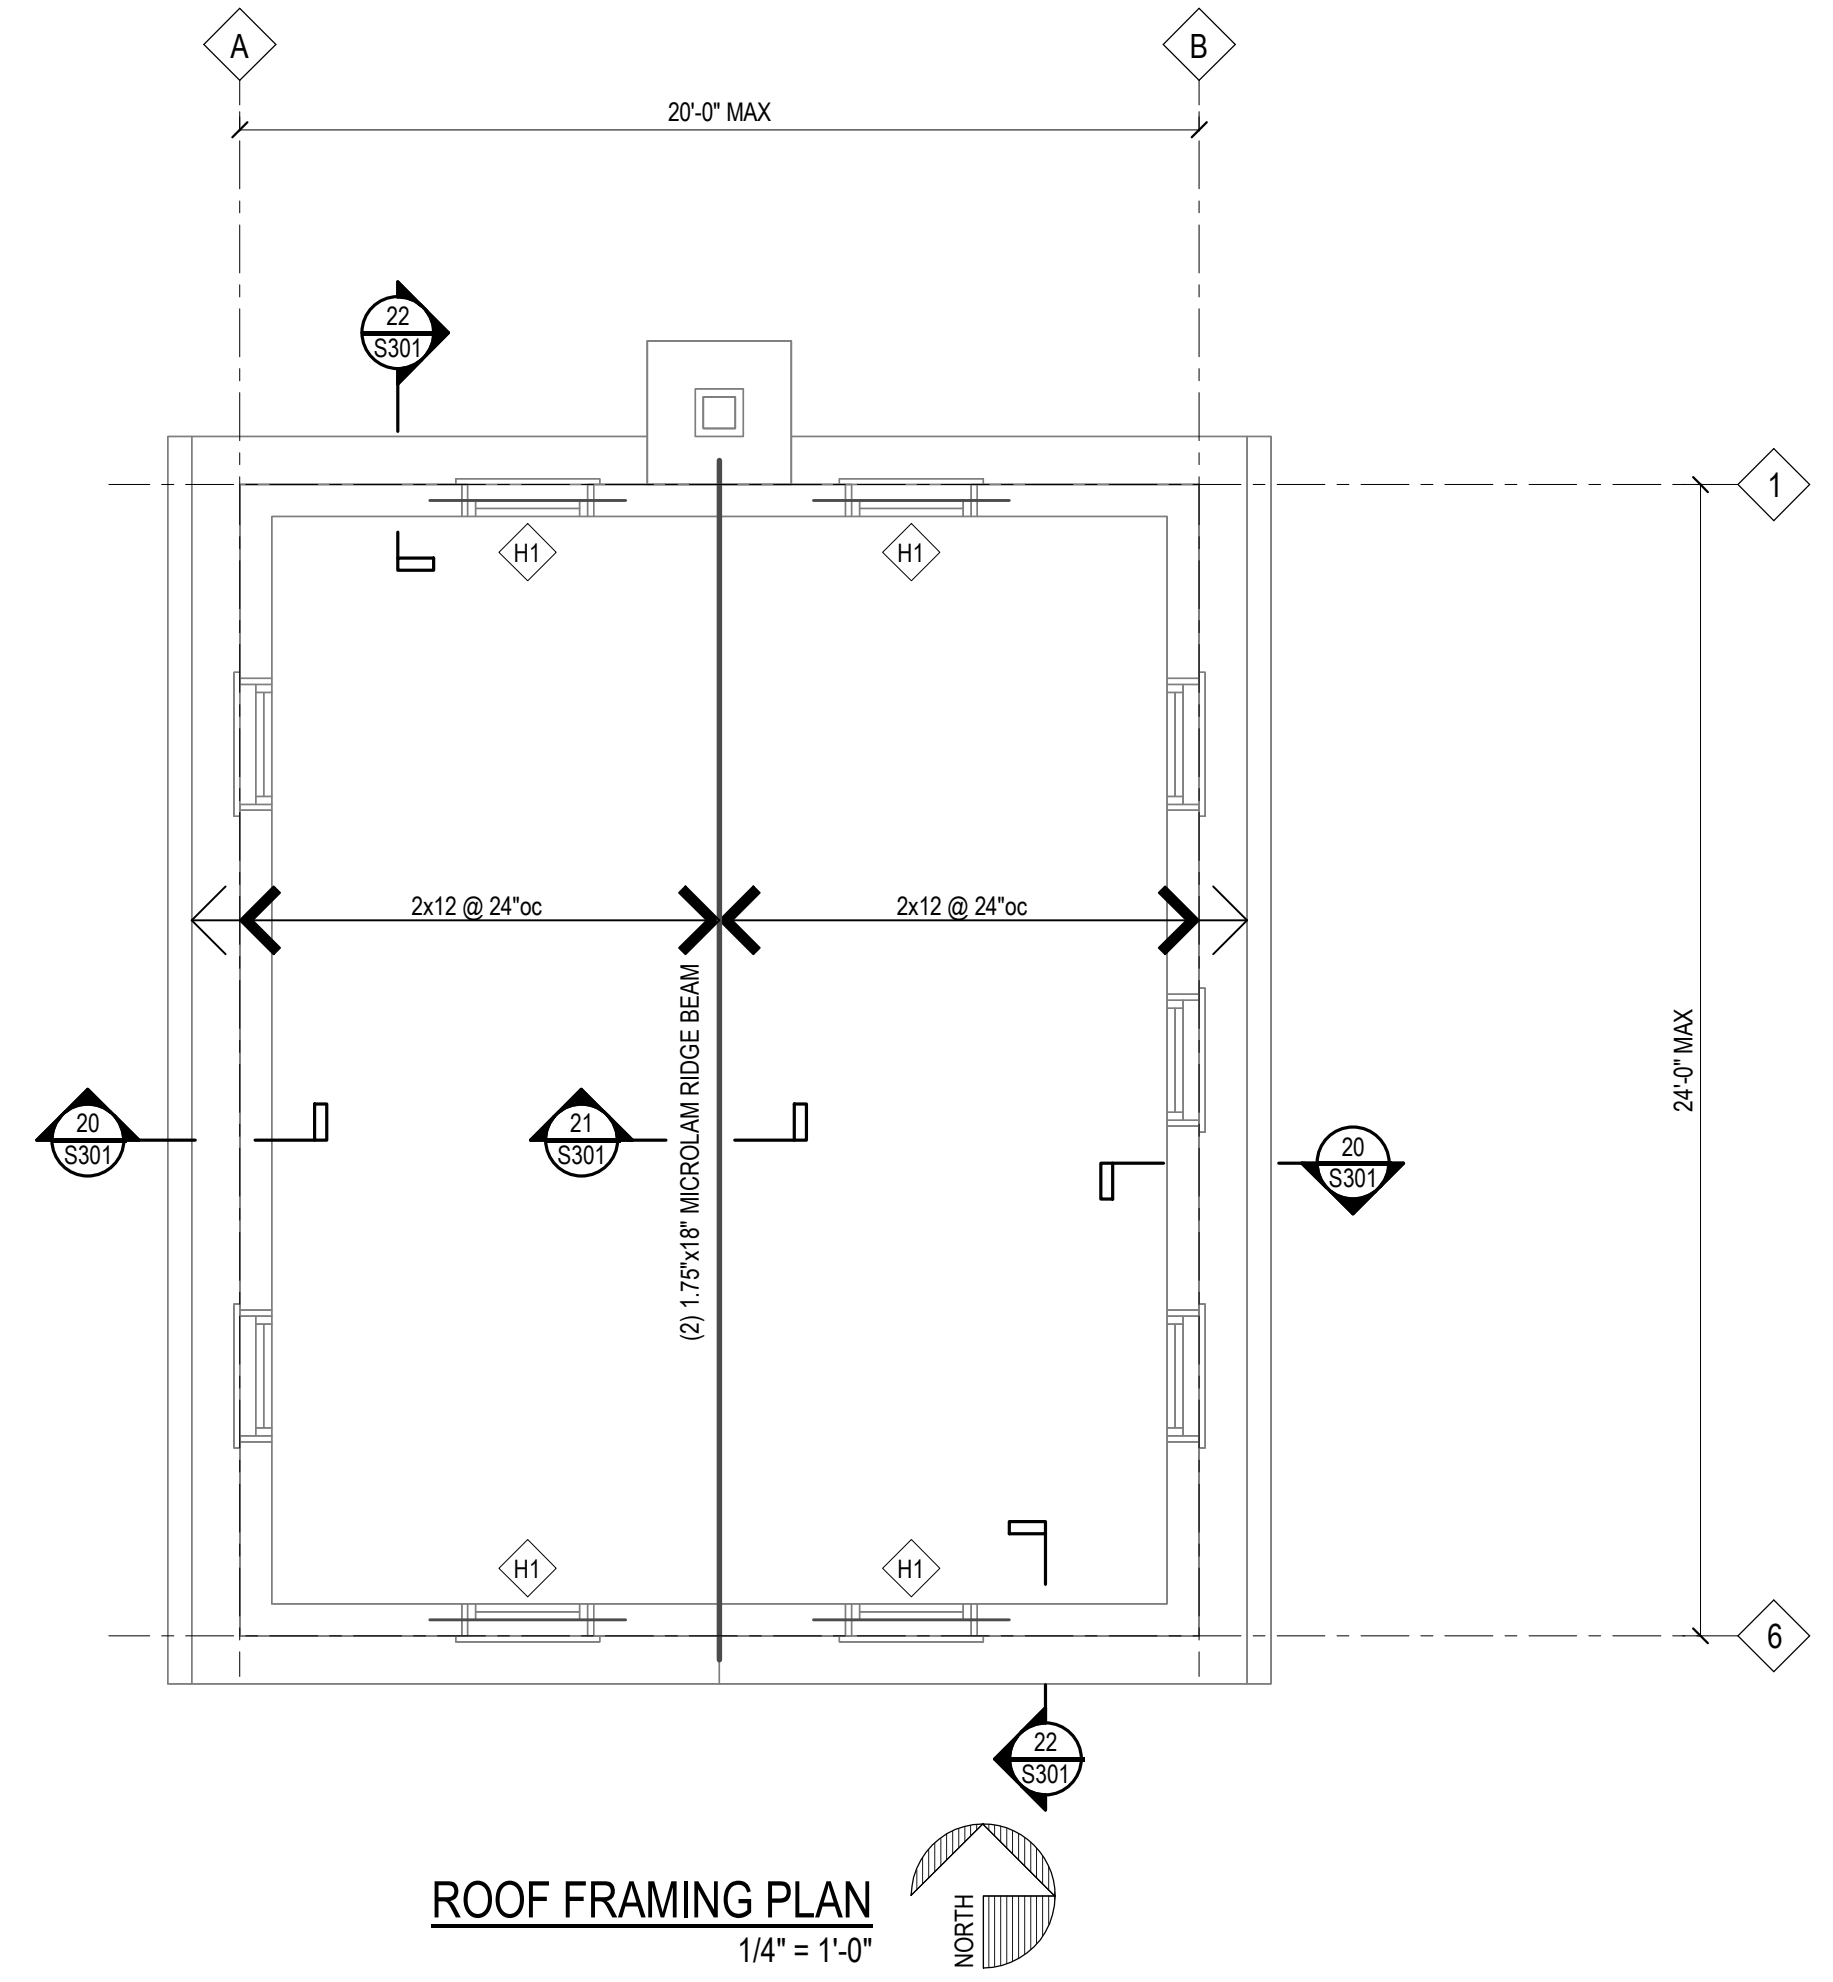

ROOF FRAMING PLAN
1/4" = 1'-0"

3/10/2022 7:28:33 AM
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SHEET INFORMATION

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Date: 03/09/2022
Revisions:

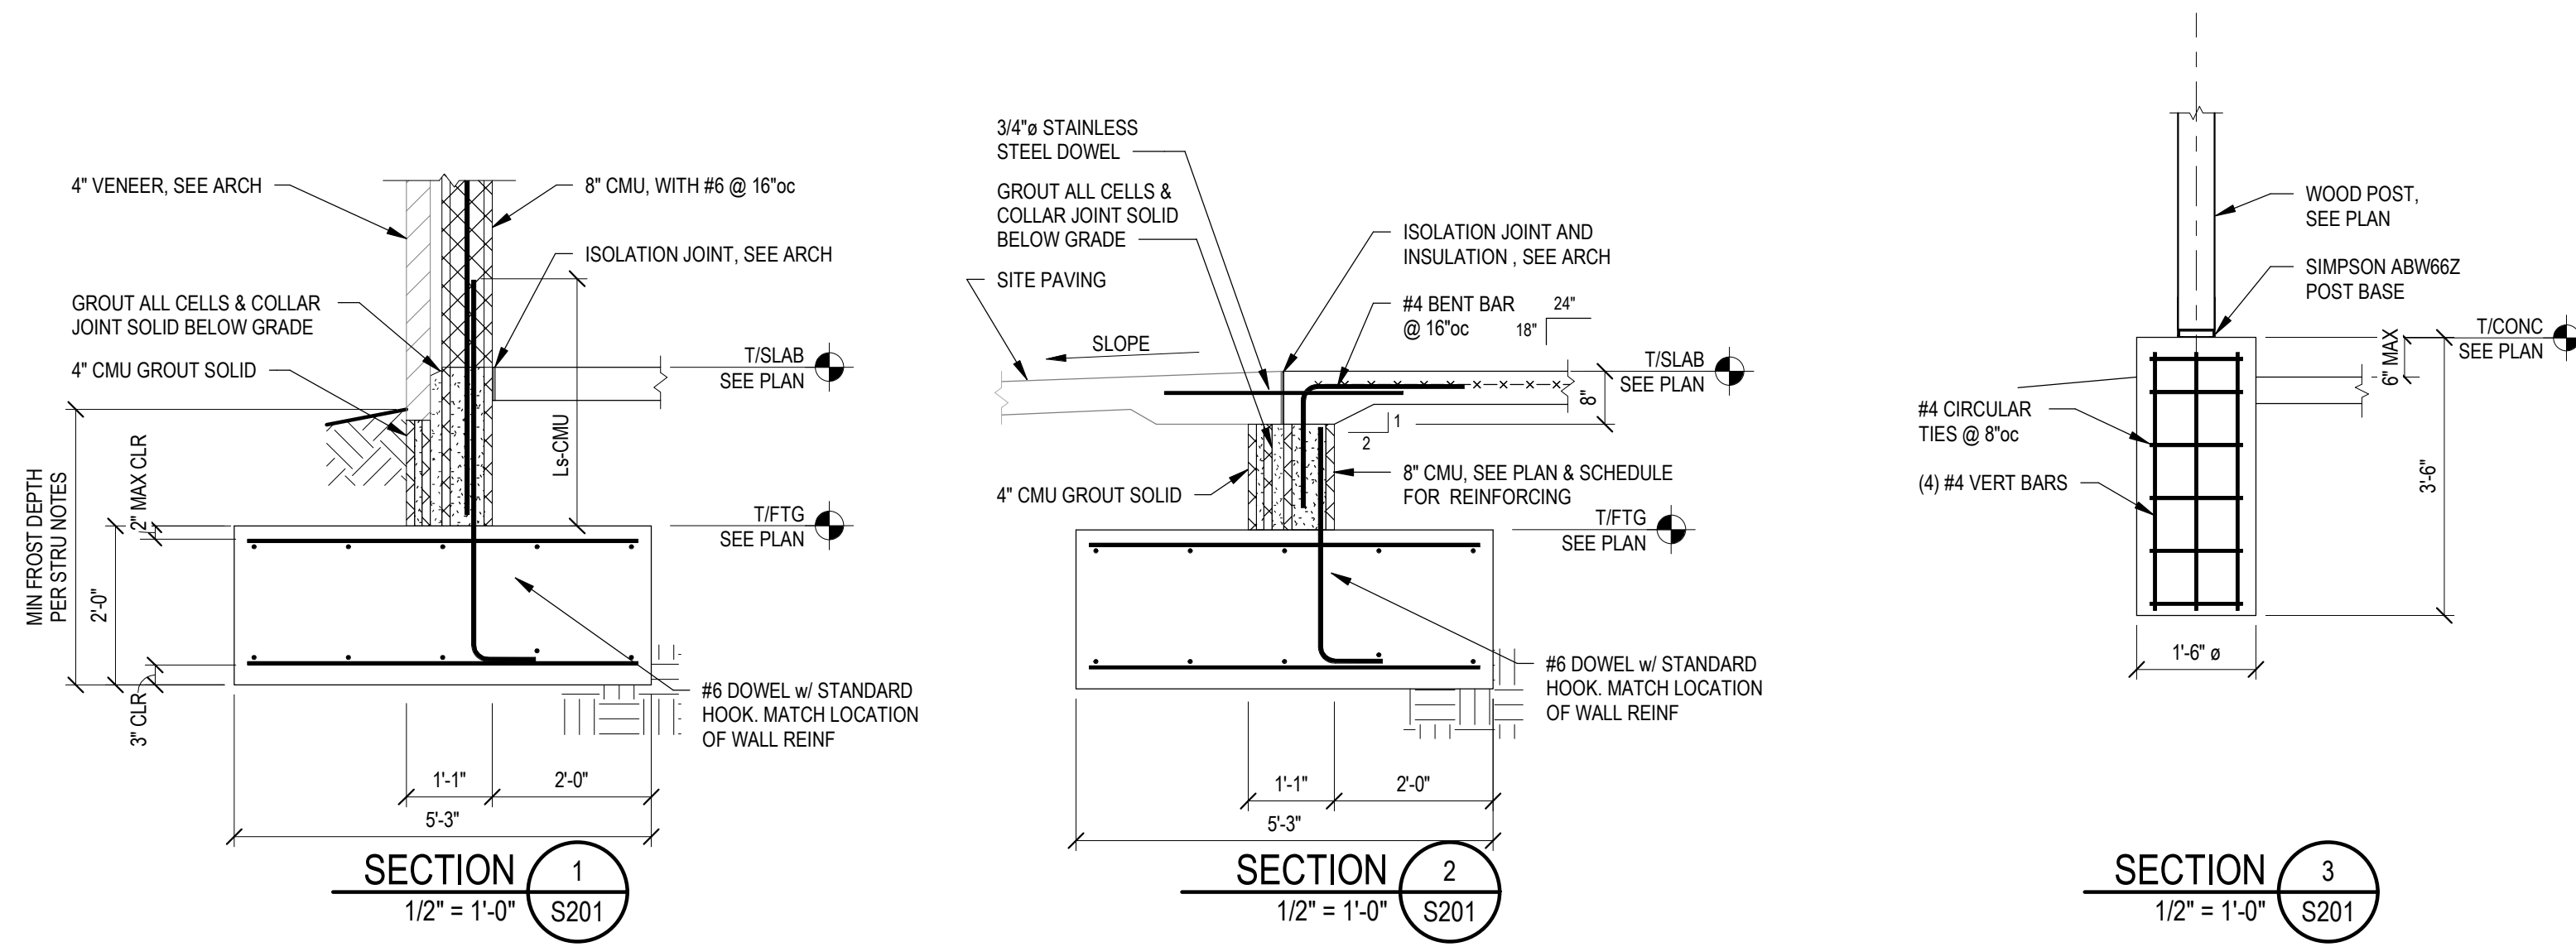SHEET TITLE

TYPICAL FOUNDATION DETAILS & SECTIONS


SHEET NUMBER

S201

LIGHTING FIXTURE SCHEDULE

FIXTURE DESIGNATION	VOLTAGE	MANUFACTURER AND CATALOG NUMBER	FIXTURE DESCRIPTION	LAMPS				MOUNTING OPTIONS	REFER TO NOTE(S)	
				QUANTITY		WATTS	L.E.D. LUMEN OUTPUT AND COLOR TEMP			
				FLUORESCENT	INCANDESCENT					
A	120	LIGHTOLIER #TH10930NF1W (HEAD) LIGHTOLIER #6102NWH (TRACK)	L.E.D. TRACK FIXTURE WITH 1100 LUMEN OUTPUT, NARROW FLOOD DISTRIBUTION, WHITE FINISH. PROVIDE 8-FT. RACK LENGTH AS SHOWN. PROVIDE MOUNTING CLIPS, END FEED AND ALL ACCESSORIES FOR A COMPLETE INSTALLATION.			1	16.3	1100 LUMEN L.E.D. 3000°K	CM	ALL
B	120	TROY RLM LIGHTING #LS-LED12-XX-3	2-1/4" x 4-1/2" L BULLET HEAD L.E.D. FIXTURE W/ALUMINUM FIXTURE HEAD, 360° HORIZONTAL AND 180° VERTICAL ROTATION, MULTI-VOLT, INTEGRATED POWER SUPPLY, 0-10 DIMMING, MONOPPOINT MOUNTING, 25°, 45° AND 65° OPTICS INCLUDED, 2700°K AND 980 LUMENS. COORDINATE FINISH WITH ARCHITECT.			1	14	980 LUMEN 2700°K	CM	ALL
C	120	LIGHTOLIER #L4R10AE1VB/L4R06930VB/L4RDD	4" L.E.D. DOWNLIGHT W/GALVANIZED STEEL MOUNTING FRAME, MOUNTING BRACKETS AND BAR HANGERS, DIFFUSE OPTICAL LENS, 0-10V DIMMING DRIVER TO 1%, 90 CRI, CLEAR REFLECTOR AND WHITE TRIM, 3000°K, 650 LUMEN OUTPUT, DAMP LABEL LISTED.			1	8.6	650 LUMENS 3000°K	R	ALL
D	120	TOPELE #JSL-03	4" x 4" x 6.1" SINGLE LIGHT 1100LM L.E.D. OUTDOOR SECURITY FLOOD LIGHT WITH ALUMINUM HOUSING, CREE L.E.D. SOURCE, 5000°K, BRUSHED STEEL FINISH, 80CRI AND IP65 WET LOCATION LISTED.			1	12	1100 LUMENS 5000°K	CM	ALL
E	120	EXITRONIX #LED-95-BL-G2-R	DECORATIVE SURFACE MOUNTED EMERGENCY BATTERY PACK FIXTURE WITH (2) HEADS AND NICAD BATTERY WITH REMOTE CAPACITY, SELF-DIAGNOSTICS, BLACK IN COLOR.			2	1.5	WITH UNIT	W	ALL
F	120	EXITRONIX #2RL52-BL	DIECAST ALUMINUM DOUBLE HEAD WEATHERPROOF REMOTE HEADS (AND BACKBOX) EACH WITH (2) 1.5 WATT HIGH OUTPUT LED LAMPS AND SELF DIAGNOSTICS, BLACK FINISH.			2	1.5	WITH UNIT	W	ALL
G	120	PROGRESS #P5202-31	6" x 11-5/16" H ADJUSTABLE SWIVEL FLOODLIGHT WITH ALUMINUM HOUSING, WALL MOUNTED, MEDIUM PORCELAIN SOCKET, BLACK FINISH AND WET LOCATION LISTED. MOUNT IN EAVE SPACE TO BE COMPLETELY CONCEALED. PROVIDE AN L.E.D. LAMP EQUIVALENT WITH A 150W PAR-38 LAMP.			1	150	2630 LUMENS 2700°K	W	ALL
H	120	TRACELITE #TLED-NFS-14-V5-4K-XX BEGA #Z2172+K4	7-7/8" x 4-3/4" x 3"D L.E.D. WALL PACK W/DIE-CAST ALUMINUM HOUSING, MATTE SAFETY GLASS, MULTI-VOLT, 0-10 DIMMING DRIVER, 80CRI, 1322 LUMENS AND 4000°K. COORDINATE FIXTURE FINISH WITH ARCHITECT.			1	14.4	1322 LUMENS 4000°K	W	ALL
J	120	DAY-BRITE #FSS440L835-UNV-DIM	48" LONG L.E.D. LINEAR FIXTURE W/FROSTED ACRYLIC LENS, UNIVERSAL VOLTAGE, 85 CRI, 0-10V DIMMING DRIVER, 3500°K, 4000 LUMEN OUTPUT AND DAMP LOCATION LISTED.			1	32	4000 LUMEN 3500°K	CM	ALL


NOTES:
1. SUBMIT A SPECIFIED MANUFACTURER PACKAGE ONLY, WITH MODEL NUMBERS SPECIFIED. DO NOT SUBSTITUTE ON THESE PRODUCTS OR SUBMIT A NON-SPECIFIED AGENT'S PACKAGE.

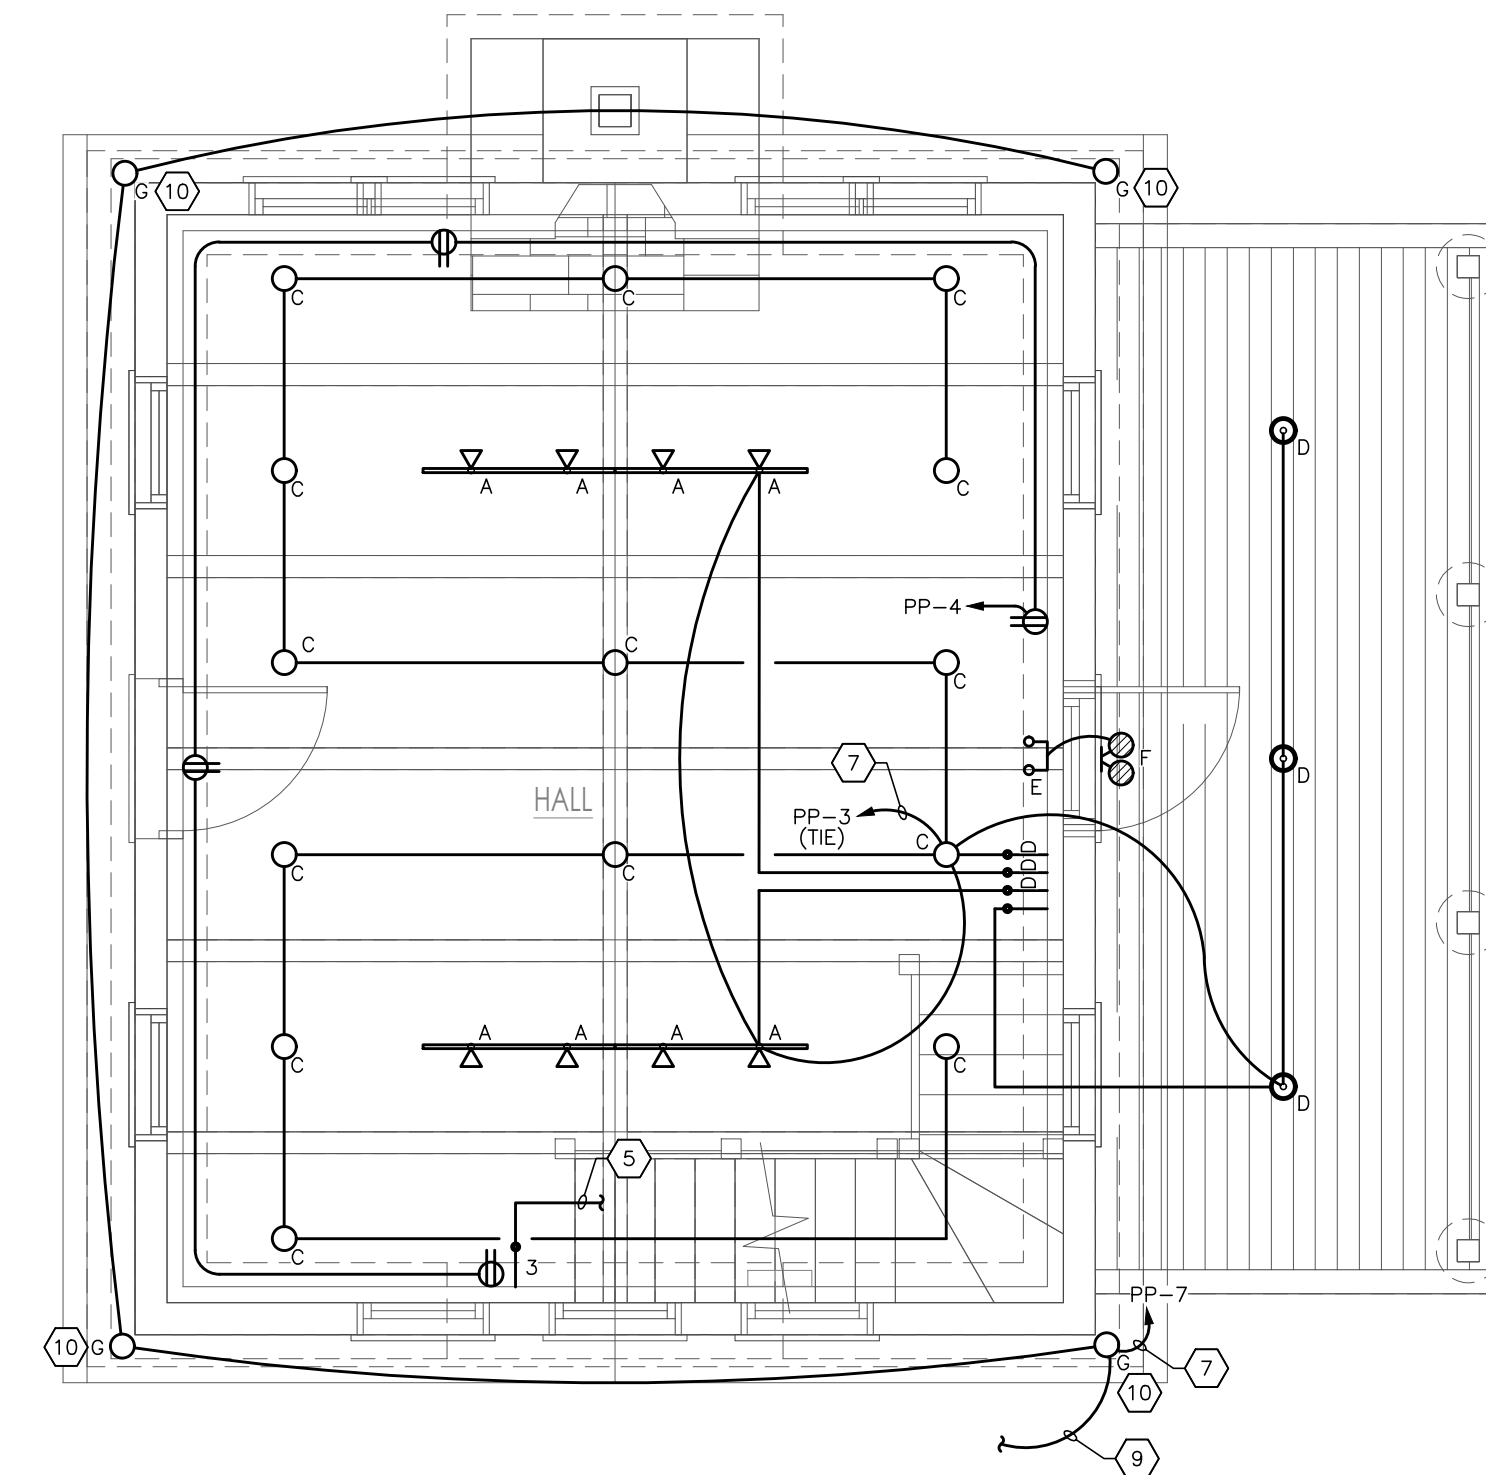


FIRST FLOOR ELECTRICAL PLAN
SCALE: 1/4"=1'-0"

- #### GENERAL NOTES
- EVERYTHING SHOWN ON THIS DRAWING AND/OR IDENTIFIED IN THE DIVISION 26, 27, AND 28 SPECIFICATIONS IS FURNISHED AND INSTALLED BY THE ELECTRICAL CONTRACTOR. IF ANY DEVICE, EQUIPMENT, FEEDERS, ETC. IS FURNISHED AND/OR INSTALLED BY ANYONE OTHER THAN THE ELECTRICAL CONTRACTOR, IT WILL BE SPECIFICALLY NOTED.
 - EC SHALL REVIEW OTHER TRADES DRAWINGS, AND COORDINATE WITH OTHER TRADES TO AVOID CONFLICTS WITH THE EC'S INSTALLATIONS. FAILURE TO COORDINATE WILL RESULT IN THE EC REMEDYING HIS CONFLICT(S) AT HIS EXPENSE.
 - FOR VOLTAGE DROP ON 120V CIRCUITS, THE MAXIMUM LENGTHS ARE AS FOLLOWS: #12=65 FEET, #10=108 FEET, AND #8=162 FEET. FOR 277V CIRCUITS, MAXIMUM LENGTHS SHALL BE #12=150 FEET, #10=247 FEET, AND #8=375 FEET. THESE DISTANCES MUST BE FOLLOWED TO MAINTAIN 3% VOLTAGE DROP.
 - ALL BACKBOXES LOCATED IN RATED WALLS MUST BE ENCASED IN FIRE PUTTY SEALANT. ALL CONDUITS THAT PASS THRU RATED WALLS MUST BE FIRE SEALED ON BOTH SIDES OF THE WALL. COORDINATE WITH THE ARCHITECT'S DRAWINGS FOR LOCATIONS OF THE RATED WALLS.
 - SEE ARCHITECTURAL REFLECTED CEILING PLAN FOR EXACT LOCATION OF ALL LIGHT FIXTURES.
 - CONNECT ALL EXIT SIGNS, EMERGENCY/NIGHT LIGHTS (EM/NL) TO LOCAL CIRCUIT AHEAD OF ANY SWITCH LEGS.

- #### PLAN NOTES
- NEW LOADCENTER "PP" - 60A, 120/240V, 1ø, 3W.
 - COORDINATE EXACT MOUNTING LOCATION WITH ARCHITECT.
 - CONNECT FIXTURE TO LOCAL CIRCUIT AHEAD OF SWITCH LEG.
 - DOWN TO SWITCH ON FIRST FLOOR.
 - UP TO FIXTURES IN ATTIC.
 - SINGLE CHANNEL DIGITAL TIME SWITCH "TCT" FOR LIGHTING CONTROL: PROVIDE DIGITAL 365/7-DAY SUNSET TIME SWITCH WITH (2) CHANNELS IN A NEMA 1 ENCLOSURE AND ACCESSORY PHOTO SENSOR TORQUE #DGLC100A-NC OR EQUAL. MOUNT PHOTOCELL ON ROOF PARAPET FACING NORTH AND AWAY FROM ALL INTERFERING LIGHT SOURCES. PROVIDE LIGHT SHIELDING COVER AS REQUIRED. CONNECT TO A 20A-1P CIRCUIT BREAKER IN PANEL.
 - WIRE CIRCUIT THRU DIGITAL TIMECLOCK "TCT" AND CONNECT TO A 20A-1P CIRCUIT BREAKER IN PANEL. LIGHTS TO COME ON AT DUSK VIA PHOTOCELL. COORDINATE EXACT ON/OFF SCHEDULE WITH OWNER.
 - CONNECT TO BUILDING FLOOD LIGHTS ON 1ST FLOOR. SEE FIRST FLOOR ELECTRICAL PLAN FOR ADDITIONAL INFORMATION.
 - CONNECT TO WALL PACKS ON BASEMENT WING WALLS. SEE BASEMENT ELECTRICAL PLAN FOR ADDITIONAL INFORMATION.
 - MOUNT FIXTURE UNDER OVERHANG AT CORNER OF EAVES. COORDINATE MOUNTING LOCATION WITH ARCHITECT.
 - COORDINATE EXACT MOUNTING HEIGHT AND LOCATION WITH ARCHITECT.
 -

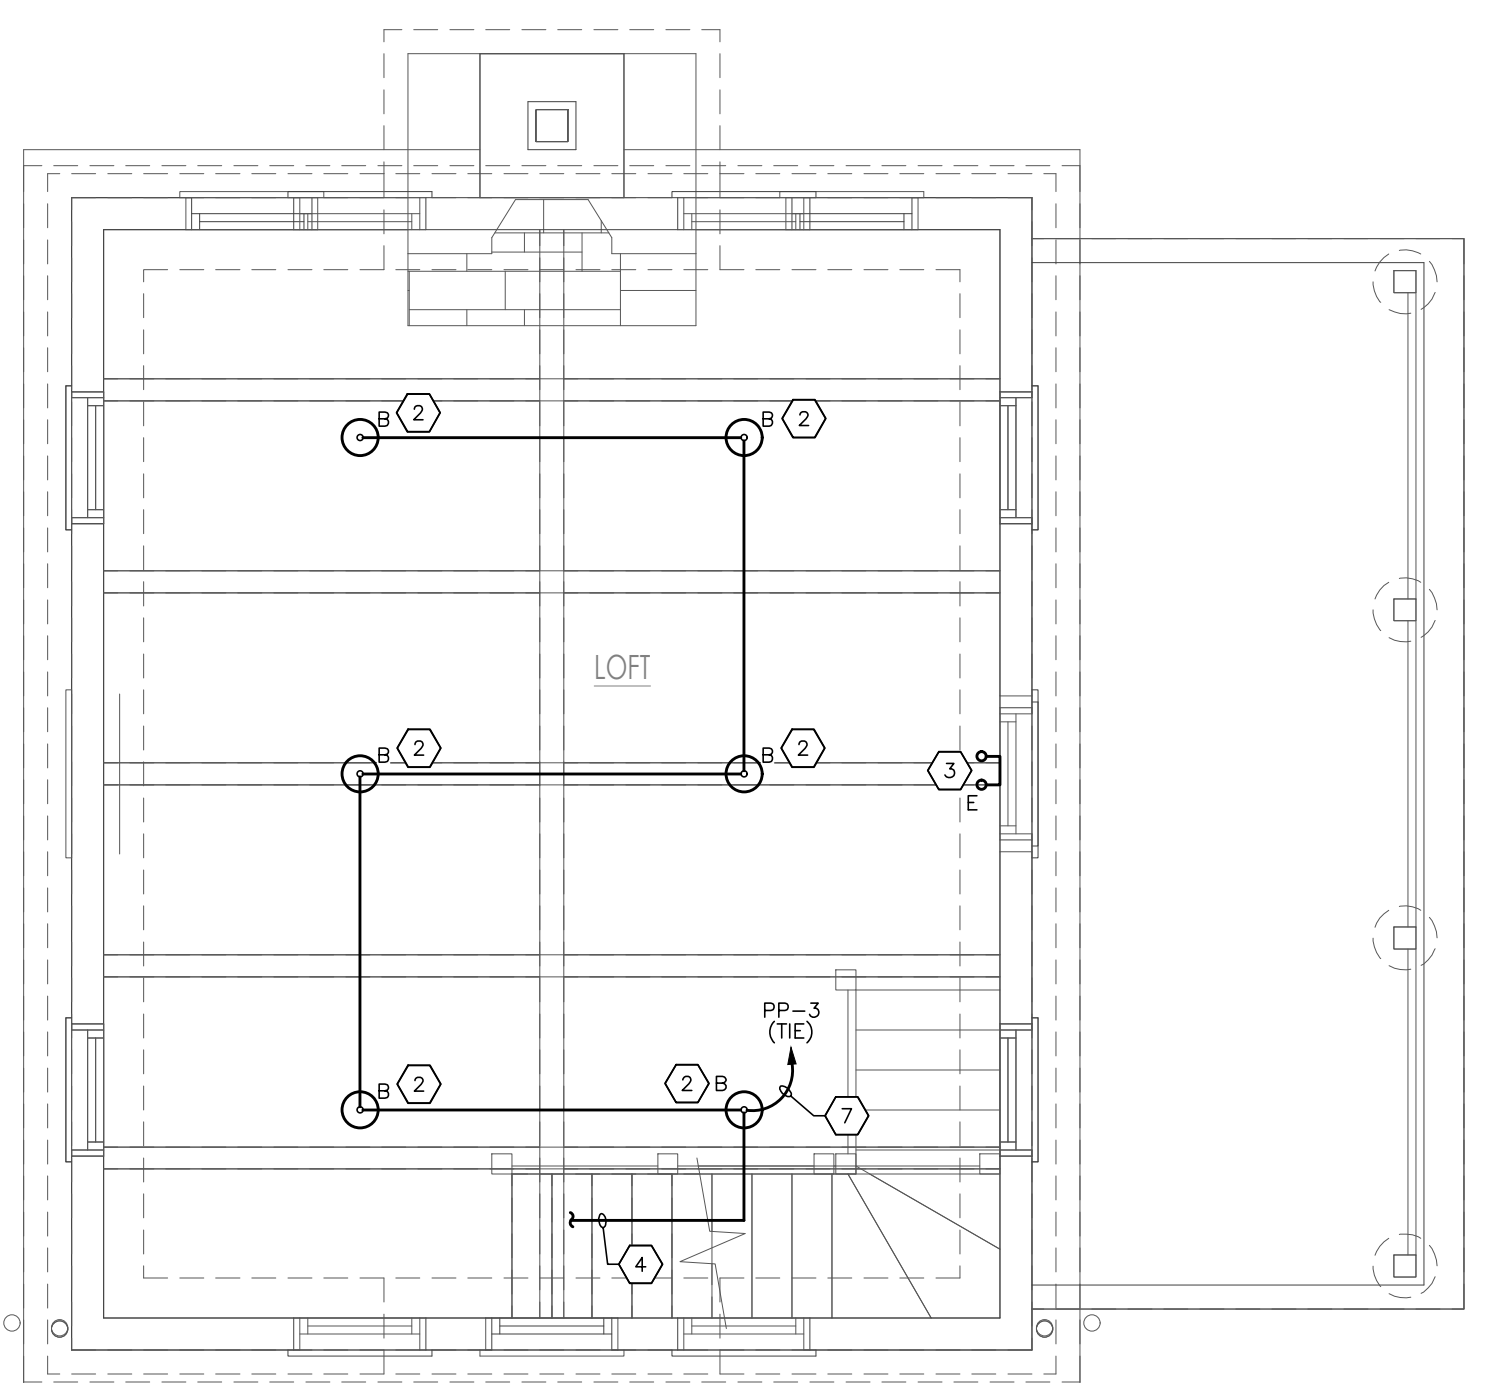


ATTIC/LOFT ELECTRICAL PLAN
SCALE: 1/4"=1'-0"

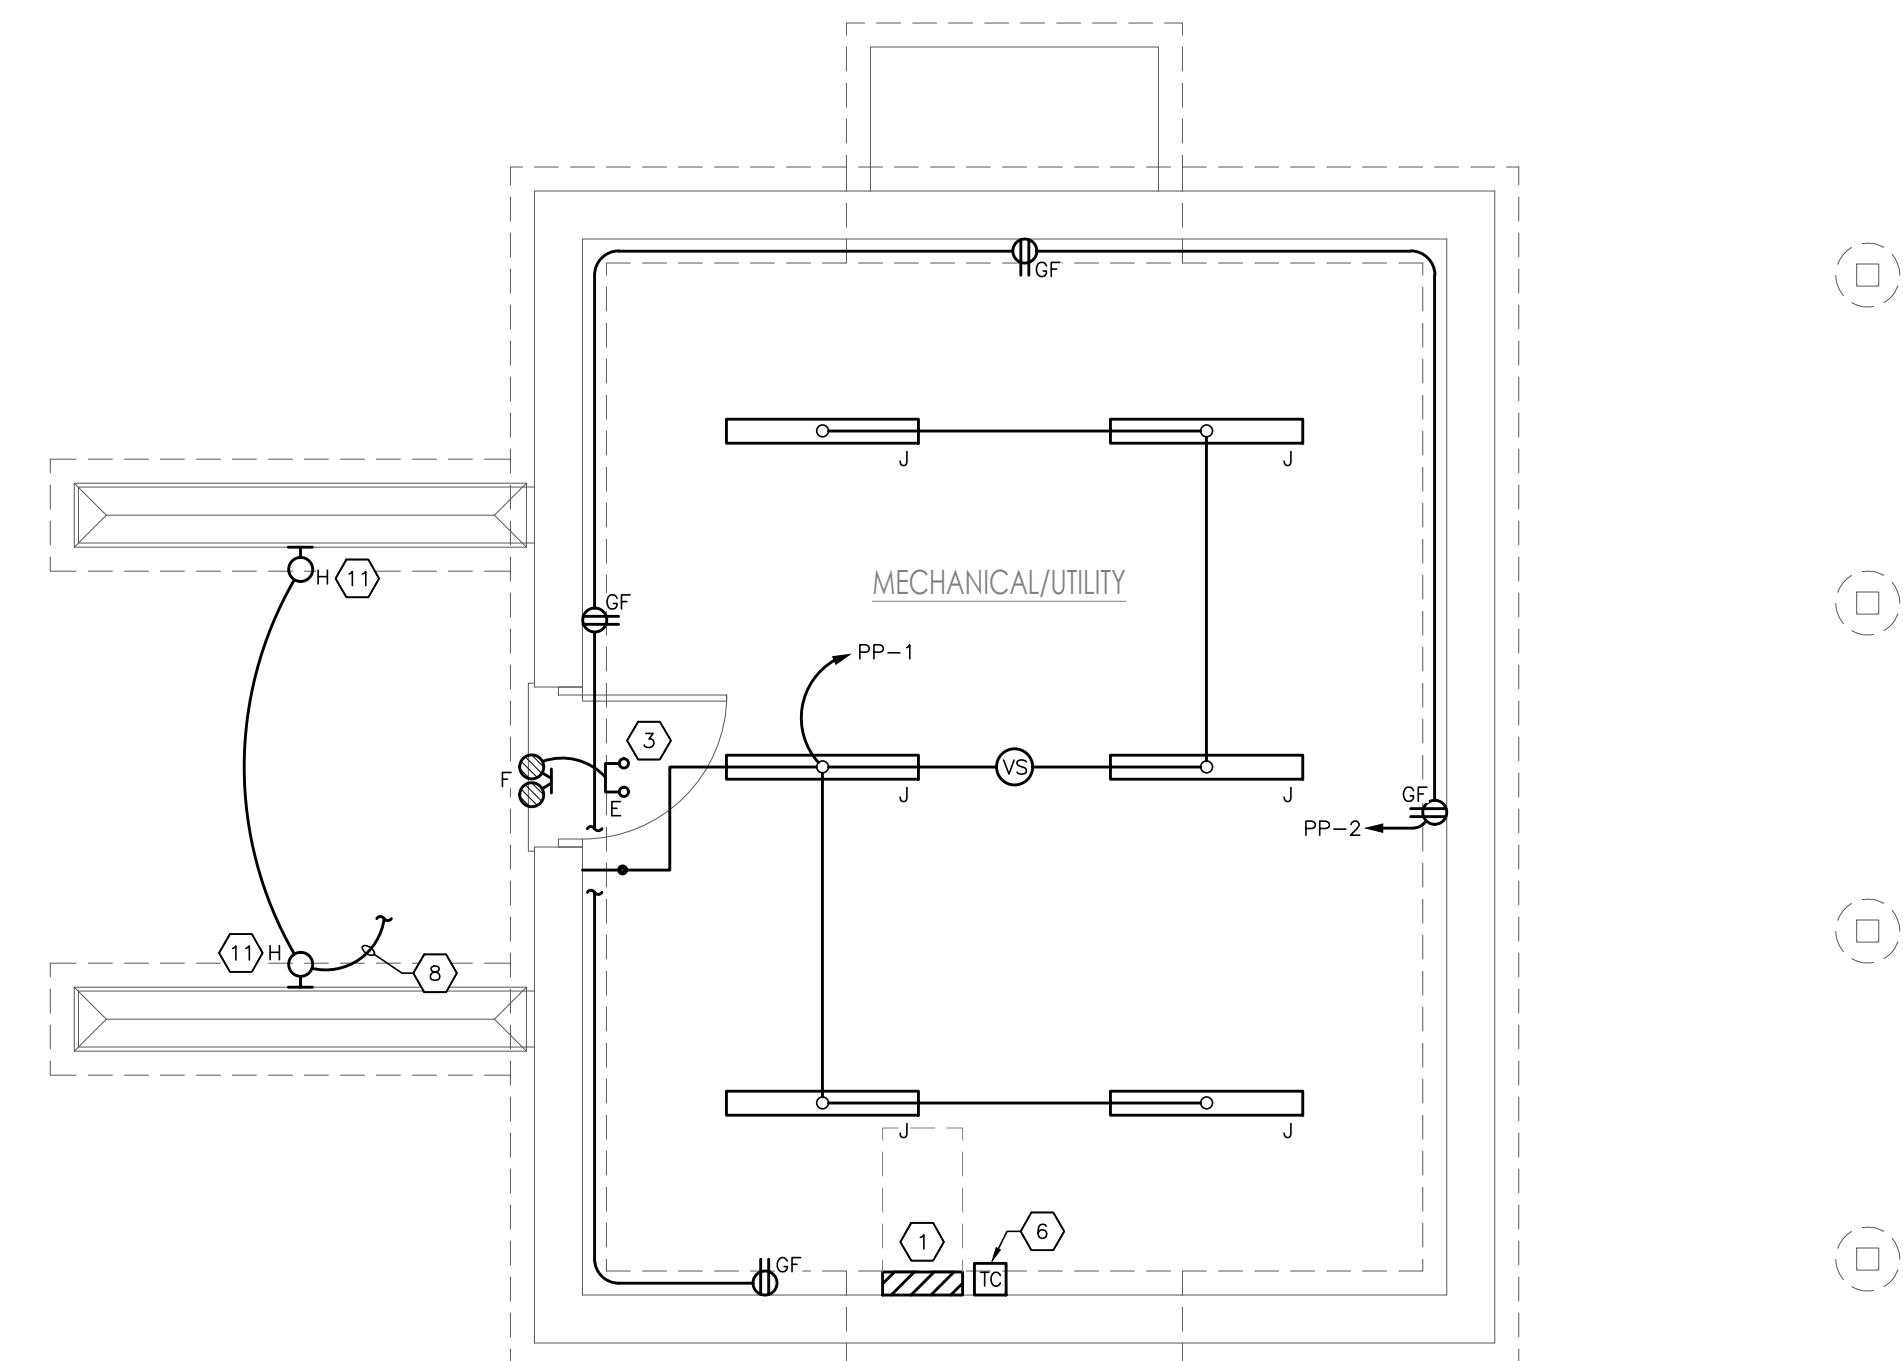


BASEMENT ELECTRICAL PLAN
SCALE: 1/4"=1'-0"

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www.VMPengineering.com

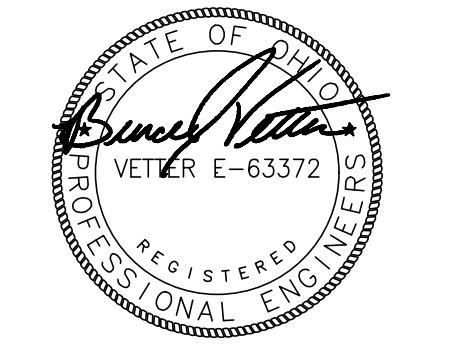

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SHEET INFORMATION

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SHEET TITLE

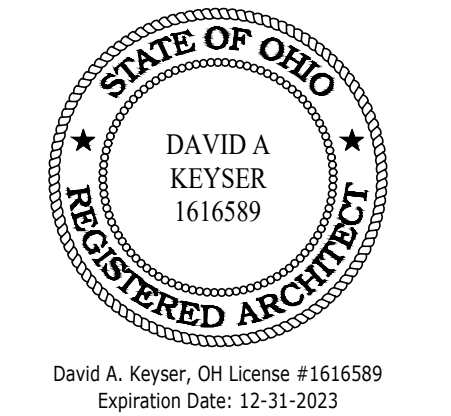BASEMENT, FIRST FLOOR AND ATTIC ELECTRICAL PLANS

SHEET NUMBER


E-1

ELECTRICAL SPECIFICATIONS

1. GENERAL
 - A. FURNISH AND INSTALL A COMPLETE ELECTRICAL SYSTEM AS SHOWN ON THE DRAWINGS AND AS SPECIFIED HERE-IN. WORK INCLUDES, BUT IS NOT NECESSARILY LIMITED TO THE FOLLOWING CATEGORIES:
 - 1) WIRING DEVICES
 - 2) POWER WIRING
 - 3) MISCELLANEOUS WIRING AND INTERLOCKS
 - 4) EQUIPMENT CONNECTIONS
 - 5) LIGHTING FIXTURES
 - B. OBTAIN AND PAY FOR ALL PERMITS. UPON COMPLETION, PROVIDE A CERTIFICATE OF INSPECTIONS FROM THE GOVERNING ELECTRICAL AUTHORITY.
 - C. DURING THE BIDDING PERIOD, INSPECT THE SITE AND PREMISES OF PROPOSED WORK. REPORT IMMEDIATELY ANY OBSERVED DISCREPANCIES AS RELATED TO THE PLANS OR REQUIRED WORK. ALL WORK SHALL COMPLY WITH N.E.C.
 - D. WHERE TRADE NAMES, BRANDS, OR MANUFACTURERS ARE LISTED, ANY ONE OF THE NAMED ARE CONSIDERED EQUALLY ACCEPTABLE. NON-SPECIFIED MANUFACTURERS, PRODUCTS, OR MATERIAL SHALL BE USED UNLESS IT IS SUBMITTED DURING BIDDING, WITH STATED CHANGE IN COST, AND APPROVED BY THE ENGINEER PRIOR TO PLACEMENT OF ORDER. SUBMIT SHOP DRAWINGS ON ALL EQUIPMENT AND MATERIALS.
 - E. WORKMANSHIP SHALL BE FIRST CLASS. THE ARCHITECT AND/OR ENGINEER'S JUDGEMENT SHALL PREVAIL IF THE QUALITY IS SUSPECT.
 - F. PROTECT MATERIAL AND EQUIPMENT AFTER DELIVERY TO THE JOB SITE. RESPECT OTHER TRADES AS RELATED TO PROTECTING THEIR WORK AND TO AVOID CONSTRUCTION INTERFERENCES. CALL ATTENTION TO PROBLEMS RELATING TO SPACE REQUIREMENTS SO EARLY RESOLUTION MAY BE OBTAINED. RESPECT THE OWNER'S PROPERTY AT ALL TIMES.
 - G. CUT AND PATCH TO INSTALL WORK WHERE FAILURE TO INSTALL SLEEVES OCCURS, OR PAY OTHERS TO PERFORM SUCH WORK. THE ELECTRICAL CONTRACTOR SHALL BE RESPONSIBLE TO PERFORM ALL OF HIS OWN CUTTING AND PATCHING OF FLOORS AND WALLS WHERE NECESSARY TO INSTALL ELECTRICAL EQUIPMENT. CONCRETE SHALL BE SAW CUT, NEATLY AND ACCURATELY. NECESSARY HOLES SHALL BE CORE DRILLED AND FIRE SEALED. PATCHING SHALL BE DONE TO MATCH BOTH THICKNESS AND FINISH OF ADJACENT MATERIAL. GENERAL CONTRACTOR SHALL DO ALL PATCHING WORK, PAID FOR BY THE ELECTRICAL CONTRACTOR.
 - H. CONDUITS, CABLES AND WIRING WHICH PENETRATE WALLS, SLABS, MASONRY, ETC., SHALL DO SO THROUGH PIPE SLEEVES. PENETRATIONS THROUGH ALL ASSEMBLIES SHALL HAVE SLEEVES AND BE SEALED OUTSIDE AND INSIDE WITH CAULK OR TIGHTLY PACKED WITH INSULATION (BLANKET OR FOAM) TO PREVENT HEAT LOSS, INFILTRATION AND SOUND TRANSMISSION. PENETRATIONS THROUGH FIRE/SMOKE RATED ASSEMBLIES SHALL BE PROTECTED WITH PRODUCTS LISTED AND LABELED TO MAINTAIN THE FIRE/SMOKE RATING OF THE ASSEMBLY.
 - I. AS EACH ELECTRICAL SYSTEM IS COMPLETED, IT SHALL BE TESTED TO ASSURE FREEDOM FROM GROUND, AND THAT ALL REQUIRED FUNCTIONS HAVE BEEN PERFORMED. WORK SHALL BE INSPECTED AND APPROVED BY THE LOCAL INSPECTION AGENCY HAVING JURISDICTION. PERFORM SPECIFIC RESISTANCE TESTS WHEN REQUESTED BY THE INSPECTION AGENCY TO PROVE THE SYSTEM'S INTEGRITY. FURNISH TO THE OWNER (THROUGH THE ARCHITECT), A FINAL INSPECTION CERTIFICATE.
 - J. DEMONSTRATE FUNCTIONS PERFORMED BY DEVICES AND SYSTEMS TO THE OWNER'S REPRESENTATIVE. FURNISH TO THE OWNER, DATA SHEETS INDICATING NATURE AND FREQUENCY OF MAINTENANCE REQUIRED FOR SWITCHES, DEVICES, AND EQUIPMENT. ASSEMBLE AND DELIVER TWO (2) BOUND COPIES OF THIS DATA.
 - K. THIS CONTRACTOR SHALL GUARANTEE ALL WORKMANSHIP, EQUIPMENT, AND MATERIAL ENTERING INTO THIS CONTRACT FOR A PERIOD OF ONE (1) YEAR FROM THE DATE OF ACCEPTANCE, INCLUDING ALL LAMPS AND BALLASTS. ANY WORK PROVEN TO BE DEFECTIVE DURING THIS PERIOD SHALL BE MADE GOOD BY THIS CONTRACTOR WITH NO EXPENSE TO THE OWNER.
 - L. THE CONTRACTOR SHALL SUBMIT A COMPLETE SET OF "AS-BUILT" DRAWINGS TO THE OWNER AT THE COMPLETION OF THE PROJECT. THE DRAWINGS ARE TO SHOW ALL CONDUIT, DEVICES, WIRE QUANTITY AND SIZES.
2. WIRING DEVICES
 - A. HARD USE SPECIFICATION GRADE WIRING DEVICES AND GROUND FUL CIRCUIT INTERRUPTERS IN NEMA CONFIGURATIONS AS SHOWN ON THE ELECTRICAL PLANS. DEVICES AND COVER PLATES SHALL BE IVORY IN COLOR. COVER PLATES SHALL BE NON-BREAKABLE, AND NON-COMBUSTIBLE NYLON, 0.100" THICK. DEVICES MUST BE SIDE AND BACK WIRED. QUICK CONNECT OR PLUG-IN TYPE RECEPTACLES ARE NOT APPROVED. HUBBELL, P&S, OR COOPER.
 - PHASE B OR L2-RED
 - PHASE C OR L3-YELLOW
 - GROUND-GREEN
 - PHASE B OR L2-ORANGE
 - PHASE C OR L3-YELLOW
 - GROUND-GREEN w/YELLOW TRACER
3. RACKWAYS & BOXES
 - A. CONDUIT SHALL BE USED FOR ALL WIRING, EXCEPT AS NOTED FOR "MC" CABLE ASSEMBLIES. CONDUIT TYPES SHALL BE ANY ONE OR A COMBINATION OF THE FOLLOWING, WITHIN RESTRICTING LIMITS INDICATED. CONDUIT TYPES NOT LISTED SHALL NOT BE USED. MINIMUM SIZE FOR ALL TYPES SHALL BE 3/4".
 - 1) RIGID GALVANIZED CONDUIT - NO RESTRICTIONS
 - 2) INTERMEDIATE GRADE GALVANIZED THREADED CONDUIT - NO RESTRICTIONS
 - 3) THINWALL CONDUIT WITH APPROVED CONNECTOR FITTINGS TO ASSURE GROUNDING CONTINUITY, SUBJECT TO THE FOLLOWING RESTRICTIONS:
 - a. HAZARDOUS OR CORROSIVE ATMOSPHERES
 - b. NOT IN POURED CONCRETE, OUTDOOR OR UNDERGROUND
 - c. EXPOSED BELOW 96" ABOVE FINISHED FLOOR
 - 4) FLEXIBLE METAL CONDUIT (GREENFIELD TYPE), GALVANIZED. USE RESTRICTED TO THE FOLLOWING APPLICATIONS:
 - a. CONNECTIONS TO LIGHTING FIXTURES, MAXIMUM LENGTH IS 6 FEET
 - b. LIQUID TIGHT FLEXIBLE METAL CONDUIT WITH WATER/TIGHT OIL RESISTANT OUTER PVC COVERING. USE REQUIRED:
 - a. CONNECTIONS TO MOTORS OR CONTROL ON DYNAMIC EQUIPMENT
 - b. CONNECTIONS TO FURNITURE ELECTRICAL OUTLETS
 - 5) RIGID NON-METALLIC (SCHEDULE 40 PVC)
 - a. THIS CONDUIT MAY BE USED IN OR UNDER CONCRETE SLABS ON GRADE, IN CONCRETE DUCT BANKS, AND DIRECT BURIED
 - b. THIS CONDUIT MAY NOT BE EXPOSED WHERE SUBJECT TO PHYSICAL DAMAGE
 - c. TYPE EB MAY BE USED WHERE U.L. LISTED FOR SPECIFIC USE INTENDED CONDUIT FITTINGS
 - C. CONDUIT TYPES SHALL BE MANUFACTURED BY ETCOR, STEEL CITY, RACO, MIDWEST ETP, OR T&B. WHERE THE METALLIC CONDUIT SYSTEM IS USED AS THE EQUIPMENT GROUNDING SYSTEM.
 - 1) RIGID CONDUIT-COUPPLINGS AND CONNECTORS SHALL BE THREADED STEEL, CONCRETE TIGHT WITH NON-INSULATED THROAT. GROUND BUSHINGS SHALL BE INSULATED MALLEABLE IRON.
 - 2) EMT-FITTINGS SHALL BE ALL STEEL SET SCREW TYPE, CONCRETE TIGHT, WITH INSULATED THROAT FITTINGS. GROUND BUSHINGS SHALL BE INSULATED MALLEABLE TYPE.
 - 3) FLEXIBLE CONDUIT-MALLEABLE IRON, "SQUEEZE" TYPE
 - 4) LIQUID-TIGHT CONDUIT-STEEL OR MALLEABLE IRON
 - D. RUN CONDUITS AGAINST UNDERSIDE OF STRUCTURE OR AGAINST TOP CHORD OF JOISTS OR TRUSSES, WHETHER EXPOSED OR CONCEALED. IN NO CASE SHALL CONDUIT BE RUN IMMEDIATELY ABOVE ACCESSIBLE CEILINGS. USE ONLY METALLIC CONNECTORS AND FASTENERS. IN CONCRETE SLAB, LIMIT CONDUIT SIZE TO 3/4". LARGER CONDUITS SHALL BE INSTALLED UNDER THE SLAB. PLACE METALLIC CONDUITS ABOVE THE VAPOR BARRIER WHEN SLAB IS ON GRADE. WHERE FEEDERS ARE TO BE RUN BELOW FLOOR SLAB ON GRADE, THEY SHALL BE INSTALLED IN CONDUIT ENCASED IN 3" CONCRETE.
 - E. BRANCH CIRCUITS FOR LIGHTING AND RECEPTACLE CIRCUITS MAY BE TYPE "MC" CABLE ASSEMBLIES, WHERE PERMITTED BY N.E.C. "MC" SHALL BE USED ONLY WHERE CONCEALED IN WALLS OR ABOVE CEILINGS. ALL "MC" CABLE SHALL BE PROPERLY SUPPORTED PER N.E.C. ALL CONDUITS LEAVING A PANELBOARD MUST BE A MINIMUM OF EMT CONDUIT TO ABOVE CEILING, THEN TRANSITION TO "MC" CABLE.
 - F. DEVICE AND JUNCTION BOXES SHALL BE GALVANIZED STEEL, CODE GAUGE AND SIZE, BY STEEL CITY, RACO, APPLETON, OR T&B. BOXES CONNECTING MORE THAN ONE PAIR OF CONDUCTORS SHALL BE A MINIMUM 4"x4" OR 4" OCTAGONAL SIZE. USE ADAPTER PLATES FOR DEVICES WHERE NUMBER OF CONNECTIONS OR OTHER CONDITIONS DICTATE. EXTERIOR WEATHERPROOF METALLIC COVER PLATES SHALL BE HEAVY CAST ALUMINUM SIMILAR TO PASS & SEYMOUR #4510 UNLESS NOTED OTHERWISE.
4. CONDUCTORS
 - A. ALL BRANCH CIRCUIT CONDUCTORS SHALL BE COPPER. MINIMUM SIZE IS #12 AWG FOR BRANCH CIRCUITS AND #14 FOR CONTROL CIRCUITS. SEE DRAWINGS FOR VOLTAGE DROP PARAMETERS. BUILDING WIRING SHALL BE INSULATED FOR 600 VOLT, TYPE THW, THWN, XHHW, OR THHN, SUBJECT TO MOISTURE AND HEAT LIMITATIONS STATED IN CODE. THW, THWN, OR XHHW CONDUCTORS FOR CONNECTIONS TO LIGHTING AND EMERGENCY FIXTURES. SERVICE CONDUCTORS AND SELECTED FEEDERS MAY BE ALUMINUM. ALL SERVICE AND FEEDER GROUNDING CONDUCTORS MUST BE COPPER, NO EXCEPTIONS. ALL WIRING TO BE COLOR-CODED AS FOLLOWS:

120/208 VOLT SYSTEM:	277/480 VOLT SYSTEM:
NEUTRAL-WHITE	NEUTRAL-GRAY
PHASE A OR L1-BLACK	PHASE A OR L1-BROWN

FIRE RATED WALL PENETRATION FOR CONDUITS

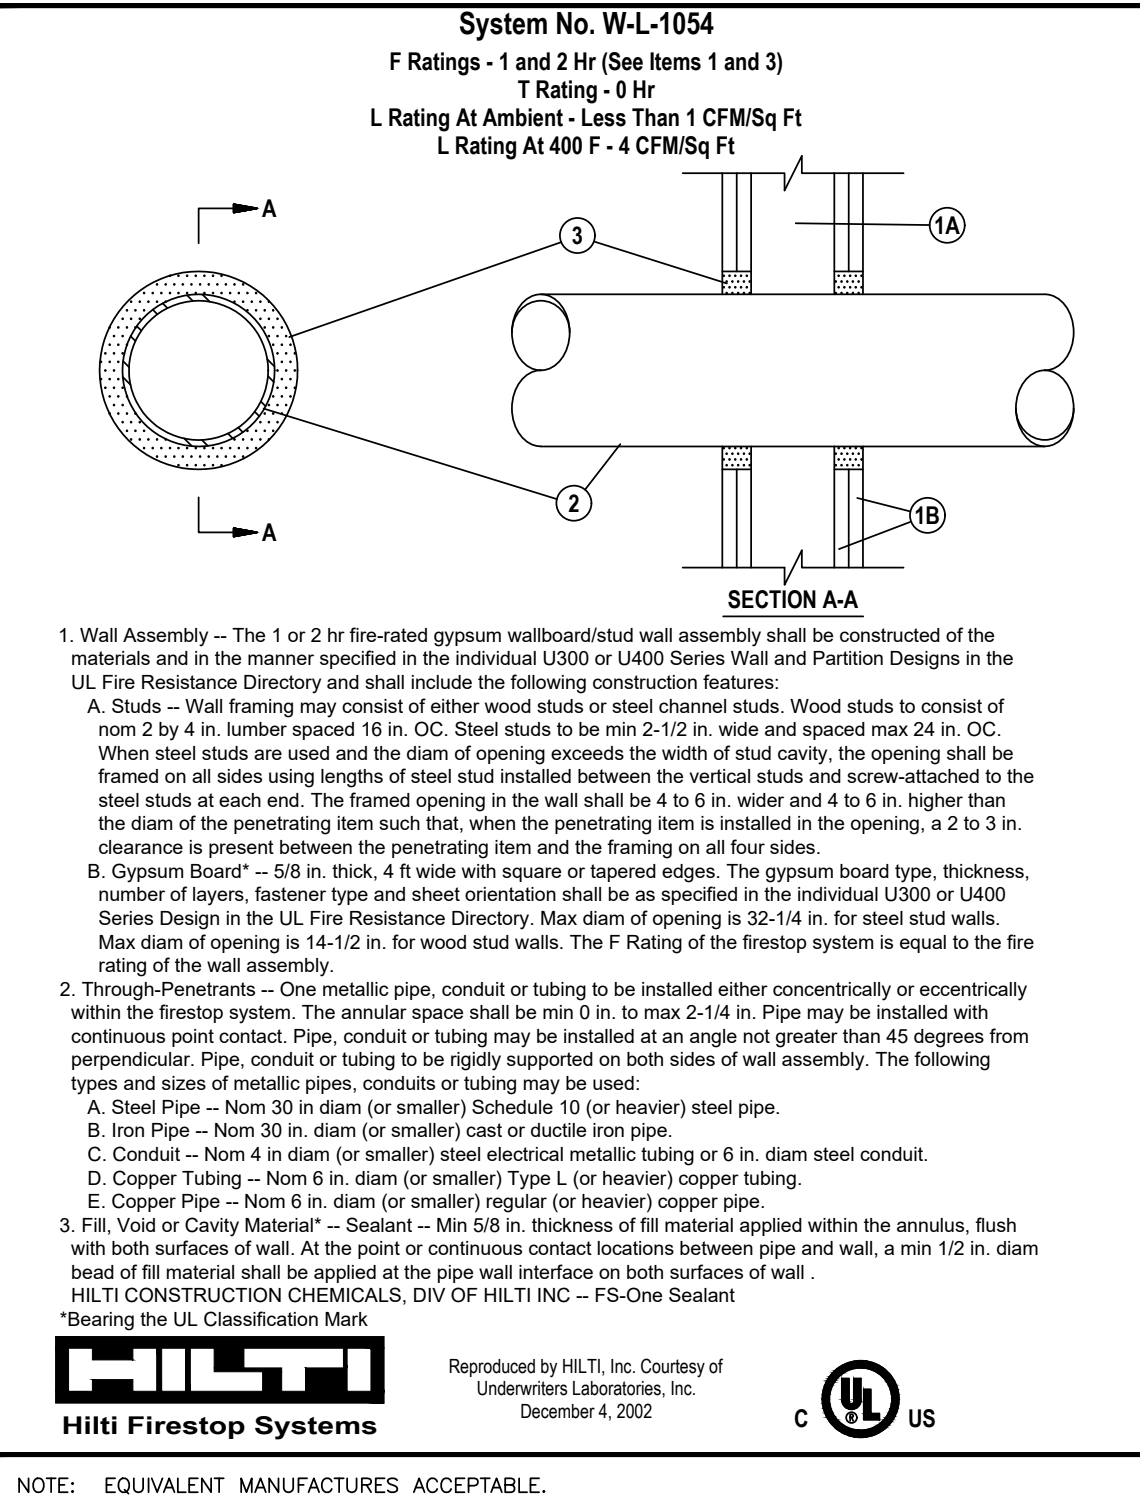


LOADCENTER: PP						
MANS: 100A	VOLTAGE: 120/240V., 1ø, 3W.					
60A MCB	MOUNTING: SURFACE					
REMARKS	KVA	BKR.	CIRCUIT NO. AND PHASE	BKR.	KVA	REMARKS
LTS (BASEMENT)	-	20/1	1 A 2	20/1	0.72-R	REC (BASEMENT)
			3 B 4			
			5 A 6			
			7 B 8			
			9 A 10			
			11 B 12			
			13 A 14			
			15 B 16			
			17 A 18			
			19 B 20			

LEGEND: L-LIGHTING, R-RECEPTACLES, M-MOTORS, H-HVAC REHEAT, A-APPLIANCE, MLO-MAIN LUGS ONLY, MCB-MAIN BREAKER, GF-GROUND FAULT, LC-LOCKING CLIP.
CONNECTED LOADS:
LIGHTING: 0.00 KW @ 100% = 0.00 KW
RECEPTS: 0.00 KW @ 100% TO 10 KW + 50% REMAIN = 0.00 KW
MOTOR: 0.00 KW @ 80% = 0.00 KW
APPLIANCE: 0.00 KW @ 80% = 0.00 KW
HVAC: 0.00 KW @ 80% = 0.00 KW
SUBTOTAL: 0.00 KW
DEMAND TOTAL: 0.00 KW / (208V x √3) = 0.0 AMPS

PROVIDE LOCKING CLIP. PROVIDE RED LABEL "FIRE ALARM CIRCUIT" ON CIRCUIT BREAKER PER NFPA 70 PARAGRAPH 760.41(B).
 INSTALL AN ARC FLASH WARNING LABEL ON THE PANEL TRIM.

GROUNDING ELECTRODE SYSTEM DETAIL

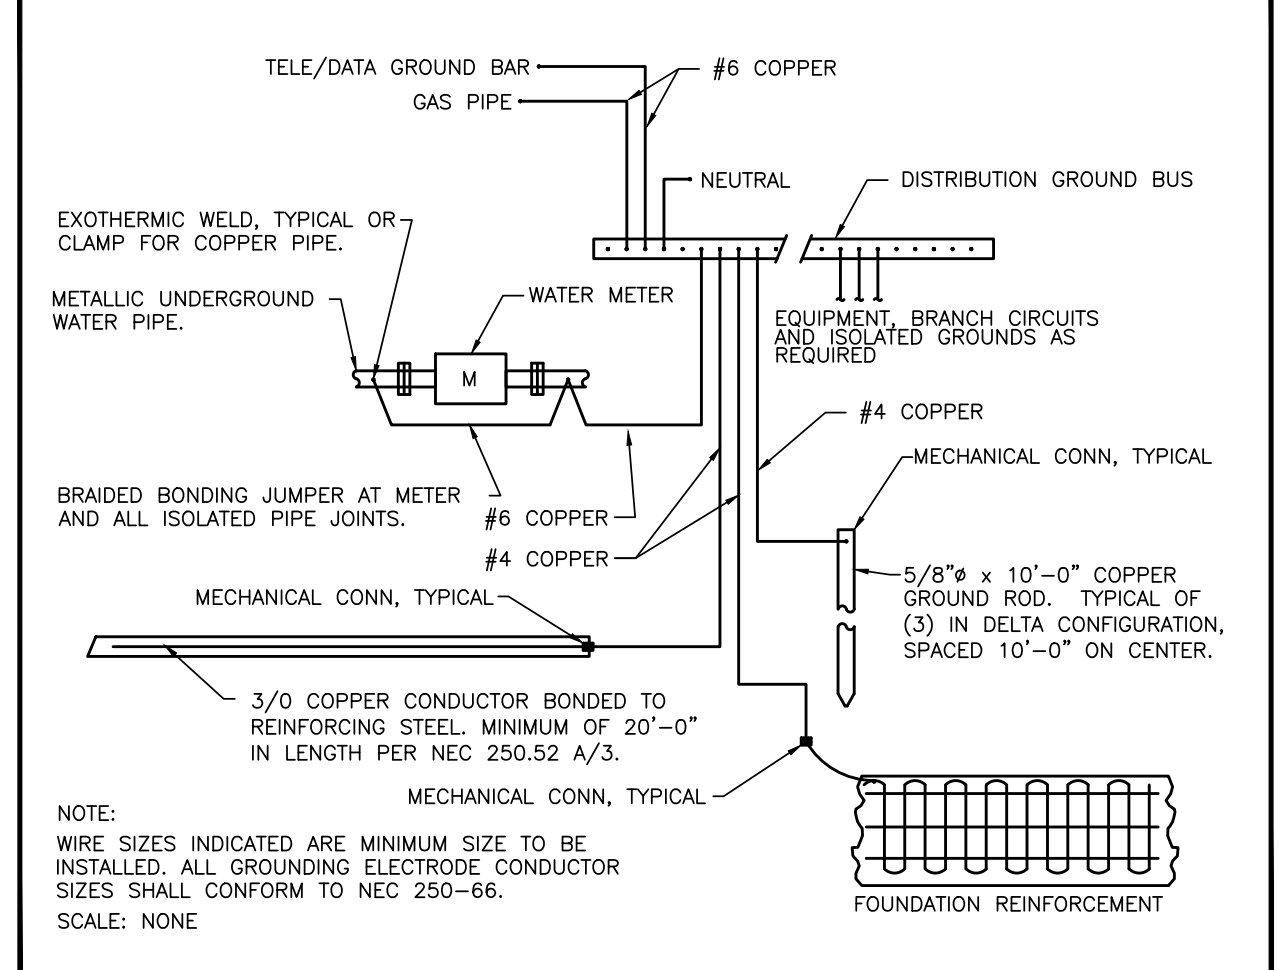

POWER RISER
 SCALE: NO SCALE

POWER RISER PLAN NOTES

1. NEW UTILITY METER CABINET BY ELECTRICAL CONTRACTOR. METER BY UTILITY COMPANY. COORDINATE ALL REQUIREMENTS WITH UTILITY COMPANY.
2. SEE GROUNDING ELECTRODE SYSTEM DETAIL THIS SHEET.
3. RUN 3 #1 IN 1-1/4" CONDUIT UNDERGROUND.
4. COORDINATE LOCATION OF UTILITY TRANSFORMER WITH SITE PLAN. LOCATION OF TRANSFORMER IS APPROXIMATELY 500'-0" AWAY.

ELECTRICAL LEGEND

- ALL HEIGHTS INDICATED ARE TO CENTERLINE OF ITEM UNLESS INDICATED OTHERWISE ON DRAWINGS.
- ABBREVIATIONS/TAGS
- E EXISTING DEVICE.
 - EC ELECTRICAL CONTRACTOR.
 - ES EQUIPMENT SUPPLIER.
 - GC GENERAL CONTRACTOR.
 - HC HVAC CONTRACTOR.
 - MH MOUNTING HEIGHT TO CENTERLINE OF ITEM UNLESS INDICATED OTHERWISE ON DRAWINGS.
 - PC PLUMBING CONTRACTOR.
 - R REMOVED EXISTING FOR RELOCATION.
 - RE RELOCATED EXISTING.
 - TYP TYPICAL.
 - WP WEATHERPROOF.
 - (P) PLAN NOTE SYMBOL - APPLIES ONLY TO SHEET ON WHICH NOTE IS SHOWN.
 - (EF) EQUIPMENT REFERENCE SYMBOL.
 - 123 ROOM NUMBER.
- WIRING DEVICES
- 20A-125V DUPLEX RECEPTACLE, NEMA 5-20R (16" MH).
 - 20A-125V DUPLEX RECEPTACLE, NEMA 5-20R (46" MH).
 - 20A-125V DUPLEX TAMPER-PROOF RECEPTACLE, NEMA 5-20R (16" MH).
 - 20A-125V DUPLEX RECEPTACLE, NEMA 5-20R, WITH GROUND FAULT CIRCUIT INTERRUPTER (16" MH).
 - 20A-125V DUPLEX RECEPTACLE, NEMA 5-20R, WITH GROUND FAULT CIRCUIT INTERRUPTER (46" MH).
 - 20A-125V DOUBLE DUPLEX RECEPTACLE, NEMA 5-20R (16" MH). TWO-GANG ASSEMBLY.
 - 20A-125V DOUBLE DUPLEX RECEPTACLE, NEMA 5-20R (46" MH). TWO-GANG ASSEMBLY.
 - FLUSH FLOOR MOUNTED DUPLEX RECEPTACLE. SEE SPECIFICATIONS.
- LIGHTING CONTROLS
- SINGLE POLE WALL SWITCH (46" MH).
 - THREE-WAY WALL SWITCH (46" MH).
 - LED DIMMER - w/rods/SELECT BY HUBBELL (IVORY). EQUALS BY SENSOR SWITCH, DOUGLAS, GREENGATE, WATTSTOPPER, LEVITON OR LUTRON. COORDINATE WITH LIGHTING MANUFACTURER FOR COMPATIBILITY. COORDINATE SWITCH COLOR WITH ARCHITECT (46" MH).
 - LOW VOLTAGE "ON/OFF" SWITCH BY LEVITON. EQUALS BY SENSOR SWITCH, GREENGATE, WATTSTOPPER, HUBBELL, LUTRON OR DOUGLAS (46" MH). COORDINATE WITH LIGHTING CONTROL VENDOR FOR COMPATIBILITY WITH LIGHTING CONTROL EQUIPMENT.
 - LOW VOLTAGE "ON/OFF/DIMMING" SWITCH BY LEVITON #AWSMT-EDW SERIES. EQUALS BY SENSOR SWITCH, GREENGATE, WATTSTOPPER, HUBBELL, LUTRON OR DOUGLAS (46" MH). COORDINATE WITH LIGHTING CONTROL VENDOR FOR COMPATIBILITY WITH LIGHTING CONTROL EQUIPMENT.
 - OR SINGLE BUTTON OVERRIDE SWITCH WITH LIGHT. EQUALS BY HUBBELL, SENSOR SWITCH, GREENGATE, WATTSTOPPER, LEVITON OR LUTRON. COORDINATE WITH LIGHTING CONTROL VENDOR FOR COMPATIBILITY WITH LIGHTING CONTROL EQUIPMENT.
 - OS WALL MOUNTED DUAL-TECHNOLOGY PASSIVE INFRARED/ULTRASONIC OCCUPANCY SENSOR W/AUTO-ON/AUTO-OFF CONTROL BY SENSORWORX #SWX-121-WH. COVERAGE AREA EQUAL TO 2000 SQ/FT MAJOR MOTION AND 600 SQ/FT MINOR MOTION AND 180' OF DETECTION. EQUALS BY SENSOR SWITCH, DOUGLAS, GREENGATE, WATTSTOPPER, HUBBELL OR LUTRON. COORDINATE WITH LIGHTING MANUFACTURER FOR COMPATIBILITY. COORDINATE SWITCH COLOR WITH ARCHITECT (46" MH).
 - VS WALL MOUNTED DUAL-TECHNOLOGY PASSIVE INFRARED/ULTRASONIC VACANCY SENSOR WITH ONE BUTTON MANUAL-ON/AUTO-OFF CONTROL BY SENSORWORX #SWX-123-WH. COVERAGE AREA EQUAL TO 2000 SQ/FT MAJOR MOTION AND 600 SQ/FT MINOR MOTION AND 180' OF DETECTION. EQUALS BY SENSOR SWITCH, DOUGLAS, GREENGATE, WATTSTOPPER, HUBBELL, LUTRON OR LEVITON. COORDINATE WITH LIGHTING MANUFACTURER FOR COMPATIBILITY. COORDINATE SWITCH COLOR WITH ARCHITECT (46" MH).
 - DVS WALL MOUNTED DUAL-TECHNOLOGY PASSIVE INFRARED/ULTRASONIC 0-10V DIMMING, VACANCY SENSOR SWITCH W/MANUAL-ON/AUTO-OFF AND DIMMING CONTROL BY SENSORWORX #SWX-1-2-3-D-WH SERIES. COVERAGE AREA EQUAL TO 600 SQ/FT MINOR MOTION, 2000 SQ/FT MAJOR MOTION AND 180' OF DETECTION. EQUALS BY SENSOR SWITCH, DOUGLAS, GREENGATE, WATTSTOPPER, HUBBELL OR LUTRON. COORDINATE WITH LIGHTING MANUFACTURER FOR COMPATIBILITY. COORDINATE SWITCH COLOR WITH ARCHITECT (46" MH).
 - CS CEILING MOUNTED DUAL-TECHNOLOGY PASSIVE INFRARED/ULTRASONIC, 2000 SQ FT COVERAGE AREA "AUTO-ON/AUTO-OFF" OCCUPANCY SENSOR BY LEVITON #OSC20-MOW SERIES. EQUALS BY HUBBELL, SENSOR SWITCH, DOUGLAS OR GREENGATE. INCLUDE COSMETIC CEILING ADAPTER. ALL PARTS WHITE IN COLOR. COORDINATE WITH LIGHTING MANUFACTURER TO INSURE COMPATIBILITY.
 - VS CEILING MOUNTED DUAL-TECHNOLOGY PASSIVE INFRARED/ULTRASONIC, 2000 SQ FT COVERAGE AREA "MANUAL-ON/AUTO-OFF" VACANCY SENSOR BY LEVITON #OSC20-MOW SERIES. EQUALS BY HUBBELL, SENSOR SWITCH, DOUGLAS OR GREENGATE. INCLUDE COSMETIC CEILING ADAPTER. ALL PARTS WHITE IN COLOR. COORDINATE WITH LIGHTING MANUFACTURER TO INSURE COMPATIBILITY.
- LIGHTING
- 1 SINGLE FACE EXIT LIGHTING FIXTURE. ARROWS AS INDICATED. CEILING MOUNTED.
 - 2 DOUBLE FACE EXIT LIGHTING FIXTURE. ARROWS AS INDICATED. CEILING MOUNTED.
 - 3 COMBINATION EXIT / EM LIGHTING FIXTURE w/ 2 HEADS AND BATTERY. ARROWS AS INDICATED. CEILING MOUNTED.
 - 4 EMERGENCY LIGHT FIXTURE w/ 2 HEADS AND BATTERY. SURFACE MTD. (8'-0" MH).
 - 5 LOW VOLTAGE EMERGENCY REMOTE HEAD LIGHT FIXTURE. SURFACE MTD. ABOVE DOOR.
 - R1 LIGHTING FIXTURE; CAPITAL LETTER DENOTES FIXTURE TYPE.
 - A-1/3 EACH ARROWHEAD REPRESENTS ONE COMPLETE CIRCUIT; CAPITAL LETTER DENOTES PANEL NUMBER(S) DENOTES CIRCUIT(S).
 - WIRE & CONDUIT IN WALL OR ABOVE CEILING.
 - WIRE & CONDUIT IN OR BELOW FLOOR SLAB OR BELOW GRADE.
 - () ELECTRICAL CONNECTION REQUIRED.
 - () MOTORIZED EQUIPMENT CONNECTION.
 - () JUNCTION BOX.
 - () HEAVY DUTY DISCONNECT SWITCH. 5'-0" TO TOP.
 - () COMBINATION MOTOR STARTER w/ HEAVY DUTY DISCONNECT SWITCH.
 - () HORSEPOWER RATED TOGGLE SWITCH w/ THERMAL OVERLOADS. (46" MH).
 - () CIRCUIT BREAKER PANEL (SURFACE MOUNTED). 6'-0" TO TOP.
 - () CIRCUIT BREAKER PANEL (FLUSH MOUNTED). 6'-0" TO TOP.
 - (16") PHONE/DATA OUTLET (16"MH EXCEPT WHERE NOTED). DOUBLE GANG BOX (MINIMUM DEPTH OF 2 1/8") WITH SINGLE GANG REDUCER, JACKS, COVER PLATE, AND WIRING. EXTEND A 1" BUSHED CONDUIT OUT ABOVE NEAREST ACCESSIBLE CEILING. SEE OWNER'S SPECIFICATIONS.
 - (46")

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PRELIMINARY
 NOT FOR
 CONSTRUCTION

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SHEET INFORMATION

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SHEET TITLE

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